


2 CONCESSIONS BUILDING LIFE SAFETY PLAN
1/4" = 1'-0"

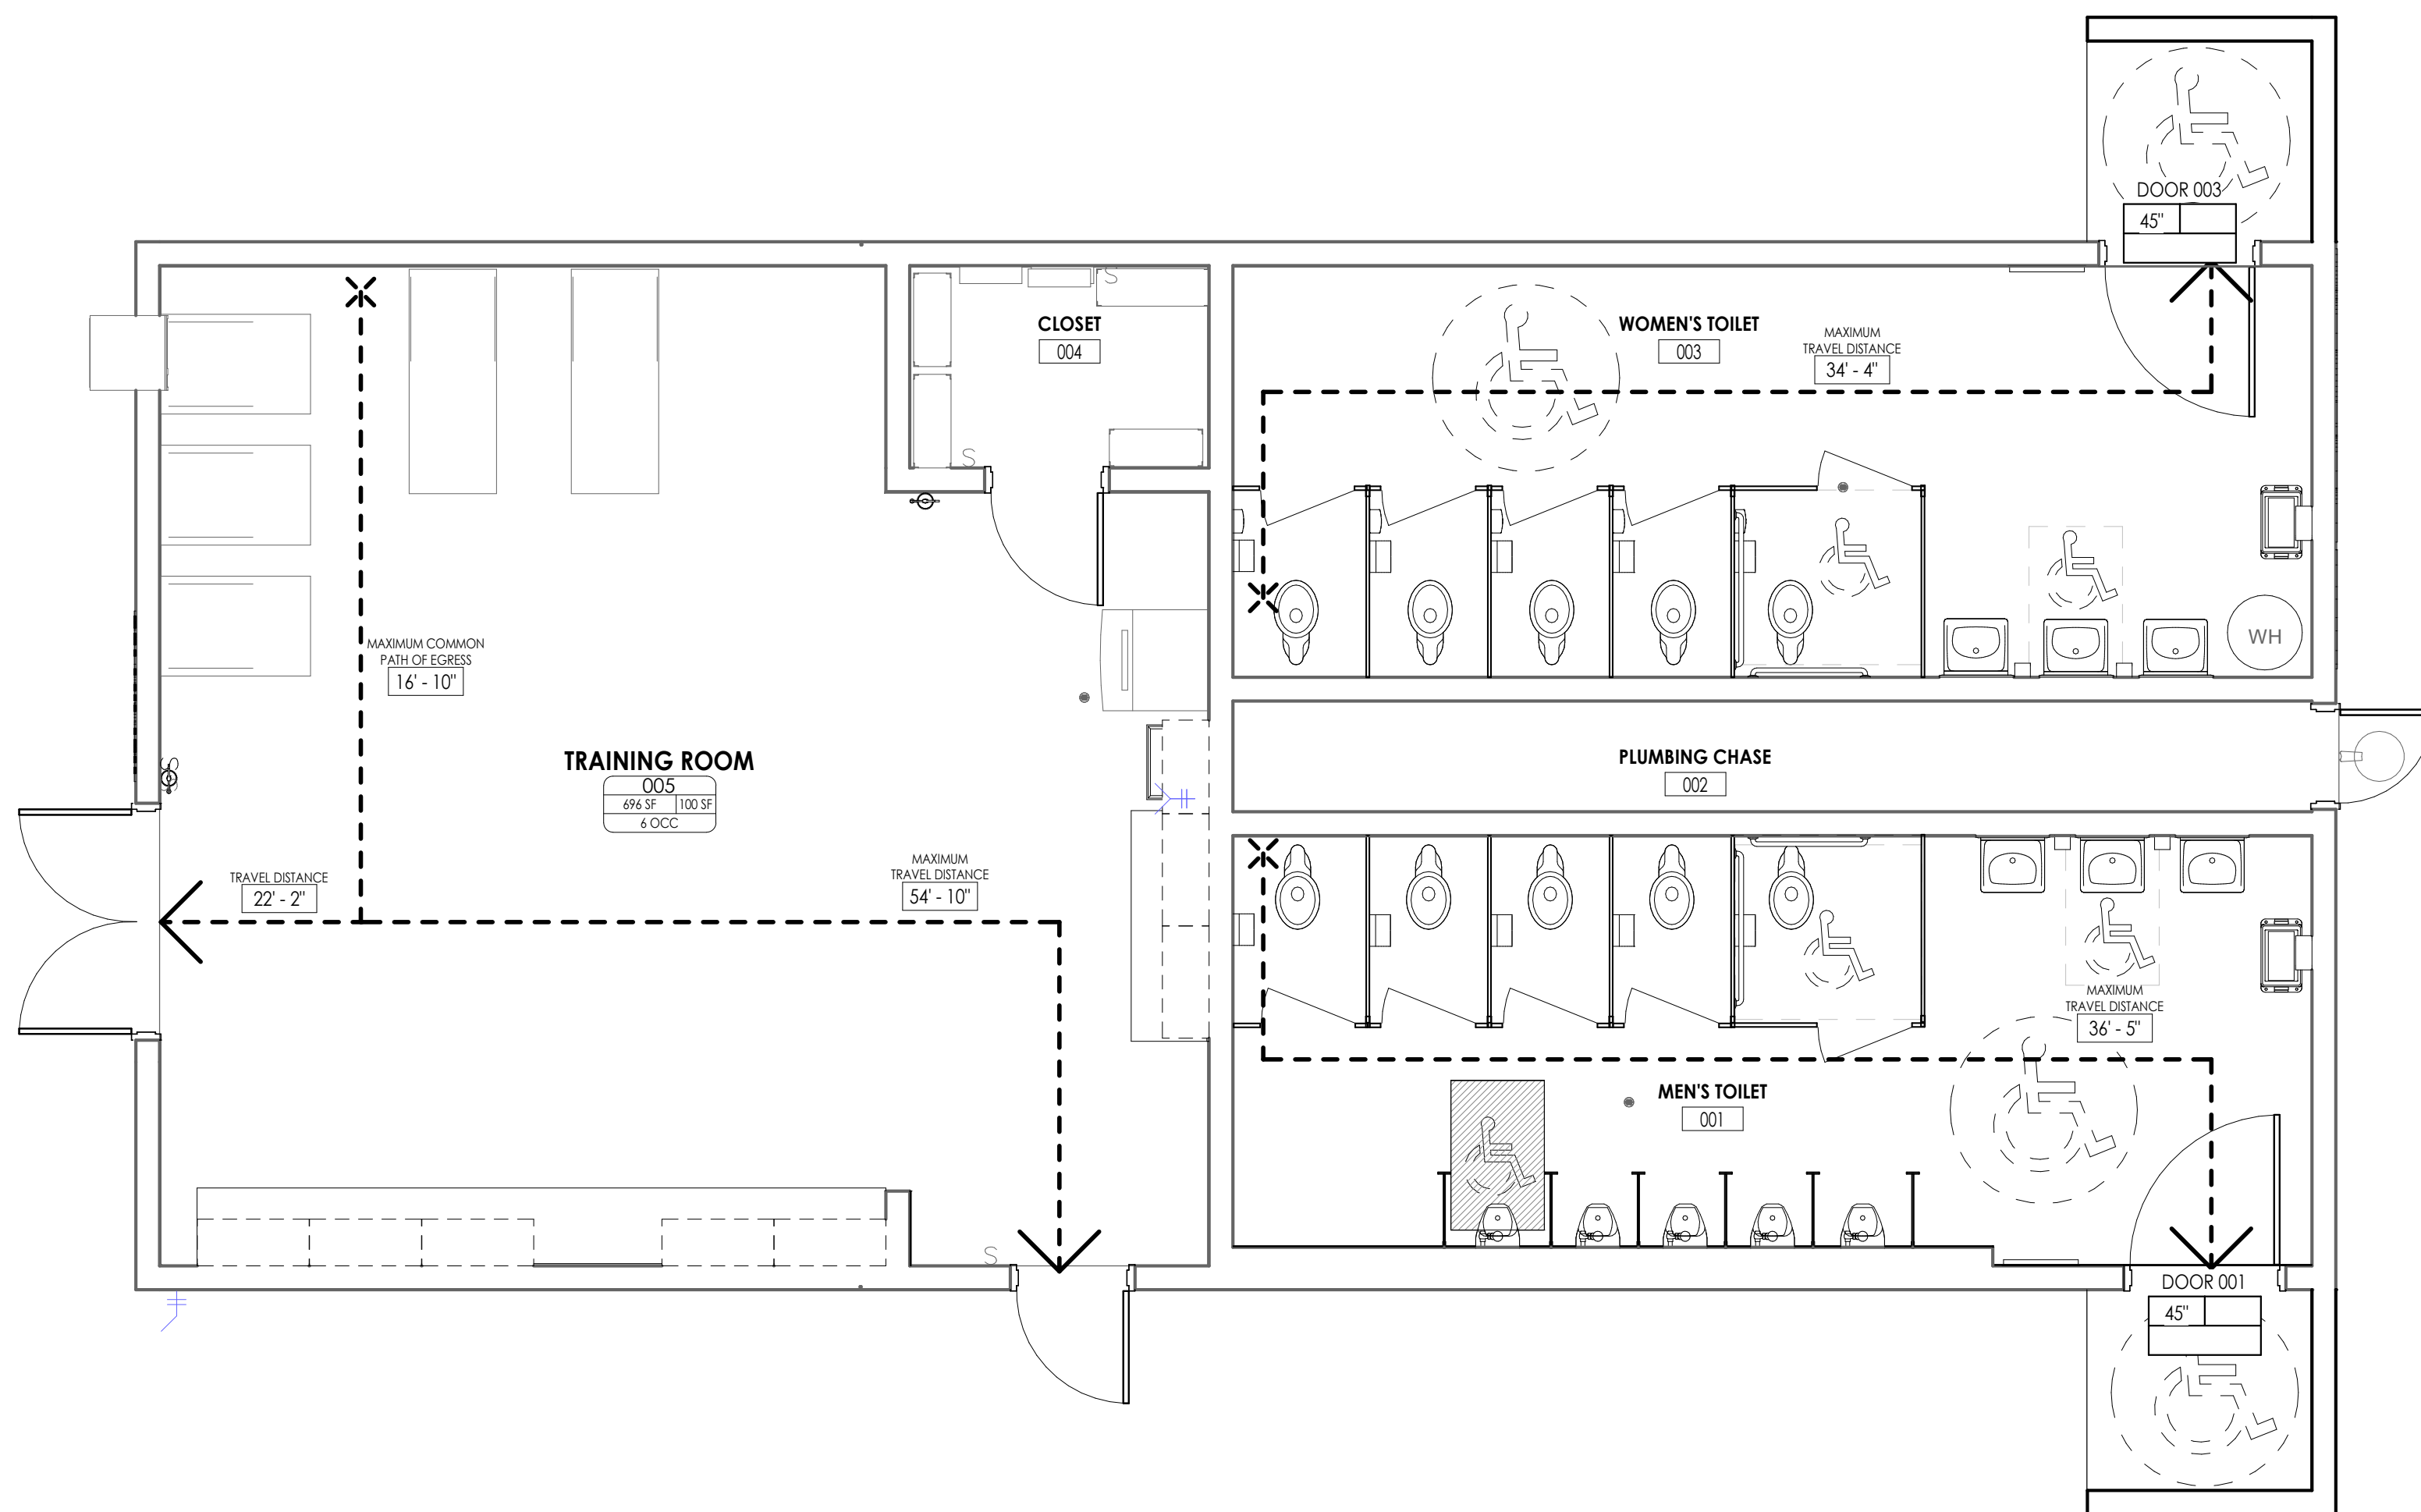

1 RESTROOM BUILDING LIFE SAFETY PLAN
1/4" = 1'-0"

LIFE SAFETY SYMBOL LEGEND

	ACCESSIBLE BUILDING ENTRANCE
	EXIT
	EXIT SIGN
ROOM NAME 	ROOM NAME ROOM NUMBER ROOM AREA OCCUPANT LOAD FACTOR OCCUPANT LOAD
DOOR 	CLEAR WIDTH REQUIRED WIDTH ANTICIPATED LOAD
TRAVEL DISTANCE 	TRAVEL DISTANCE TO EXIT
COMMON DISTANCE 	COMMON PATH OF EGRESS DISTANCE
MAXIMUM TRAVEL DISTANCE 	MAXIMUM TRAVEL DISTANCE TO EXIT
MAXIMUM COMMON PATH OF EGRESS 	MAXIMUM COMMON PATH OF EGRESS
DEAD END DISTANCE 	DEAD END DISTANCE

LIFE SAFETY CODE SUMMARY

* THE BUILDING WILL NOT EXCEED MAXIMUM ALLOWABLE QUANTITIES OF HAZARDOUS MATERIALS FOR STORAGE OR USE PER THE 2018 NORTH CAROLINA BUILDING CODE.

CONSTRUCTION TYPE: III-B NON-SPRINKLERED

OCCUPANCY USE AND USE GROUP:

CLASSIFICATION: E - EDUCATIONAL

TRAVEL DISTANCES (MAXIMUM):

EXIT ACCESS: (TABLE 1006.3.2 (2)); 75'-0" (E OCCUPANCY)

BUILDING SQUARE FOOTAGE:

TOTAL AREA (GSF): 2,226 GSF

GENERAL BUILDING AREA SUMMARY

NAME	AREA
LVL 1	
CONCESSIONS BUILDING	
CONCESSIONS	367 SF
STORAGE	334 SF
TOILET	36 SF
CLOSET	17 SF
RESTROOM BUILDING	
WOMEN'S TOILET	317 SF
MEN'S TOILET	321 SF
TRAINING ROOM	696 SF
CLOSET	43 SF
PLUMBING CHASE	85 SF
	2217 SF

PROJECT INFORMATION


Project Number: R22.16900.00
Client Name: WILSON COUNTY SCHOOLS

Project Name: HUNT HS - ATHLETICS RENOVATION
HUNT HIGH SCHOOL

Project Address: 4559 Lamm Rd, Wilson, NC 27893

PROJECT ISSUE & REVISION SCHEDULE

No.	Date	Description
-----	------	-------------

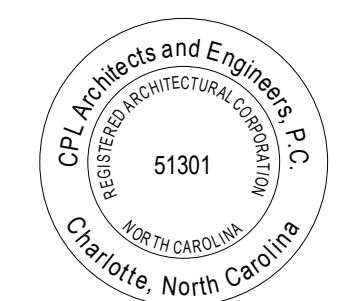

SHEET INFORMATION

Issued: 09.15.2023
Scale: As Indicated

Project Status: 100% CONSTRUCTION DOCUMENTS

Drawn By: EG
Checked By: GB

Drawing Title: OVERALL LIFE SAFETY PLAN


Drawing Number

GENERAL INFORMATION:

- PROJECT NAME: WCS - HUNT HS ATHLETICS RENOVATION
- OWNER: WILSON COUNTY SCHOOLS
117 TARBORO STREET
WILSON, NC 27893
- SITE ADDRESS: 4559 LAMM ROAD
WILSON, NC 27893
- TOTAL SITE AREA: 74.19 ACRES
- ZONING: AR
- TAX MAP ID#: 2791-91-1303
- THE PARCEL IS LOCATED IN A FEMA FLOOD ZONE - FEMA MAP NO. 3720279100K DATED APRIL 16, 2013.
- EXISTING SURVEY AND INFORMATION PROVIDED BY BARTLETT ENGINEERING & SURVEYING, P.C.
- 2003 AERIAL IMAGE TAKEN FROM WILSON COUNTY, NC GIS WEBSITE.

WATERSHED SITE DATA:

- WATERSHED NAME: CONTENTNEA CREEK
- WATERSHED CLASS: WS-IV; NSW
- STREAM INDEX: 27-95-5.7 (SHEPARD BRANCH)
- TOTAL SITE AREA: 74.19 ACRES
- 2003 BUA: 15.11 ACRES (658,077 SF)
- 2003 % IMPERVIOUS: 20.3%
- 2003 PERVIOUS AREA: 59.08 ACRES

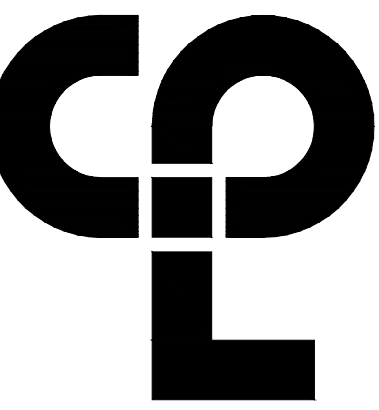

CPL | Architecture Engineering Planning
1620 Hillsborough Street Suite A,
Raleigh, NC 27605
CPLteam.com



3007 Hinsdale St.
Charlotte, NC 28210
(T) 704.582.3751

PROJECT INFORMATION

Project Number
R22.16900.00


Client Name
WILSON COUNTY SCHOOLS

Project Name
HUNT HS - ATHLETICS RENOVATION
HUNT HIGH SCHOOL

District Office Address
4559 Lamm Rd., Wilson, NC 27893

PROJECT ISSUE & REVISION SCHEDULE

No. Code Description

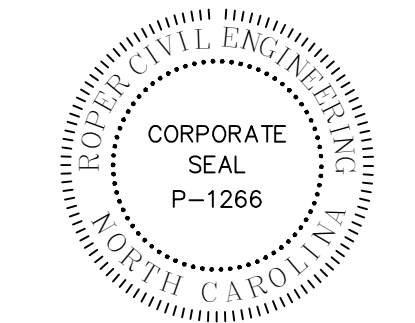

NEW YORK STATE EDUCATION STATEMENT
THE EDUCATION OF THE NEW YORK STATE EDUCATION LAW AND THE COMMISSIONER'S REGULATION FOR ANY PERSON, UNLESS ACTING UNDER THE DIRECTION OF A LICENSED ARCHITECT, ENGINEER OR LAND SURVEYOR, TO SEAL OR SIGN ANY DRAWING OR SPECIFICATION OF AN ARCHITECT, ENGINEER OR SURVEYOR IS A CRIME UNDER THE EDUCATION LAW AND THE EDUCATION REGULATION. THE ALTERNATIVE PENALTY APPLIES TO THE SEAL AND THE SIGNATURE OF THE ARCHITECT, ENGINEER OR SURVEYOR AND THE DATE OF SUCH SIGNATURE AND A PENALTY, DESCRIPTION OF THE ALTERNATIVE.

SHEET INFORMATION

Issued 09.15.2023 Scale 1" = 100'-0"

Project Status CONSTRUCTION DOCUMENTS

Drawn By MR Checked By MR

Drawing Title Built-Up on Area Map (2003)

Drawing Number

100% CONSTRUCTION DOCUMENTS



CONTRACTOR SHALL NOTIFY "NORTH CAROLINA ONE CALL" (811) OR (1-800-632-4949) AT LEAST 48 HOURS PRIOR TO BEGINNING CONSTRUCTION OR EXCAVATION TO HAVE EXISTING UTILITIES LOCATED.
CONTRACTOR SHALL CONTACT ANY LOCAL UTILITIES THAT PROVIDE THEIR OWN LOCATOR SERVICES INDEPENDENT OF "NORTH CAROLINA ONE CALL".
REPORT ANY DISCREPANCIES TO THE ENGINEER IMMEDIATELY.

GENERAL INFORMATION:

- PROJECT NAME: WCS - HUNT HS ATHLETICS RENOVATION
- OWNER: WILSON COUNTY SCHOOLS
117 TARBORO STREET
WILSON, NC 27893
- SITE ADDRESS: 4559 LAMM ROAD
WILSON, NC 27893
- TOTAL SITE AREA: 74.19 ACRES
- ZONING: AR
- TAX MAP ID#: 2791-79-1303
- THE PARCEL IS LOCATED IN A FEMA FLOOD ZONE - FEMA MAP NO. 3720279100K DATED APRIL 16, 2013.
- EXISTING SURVEY AND INFORMATION PROVIDED BY BARTLETT ENGINEERING & SURVEYING, PC.
- 2021 AERIAL IMAGE TAKEN FROM WILSON COUNTY, NC GIS WEBSITE.

WATERSHED SITE DATA:

- WATERSHED NAME: CONTENTNEA CREEK
- WATERSHED CLASS: WS-IV; NSW
- STREAM INDEX: 27-86-5.7 (SHEPARD BRANCH)
- TOTAL SITE AREA: 74.19 ACRES
- 2003 BUA: 15.11 ACRES (658,077 SF)
- 2003 % IMPERVIOUS: 20.3%
- 2021 BUA: 15.31 ACRES (666,780 SF)
- 2021 % IMPERVIOUS: 20.6%
- PROPOSED BUA: 0.55 ACRES (23,837 SF)
- 2023 TOTAL BUA: 15.85 ACRES (690,617 SF)
- % IMPERVIOUS: 21.4%

NUTRIENT CALCULATIONS FOR REDEVELOPMENT

TYPE OF LANDCOVER	EXISTING SITE CONDITIONS (ACRES)	POST-ADDITION SITE CONDITIONS (ACRES)	INCREASE (ACRES)
PERMANENTLY PROTECTED UNDISTURBED OPEN SPACE	27.55	27.55	0.00
PERMANENTLY PROTECTED MANAGED OPEN SPACE	31.53	30.79	-0.74
IMPERVIOUS SURFACES	15.11	15.85	0.74
TOTALS	74.19	74.19	0.00

NITROGEN LOADING CALCULATIONS


TN EXPORT LIMIT: 3.60 #/ACRE/YR
 TN EXPORT (#/YR): 18.21 #/YR (APPORTION METHOD)
 TN EXPORT FOR SITE: 0.25 #/ACRE/YR



100% CONSTRUCTION DOCUMENTS



CONTRACTOR SHALL NOTIFY "NORTH CAROLINA ONE CALL" (811) OR (1-800-632-4949) AT LEAST 48 HOURS PRIOR TO BEGINNING CONSTRUCTION OR EXCAVATION TO HAVE EXISTING UTILITIES LOCATED. CONTRACTOR SHALL CONTACT ANY LOCAL UTILITIES THAT PROVIDE THEIR OWN LOCATOR SERVICES INDEPENDENT OF "NORTH CAROLINA ONE CALL". REPORT ANY DISCREPANCIES TO THE ENGINEER IMMEDIATELY.

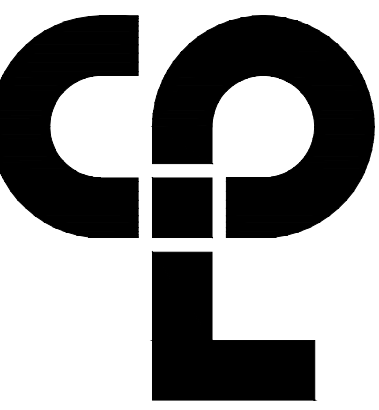

CPL | Architecture Engineering Planning
 1620 Hillsborough Street Suite A,
 Raleigh, NC 27605
 CPLteam.com



3007 Hinsdale St.
 Charlotte, NC 28210
 (T) 704.582.3751

PROJECT INFORMATION


Project Number: R22.16900.00
 Client Name: WILSON COUNTY SCHOOLS

Project Name: HUNT HS - ATHLETICS RENOVATION
 HUNT HIGH SCHOOL

Direct Office Address: 4559 Lamm Rd., Wilson, NC 27893

PROJECT ISSUE & REVISION SCHEDULE

No. Code Description

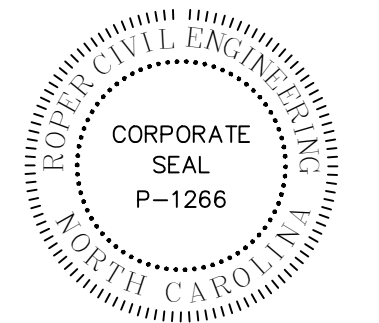

NEW YORK STATE EDUCATION STATEMENT

THE EDUCATION OF THE NEW YORK STATE EDUCATION LAW AND THE COMMISSIONER'S REGULATIONS FOR ANY PERSON, UNLESS ACTING UNDER THE DIRECTION OF A LICENSED ARCHITECT, ENGINEER OR LAND SURVEYOR, SHALL BE IN THE STATE OF NEW YORK. BOARDING THE SEAL OF AN ARCHITECT, ENGINEER OR SURVEYOR IS A CRIME. THE HOLDING PART THEREOF TO THE STATE SEAL AND THE SIGNATURE THEREON IS FOLLOWING BY THE SIGNATURE AND THE DATE OF SUCH SIGNATURE AND A PRECISE DESCRIPTION OF THE ALTAIRING.

SHEET INFORMATION


Issued: 09.15.2023 Scale: 1" = 100'-0"
 Project Status: CONSTRUCTION DOCUMENTS
 Drawn By: MR Checked By: MR
 Drawing Title: Built-Up on Area Map (2021)
 Drawing Number:

GRAPHIC SCALE
 1" = 100'

GENERAL INFORMATION:
 1. PROJECT NAME: WCS - HUNT HS ATHLETICS RENOVATION
 2. OWNER: WILSON COUNTY SCHOOLS
 117 TARBORO STREET
 WILSON, NC 27893
 3. SITE ADDRESS: 4559 LAMM ROAD
 WILSON, NC 27893
 4. TOTAL SITE AREA: 74.19 ACRES
 5. ZONING: AR
 6. TAX MAP ID#: 2791-79-1303
 7. THE PARCEL IS LOCATED IN A FEMA FLOOD ZONE - FEMA MAP NO. 3720279100K DATED APRIL 16, 2013.
 8. EXISTING SURVEY AND INFORMATION PROVIDED BY BARTLETT ENGINEERING & SURVEYING, PC.


LEGEND

- EXISTING WATER SPIGOT
- EXISTING FLAG POLE
- ★ EXISTING LIGHT POLE
- ◆ EXISTING DROP INLET
- EXISTING WATER VALVE
- - - EXISTING CONTOUR (MINOR)
- - - EXISTING CONTOUR (MAJOR)
- SD EXISTING STORM DRAIN LINE (APPROX. LOCATION)
- X EXISTING CHAIN LINK FENCE
- UG EXISTING UNDERGROUND ELECTRIC (APPROX. LOCATION)
- ~ EXISTING TREELINE

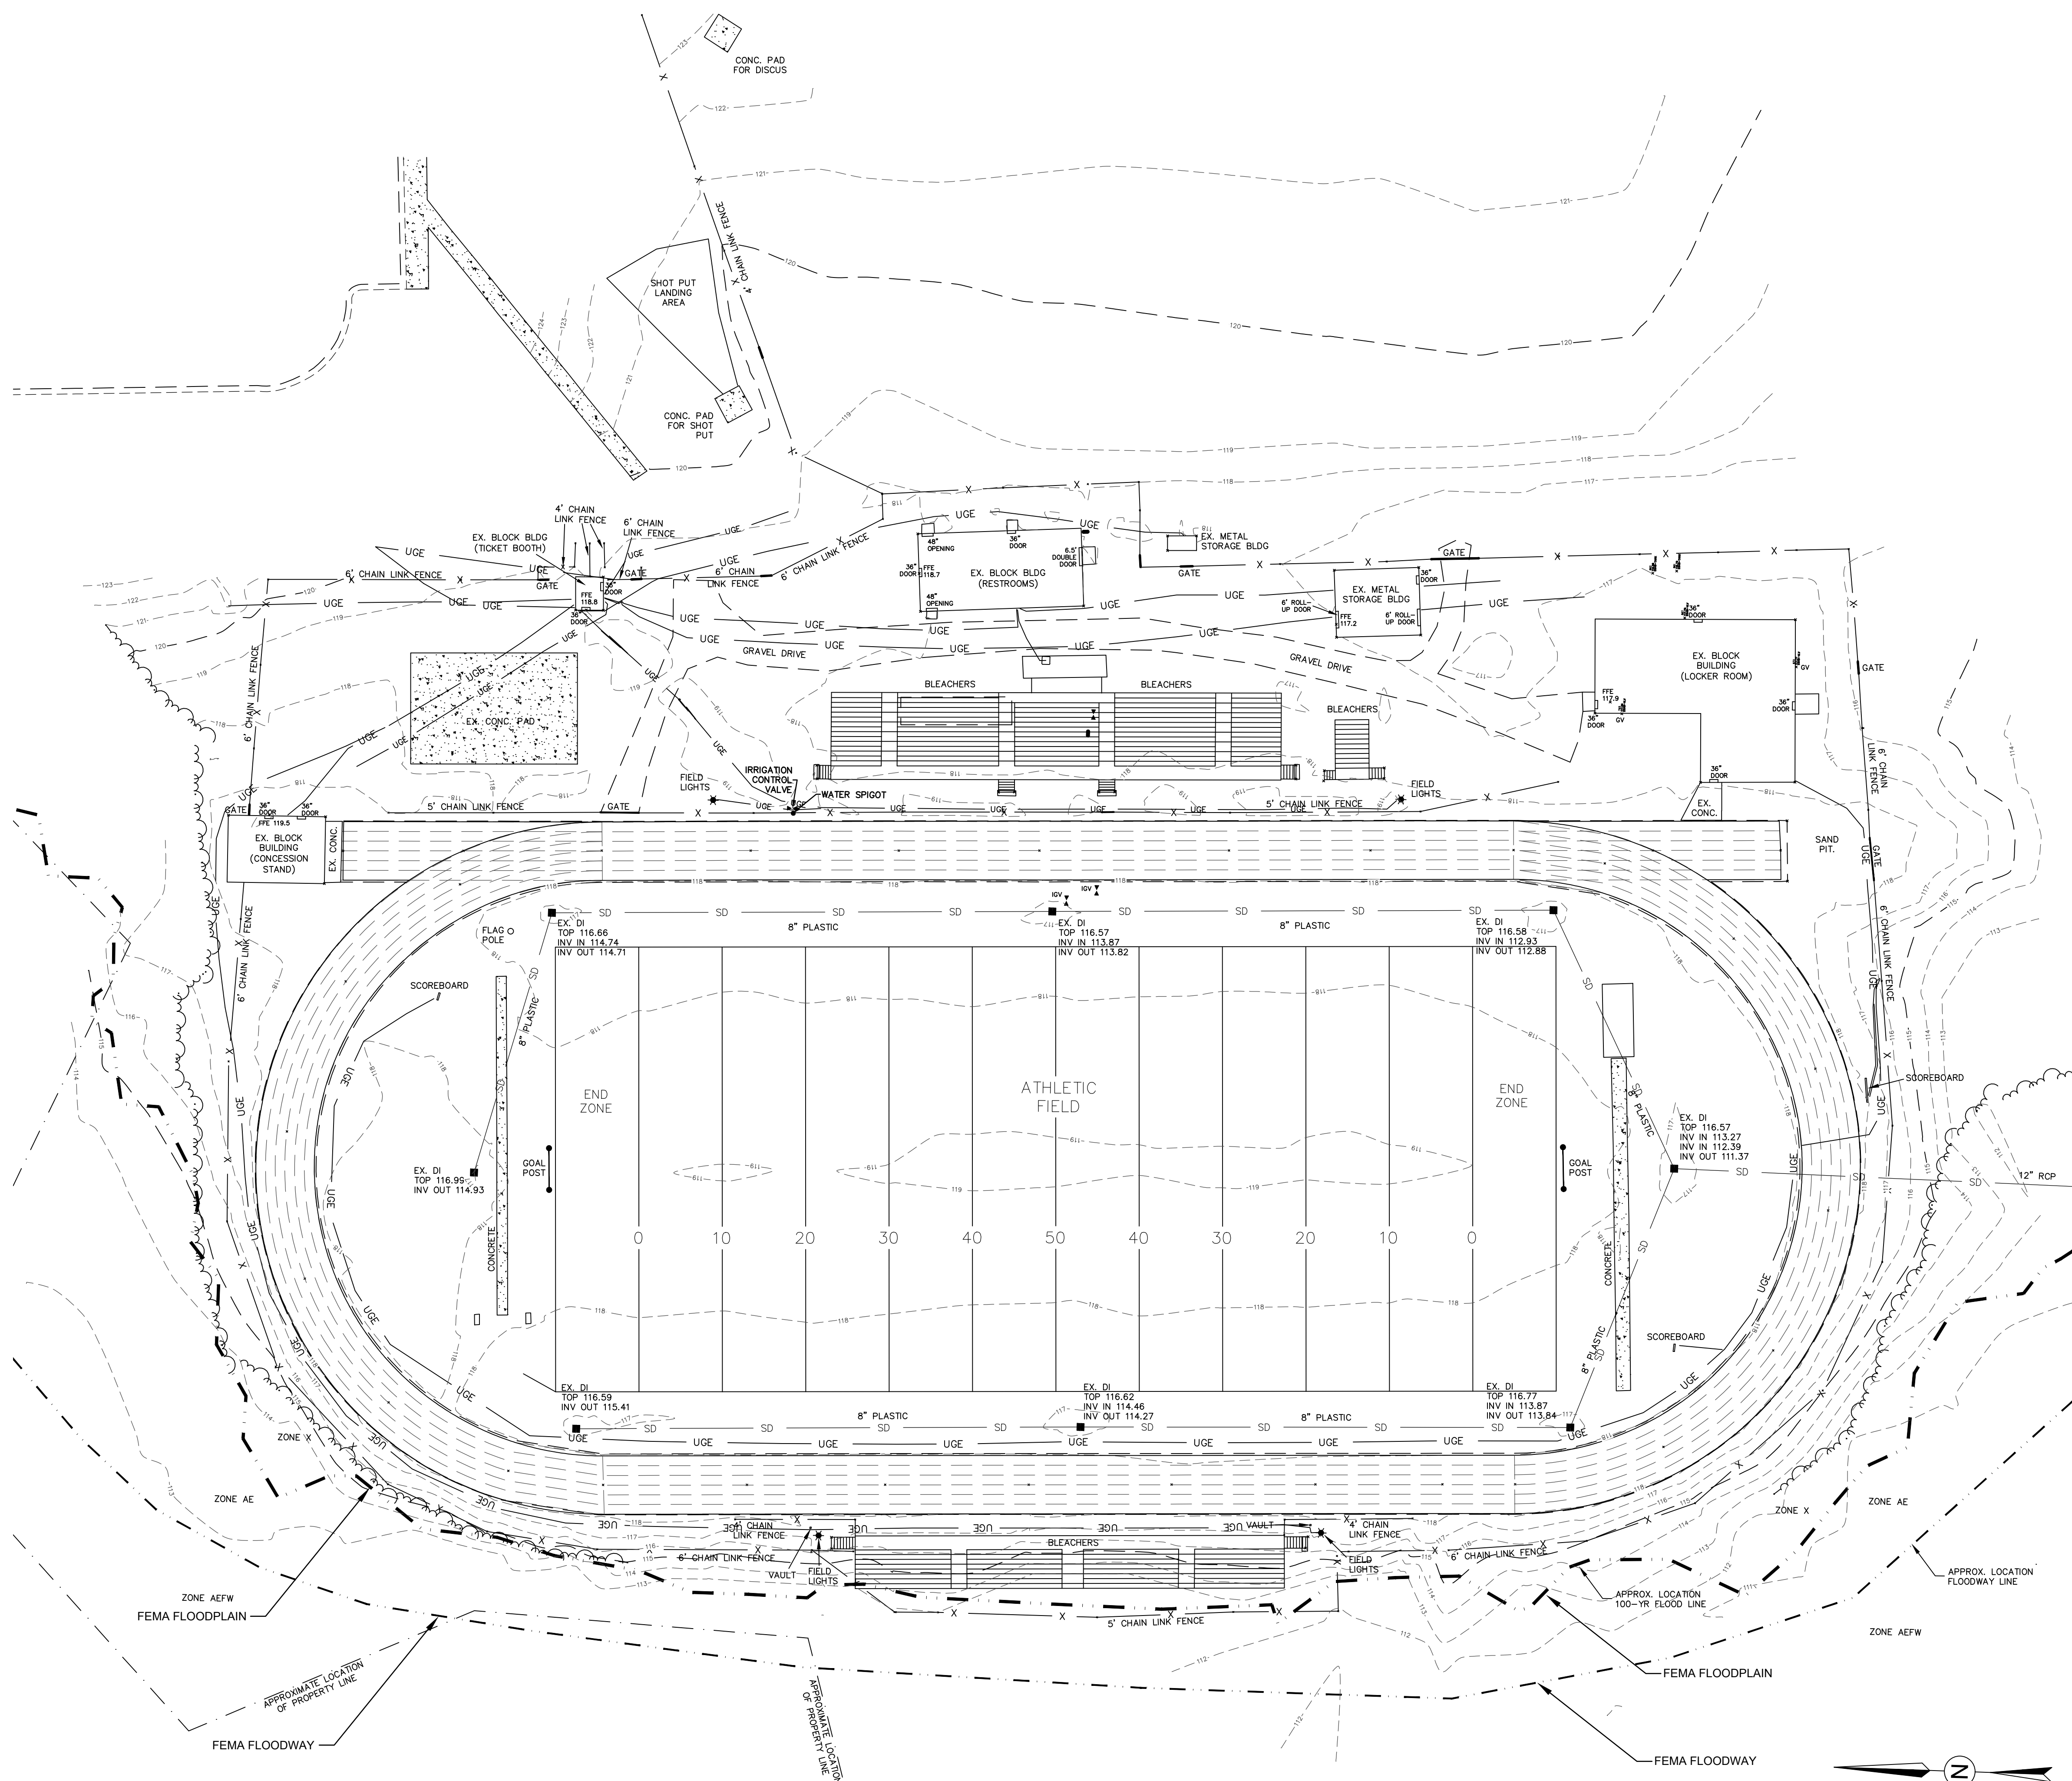

CONTRACTOR SHALL NOTIFY "NORTH CAROLINA ONE CALL" (811) OR (1-800-632-4949) AT LEAST 48 HOURS PRIOR TO BEGINNING CONSTRUCTION OR EXCAVATION TO HAVE EXISTING UTILITIES LOCATED.
 CONTRACTOR SHALL CONTACT ANY LOCAL UTILITIES THAT PROVIDE THEIR OWN LOCATOR SERVICES INDEPENDENT OF "NORTH CAROLINA ONE CALL".
 REPORT ANY DISCREPANCIES TO THE ENGINEER IMMEDIATELY.

100% CONSTRUCTION DOCUMENTS

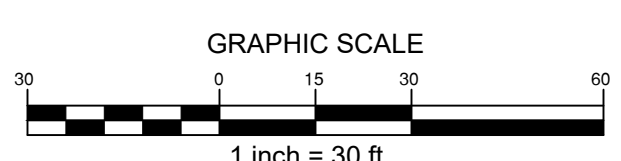


3007 Hinsdale St.
 Charlotte, NC 28210
 (T) 704.582.3751

PROJECT INFORMATION
 Project Number: R22.16900.00
 Client Name: WILSON COUNTY SCHOOLS
 Project Name: HUNT HS - ATHLETICS RENOVATION
 HUNT HIGH SCHOOL
 Project Address: 4559 Lamm Rd, Wilson, NC 27893

PROJECT ISSUE & REVISION SCHEDULE

No.	Date	Description

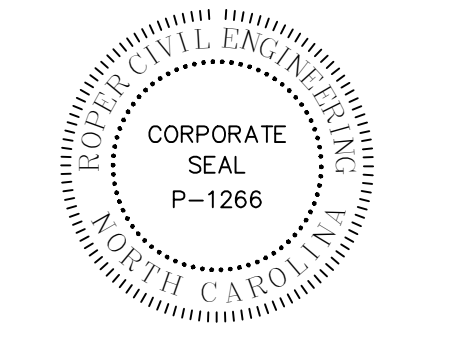

NEW YORK STATE EDUCATION STATEMENT
 I, THE UNDERSIGNED, BEING A LICENSED PROFESSIONAL ENGINEER IN THE STATE OF NEW YORK, DO HEREBY CERTIFY THAT I AM THE AUTHOR OF THE ABOVE-ENTITLED DESIGN OR INVENTION, AND THAT I AM NOT PROVIDING THE SAME TO ANY OTHER PERSON OR ENTITY WITHOUT YOUR WRITTEN CONSENT. I AM NOT PROVIDING THE SAME TO ANY OTHER PERSON OR ENTITY WITHOUT YOUR WRITTEN CONSENT. I AM NOT PROVIDING THE SAME TO ANY OTHER PERSON OR ENTITY WITHOUT YOUR WRITTEN CONSENT.

SHEET INFORMATION
 Issued: 09.15.2023
 Project Status: CONSTRUCTION DOCUMENTS
 Drawn By: BG
 Checked By: MR
 Drawing Title: Existing Conditions





Drawing Number: C102


10/09/2021 9:53:09 AM S:\Projects\Wilson\CS\Track\Repr\Plz\2\Design\UG_CAD\Repr\Centrif- Bm_306.rvt

DEMOLITION NOTES:



- ALL PROPERTY AFFECTED BY THIS WORK SHALL BE RESTORED TO A CONDITION EQUAL TO OR BETTER THAN THE EXISTING UNLESS OTHERWISE SPECIFICALLY EXEMPTED BY THESE PLANS.
- DEMOLITION DEBRIS, EXCEPT AS OTHERWISE NOTED, SHALL BECOME THE PROPERTY OF THE CONTRACTOR AND SHALL BE REMOVED FROM THE SITE. ALL DEBRIS SHALL BE DISPOSED OF OFF-SITE BY THE CONTRACTOR IN A LEGAL LANDFILL IN A TIMELY MANNER. NO SALVAGE OR SALE OF DEMOLISHED MATERIALS ON SITE WILL BE ALLOWED WITHOUT PERMISSION FROM THE OWNER.
- REMOVE WASTE MATERIALS AND UNSUITABLE AND EXCESS TOPSOIL FROM PROPERTY AND DISPOSE OF OFF-SITE IN A LEGAL MANNER. (PERMIT REQUIRED FOR OFF-SITE DISPOSAL).
- LOCATE EXISTING ABOVE GROUND AND UNDERGROUND UTILITIES IN AREAS OF WORK. IF UTILITIES ARE TO REMAIN IN PLACE, PROVIDE ADEQUATE MEANS OF SUPPORT AND PROTECTION DURING DEMOLITION OPERATION.
- SHOULD UNCHARTED, OR INCORRECTLY CHARTED PIPING OR OTHER UTILITIES BE ENCOUNTERED DURING DEMOLITION, CONSULT LANDSCAPE ARCHITECT AND UTILITY OWNER FOR IMMEDIATE ACTION.
- DEMOLISH AND COMPLETELY REMOVE FROM SITE MATERIAL INDICATED ON PLAN OR NOTED "TO BE REMOVED".
- PROTECT STRUCTURES, UTILITIES, SIDEWALKS, PAVEMENTS, AND OTHER FACILITIES FROM DAMAGE CAUSED BY SETTLEMENT, LATERAL MOVEMENT, UNDERMINING, WASHOUT AND OTHER HAZARDS CREATED BY THE DEMOLITION OPERATION.
- CONTRACTOR SHALL RESTORE ALL DISTURBED AREAS TO EXISTING CONDITIONS OR BETTER.
- CONTRACTOR SHALL MAINTAIN POSITIVE STORM DRAINAGE DURING CONSTRUCTION TO INSURE NO DAMAGE TO ADJACENT PROPERTIES OCCURS DURING STORM EVENTS.
- CONTRACTOR SHALL COORDINATE STORM DEMOLITION WITH STORM DRAIN IMPROVEMENTS TO MAINTAIN POSITIVE DRAINAGE.
- THE CONTRACTOR IS RESPONSIBLE FOR LOCATING AND PROTECTING ALL EXISTING UTILITIES.
- ALL DEMOLITION AND CONSTRUCTION SHALL COMPLY WITH APPLICABLE BUILDING CODES AND LOCAL RESTRICTIONS. THE CONTRACTOR MUST COMPLY WITH ALL OF THE CONTRACTOR REGISTRATION REQUIREMENTS OF ALL GOVERNING AUTHORITIES.
- PRIOR TO THE COMMENCEMENT OF DEMOLITION, THE CONTRACTOR SHALL COORDINATE HIS ACTIVITIES WITH ALL UTILITY COMPANIES SERVING THIS AREA. THE CONTRACTOR IS TO COORDINATE FULLY WITH THE UTILITY COMPANIES ON THE EXACT LOCATION OF ALL UNDERGROUND UTILITIES PRIOR TO DEMOLITION, CONSTRUCTION, AND EXCAVATION.
- ALL PROPOSED PAVEMENT CUTS SHALL BE SAW CUT ONLY.
- CONTRACTOR SHALL PROVIDE A MINIMUM OF 72 HOURS ADVANCE NOTICE TO THE OWNER PRIOR TO STARTING DEMOLITION ACTIVITIES.
- CONTRACTOR SHALL VERIFY AND PROTECT ALL PUBLIC UTILITIES. ANY WORK ASSOCIATED WITH SAID UTILITIES TO BE COORDINATED WITH APPROPRIATE UTILITY COMPANY. DEMOLITION OF UTILITIES WHICH ARE ACTIVE SHALL BE SEQUENCED TO ALLOW FOR INSTALLATION OF NEW OR REROUTED LINES, PRIOR TO REMOVAL OF EXISTING PORTION.
- THE CONTRACTOR SHALL IMMEDIATELY REPORT TO THE OWNER AND ENGINEER ANY DISCREPANCIES FOUND BETWEEN ACTUAL FIELD CONDITIONS AND CONSTRUCTION DOCUMENTS AND SHALL WAIT FOR INSTRUCTIONS PRIOR TO PROCEEDING.
- PRIOR TO BEGINNING CONSTRUCTION THE CONTRACTOR IS RESPONSIBLE TO VERIFY THAT ALL REQUIRED PERMITS AND APPROVALS HAVE BEEN OBTAINED FROM ALL REGULATORY AUTHORITIES AND SHALL BE THOROUGHLY FAMILIAR WITH CONDITIONS OF SAID PERMITS AND INSPECTION REQUIREMENTS.
- THE CONTRACTOR SHALL CONTACT ALL OWNERS OF EASEMENTS, UTILITIES AND RIGHT-OF-WAYS, PUBLIC OR PRIVATE, PRIOR TO WORKING IN THESE AREAS.
- THE CONTRACTOR SHALL BE RESPONSIBLE FOR DAMAGE TO ANY EXISTING ITEM AND/OR MATERIAL INSIDE OR OUTSIDE THE CONSTRUCTION LIMITS.
- CONTRACTOR SHALL MAINTAIN THE SITE IN A MANNER SO THAT WORKMEN AND PUBLIC ARE PROTECTED FROM INJURY.
- ENGINEER SHALL NOT BE IN CONTROL OR CHARGE OF, AND SHALL NOT BE RESPONSIBLE FOR ACTUAL CONSTRUCTION MEANS, METHODS, TECHNIQUES, PROCEDURES, OR SAFETY PRECAUTIONS IN CONNECTION WITH THE WORK, OR FOR THE ACTS OR OMISSIONS OF CONTRACTORS OR ANY OTHER PERSONS NOT UNDER THE EMPLOYMENT OF ENGINEER.
- SHOULD THE CONTRACTOR ENCOUNTER ANY ADDITIONAL ITEMS THAT MAY REQUIRE DEMOLITION (FENCES, GUARD RAIL, ETC.) - THE CONTRACTOR SHALL CONTACT THE ENGINEER FOR FURTHER DIRECTION.

LEGEND

-  EXISTING TRACK SURFACE AND BASE PAVEMENT TO BE REMOVED
-  EXISTING PAVEMENT AREA TO BE REMOVED.
-  EXISTING STRUCTURE TO BE REMOVED.
-  EXISTING CHAIN LINK FENCE TO BE REMOVED.

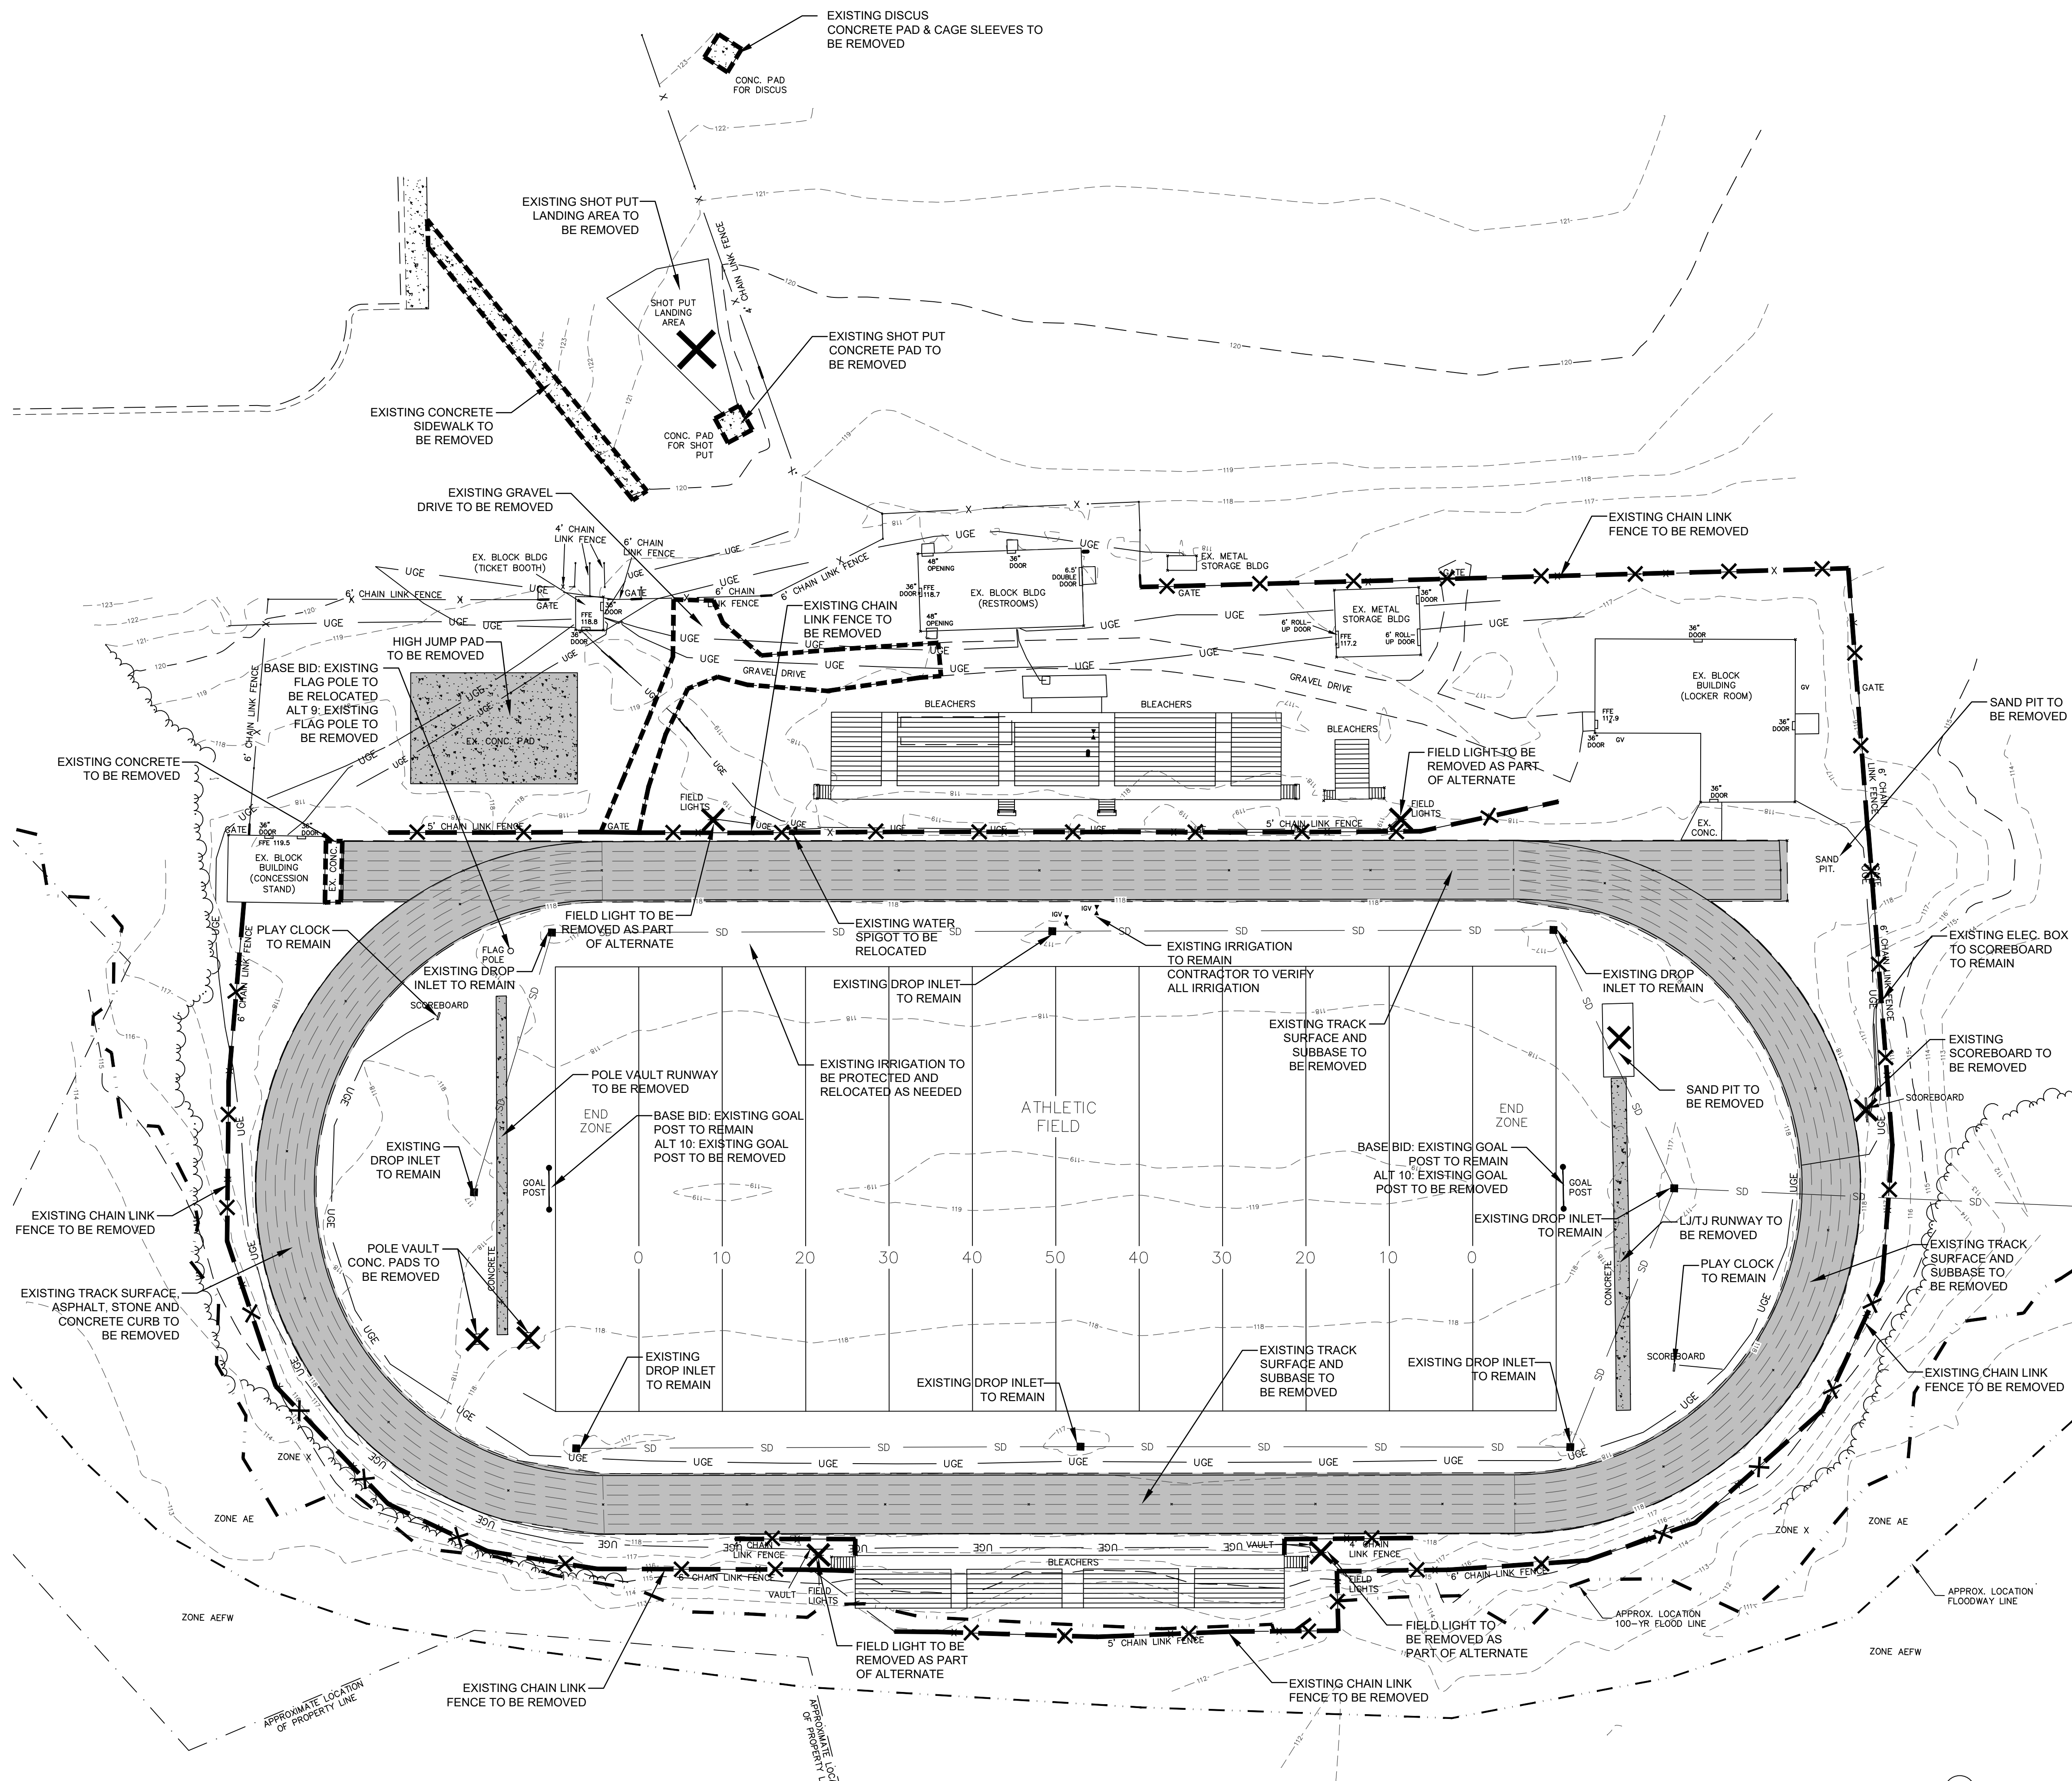

100% CONSTRUCTION DOCUMENTS

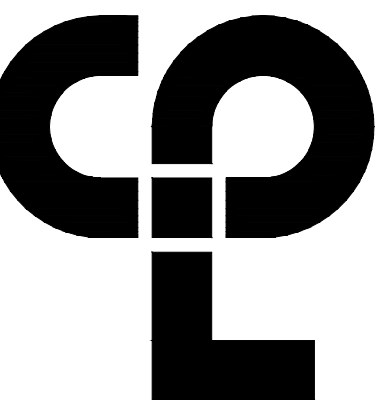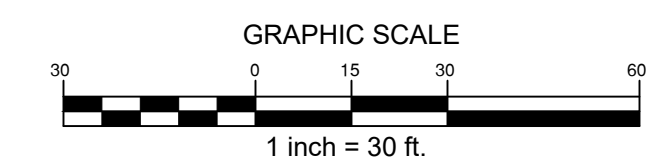

CPL | Architecture Engineering Planning
1620 Hillsborough Street Suite A,
Raleigh, NC 27605
CPLteam.com



3007 Hinsdale St.
Charlotte, NC 28210
(T) 704.582.3751

PROJECT INFORMATION

Project Number
R22.16900.00


Client Name
WILSON COUNTY SCHOOLS

Project Name
HUNT HS - ATHLETICS RENOVATION
HUNT HIGH SCHOOL

District Office Address
4559 Lamm Rd., Wilson, NC 27893

PROJECT ISSUE & REVISION SCHEDULE

No. Code Description

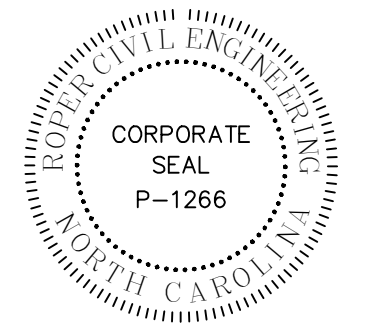

NEW YORK STATE EDUCATION STATEMENT
THE EDUCATION OF THE NEW YORK STATE EDUCATION LAW AND THE COMMISSIONER'S REGULATION FOR ANY PERSON, UNLESS ACTING UNDER THE DIRECTION OF A LICENSED ARCHITECT, ENGINEER OR LAND SURVEYOR, SHALL BE THE RESPONSIBILITY OF ANY PERSON BEARING THE SEAL OF AN ARCHITECT, ENGINEER OR LAND SURVEYOR. THE ARCHITECT, ENGINEER OR LAND SURVEYOR SHALL BE RESPONSIBLE FOR THE DESIGN AND THE ACCURACY OF THE INFORMATION AND THE DATE OF SUCH INFORMATION, AND A PRECISE DESCRIPTION OF THE ALTERNATION.

SHEET INFORMATION

Issued
09.15.2023
Scale
1" = 30'-0"
Project Status
CONSTRUCTION DOCUMENTS
Drawn By
BG
Checked By
MR
Drawing Title
Demolition Plan

Drawing Number

C103



CONTRACTOR SHALL NOTIFY "NORTH CAROLINA ONE CALL" (811) OR (1-800-632-4949) AT LEAST 48 HOURS PRIOR TO BEGINNING CONSTRUCTION OR EXCAVATION TO HAVE EXISTING UTILITIES LOCATED.
CONTRACTOR SHALL CONTACT ANY LOCAL UTILITIES THAT PROVIDE THEIR OWN LOCATOR SERVICES INDEPENDENT OF "NORTH CAROLINA ONE CALL". REPORT ANY DISCREPANCIES TO THE ENGINEER IMMEDIATELY.

EROSION CONTROL NOTES:

1. THIS EROSION CONTROL PLAN SHALL BE IMPLEMENTED IN ACCORDANCE WITH THE STANDARDS OF NORTH CAROLINA DEPARTMENT OF ENVIRONMENTAL QUALITY AS APPLICABLE. ALL EROSION CONTROL MEASURES SHALL BE CONSTRUCTED IN ACCORDANCE WITH NC EROSION AND SEDIMENT CONTROL PLANNING AND DESIGN MANUAL.
2. ADDITIONAL MEASURES TO CONTROL EROSION AND SEDIMENT MAY BE REQUIRED BY THE INSPECTOR.
3. IN AREAS WHERE SILT FENCE IS NOT REQUIRED, BUT THE CONTRACTOR DESIRES TO RESTRICT ACCESS, ORANGE TREE PROTECTION/BARRIER FENCE MAY BE UTILIZED.
4. STABILIZATION IS THE BEST FORM OF EROSION CONTROL. TEMPORARY SEEDING IS NECESSARY TO ACHIEVE EROSION CONTROL ON LARGE DENUDED AREAS AND ESPECIALLY WHEN SPECIFICALLY REQUIRED AS PART OF THE CONSTRUCTION SEQUENCE. ALL SLOPES MUST BE SEED AND MULCHED WITHIN DAYS. REFER TO EROSION CONTROL ORDINANCE FOR ADDITIONAL REQUIREMENTS.
5. ALL EROSION CONTROL DEVICES SHALL BE INSPECTED AT LEAST ONCE PER WEEK AND AFTER EACH STORM EVENT OF 0.5" OR MORE. IF ANY FAILURES ARE FOUND THEY SHOULD BE REPAIRED AS SOON AS POSSIBLE.
6. ANY GRADING BEYOND THE DENUDED LIMITS SHOWN ON THE PLAN IS A VIOLATION OF THE NCDEQ EROSION CONTROL RULES AND IS SUBJECT TO A FINE.
7. ADDITIONAL MEASURES TO CONTROL EROSION AND SEDIMENT MAY BE REQUIRED BY THE ENGINEER AND/OR A REPRESENTATIVE OF THE NCDEQ INSPECTION DEPARTMENT.
8. APPROVAL OF THIS PLAN IS NOT AN AUTHORIZATION TO GRADE ADJACENT PROPERTIES. WHEN FIELD CONDITIONS WARRANT OFF-SITE GRADING, PERMISSION MUST BE OBTAINED FROM THE AFFECTED PROPERTY OWNERS.
9. EFFECTIVE OCTOBER 1, 2010, PERSONS RESPONSIBLE FOR LAND DISTURBING ACTIVITIES MUST INSPECT A PROJECT AFTER EACH PHASE OF THE PROJECT TO MAKE SURE THAT THE APPROVED EROSION AND SEDIMENTATION CONTROL PLAN IS BEING FOLLOWED. SELF-INSPECTION REPORTS ARE REQUIRED. A SAMPLE SELF INSPECTION, AS WELL AS DETAILS OF THE SELF-INSPECTION PROGRAM, CAN BE FOUND ON THE NCDEQ WEBSITE.
10. ANY SEDIMENT OR MATERIAL TRACKED ONTO THE ADJACENT STREETS SHALL BE SWEEPED AND REMOVED IMMEDIATELY.
11. ALL DISTURBED AREAS WILL BE PROVIDED WITH PERMANENT GROUNDCOVER.

CONSTRUCTION SEQUENCE (PHASE 1):

1. OBTAIN GRADING/EROSION CONTROL PLAN APPROVAL FROM NCDEQ - DEMLR, STORMWATER PERMIT FROM WILSON COUNTY, AND ALL OTHER NECESSARY PERMITS FROM OTHER APPLICABLE AGENCIES.
2. EROSION AND SEDIMENT CONTROL (E&SC) PERMIT AND A CERTIFICATE OF COVERAGE (COC) MUST BE OBTAINED BEFORE ANY LAND DISTURBING ACTIVITIES CAN OCCUR.
3. AT LEAST 48 HOURS PRIOR TO BEGINNING CONSTRUCTION, CONTACT THE DEMLR SECTION IN THE RALEIGH REGIONAL DEQ OFFICE AT (919)791-4200, WILSON COUNTY INSPECTORS, AND THE ENGINEER. MEET WITH DEMLR REPRESENTATIVES AND THE ENGINEER ON-SITE AT THEIR REQUEST FOR A PRE-CONSTRUCTION MEETING.
4. PER NPDES REQUIREMENTS, A RAIN GAUGE, SELF-INSPECTIONS RECORDS, PERMIT, CERTIFICATE OF COVERAGE, AND SEDIMENT AND EROSION CONTROL PLAN ARE REQUIRED TO BE MAINTAINED ON SITE AND ACCESSIBLE DURING INSPECTION. IT IS RECOMMENDED THAT THESE ITEMS BE PLACED IN A PERMITS BOX AT THE BEGINNING OR ENTRANCE OF PROJECT.
5. INSTALL EROSION CONTROL MEASURES PER THE APPROVED PLAN OR AS DIRECTED BY THE INSPECTOR.
6. CALL FOR ON-SITE INSPECTION OF INSTALLED MEASURES BY THE INSPECTOR. AFTER APPROVAL BY THE INSPECTOR, CONSTRUCTION MAY BEGIN.
7. SELF-INSPECTIONS FOR EROSION AND SEDIMENTATION CONTROL MEASURES ARE TO BE PERFORMED AT LEAST ONCE EVERY SEVEN CALENDAR DAYS AND WITHIN 24 HOURS OF EVERY RAIN EVENT OF GREATER THAN 1-INCH. ANY NEEDED REPAIRS SHALL BE MADE IMMEDIATELY TO MAINTAIN MEASURES AS DESIGNED. ALL E&SC MEASURES SHALL BE MAINTAINED AS SPECIFIED IN THE CONSTRUCTION DETAILS ON THIS PLAN. A RAIN GAUGE SHALL BE INSTALLED AT THE PROJECT SITE FOR MONITORING.
8. DEMOLISH AND REMOVE THE EXISTING TRACK SURFACE AND SUBGRADE, EXISTING TRACK FEATURES (LONG JUMP, HIGH JUMP, ETC), EXISTING STORM PIPE AND STRUCTURES, AND ANY OTHER ITEMS SHOWN ON THE DEMO PLAN. STRIP AND REMOVE EXISTING GRASS, ROOT MAT, AND TOPSOIL FROM LAWN AREAS OF THE SITE. THIS MATERIAL SHALL BE STORED IN THE APPROVED STOCKPILE LOCATION.
9. EXCAVATE TO THE PROPOSED SUBGRADE ELEVATION IN THE LIMITS OF THE PROPOSED TRACK REPLACEMENT.
10. SILT BAGS SHALL BE UTILIZED AS NECESSARY IN THE AREAS SHOWN ON THE PLAN AND SHALL BE CONTINUOUSLY MONITORED DURING OPERATION.
11. PRIOR TO PLACEMENT / COMPACTION OF ANY BACK FILL WITHIN THESE AREAS, THE ON-SITE GEOTECHNICAL ENGINEER SHALL INSPECT THE SUB-GRADE. IF THE CONTRACTOR CONSTRUCTS AND COVERS UP THESE AREAS PRIOR TO INSPECTION, THEN THE SUB-GRADE SHALL BE UNCOVERED AND TESTED AT THE CONTRACTOR'S EXPENSE. NO BACKFILL MATERIAL SHALL BE PLACED FOR THE TRACK AREA UNTIL APPROVAL IS OBTAINED FROM THE ON-SITE GEOTECHNICAL ENGINEER.
12. REMOVE AND RELOCATE THE EXISTING DRAINAGE PIPE IN THE VICINITY OF THE TRACK REPLACEMENT AS SHOWN ON THE DRAINAGE PLAN.
13. ONCE THE DRAINAGE HAS BEEN RELOCATED, PROCEED TO PHASE 2 OF THE EROSION CONTROL PLANS.

EROSION CONTROL MAINTENANCE:

1. CHECK ALL EROSION AND SEDIMENT CONTROL MEASURES FOLLOWING EVERY RUNOFF PRODUCING RAIN EVENT, BUT NO LESS THAN ONCE A WEEK. ANY REPAIRS SHALL BE MADE IMMEDIATELY TO MAINTAIN MEASURES AS DESIGNED.
2. SEDIMENT COLLECTED BEHIND INLET PROTECTION SHALL BE CLEANED OUT BEFORE THE SEDIMENT REACHES AN ELEVATION WITHIN 6-INCHES OF THE OVERFLOW. PLACE THE REMOVED SEDIMENT IN THE STOCKPILE AREA.
3. SEDIMENT SHALL BE CLEANED OUT FROM BEHIND THE SEDIMENT FENCES BEFORE IT REACHES 6-INCHES DEEP AT THE FENCE. THE FENCING SHALL BE REPAIRED AS NECESSARY TO MAINTAIN A FUNCTIONING BARRIER. PLACE THE REMOVED SEDIMENT IN THE STOCKPILE AREAS.
4. SLOPES THAT ARE FLATTER THAN 3:1, WITHIN 14 CALENDAR DAYS OF COMPLETION OF ANY PHASE OF GRADING, SHALL BE PROVIDED WITH GROUNDCOVER.
5. ALL SEEDDED AREAS SHALL BE FERTILIZED, RESEEDDED, AND MULCHED AS NECESSARY TO MAINTAIN DENSE VEGETATED COVER.

GENERAL NOTES:


1. THE INSTALLATION OF UTILITIES (CABLE, ELECTRICAL, NATURAL GAS, WATER, SEWER, ETC.) ARE TO BE WITHIN THE PERMITTED LIMITS OF DISTURBANCE AND ANY PROPOSED INSTALLATION OUTSIDE OF THESE AREAS WILL REQUIRE A PLAN MODIFICATION TO THE PERMIT BEFORE SAID WORK IS DONE.
2. THE LOCATION OF ANY POSSIBLE STOCKPILES, OFFSITE MATERIAL, WASTE, BORROW, OR CONSTRUCTION EQUIPMENT STORAGE / LAYDOWN AREAS SHALL BE WITHIN THE LIMITS OF DISTURBANCE, ALONG WITH ADEQUATE SEDIMENT AND EROSION CONTROL MEASURES.

DEWATERING NOTE:

DEWATERING MAY BE NECESSARY IN THE EXCAVATION AREAS (E.G. SUBGRADE AREAS). THEREFORE, THE CONTRACTOR SHALL FURNISH, INSTALL, OPERATE, AND MAINTAIN ANY PUMPING EQUIPMENT, ETC. NEEDED FOR REMOVAL OF WATER FROM VARIOUS PARTS OF THE SITE. DURING PLACEMENT OF FILL WITHIN THESE AREAS, THE CONTRACTOR SHALL KEEP THE WATER LEVEL BELOW THE BOTTOM OF THE EXCAVATION / CONSTRUCTION AREAS. THE MANNER IN WHICH THE WATER IS REMOVED SHALL BE SUCH THAT THE EXCAVATION BOTTOM AND SIDE SLOPES ARE STABLE, WITH NO SEDIMENT DISCHARGED FROM THE SITE (I.E. PUMPED WATER MAY NEED TO BE DIRECTED TO AN APPROVED EROSION CONTROL DEVICE PRIOR TO DISCHARGE).

LEGEND:

- EXISTING CONTOUR
- SD --- EXISTING STORM PIPE
- EXISTING DRAIN INLET
- LD --- PROPOSED LIMITS OF DISTURBANCE
- SF --- SF --- PROPOSED TEMPORARY SILT FENCE
- PROPOSED INLET PROTECTION
- RO --- PROPOSED SILT FENCE ROCK OUTLET

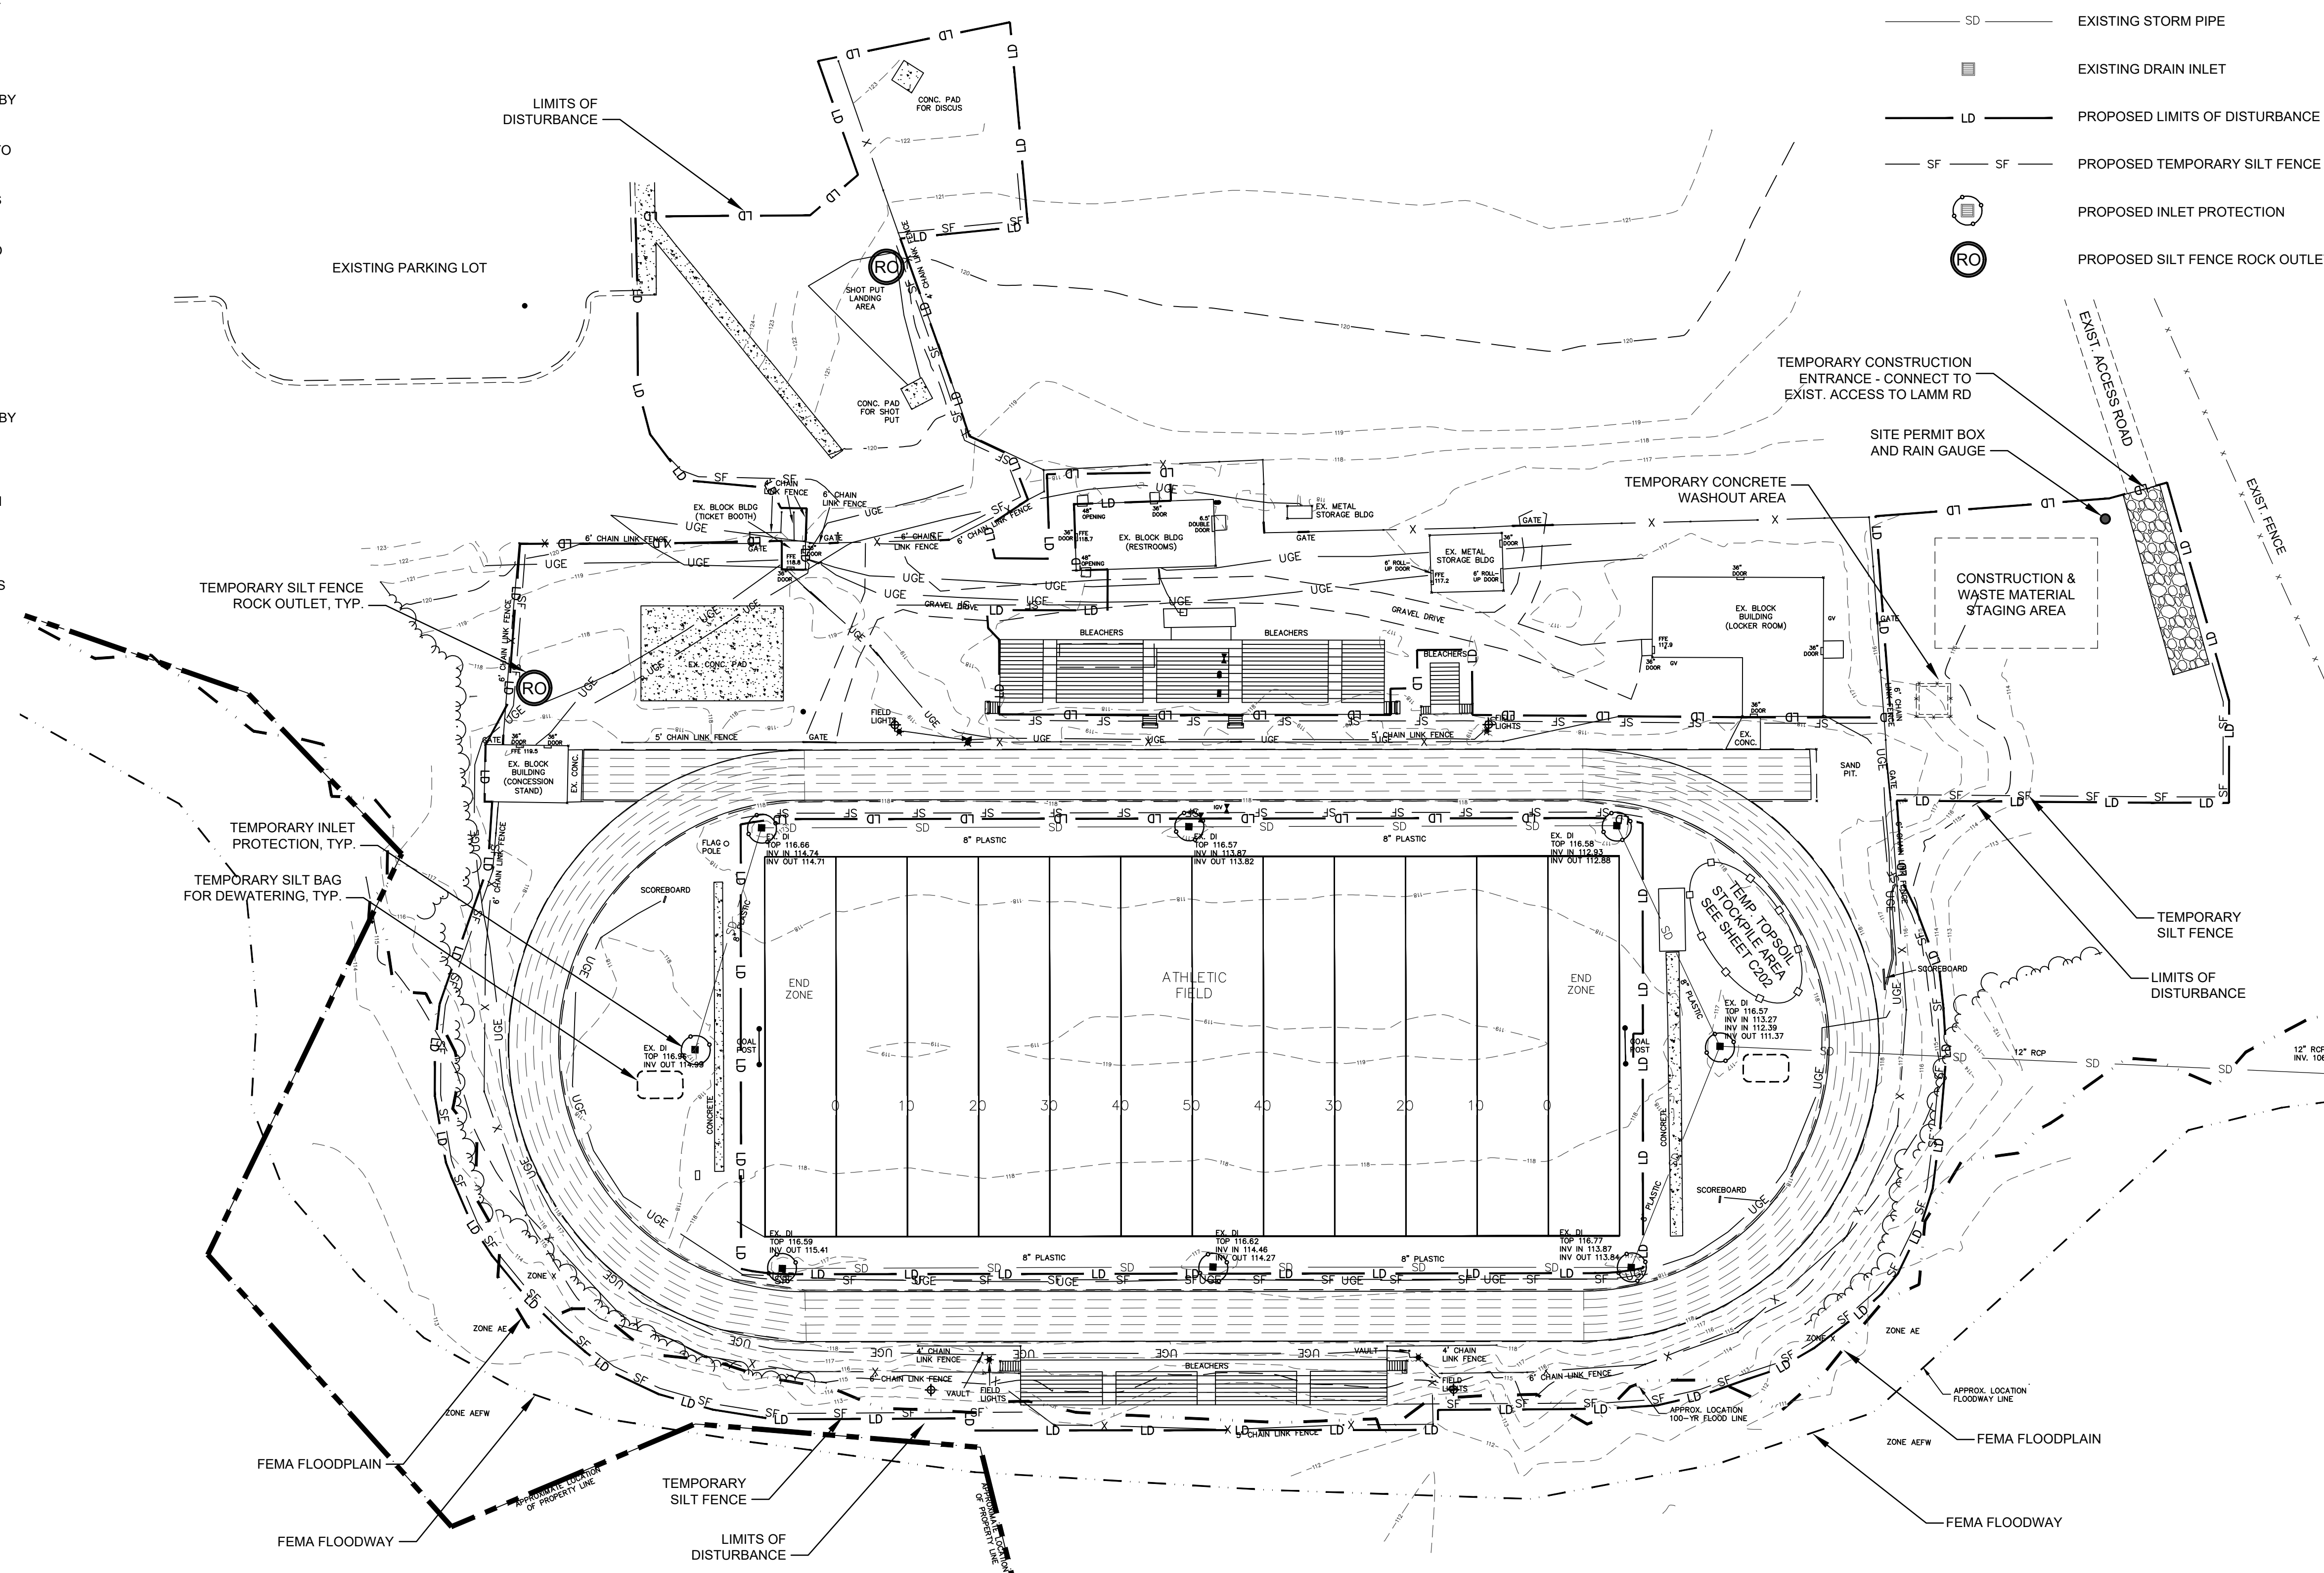




TOTAL DENUDED AREA = 3.8 ACRES

GROUND STABILIZATION		
SITE AREA DESCRIPTION	STABILIZATION TIME FRAME	STABILIZATION TIME FRAME EXCEPTIONS
PERIMETER DIKES, SWALES, DITCHES AND SLOPES	7 DAYS	NONE
HIGH QUALITY WATER (HOW) ZONES	7 DAYS	NONE
SLOPES STEEPER THAN 3:1	7 DAYS	IF SLOPES ARE 10' OR LESS IN LENGTH AND ARE NOT STEEPER THAN 2:1, 14 DAYS ARE ALLOWED
SLOPES 3:1 OR FLATTER	14 DAYS	7-DAYS FOR SLOPES GREATER THAN 50 FEET IN LENGTH
ALL OTHER AREAS WITH SLOPES FLATTER THAN 4:1	14 DAYS	NONE (EXCEPT FOR PERIMETERS AND HOW ZONES)

WETLANDS NOTE:

THERE ARE NO JURISDICTIONAL WETLANDS IN THE PROJECT AREA. NO JURISDICTIONAL WETLANDS WILL BE IMPACTED DURING CONSTRUCTION.

100% CONSTRUCTION DOCUMENTS

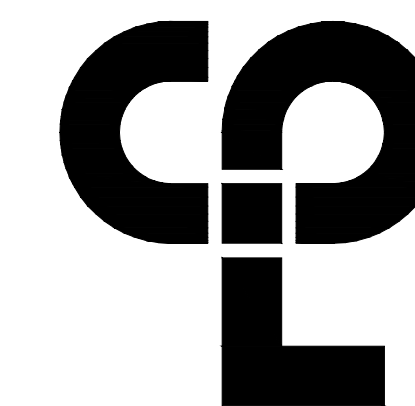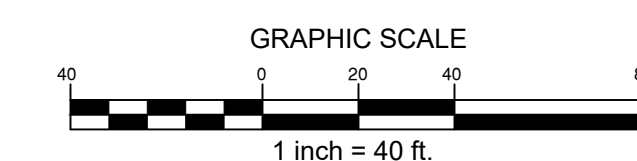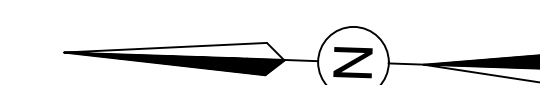

CPL | Architecture Engineering Planning
1620 Hillborough Street Suite A,
Raleigh, NC 27605
CPLteam.com



3007 Hinsdale St.
Charlotte, NC 28210
(T) 704.582.3751

PROJECT INFORMATION

Project Number
R22.1.6900.00


Client Name
WILSON COUNTY SCHOOLS

Project Name
HUNT HS - ATHLETICS RENOVATION
HUNT HIGH SCHOOL

District Office Address
4559 Lamm Rd., Wilson, NC 27893

PROJECT ISSUE & REVISION SCHEDULE

No. Date Description

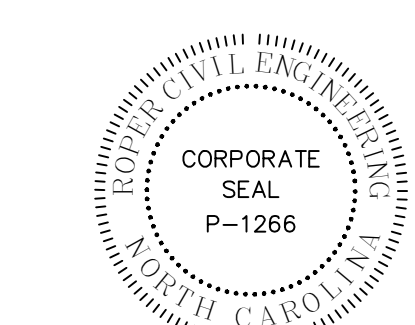

NEW YORK STATE EDUCATION STATEMENT
I, THE UNDERSIGNED, BEING A LICENSED PROFESSIONAL ENGINEER IN THE STATE OF NEW YORK, HAVE REVIEWED THE PROJECT AND THE CONSTRUCTION DOCUMENTS AND HAVE DETERMINED THAT THE PROJECT IS IN ACCORDANCE WITH THE REQUIREMENTS OF THE EDUCATION LAW AND THE CONSTRUCTION DOCUMENTS. I HAVE ADVISED THE STATE EDUCATION DEPARTMENT OF MY REVIEW AND THE DATE OF SUCH REVIEW AND A PRECISE DESCRIPTION OF THE REVIEW.

SHEET INFORMATION

Issued 09.15.2023 Scale 1" = 40'-0"

Project Status Construction Documents

Drawn By MR Checked By MR

Drawing Title Phase 1

Erosion Control Plan

Drawing Number

C200



CONTRACTOR SHALL NOTIFY "NORTH CAROLINA ONE CALL" (811) OR (1-800-632-4949) AT LEAST 48 HOURS PRIOR TO BEGINNING CONSTRUCTION OR EXCAVATION TO HAVE EXISTING UTILITIES LOCATED.
CONTRACTOR SHALL CONTACT ANY LOCAL UTILITIES THAT PROVIDE THEIR OWN LOCATOR SERVICES INDEPENDENT OF "NORTH CAROLINA ONE CALL". REPORT ANY DISCREPANCIES TO THE ENGINEER IMMEDIATELY.

EROSION CONTROL NOTES:

1. THIS EROSION CONTROL PLAN SHALL BE IMPLEMENTED IN ACCORDANCE WITH THE STANDARDS OF NORTH CAROLINA DEPARTMENT OF ENVIRONMENTAL QUALITY AS APPLICABLE. ALL EROSION CONTROL MEASURES SHALL BE CONSTRUCTED IN ACCORDANCE WITH NC EROSION AND SEDIMENT CONTROL PLANNING AND DESIGN MANUAL.
2. ADDITIONAL MEASURES TO CONTROL EROSION AND SEDIMENT MAY BE REQUIRED BY THE INSPECTOR.
3. IN AREAS WHERE SILT FENCE IS NOT REQUIRED, BUT THE CONTRACTOR DESIRES TO RESTRICT ACCESS, ORANGE TREE PROTECTION/BARRIER FENCE MAY BE UTILIZED.
4. STABILIZATION IS THE BEST FORM OF EROSION CONTROL. TEMPORARY SEEDING IS NECESSARY TO ACHIEVE EROSION CONTROL ON LARGE DENUDED AREAS AND ESPECIALLY WHEN SPECIFICALLY REQUIRED AS PART OF THE CONSTRUCTION SEQUENCE. ALL SLOPES MUST BE SEEDED AND MULCHED WITHIN DAYS. REFER TO EROSION CONTROL ORDINANCE FOR ADDITIONAL REQUIREMENTS.
5. ALL EROSION CONTROL DEVICES SHALL BE INSPECTED AT LEAST ONCE PER WEEK AND AFTER EACH STORM EVENT OF 0.5" OR MORE. IF ANY FAILURES ARE FOUND THEY SHOULD BE REPAIRED AS SOON AS POSSIBLE.
6. ANY GRADING BEYOND THE DENUDED LIMITS SHOWN ON THE PLAN IS A VIOLATION OF THE NCDEQ EROSION CONTROL RULES AND IS SUBJECT TO A FINE.
7. ADDITIONAL MEASURES TO CONTROL EROSION AND SEDIMENT MAY BE REQUIRED BY THE ENGINEER AND/OR A REPRESENTATIVE OF THE NCDEQ INSPECTION DEPARTMENT.
8. APPROVAL OF THIS PLAN IS NOT AN AUTHORIZATION TO GRADE ADJACENT PROPERTIES. WHEN FIELD CONDITIONS WARRANT OFF-SITE GRADING, PERMISSION MUST BE OBTAINED FROM THE AFFECTED PROPERTY OWNERS.
9. EFFECTIVE OCTOBER 1, 2010, PERSONS RESPONSIBLE FOR LAND DISTURBING ACTIVITIES MUST INSPECT A PROJECT AFTER EACH PHASE OF THE PROJECT TO MAKE SURE THAT THE APPROVED EROSION AND SEDIMENTATION CONTROL PLAN IS BEING FOLLOWED. SELF-INSPECTION REPORTS ARE REQUIRED. A SAMPLE SELF INSPECTION, AS WELL AS DETAILS OF THE SELF-INSPECTION PROGRAM, CAN BE FOUND ON THE NCDEQ WEBSITE.
10. ANY SEDIMENT OR MATERIAL TRACKED ONTO THE ADJACENT STREETS SHALL BE SWEEPED AND REMOVED IMMEDIATELY.
11. ALL DISTURBED AREAS WILL BE PROVIDED WITH PERMANENT GROUND COVER.

CONSTRUCTION SEQUENCE (PHASE 2):

1. ONCE THE DRAINAGE PIPE HAS BEEN RELOCATED AND TIED INTO THE EXISTING STORM DRAINAGE SYSTEM, THE CONTRACTOR MAY BEGIN INSTALLATION OF THE COMPACTED STONE SUBGRADE FOR THE TRACK REPLACEMENT.
2. CONTRACTOR TO BEGIN WORK ON OTHER HARDSCAPE AREAS OF THE TRACK REPLACEMENT PLAN INCLUDING SIDEWALK ACCESS, LONG JUMP RUNWAYS, POLE VAULT RUNWAYS, HIGH JUMP PAD, AND THROWING PADS.
3. CONTRACTOR TO INSTALL PERIMETER CURB AND PAVING SURFACE FOR TRACK AS SHOWN ON THE PLANS. CONTRACTOR TO INSTALL PERIMETER FENCE AROUND TRACK AFTER PAVING IS COMPLETE.
4. CONTRACTOR TO INSTALL FIELD ITEMS (LONG JUMP RUNWAYS, POLE VAULT RUNWAYS, HIGH JUMP PAD, AND THROWING PADS, ETC.) AS SHOWN ON THE PLANS.
5. SELF-INSPECTIONS FOR EROSION AND SEDIMENTATION CONTROL MEASURES ARE TO BE PERFORMED AT LEAST ONCE EVERY SEVEN CALENDAR DAYS AND WITHIN 24 HOURS OF EVERY RAIN EVENT OF GREATER THAN 1-INCH. ANY NEEDED REPAIRS SHALL BE MADE IMMEDIATELY TO MAINTAIN MEASURES AS DESIGNED. ALL E&S MEASURES SHALL BE MAINTAINED AS SPECIFIED IN THE CONSTRUCTION DETAILS ON THIS PLAN. A RAIN GAUGE SHALL BE INSTALLED AT THE PROJECT SITE FOR MONITORING.
6. STABILIZATION IS THE BEST FORM OF EROSION CONTROL. TEMPORARY SEEDING IS NECESSARY TO ACHIEVE EROSION CONTROL ON LARGE DENUDED AREAS. ALL SLOPES MUST BE SEEDED AND MULCHED WITHIN DAYS. REFER TO EROSION CONTROL ORDINANCE FOR ADDITIONAL REQUIREMENTS.
7. THE CONTRACTOR SHALL DILIGENTLY AND CONTINUOUSLY MAINTAIN ALL EROSION CONTROL DEVICES.
8. STABILIZE THE SITE AS AREAS ARE BROUGHT UP TO FINISHED GRADE.
9. AFTER FINAL SITE STABILIZATION OCCURS, COORDINATE WITH THE INSPECTOR PRIOR TO REMOVAL OF EROSION CONTROL MEASURES.
10. WHEN THE PROJECT IS COMPLETE, THE PERMITTEE SHALL CONTACT DEMLR TO CLOSE OUT THE E&S PLAN. SUBMIT NOTICE OF TERMINATION (NOT) TO WILSON COUNTY AND NCDEQ, AS APPROPRIATE.

DEWATERING NOTE:

DEWATERING MAY BE NECESSARY IN THE EXCAVATION AREAS (E.G. SUBGRADE AREAS). THEREFORE, THE CONTRACTOR SHALL FURNISH, INSTALL, OPERATE, AND MAINTAIN ANY PUMPING EQUIPMENT, ETC. NEEDED FOR REMOVAL OF WATER FROM VARIOUS PARTS OF THE SITE. DURING PLACEMENT OF FILL WITHIN THESE AREAS, THE CONTRACTOR SHALL KEEP THE WATER LEVEL BELOW THE BOTTOM OF THE EXCAVATION / CONSTRUCTION AREAS. THE MANNER IN WHICH THE WATER IS REMOVED SHALL BE SUCH THAT THE EXCAVATION BOTTOM AND SIDE SLOPES ARE STABLE, WITH NO SEDIMENT DISCHARGED FROM THE SITE (I.E. PUMPED WATER MAY NEED TO BE DIRECTED TO AN APPROVED EROSION CONTROL DEVICE PRIOR TO DISCHARGE).

EROSION CONTROL MAINTENANCE:

1. CHECK ALL EROSION AND SEDIMENT CONTROL MEASURES FOLLOWING EVERY RUNOFF PRODUCING RAIN EVENT, BUT NO LESS THAN ONCE A WEEK. ANY REPAIRS SHALL BE MADE IMMEDIATELY TO MAINTAIN MEASURES AS DESIGNED.
2. SEDIMENT COLLECTED BEHIND INLET PROTECTION SHALL BE CLEANED OUT BEFORE THE SEDIMENT REACHES AN ELEVATION WITHIN 6-INCHES OF THE OVERFLOW. PLACE THE REMOVED SEDIMENT IN THE STOCKPILE AREA.
3. SEDIMENT SHALL BE CLEANED OUT FROM BEHIND THE SEDIMENT FENCES BEFORE IT REACHES 6-INCHES DEEP AT THE FENCE. THE FENCING SHALL BE REPAIRED AS NECESSARY TO MAINTAIN A FUNCTIONING BARRIER. PLACE THE REMOVED SEDIMENT IN THE STOCKPILE AREAS.
4. SLOPES THAT ARE FLATTER THAN 3:1, WITHIN 14 CALENDAR DAYS OF COMPLETION OF ANY PHASE OF GRADING, SHALL BE PROVIDED WITH GROUND COVER.
5. ALL SEEDED AREAS SHALL BE FERTILIZED, RESEEDED, AND MULCHED AS NECESSARY TO MAINTAIN DENSE VEGETATED COVER.

GENERAL NOTES:

1. THE INSTALLATION OF UTILITIES (CABLE, ELECTRICAL, NATURAL GAS, WATER, SEWER, ETC.) ARE TO BE WITHIN THE PERMITTED LIMITS OF DISTURBANCE AND ANY PROPOSED INSTALLATION OUTSIDE OF THESE AREAS WILL REQUIRE A PLAN MODIFICATION TO THE PERMIT BEFORE SAID WORK IS DONE.
2. THE LOCATION OF ANY POSSIBLE STOCKPILES, OFFSITE MATERIAL, WASTE, BORROW, OR CONSTRUCTION EQUIPMENT STORAGE / LAYDOWN AREAS SHALL BE WITHIN THE LIMITS OF DISTURBANCE, ALONG WITH ADEQUATE SEDIMENT AND EROSION CONTROL MEASURES.



TOTAL DENUDED AREA = 3.8 ACRES

GROUND STABILIZATION		
SITE AREA DESCRIPTION	STABILIZATION TIME FRAME	STABILIZATION TIME FRAME EXCEPTIONS
PERIMETER DIKES, SWALES, DITCHES AND SLOPES	7 DAYS	NONE
HIGH QUALITY WATER (HOW) ZONES	7 DAYS	NONE
SLOPES STEEPER THAN 3:1	7 DAYS	IF SLOPES ARE 10' OR LESS IN LENGTH AND ARE NOT STEEPER THAN 2:1, 14 DAYS ARE ALLOWED
SLOPES 3:1 OR FLATTER	14 DAYS	7-DAYS FOR SLOPES GREATER THAN 50 FEET IN LENGTH
ALL OTHER AREAS WITH SLOPES FLATTER THAN 4:1	14 DAYS	NONE (EXCEPT FOR PERIMETERS AND HOW ZONES)

WETLANDS NOTE:


THERE ARE NO JURISDICTIONAL WETLANDS IN THE PROJECT AREA. NO JURISDICTIONAL WETLANDS WILL BE IMPACTED DURING CONSTRUCTION.

100% CONSTRUCTION DOCUMENTS

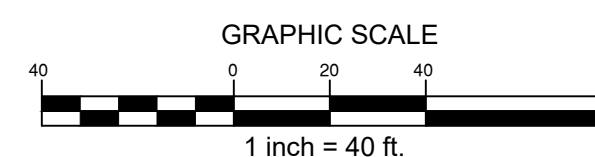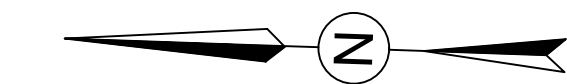

LEGEND:

- EXISTING CONTOUR
- SD --- EXISTING STORM PIPE
- EXISTING DRAIN INLET
- LD --- PROPOSED LIMITS OF DISTURBANCE
- SF --- SF --- PROPOSED TEMPORARY SILT FENCE
- ⊙ --- PROPOSED INLET PROTECTION
- ⊙ --- PROPOSED SILT FENCE ROCK OUTLET

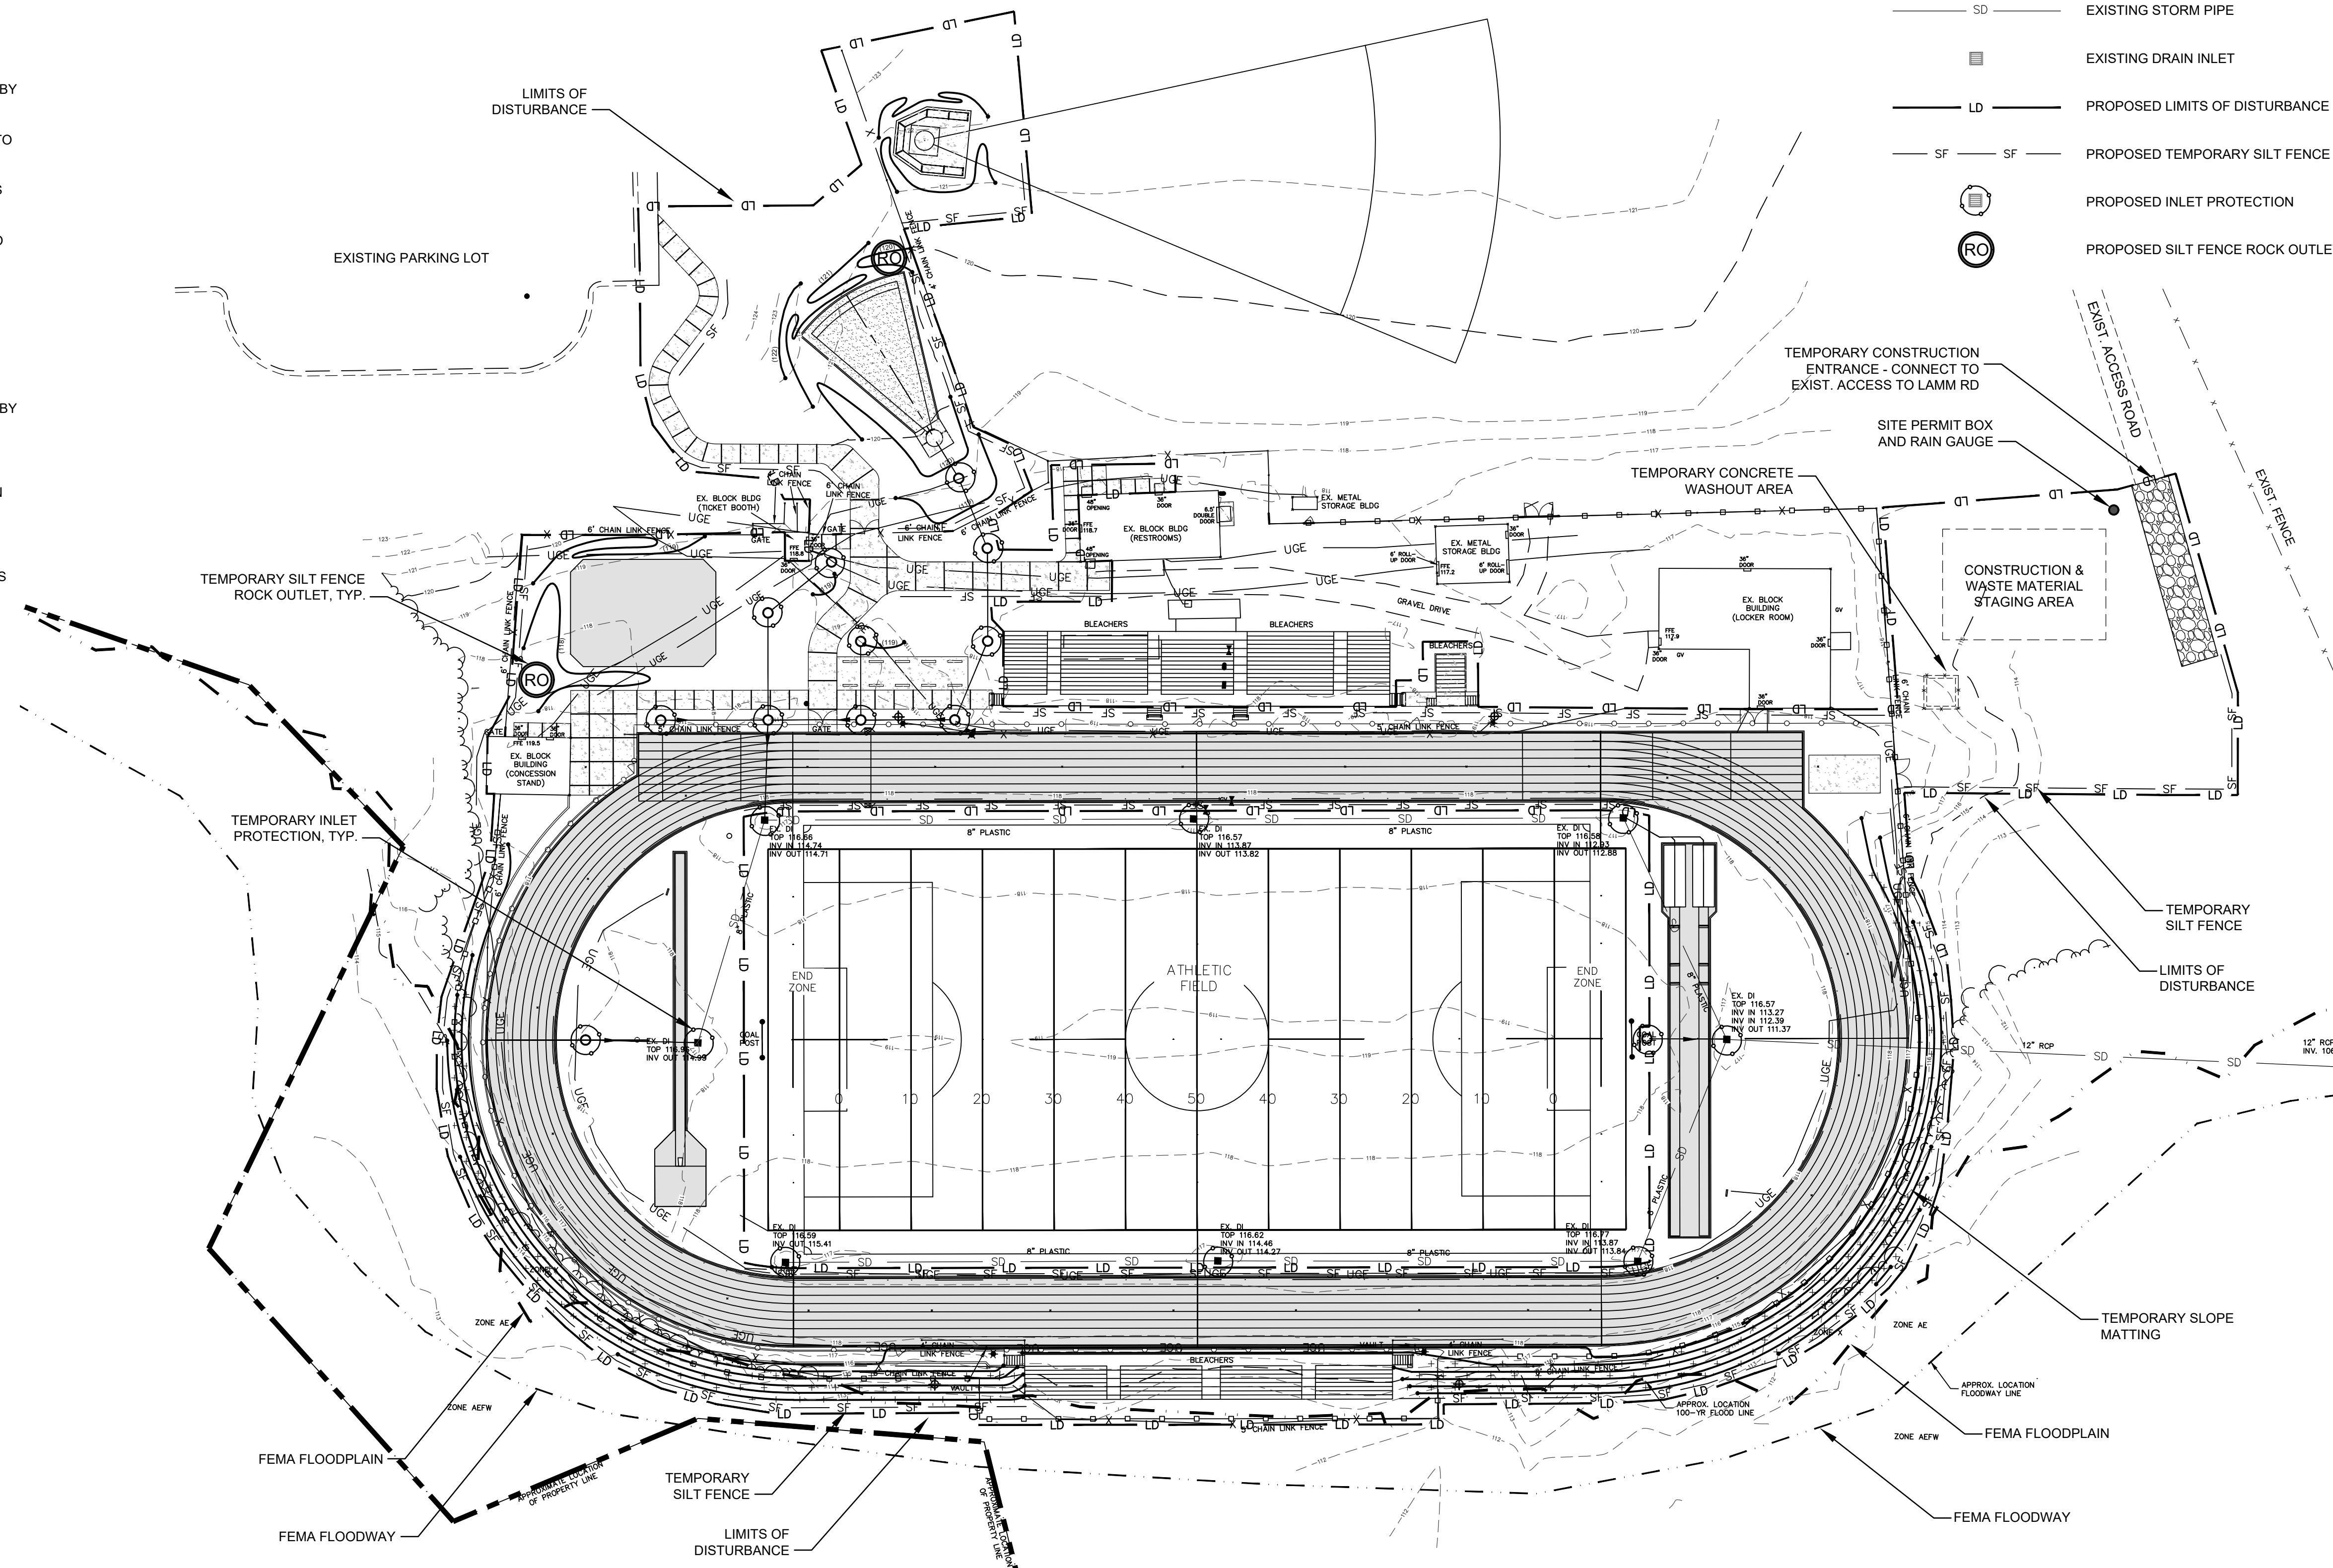

PROJECT INFORMATION


Project Number: R22.16900.00
Client Name: WILSON COUNTY SCHOOLS

PROJECT INFORMATION

Project Name: HUNT HS - ATHLETICS RENOVATION
HUNT HIGH SCHOOL
District Office Address: 4559 Lamm Rd., Wilson, NC 27893

PROJECT ISSUE & REVISION SCHEDULE

NO. CODE DESCRIPTION

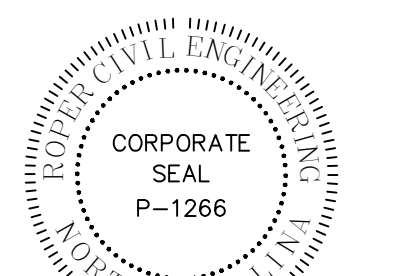

NEW YORK STATE EDUCATION STATEMENT

THE EDUCATION OF THE NEW YORK STATE EDUCATION LAW AND THE COMPLETION OF THE REQUIREMENTS FOR ANY PROFESSION, LICENSED UNDER THE REGULATION OF A LICENSED PROFESSION, ENGINEER OR LAND SURVEYOR, IS THE RESPONSIBILITY OF THE INDIVIDUAL. THE BOARD OF STATE EDUCATION HAS THE HONOR AND THE DUTY TO PROTECT THE PUBLIC INTEREST AND THE QUALITY OF THE EDUCATION SYSTEM. THE BOARD HAS THE HONOR AND THE DUTY TO PROTECT THE PUBLIC INTEREST AND THE QUALITY OF THE EDUCATION SYSTEM.

SHEET INFORMATION

Issued: 09.15.2023 Scale: 1" = 40'-0"
Project Status: CONSTRUCTION DOCUMENTS
Drawn By: MR Checked By: MR
Drawing Title: Phase 2 Erosion Control Plan
Drawing Number:

C201



CONTRACTOR SHALL NOTIFY "NORTH CAROLINA ONE CALL" (811) OR (1-800-632-4949) AT LEAST 48 HOURS PRIOR TO BEGINNING CONSTRUCTION OR EXCAVATION TO HAVE EXISTING UTILITIES LOCATED.
CONTRACTOR SHALL CONTACT ANY LOCAL UTILITIES THAT PROVIDE THEIR OWN LOCATOR SERVICES INDEPENDENT OF "NORTH CAROLINA ONE CALL". REPORT ANY DISCREPANCIES TO THE ENGINEER IMMEDIATELY.

PROJECT INFORMATION

Project Number
 R22.16900.00

Client Name
WILSON COUNTY SCHOOLS


Project Name
HUNT HS - ATHLETICS RENOVATION

HUNT HIGH SCHOOL

District Office Address
 4559 Lamm Rd., Wilson, NC 27893

PROJECT ISSUE & REVISION SCHEDULE


Rev. Code Description

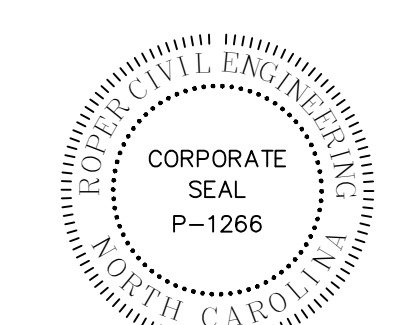

NEW YORK STATE EDUCATION STATEMENT
 I am a holder of my New York State Education License and the Commissioner's Regulation for any profession, unless stated under the direction of a licensed professional engineer or landscape architect, and I am not aware of any disciplinary action taken by the State Education Department or the State Board of Regents against me in the jurisdiction and the date of such action and a specific description of the action.


SHEET INFORMATION

Scale
 09.15.2023 NTS
 Project Status
 CONSTRUCTION DOCUMENTS
 Drawn By
 MR
 Checked By
 MR
 Drawing Title
 Erosion Control Details
 Drawing Number

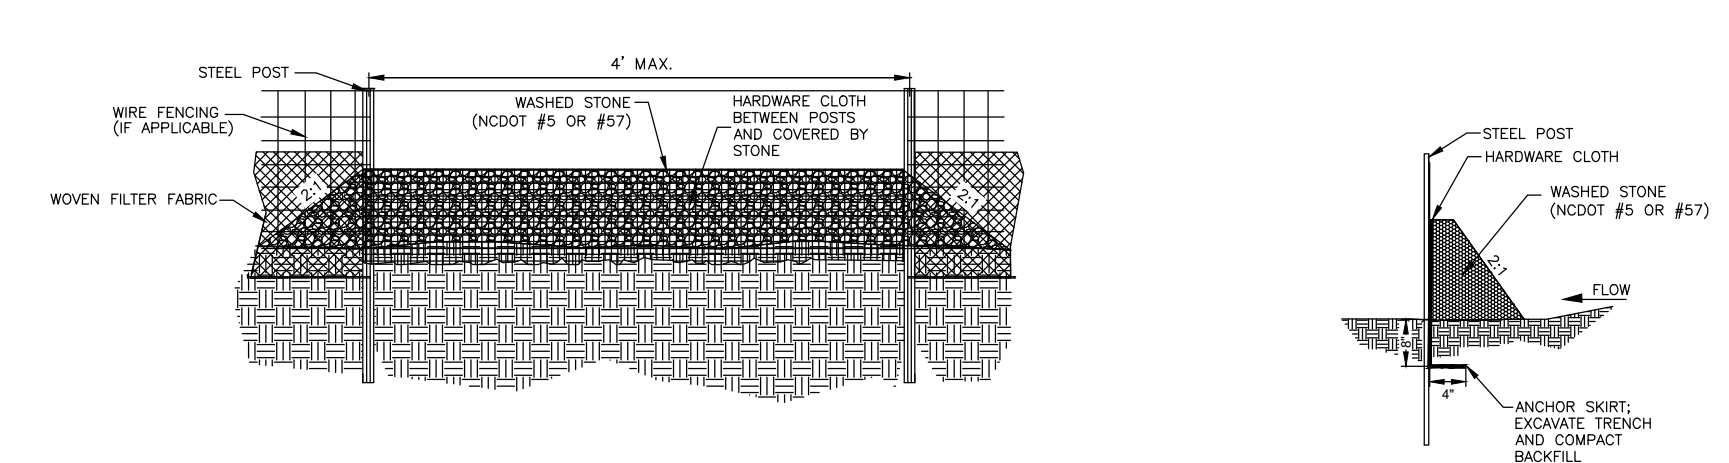


- GENERAL NOTES:**
- SEDIMENT FILTER OUTLET AND HARDWARE CLOTH SHALL BE 18 INCHES HIGH BUT NO TALLER THAN 18 INCHES.
 - HARDWARE CLOTH SHALL BE ANCHORED TO THE STEEL POSTS SECURELY USING APPROPRIATE ANCHORS. HARDWARE CLOTH SHALL BE KEPT IN A MINIMUM OF 12 INCHES IN LENGTH AND BACKFILLED PROPERLY AS SHOWN IN ABOVE DETAIL. HARDWARE CLOTH TO BE SAME AS STD. #40-UP (19 GAUGE, 1/4" SPACING).
 - POSTS SHALL BE NO MORE THAN 4 FEET APART.
 - SITE OUTLETS AT ANY POINT SMALL CONCENTRATED FLOWS ARE ANTICIPATED AND AT THE DIRECTION OF THE INSPECTOR.
- MAINTENANCE NOTES:**
- FILTER OUTLETS SHALL BE INSPECTED BY THE FINANCIALLY RESPONSIBLE PARTY OR HIS AGENT IMMEDIATELY AFTER EACH RAINFALL AND AT LEAST DAILY DURING PROLONGED RAINFALL. ANY REPAIRS NEEDED SHALL BE MADE IMMEDIATELY.
 - THE STONE SHALL BE REPLACED PROMPTLY AFTER ANY EVENT THAT HAS CLOGGED OR REMOVED IT.
 - SEDIMENT DEPOSITS SHOULD BE REMOVED WHEN DEPOSITS REACH HALF THE HEIGHT OF THE BARRIER. ANY SEDIMENT DEPOSITS REMAINING IN PLACE AFTER THE SILT FENCE OUTLET IS REMOVED SHALL BE DRESSED TO CONFORM TO THE EXISTING GRADE, PREPARED AND SEEDED.

3 SILT FENCE OUTLET
 NOT TO SCALE

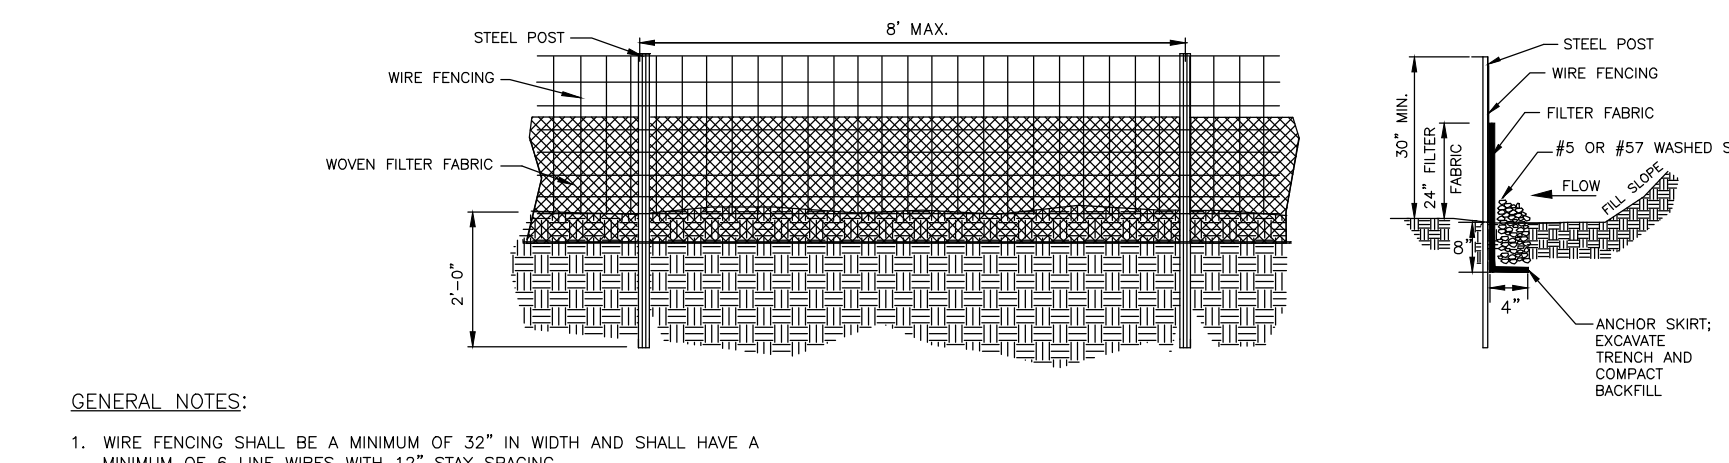

- GENERAL NOTES:**
- WIRE FENCING SHALL BE A MINIMUM OF 32" IN WIDTH AND SHALL HAVE A MINIMUM OF 6 LINE WIRES WITH 12" STAY SPACING.
 - WOVEN FILTER FABRIC BE USED WHERE SILT FENCE IS TO REMAIN FOR A PERIOD OF MORE THAN 30 DAYS.
 - STEEL POSTS SHALL BE 5'-0" IN HEIGHT AND BE OF THE SELF-FASTENER ANGLE STEEL TYPE.
 - WIRE FENCING SHALL BE AT LEAST #10 GAUGE WITH A MINIMUM OF 6 LINE WIRES WITH 6" STAY SPACING.
 - TURN SILT FENCE UP SLOPE AT ENDS.
 - WIRE AND WASHED STONE IS REQUIRED TO BE SHOWN ON PLANS AT THE TOE OF SLOPES GREATER THAN 10 FEET VERTICAL (2:1 SLOPE).
 - ORANGE SAFETY FENCE IS REQUIRED AT BACK OF SILT FENCE WHEN GRADING IS ADJACENT TO SWIM BUFFERS, STREAMS OR WETLANDS (REFER TO SWIM BUFFER GUIDELINES). THE COLOR ORANGE IS RESERVED FOR VISUAL IDENTIFICATION OF ENVIRONMENTALLY SENSITIVE AREAS.
 - DRAINAGE AREA CAN NOT BE GREATER THAN 1/4 ACRE PER 100 FT OF FENCE.
 - SLOPE LENGTHS CAN NOT EXCEED CRITERIA SHOWN IN TABLE 6.62A NORTH CAROLINA EROSION AND SEDIMENT CONTROL PLANNING AND DESIGN MANUAL.
 - DO NOT INSTALL SEDIMENT FENCE ACROSS STREAMS, DITCHES, WATERWAYS OR OTHER AREAS OF CONCENTRATED FLOW.
- MAINTENANCE NOTES:**
- FILTER BARRIERS SHALL BE INSPECTED BY THE FINANCIALLY RESPONSIBLE PARTY OR HIS AGENT IMMEDIATELY AFTER EACH RAINFALL AND AT LEAST DAILY DURING PROLONGED RAINFALL. ANY REPAIRS NEEDED SHALL BE MADE IMMEDIATELY.
 - SHOULD THE FABRIC DECOMPOSE OR BECOME INEFFECTIVE PRIOR TO THE END OF THE EXPECTED USABLE LIFE AND THE BARRIER STILL IS NECESSARY, THE FABRIC SHALL BE REPLACED PROMPTLY.
 - SEDIMENT DEPOSITS SHOULD BE REMOVED WHEN DEPOSITS REACH APPROX. HALF THE HEIGHT OF THE BARRIER. ANY SEDIMENT DEPOSITS REMAINING IN PLACE AFTER THE SILT FENCE IS REMOVED SHALL BE DRESSED TO CONFORM TO THE EXISTING GRADE, PREPARED AND SEEDED.
 - DO NOT INSTALL SEDIMENT FENCE ACROSS STREAMS, DITCHES, WATERWAYS OR OTHER AREAS OF CONCENTRATED FLOW.


2 TEMPORARY HIGH HAZARD SILT FENCE
 NOT TO SCALE

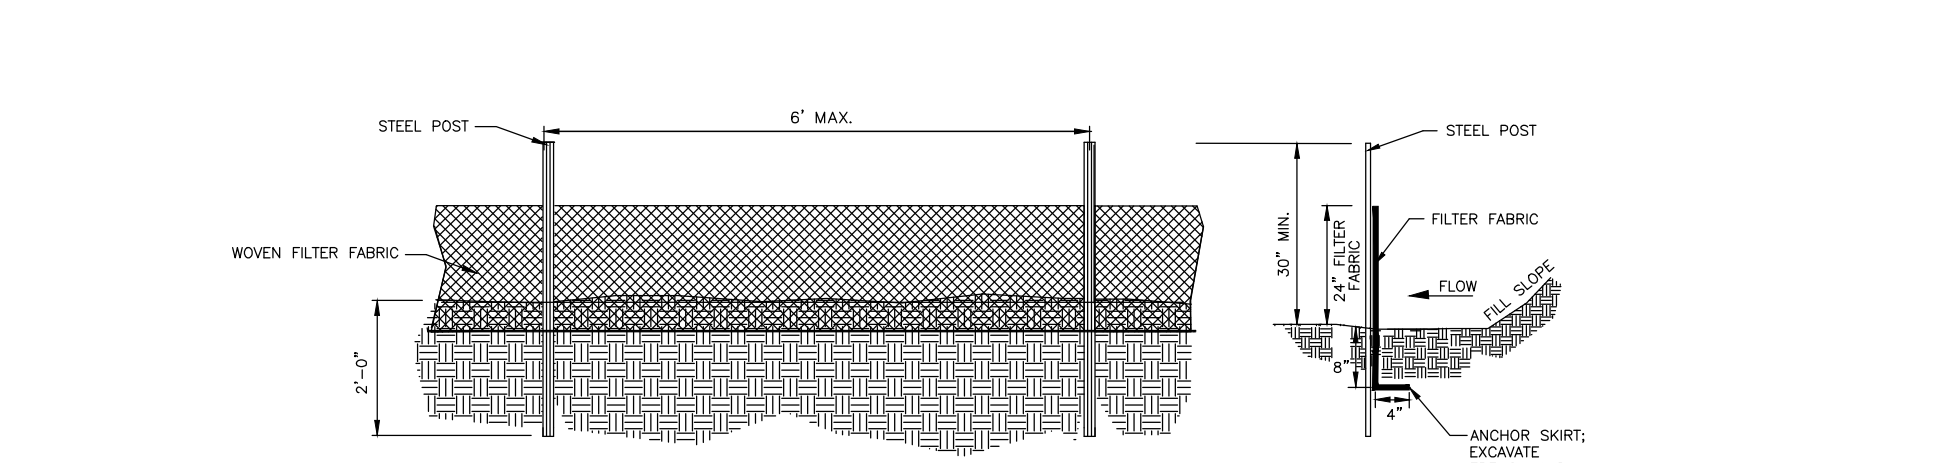


- GENERAL NOTES:**
- WOVEN FILTER FABRIC BE USED WHERE SILT FENCE IS TO REMAIN FOR A PERIOD OF MORE THAN 30 DAYS.
 - STEEL POSTS SHALL BE 5'-0" IN HEIGHT AND BE OF THE SELF-FASTENER ANGLE STEEL TYPE.
 - TURN SILT FENCE UP SLOPE AT ENDS.
 - ORANGE SAFETY FENCE IS REQUIRED AT BACK OF SILT FENCE WHEN GRADING IS ADJACENT TO SWIM BUFFERS, STREAMS OR WETLANDS (REFER TO SWIM BUFFER GUIDELINES). THE COLOR ORANGE IS RESERVED FOR VISUAL IDENTIFICATION OF ENVIRONMENTALLY SENSITIVE AREAS.
 - DRAINAGE AREA CAN NOT BE GREATER THAN 1/4 ACRE PER 100 FT OF FENCE.
 - SLOPE LENGTHS CAN NOT EXCEED CRITERIA SHOWN IN TABLE 6.62A NORTH CAROLINA EROSION AND SEDIMENT CONTROL PLANNING AND DESIGN MANUAL.
 - DO NOT INSTALL SEDIMENT FENCE ACROSS STREAMS, DITCHES, WATERWAYS OR OTHER AREAS OF CONCENTRATED FLOW.
- MAINTENANCE NOTES:**
- FILTER BARRIERS SHALL BE INSPECTED BY THE FINANCIALLY RESPONSIBLE PARTY OR HIS AGENT IMMEDIATELY AFTER EACH RAINFALL AND AT LEAST DAILY DURING PROLONGED RAINFALL. ANY REPAIRS NEEDED SHALL BE MADE IMMEDIATELY.
 - SHOULD THE FABRIC DECOMPOSE OR BECOME INEFFECTIVE PRIOR TO THE END OF THE EXPECTED USABLE LIFE AND THE BARRIER STILL IS NECESSARY, THE FABRIC SHALL BE REPLACED PROMPTLY.
 - SEDIMENT DEPOSITS SHOULD BE REMOVED WHEN DEPOSITS REACH APPROX. HALF THE HEIGHT OF THE BARRIER. ANY SEDIMENT DEPOSITS REMAINING IN PLACE AFTER THE SILT FENCE IS REMOVED SHALL BE DRESSED TO CONFORM TO THE EXISTING GRADE, PREPARED AND SEEDED.

1 TEMPORARY SILT FENCE
 NOT TO SCALE

- MAINTENANCE NOTES:**
- REGULAR INSPECTION OF CATCH BASIN INLET PROTECTION SHALL BE CONDUCTED ONCE EVERY SEVEN CALENDAR DAYS AND WITHIN 24-HOURS AFTER EACH RAINFALL GREATER THAN 1-INCH.
 - CLEAN OR REPLACE FILTER BAG WHEN THE SEDIMENT REACHES 1/2 HEIGHT OF THE BAG.
 - REMOVED SEDIMENT SHALL BE PLACED IN STOCKPILE STORAGE AREAS OR SPREAD THINLY ACROSS DISTURBED AREA. STABILIZE THE REMOVED SEDIMENT AFTER IT IS RELOCATED.
 - INLET PROTECTION FILTER BAGS SHOULD BE REMOVED AFTER THE DISTURBED AREAS ARE PERMANENTLY STABILIZED AND DISPOSED OF PROPERLY.

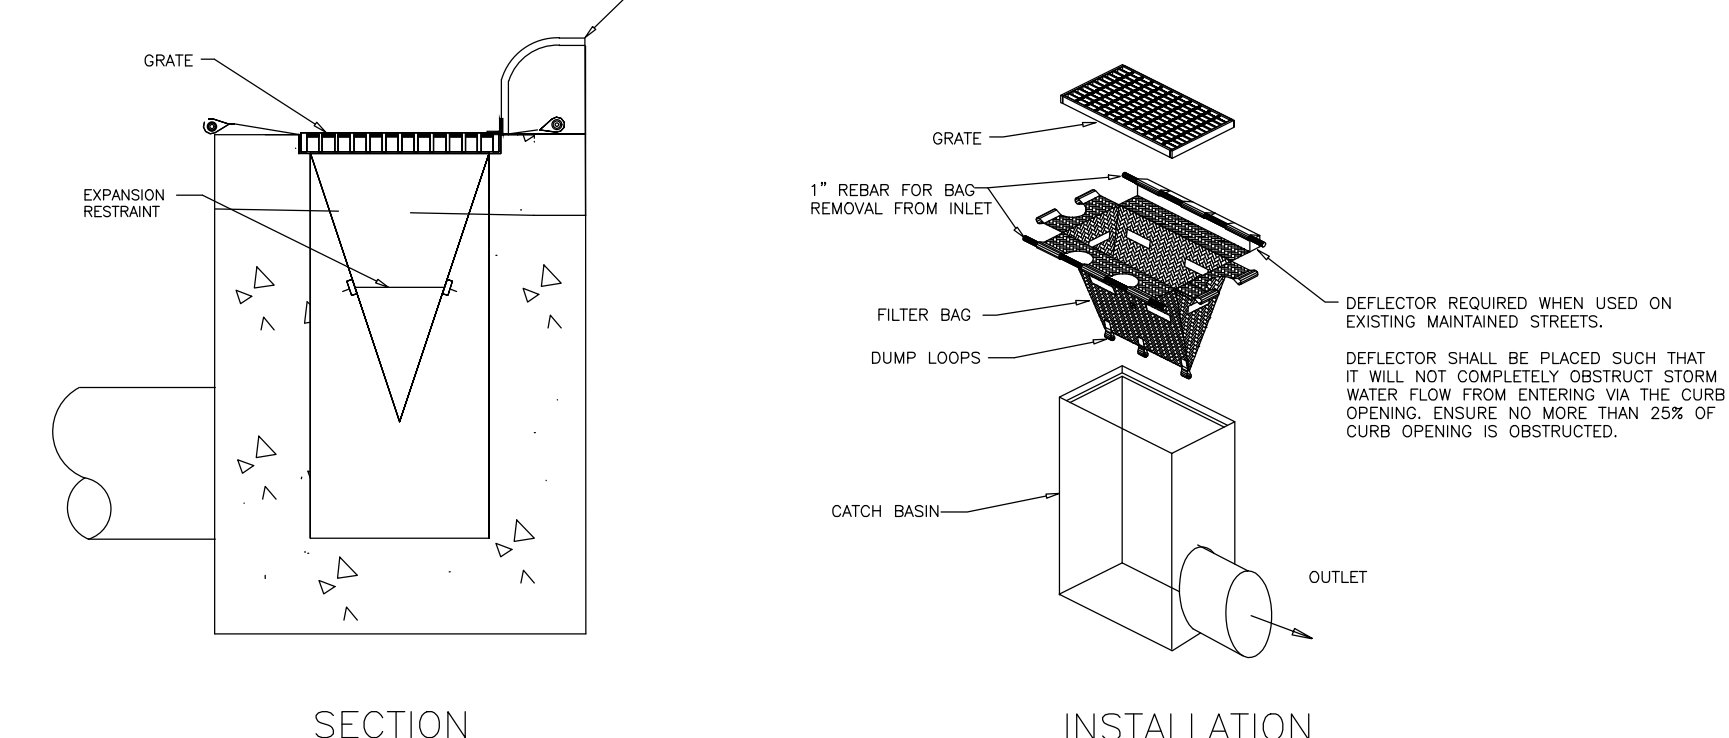


6 CATCH BASIN INLET PROTECTION
 NOT TO SCALE

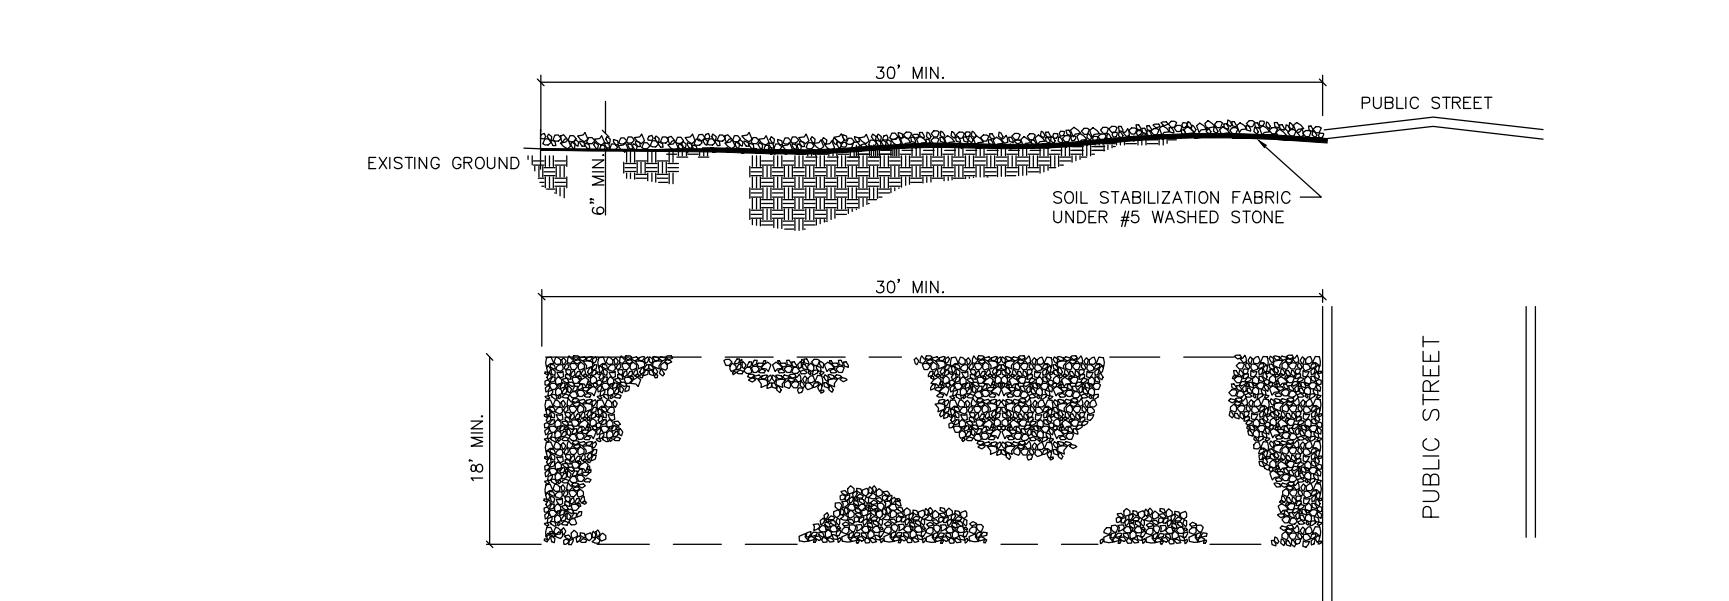


- NOTES:**
- A STABILIZED ENTRANCE PAD OF #5 WASHED STONE AND RAILROAD BALLAST SHALL BE LOCATED WHERE TRAFFIC WILL ENTER OR LEAVE THE CONSTRUCTION SITE ONTO A PUBLIC STREET.
 - FILTER FABRIC OR COMPACTED CRUSHER RUN STONE SHALL BE USED AS A BASE FOR THE CONSTRUCTION ENTRANCE.
 - THE ENTRANCE SHALL BE MAINTAINED IN A CONDITION WHICH WILL PREVENT TRACKING OR FLOWING OF SEDIMENT ONTO PUBLIC STREETS OR EXISTING PAVEMENT. THIS MAY REQUIRE PERIODIC TOP DRESSING WITH ADDITIONAL STONE AS CONDITIONS WARRANT AND REPAIR OR CLEANOUT OF ANY MEASURES USED TO TRAP SEDIMENT.
 - ANY SEDIMENT SPILLED, DROPPED, WASHED, OR TRACKED ONTO PUBLIC STREETS MUST BE REMOVED IMMEDIATELY. ANY AGGREGATE TRACKED INTO THE ROADWAY MUST BE SWEEP BACK ON-SITE ON A NIGHTLY BASIS.
 - WHEN APPROPRIATE, WHEELS MUST BE CLEANED TO REMOVE SEDIMENT PRIOR TO ENTERING A PUBLIC STREET. WHEN WASHING IS REQUIRED, IT SHALL BE DONE IN AN AREA STABILIZED WITH CRUSHED STONE WHICH DRAINS INTO AN APPROVED SEDIMENT BASIN.
- MAINTENANCE NOTES:**
- REGULAR INSPECTION OF WIRE MESH AND STONE INLET PROTECTION SHALL BE CONDUCTED ONCE EVERY SEVEN CALENDAR DAYS AND WITHIN 24-HOURS AFTER EACH RAINFALL GREATER THAN 1-INCH.
 - DURING REGULAR INSPECTIONS, CHECK FOR MUD AND SEDIMENT BUILDUP AND POND INFESTION. INSPECTION FREQUENCIES MAY NEED TO BE MORE FREQUENT DURING LONG PERIODS OF WET WEATHER.
 - RESHAPE STONE PAD AS NECESSARY FOR DRAINAGE AND RUNOFF CONTROL.
 - WASH OR REPLACE STONES AS NEEDED AND AS DIRECTED BY SITE INSPECTOR. THE STONE IN THE ENTRANCE SHOULD BE WASHED OR REPLACED WHENEVER THE ENTRANCE FAILS TO REDUCE THE AMOUNT OF MUD BEING CARRIED OFF-SITE BY VEHICLES.
 - CONSTRUCTION ENTRANCES SHOULD BE REMOVED AFTER THE DISTURBED AREAS ARE PERMANENTLY STABILIZED. PERMANENT VEGETATION SHOULD REPLACE AREAS FROM WHICH CONSTRUCTION ENTRANCES HAVE BEEN REMOVED, UNLESS AREA WILL BE CONVERTED TO AN IMPROVED SURFACE.

5 STABILIZED CONSTRUCTION ENTRANCE
 NOT TO SCALE

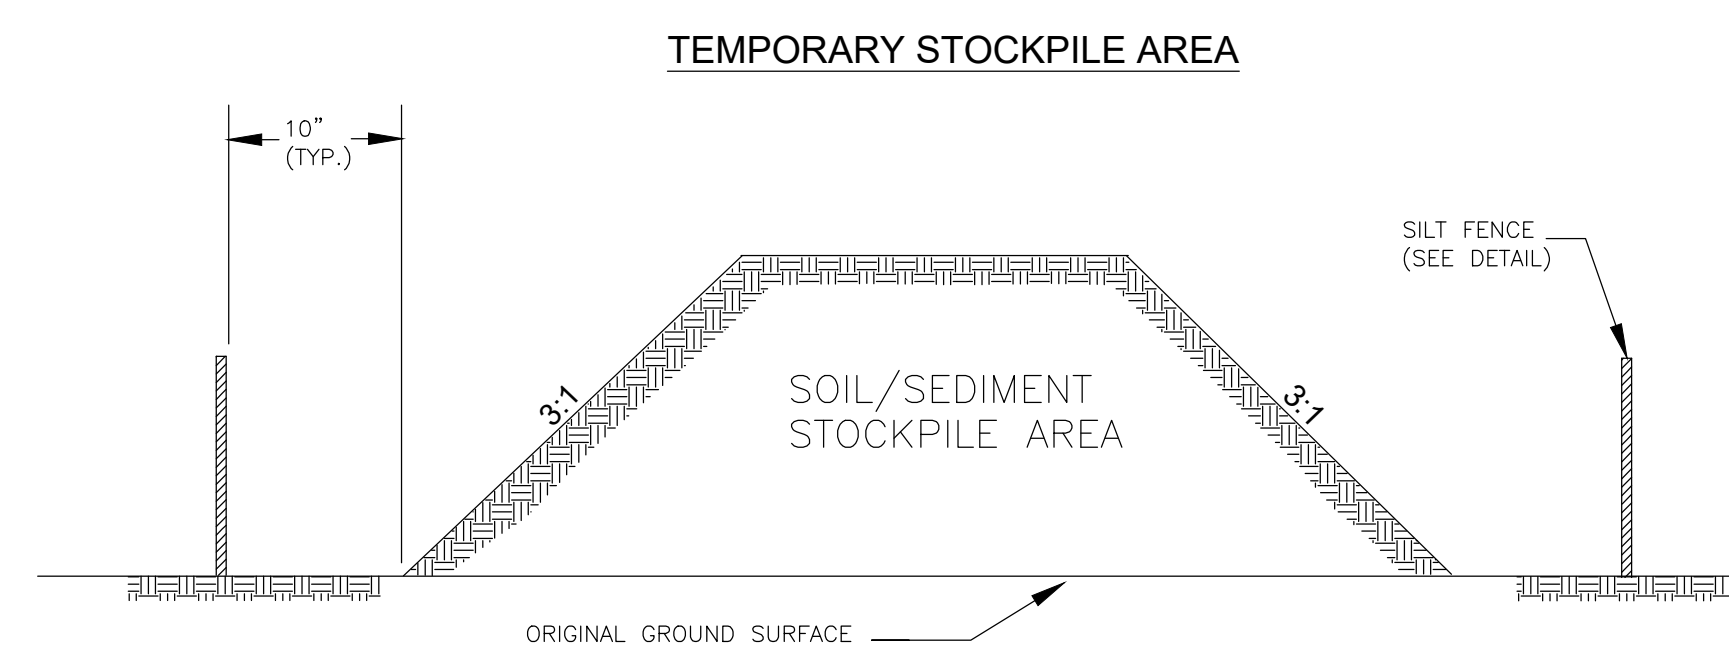

- NOTES:**
- SILT FENCE TO EXTEND AROUND ENTIRE PERIMETER OF STOCKPILE, OR IF STOCKPILE AREA IS LOCATED ON/NEAR A SLOPE THE SILT FENCE IS TO EXTEND ALONG CONTOURS OF THE DOWN-GRADIENT AREA.
 - IF STOCKPILE IS TO REMAIN FOR MORE THAN 14 DAYS, TEMPORARY STABILIZATION MEASURES MUST BE IMPLEMENTED.
 - SILT FENCE SHALL BE MAINTAINED UNTIL STOCKPILE AREA HAS EITHER BEEN REMOVED OR PERMANENTLY STABILIZED.
 - THE KEY TO FUNCTIONAL TEMPORARY STOCKPILE AREAS IS WEEKLY INSPECTIONS, ROUTINE MAINTENANCE, AND REGULAR SEDIMENT REMOVAL.


9 TEMPORARY STOCKPILE AREA
 NOT TO SCALE

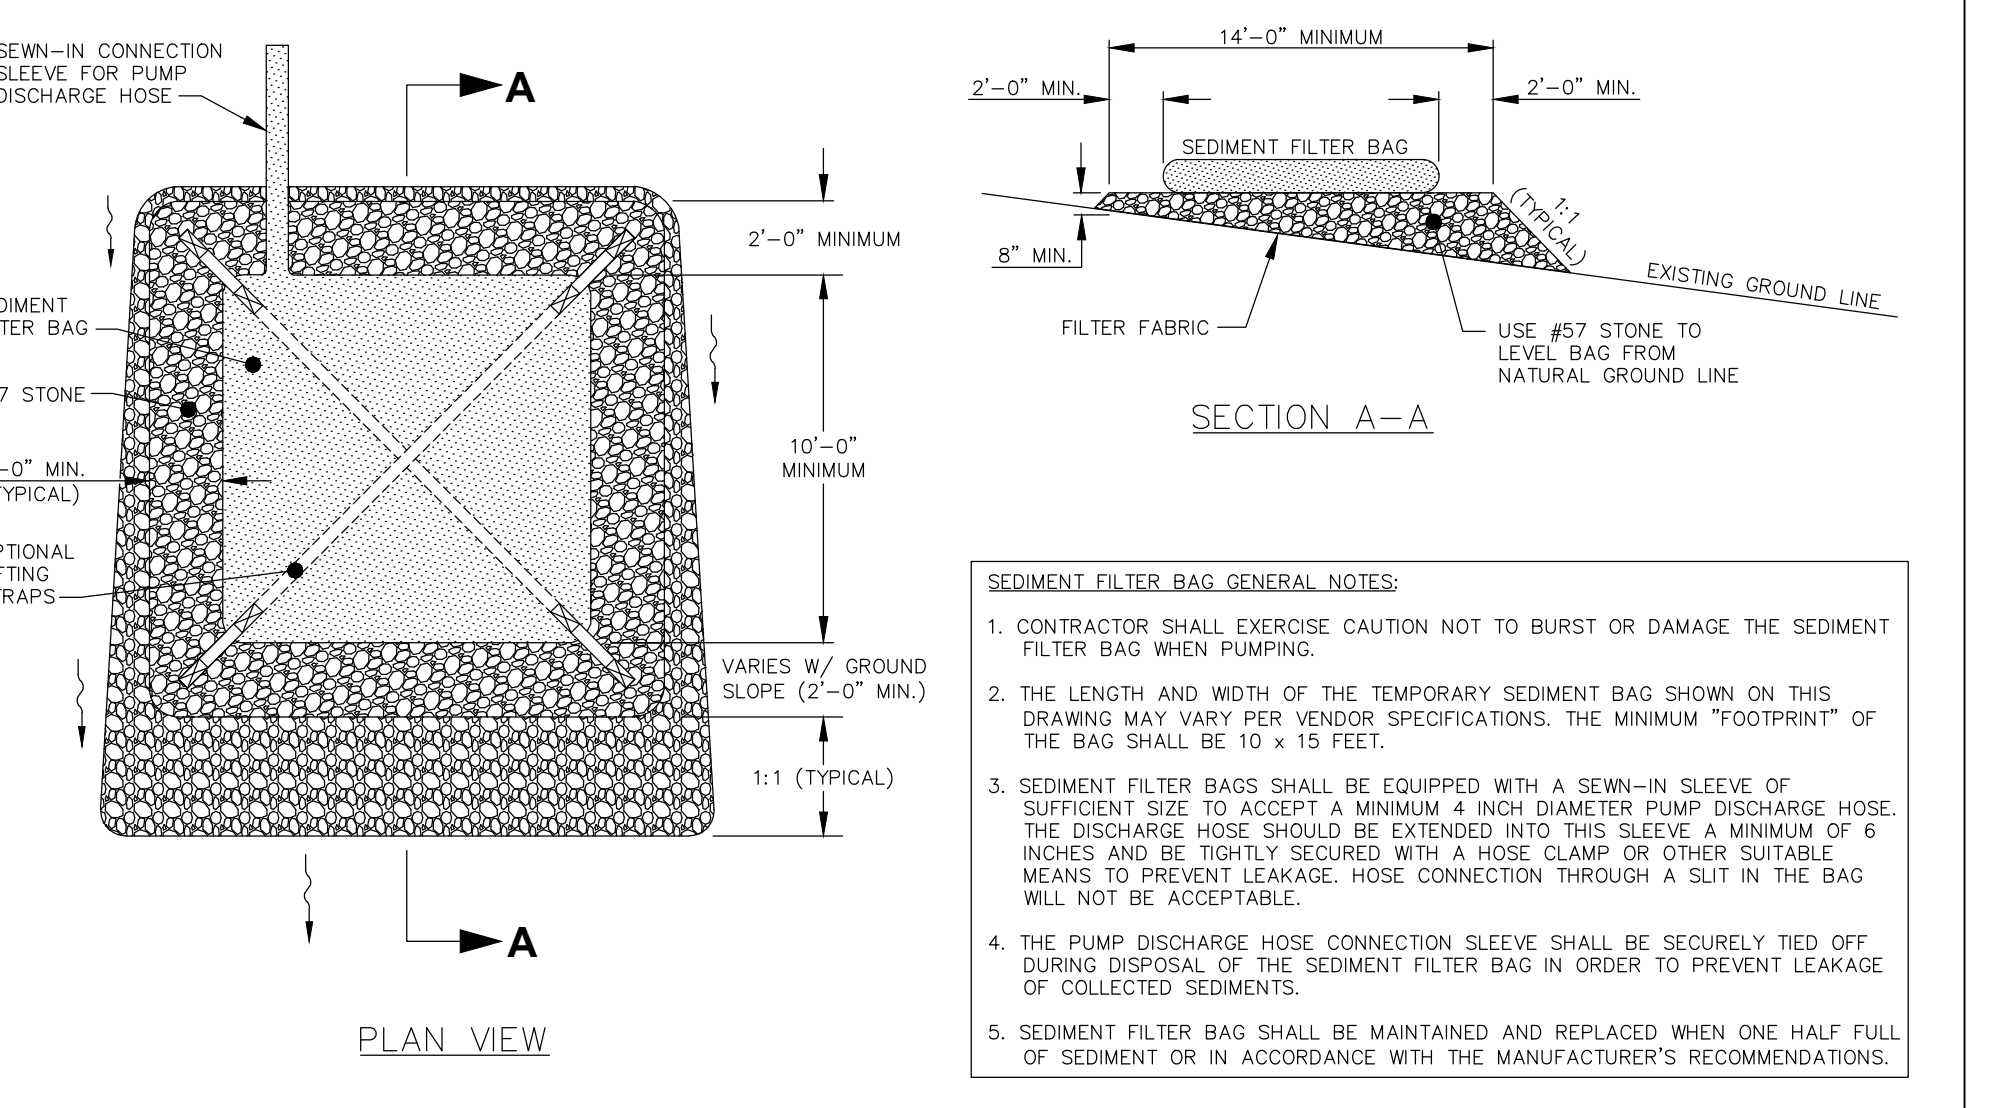

8 SILT BAG
 NOT TO SCALE

- FOR LATE WINTER AND EARLY SPRING:**
- SEEDING MIXTURE:**
 RYE (GRAIN) - 120 LB/ACRE
 ANNUAL LESPEDEZA (KOBE) - 50 LB/ACRE
 (OMIT ANNUAL LESPEDEZA WHEN DURATION OF TEMPORARY COVER IS NOT TO EXTEND BEYOND JUNE)
- SEEDING DATES:**
 JAN. 1 - MAY 1
- FOR SUMMER:**
- SEEDING MIXTURE:**
 GERMAN MILLET - 40 LB/ACRE
 (A SMALL-STEMMED SUDANGRASS MAY BE SUBSTITUTED AT A RATE OF 50 LB/ACRE)
- SEEDING DATES:**
 MAY 1 - AUG. 15
- FOR FALL:**
- SEEDING MIXTURE:**
 RYE (GRAIN) - 120 LB/ACRE
- SEEDING DATES:**
 AUG. 15 - DEC 30
- SOIL AMENDMENTS:**
 FOLLOW RECOMMENDATIONS OF SOIL TESTS OR APPLY 2,000 LB/ACRE GROUND AGRICULTURAL LIMESTONE AND 750 LB/ACRE 10-10-10 FERTILIZER
- MULCH:**
 APPLY 4,000 LB/ACRE STRAW. ANCHOR STRAW BY TACKING WITH ASPHALT, NETTING, OR A MULCH ANCHORING TOOL. A DISK WITH BLADES SET NEARLY STRAIGHT CAN BE USED AS A MULCH ANCHORING TOOL. ASPHALT EMULSION TACK RATE 400 GAL/ACRE
- MAINTENANCE:**
 REFERTILIZE IF GROWTH IS NOT FULLY ADEQUATE. RESEED, FERTILIZE AND MULCH IMMEDIATELY FOLLOWING EROSION OR OTHER DAMAGE
- SOIL AMENDMENTS:**
 FOLLOW RECOMMENDATIONS OF SOIL TESTS OR APPLY 2,000 LB/ACRE GROUND AGRICULTURAL LIMESTONE AND 750 LB/ACRE 10-10-10 FERTILIZER
- MULCH:**
 APPLY 4,000 LB/ACRE STRAW. ANCHOR STRAW BY TACKING WITH ASPHALT, NETTING, OR A MULCH ANCHORING TOOL. A DISK WITH BLADES SET NEARLY STRAIGHT CAN BE USED AS A MULCH ANCHORING TOOL. ASPHALT EMULSION TACK RATE 400 GAL/ACRE
- MAINTENANCE:**
 REFERTILIZE IF GROWTH IS NOT FULLY ADEQUATE. RESEED, FERTILIZE AND MULCH IMMEDIATELY FOLLOWING EROSION OR OTHER DAMAGE
- SOIL AMENDMENTS:**
 FOLLOW RECOMMENDATIONS OF SOIL TESTS OR APPLY 2,000 LB/ACRE GROUND AGRICULTURAL LIMESTONE AND 1,000 LB/ACRE 10-10-10 FERTILIZER
- MULCH:**
 APPLY 4,000 LB/ACRE STRAW. ANCHOR STRAW BY TACKING WITH ASPHALT, NETTING, OR A MULCH ANCHORING TOOL. A DISK WITH BLADES SET NEARLY STRAIGHT CAN BE USED AS A MULCH ANCHORING TOOL. ASPHALT EMULSION TACK RATE 400 GAL/ACRE
- MAINTENANCE:**
 REPAIR AND REFERTILIZE DAMAGED AREAS IMMEDIATELY. TOPDRESS WITH 50 LB/ACRE OF NITROGEN IN MARCH. IF IT IS NECESSARY TO EXTEND TEMPORARY COVER BEYOND JUNE 15, OVERSEED WITH 50 LB/ACRE KOBE LESPEDEZA IN LATE FEBRUARY OR EARLY MARCH.
- FOR ADDITIONAL INFORMATION, REFER TO NCDCEQ EROSION AND SEDIMENT CONTROL PLANNING AND DESIGN MANUAL (ESCPDM), SECTION 6.10. FOR PERMANENT SEEDING SPECIFICATIONS, INCLUDING SEED BED PREP, SEASONAL LIMITATIONS FOR SEEDING OPERATIONS, THE KINDS OF GRADES OF FERTILIZERS, THE KINDS OF SEED, AND THE RATES OF APPLICATION OF LIMESTONE, FERTILIZER, AND SEED, REFER TO NCDCEQ ESCPDM SECTION 6.11

7 TEMPORARY SEEDING SCHEDULE
 NOT TO SCALE

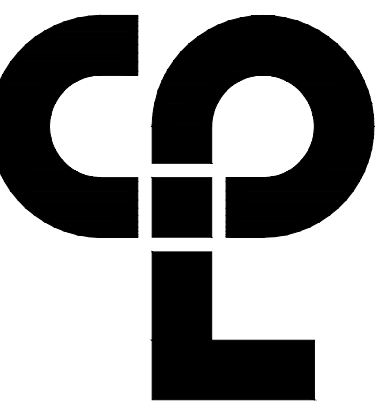

CPL | Architecture Engineering Planning
1620 Hillsborough Street Suite A,
Raleigh, NC 27605
CPLteam.com



3007 Hinsdale St.
Charlotte, NC 28210
(T) 704.582.3751

PROJECT INFORMATION

Project Number
R22.16900.00
Client Name


WILSON COUNTY SCHOOLS

Project Name
HUNT HS - ATHLETICS RENOVATION
HUNT HIGH SCHOOL

District Office Address
4559 Lamm Rd. Wilson, NC 27893

PROJECT ISSUE & REVISION SCHEDULE

No. Code Description



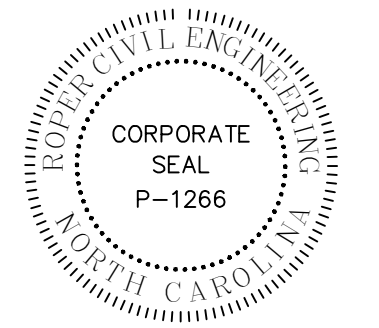


NEW YORK STATE EDUCATION STATEMENT
I, THE UNDERSIGNED, OF THE NEW YORK STATE EDUCATION LAW AND THE COMMISSIONERS' REGULATIONS FOR ANY PERSON, UNLESS ALREADY UNDER THE DIRECTION OF A LICENSED ARCHITECT, ENGINEER OR LAND SURVEYOR, DO NOT KNOW THE NAME AND ANY STATE OR BOARDING THE SEAL OF AN ARCHITECT, ENGINEER OR SURVEYOR IS AVOIDING THE ALTERNATIVE PARTIAL APPEAL TO BE SET BY THIS BOARD AND THE REVISION APPEAL BY FOLLOWING IT. THIS STATEMENT AND THE DATE OF SUCH AVOIDANCE AND A PRECISE DESCRIPTION OF THE AVOIDANCE.

SHEET INFORMATION

Issued
09.15.2023
Scale
NTS
Project Status
CONSTRUCTION DOCUMENTS
Drawn By
MR
Checked By
MR
Drawing Title
Erosion Control Details
Drawing Number

C203

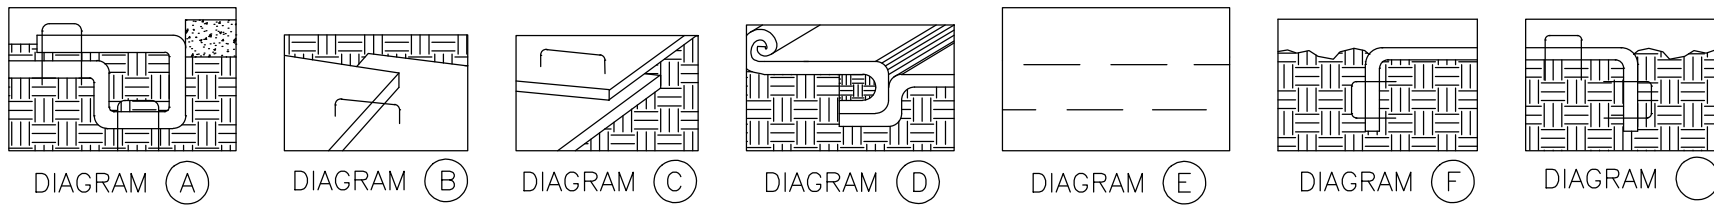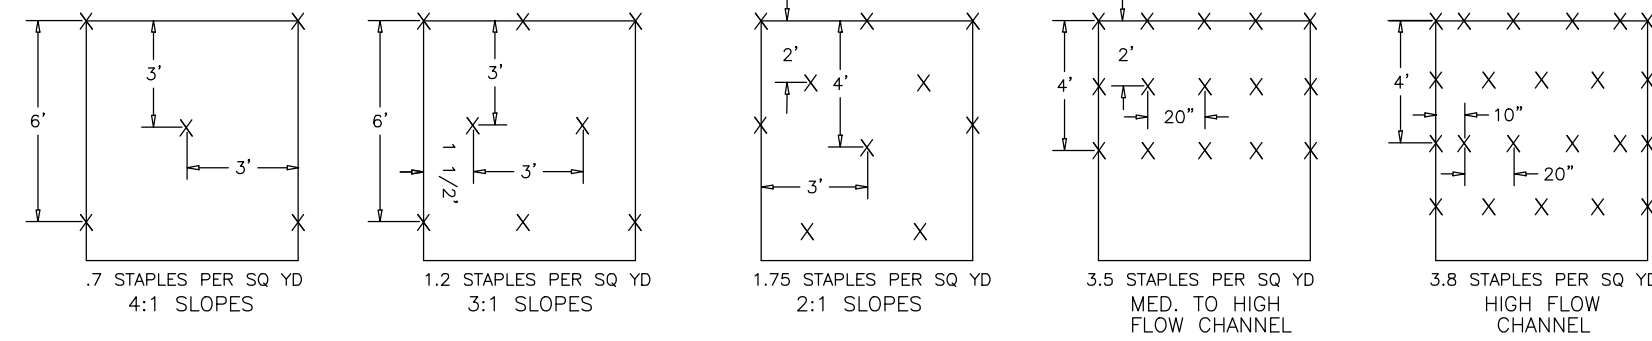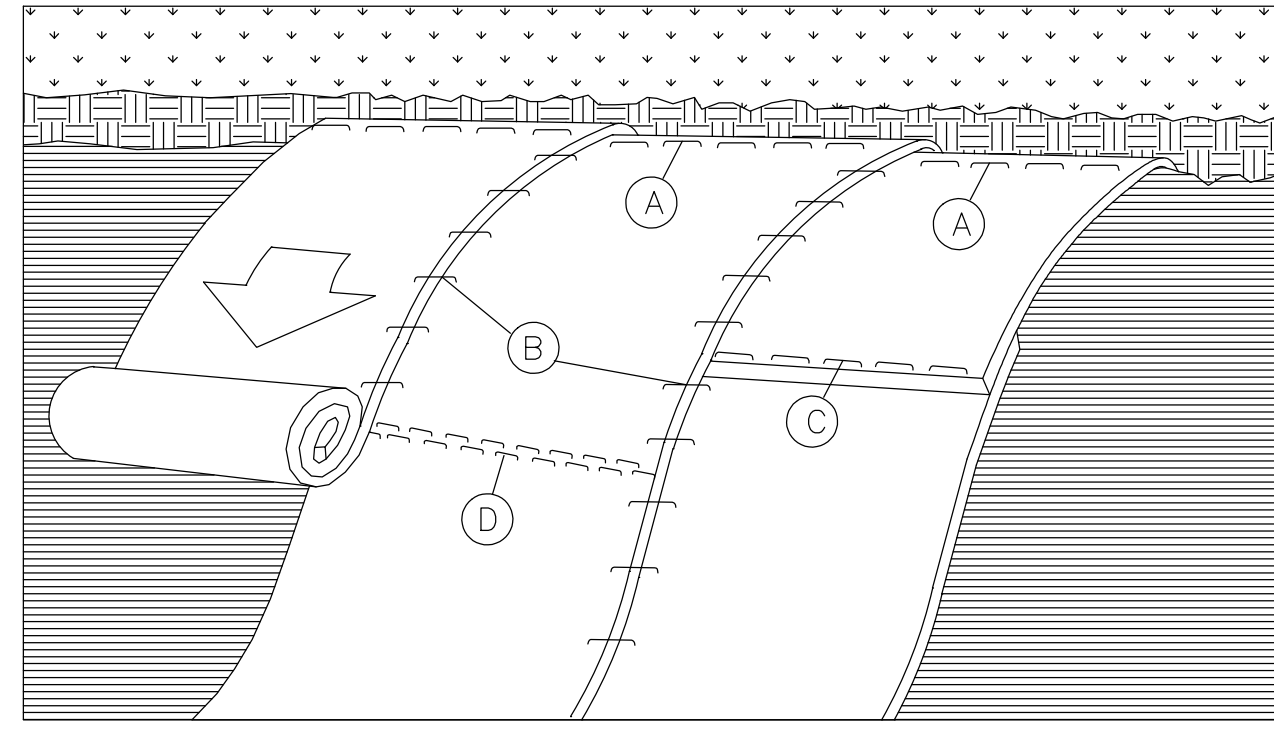

BASIC INSTALLATION GUIDELINES

1. Prepare the soil surface including raking, seeding, and fertilizing.
2. Begin the installation process by digging a trench 6" deep by 6" wide at the top of the slope. Place 12" of blanket over the up-slope portion of the trench. Secure the blanket at the bottom of the trench with staples placed 12" apart. Backfill and compact the trench. Apply seed and fold the remaining 12" of blanket over soil, secure with a row of staples placed 12" apart across the width of the blanket. (See Diagram A)
3. Roll the blanket vertically down the slope. Secure using the appropriate staple pattern shown hereon specified by slopes.
4. Parallel blankets must be overlapped by a minimum 4" and secured with a row of staples placed approximately 3'-0" apart. (See Diagram B)
5. Additional vertical blankets can be joined using a minimum 4" overlapping (shingle style) in the direction of water flow. Connect the blankets by using staples approximately 12" apart across the width of the blanket. (See Diagram C)
6. For maximum performance a check slot should be placed at 25'-40' intervals. A 6" deep by 6" wide trench is made. The blanket is placed at the bottom of the trench and covered with approximately 2" of soil. The blanket is rolled over compacted soil and secured with staples placed 4" apart. A second row should be placed 4" below in a staggered pattern. Backfill and compact the trench. Apply seed and continue with general installation. (See Diagrams D & E)
7. The end of blanket must be secured in a 6" x 6" trench with a row of staples placed at 12" intervals. (See Diagram F)

EROSION CONTROL MATTING INSTALLATION

1 EROSION CONTROL MATTING INSTALLATION
NOT TO SCALE

4 RESERVED
NOT TO SCALE


5 RESERVED
NOT TO SCALE

6 RESERVED
NOT TO SCALE

7 RESERVED
NOT TO SCALE

8 RESERVED
NOT TO SCALE

100% CONSTRUCTION DOCUMENTS

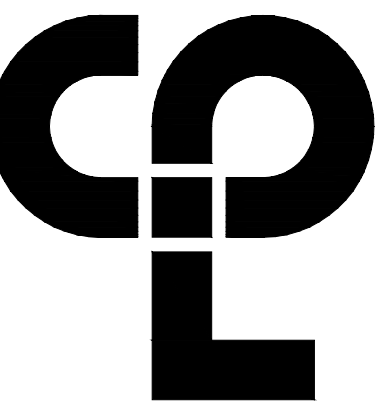

CPL | Architecture Engineering Planning
1620 Hillborough Street Suite A,
Raleigh, NC 27605
CPLteam.com



3007 Hinsdale St.
Charlotte, NC 28210
(T) 704.582.3751

PROJECT INFORMATION


Project Number
R22.16900.00
Client Name
WILSON COUNTY SCHOOLS

Project Name
HUNT HS - ATHLETICS
RENOVATION
HUNT HIGH SCHOOL

District Office Address
4559 Lamm Rd, Wilson, NC 27893

PROJECT ISSUE & REVISION SCHEDULE

No. Code Description

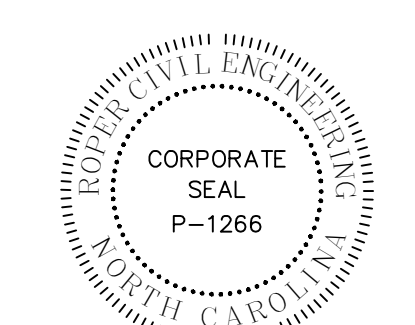

NEW YORK STATE EDUCATION STATEMENT
I, the undersigned, being a duly qualified and licensed professional engineer, hereby certify that the undersigned is a duly qualified and licensed professional engineer in the State of New York and that the undersigned is duly qualified and licensed to practice as a professional engineer in the State of New York.

SHEET INFORMATION

Issued
09.15.2023
Scale
NTS
Project Status
CONSTRUCTION DOCUMENTS
Drawn By
MR
Checked By
MR
Drawing Title
Erosion
Control
Details
Drawing Number

GROUND STABILIZATION AND MATERIALS HANDLING PRACTICES FOR COMPLIANCE WITH THE NCG01 CONSTRUCTION GENERAL PERMIT

Implementing the details and specifications on this plan sheet will result in the construction activity being considered compliant with the Ground Stabilization and Materials Handling sections of the NCG01 Construction General Permit (Sections E and F, respectively). The permittee shall comply with the Erosion and Sediment Control plan approved by the delegated authority having jurisdiction. All details and specifications shown on this sheet may not apply depending on site conditions and the delegated authority having jurisdiction.

SECTION E: GROUND STABILIZATION

Required Ground Stabilization Timeframes		
Site Area Description	Stabilize within this many calendar days after ceasing land disturbance	Timeframe variations
(a) Perimeter dikes, swales, ditches, and perimeter slopes	7	None
(b) High Quality Water (HQW) Zones	7	None
(c) Slopes steeper than 3:1	7	If slopes are 10' or less in length and are not steeper than 2:1, 14 days are allowed
(d) Slopes 3:1 to 4:1	14	-7 days for slopes greater than 50' in length and with slopes steeper than 4:1 -7 days for perimeter dikes, swales, ditches, perimeter slopes and HQW Zones -10 days for Falls Lake Watershed
(e) Areas with slopes flatter than 4:1	14	-7 days for perimeter dikes, swales, ditches, perimeter slopes and HQW Zones -10 days for Falls Lake Watershed unless there is zero slope

Note: After the permanent cessation of construction activities, any areas with temporary ground stabilization shall be converted to permanent ground stabilization as soon as practicable but in no case longer than 90 calendar days after the last land disturbing activity. Temporary ground stabilization shall be maintained in a manner to render the surface stable against accelerated erosion until permanent ground stabilization is achieved.

GROUND STABILIZATION SPECIFICATION

Stabilize the ground sufficiently so that rain will not dislodge the soil. Use one of the techniques in the table below:

Temporary Stabilization	Permanent Stabilization
<ul style="list-style-type: none"> Temporary grass seed covered with straw or other mulches and tackifiers Hydroseeding Rolled erosion control products with or without temporary grass seed Appropriately applied straw or other mulch Plastic sheeting 	<ul style="list-style-type: none"> Permanent grass seed covered with straw or other mulches and tackifiers Geotextile fabrics such as permanent soil reinforcement matting Hydroseeding Shrubs or other permanent plantings covered with mulch Uniform and evenly distributed ground cover sufficient to restrain erosion Structural methods such as concrete, asphalt or retaining walls Rolled erosion control products with grass seed

POLYACRYLAMIDES (PAMS) AND FLOCCULANTS

- Select flocculants that are appropriate for the soils being exposed during construction, selecting from the *NC DWR List of Approved PAMS/Flocculants*.
- Apply flocculants at or before the inlets to Erosion and Sediment Control Measures.
- Apply flocculants at the concentrations specified in the *NC DWR List of Approved PAMS/Flocculants* and in accordance with the manufacturer's instructions.
- Provide ponding area for containment of treated Stormwater before discharging offsite.
- Store flocculants in leak-proof containers that are kept under storm-resistant cover or surrounded by secondary containment structures.

EQUIPMENT AND VEHICLE MAINTENANCE

- Maintain vehicles and equipment to prevent discharge of fluids.
- Provide drip pans under any stored equipment.
- Identify leaks and repair as soon as feasible, or remove leaking equipment from the project.
- Collect all spent fluids, store in separate containers and properly dispose as hazardous waste (recycle when possible).
- Remove leaking vehicles and construction equipment from service until the problem has been corrected.
- Bring used fuels, lubricants, coolants, hydraulic fluids and other petroleum products to a recycling or disposal center that handles these materials.

LITTER, BUILDING MATERIAL AND LAND CLEARING WASTE

- Never bury or burn waste. Place litter and debris in approved waste containers.
- Provide a sufficient number and size of waste containers (e.g dumpster, trash receptacle) on site to contain construction and domestic wastes.
- Locate waste containers at least 50 feet away from storm drain inlets and surface waters unless no other alternatives are reasonably available.
- Locate waste containers on areas that do not receive substantial amounts of runoff from upland areas and does not drain directly to a storm drain, stream or wetland.
- Cover waste containers at the end of each workday and before storm events or provide secondary containment. Repair or replace damaged waste containers.
- Anchor all lightweight items in waste containers during times of high winds.
- Empty waste containers as needed to prevent overflow. Clean up immediately if containers overflow.
- Dispose waste off-site at an approved disposal facility.
- On business days, clean up and dispose of waste in designated waste containers.

PAINT AND OTHER LIQUID WASTE


- Do not dump paint and other liquid waste into storm drains, streams or wetlands.
- Locate paint washouts at least 50 feet away from storm drain inlets and surface waters unless no other alternatives are reasonably available.
- Contain liquid wastes in a controlled area.
- Containment must be labeled, sized and placed appropriately for the needs of site.
- Prevent the discharge of soaps, solvents, detergents and other liquid wastes from construction sites.

PORTABLE TOILETS

- Install portable toilets on level ground, at least 50 feet away from storm drains, streams or wetlands unless there is no alternative reasonably available. If 50 foot offset is not attainable, provide relocation of portable toilet behind silt fence or place on a gravel pad and surround with sand bags.
- Provide staking or anchoring of portable toilets during periods of high winds or in high foot traffic areas.
- Monitor portable toilets for leaking and properly dispose of any leaked material. Utilize a licensed sanitary waste hauler to remove leaking portable toilets and replace with properly operating unit.

EARTHEN STOCKPILE MANAGEMENT

- Show stockpile locations on plans. Locate earthen-material stockpile areas at least 50 feet away from storm drain inlets, sediment basins, perimeter sediment controls and surface waters unless it can be shown no other alternatives are reasonably available.
- Protect stockpile with silt fence installed along toe of slope with a minimum offset of five feet from the toe of stockpile.
- Provide stable stone access point when feasible.
- Stabilize stockpile within the timeframes provided on this sheet and in accordance with the approved plan and any additional requirements. Soil stabilization is defined as vegetative, physical or chemical coverage techniques that will restrain accelerated erosion on disturbed soils for temporary or permanent control needs.

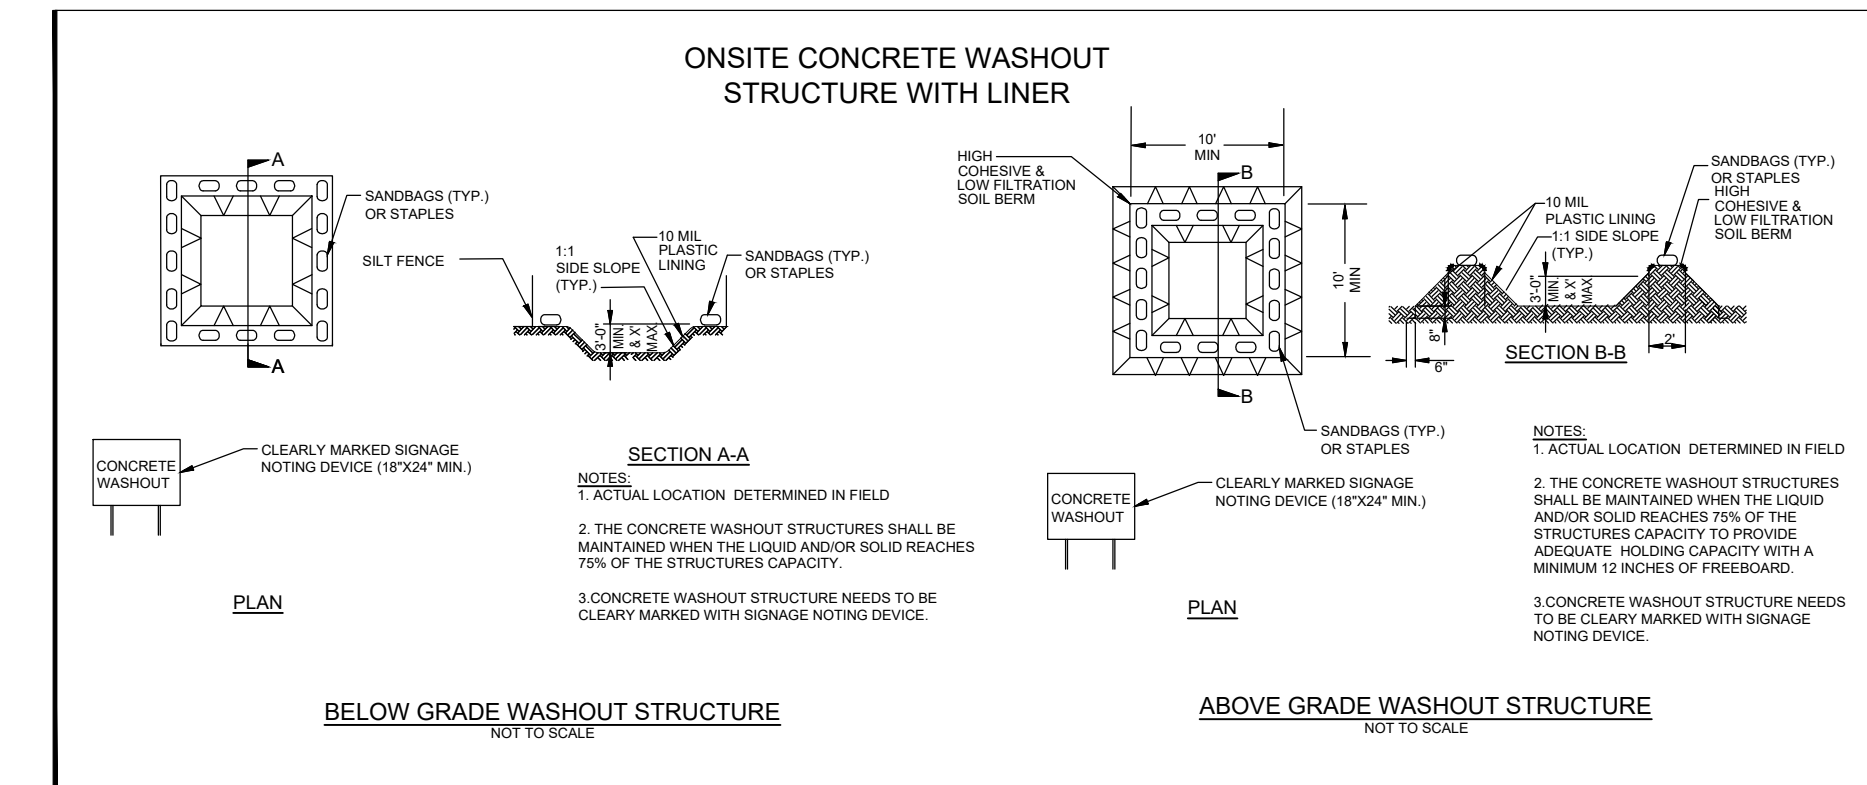

CONCRETE WASHOUTS

- Do not discharge concrete or cement slurry from the site.
- Dispose of, or recycle settled, hardened concrete residue in accordance with local and state solid waste regulations and at an approved facility.
- Manage washout from mortar mixers in accordance with the above item and in addition place the mixer and associated materials on impervious barrier and within lot perimeter silt fence.
- Install temporary concrete washouts per local requirements, where applicable. If an alternate method or product is to be used, contact your approval authority for review and approval. If local standard details are not available, use one of the two types of temporary concrete washouts provided on this detail.
- Do not use concrete washouts for dewatering or storing defective curb or sidewalk sections. Stormwater accumulated within the washout may not be pumped into or discharged to the storm drain system or receiving surface waters. Liquid waste must be pumped out and removed from project.
- Locate washouts at least 50 feet from storm drain inlets and surface waters unless it can be shown that no other alternatives are reasonably available. At a minimum, install protection of storm drain inlet(s) closest to the washout which could receive spills or overflow.
- Locate washouts in an easily accessible area, on level ground and install a stone entrance pad in front of the washout. Additional controls may be required by the approving authority.
- Install at least one sign directing concrete trucks to the washout within the project limits. Post signage on the washout itself to identify this location.
- Remove leavings from the washout when at approximately 75% capacity to limit overflow events. Replace the tarp, sand bags or other temporary structural components when no longer functional. When utilizing alternative or proprietary products, follow manufacturer's instructions.
- At the completion of the concrete work, remove remaining leavings and dispose of in an approved disposal facility. Fill pit, if applicable, and stabilize any disturbance caused by removal of washout.

HERBICIDES, PESTICIDES AND RODENTICIDES

- Store and apply herbicides, pesticides and rodenticides in accordance with label restrictions.
- Store herbicides, pesticides and rodenticides in their original containers with the label, which lists directions for use, ingredients and first aid steps in case of accidental poisoning.
- Do not store herbicides, pesticides and rodenticides in areas where flooding is possible or where they may spill or leak into wells, stormwater drains, ground water or surface water. If a spill occurs, clean area immediately.
- Do not stockpile these materials onsite.

HAZARDOUS AND TOXIC WASTE


- Create designated hazardous waste collection areas on-site.
- Place hazardous waste containers under cover or in secondary containment.
- Do not store hazardous chemicals, drums or bagged materials directly on the ground.

NCG01 GROUND STABILIZATION AND MATERIALS HANDLING

EFFECTIVE: 04/01/19

100% CONSTRUCTION DOCUMENTS

10/09/2021 9:53:09 AM S:\Projects\Wilson_Civil\Track_Rep_Plan\2D\Design\06_CAD\Rev\h\Central - bin_300.FIL

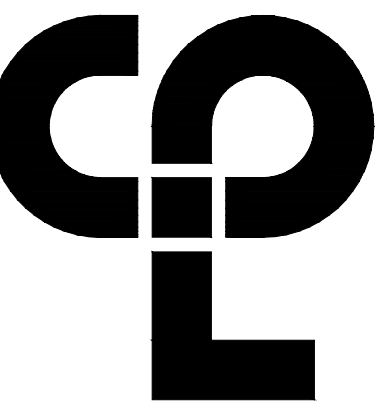

CPL | Architecture Engineering Planning
1620 Hillsborough Street Suite A,
Raleigh, NC 27605
CPLteam.com



3007 Hinsdale St.
Charlotte, NC 28210
(T) 704.582.3751

PROJECT INFORMATION

Project Number
R22.16900.00

Client Name

WILSON COUNTY SCHOOLS

Project Name

HUNT HS - ATHLETICS
RENOVATION


HUNT HIGH SCHOOL

District Office Address

4559 Lamm Rd, Wilson, NC 27893

PROJECT ISSUE & REVISION SCHEDULE

No. Code Description

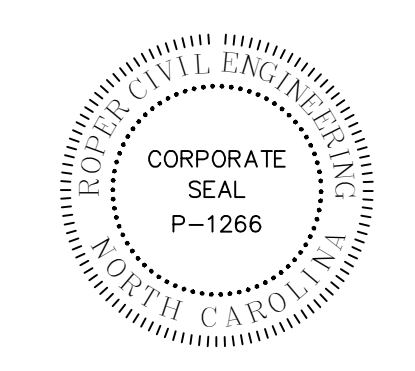

NEW YORK STATE EDUCATION STATEMENT
I, THE UNDERSIGNED, BEING A MEMBER OF THE NEW YORK STATE EDUCATION LAW AND THE CONSTRUCTION
REGULATORY BOARD FOR ANY PERSON, UNDER A LICENSE UNDER THE REGULATION OF A LICENSED
ARCHITECT, ENGINEER OR LAND SURVEYOR, DO HEREBY CERTIFY THAT I AM NOT AN ACTIVE
MEMBER OF THE BOARD OF AN ARCHITECT, ENGINEER OR SURVEYOR LICENSED IN ANY OTHER
STATE AND I AM NOT BEING TRAINED BY OR UNDER THE SUPERVISION OF ANY SUCH LICENSED
PERSON AND I AM NOT BEING TRAINED BY OR UNDER THE SUPERVISION OF ANY SUCH LICENSED
PERSON AND I AM NOT BEING TRAINED BY OR UNDER THE SUPERVISION OF ANY SUCH LICENSED
PERSON.

SHEET INFORMATION

Issued: 09.15.2023 Scale: NTS
Project Status: CONSTRUCTION DOCUMENTS
Drawn By: MR Checked By: MR
Drawing Title: Erosion Control Details
Drawing Number:

**PART III
SELF-INSPECTION, RECORDKEEPING AND REPORTING**

SECTION A: SELF-INSPECTION

Self-inspections are required during normal business hours in accordance with the table below. When adverse weather or site conditions would cause the safety of the inspection personnel to be in jeopardy, the inspection may be delayed until the next business day on which it is safe to perform the inspection. In addition, when a storm event of equal to or greater than 1.0 inch occurs outside of normal business hours, the self-inspection shall be performed upon the commencement of the next business day. Any time when inspections were delayed shall be noted in the Inspection Record.

Inspect	Frequency (during normal business hours)	Inspection records must include:
(1) Rain gauge maintained in good working order	Daily	Daily rainfall amounts. If no daily rain gauge observations are made during weekend or holiday periods, and no individual-day rainfall information is available, record the cumulative rain measurement for those unattended days (and this will determine if a site inspection is needed). Days on which no rainfall occurred shall be recorded as "zero." The permittee may use another rain-monitoring device approved by the Division.
(2) E&SC Measures	At least once per 7 calendar days and within 24 hours of a rain event ≥ 1.0 inch in 24 hours	1. Identification of the measures inspected, 2. Date and time of the inspection, 3. Name of the person performing the inspection, 4. Indication of whether the measures were operating properly, 5. Description of maintenance needs for the measure, 6. Description, evidence, and date of corrective actions taken.
(3) Stormwater discharge outfalls (SDOs)	At least once per 7 calendar days and within 24 hours of a rain event ≥ 1.0 inch in 24 hours	1. Identification of the discharge outfalls inspected, 2. Date and time of the inspection, 3. Name of the person performing the inspection, 4. Evidence of indicators of stormwater pollution such as oil sheen, floating or suspended solids or discoloration, 5. Indication of visible sediment leaving the site, 6. Description, evidence, and date of corrective actions taken.
(4) Perimeter of site	At least once per 7 calendar days and within 24 hours of a rain event ≥ 1.0 inch in 24 hours	If visible sedimentation is found outside site limits, then a record of the following shall be made: 1. Actions taken to clean up or stabilize the sediment that has left the site limits, 2. Description, evidence, and date of corrective actions taken, and 3. An explanation as to the actions taken to control future releases.
(5) Streams or wetlands onsite or offsite (where accessible)	At least once per 7 calendar days and within 24 hours of a rain event ≥ 1.0 inch in 24 hours	If the stream or wetland has increased visible sedimentation or a stream has visible increased turbidity from the construction activity, then a record of the following shall be made: 1. Description, evidence and date of corrective actions taken, and 2. Records of the required reports to the appropriate Division Regional Office per Part III, Section C, Item (2)(a) of this permit.
(6) Ground stabilization measures	After each phase of grading	1. The phase of grading (installation of perimeter E&SC measures, clearing and grubbing, installation of storm drainage facilities, completion of all land-disturbing activity, construction or redevelopment, permanent ground cover). 2. Documentation that the required ground stabilization measures have been provided within the required timeframe or an assurance that they will be provided as soon as possible.

NOTE: The rain inspection resets the required 7 calendar day inspection requirement.

**PART III
SELF-INSPECTION, RECORDKEEPING AND REPORTING**

SECTION B: RECORDKEEPING

1. E&SC Plan Documentation

The approved E&SC plan as well as any approved deviation shall be kept on the site. The approved E&SC plan must be kept up-to-date throughout the coverage under this permit. The following items pertaining to the E&SC plan shall be kept on site and available for inspection at all times during normal business hours.

Item to Document	Documentation Requirements
(a) Each E&SC measure has been installed and does not significantly deviate from the locations, dimensions and relative elevations shown on the approved E&SC plan.	Initial and date each E&SC measure on a copy of the approved E&SC plan or complete, date and sign an inspection report that lists each E&SC measure shown on the approved E&SC plan. This documentation is required upon the initial installation of the E&SC measures or if the E&SC measures are modified after initial installation.
(b) A phase of grading has been completed.	Initial and date a copy of the approved E&SC plan or complete, date and sign an inspection report to indicate completion of the construction phase.
(c) Ground cover is located and installed in accordance with the approved E&SC plan.	Initial and date a copy of the approved E&SC plan or complete, date and sign an inspection report to indicate compliance with approved ground cover specifications.
(d) The maintenance and repair requirements for all E&SC measures have been performed.	Complete, date and sign an inspection report.
(e) Corrective actions have been taken to E&SC measures.	Initial and date a copy of the approved E&SC plan or complete, date and sign an inspection report to indicate the completion of the corrective action.

2. Additional Documentation to be Kept on Site

In addition to the E&SC plan documents above, the following items shall be kept on the site and available for inspectors at all times during normal business hours, unless the Division provides a site-specific exemption based on unique site conditions that make this requirement not practical:

- This General Permit as well as the Certificate of Coverage, after it is received.
- Records of inspections made during the previous twelve months. The permittee shall record the required observations on the Inspection Record Form provided by the Division or a similar inspection form that includes all the required elements. Use of electronically-available records in lieu of the required paper copies will be allowed if shown to provide equal access and utility as the hard-copy records.

3. Documentation to be Retained for Three Years

All data used to complete the e-NOI and all inspection records shall be maintained for a period of three years after project completion and made available upon request. [40 CFR 122.41]

**PART II, SECTION G, ITEM (4)
DRAW DOWN OF SEDIMENT BASINS FOR MAINTENANCE OR CLOSE OUT**

Sediment basins and traps that receive runoff from drainage areas of one acre or more shall use outlet structures that withdraw water from the surface when these devices need to be drawn down for maintenance or close out unless this is infeasible. The circumstances in which it is not feasible to withdraw water from the surface shall be rare (for example, times with extended cold weather). Non-surface withdrawals from sediment basins shall be allowed only when all of the following criteria have been met:

- The E&SC plan authority has been provided with documentation of the non-surface withdrawal and the specific time periods or conditions in which it will occur. The non-surface withdrawal shall not commence until the E&SC plan authority has approved these items,
- The non-surface withdrawal has been reported as an anticipated bypass in accordance with Part III, Section C, Item (2)(c) and (d) of this permit,
- Dewatering discharges are treated with controls to minimize discharges of pollutants from stormwater that is removed from the sediment basin. Examples of appropriate controls include properly sited, designed and maintained dewatering tanks, weir tanks, and filtration systems,
- Vegetated, upland areas of the sites or a properly designed stone pad is used to the extent feasible at the outlet of the dewatering treatment devices described in Item (c) above,
- Velocity dissipation devices such as check dams, sediment traps, and riprap are provided at the discharge points of all dewatering devices, and
- Sediment removed from the dewatering treatment devices described in Item (c) above is disposed of in a manner that does not cause deposition of sediment into waters of the United States.

**PART III
SELF-INSPECTION, RECORDKEEPING AND REPORTING**

SECTION C: REPORTING

1. Occurrences that Must be Reported

Permittees shall report the following occurrences:

- Visible sediment deposition in a stream or wetland.
- Oil spills if:
 - They are 25 gallons or more,
 - They are less than 25 gallons but cannot be cleaned up within 24 hours,
 - They cause sheen on surface waters (regardless of volume), or
 - They are within 100 feet of surface waters (regardless of volume).
- Releases of hazardous substances in excess of reportable quantities under Section 311 of the Clean Water Act (Ref: 40 CFR 110.3 and 40 CFR 117.3) or Section 102 of CERCLA (Ref: 40 CFR 302.4) or G.S. 143-215.85.
- Anticipated bypasses and unanticipated bypasses.
- Noncompliance with the conditions of this permit that may endanger health or the environment.

2. Reporting Timeframes and Other Requirements

After a permittee becomes aware of an occurrence that must be reported, he shall contact the appropriate Division regional office within the timeframes and in accordance with the other requirements listed below. Occurrences outside normal business hours may also be reported to the Department's Environmental Emergency Center personnel at (800) 858-0368.

Occurrence	Reporting Timeframes (After Discovery) and Other Requirements
(a) Visible sediment deposition in a stream or wetland	<ul style="list-style-type: none"> Within 24 hours, an oral or electronic notification. Within 7 calendar days, a report that contains a description of the sediment and actions taken to address the cause of the deposition. Division staff may waive the requirement for a written report on a case-by-case basis. If the stream is named on the NC 303(d) list as impaired for sediment-related causes, the permittee may be required to perform additional monitoring, inspections or apply more stringent practices if staff determine that additional requirements are needed to assure compliance with the federal or state impaired-waters conditions.
(b) Oil spills and release of hazardous substances per Item 1(b)-(c) above	<ul style="list-style-type: none"> Within 24 hours, an oral or electronic notification. The notification shall include information about the date, time, nature, volume and location of the spill or release.
(c) Anticipated bypasses [40 CFR 122.41(m)(3)]	<ul style="list-style-type: none"> A report at least ten days before the date of the bypass, if possible. The report shall include an evaluation of the anticipated quality and effect of the bypass.
(d) Unanticipated bypasses [40 CFR 122.41(m)(3)]	<ul style="list-style-type: none"> Within 24 hours, an oral or electronic notification. Within 7 calendar days, a report that includes an evaluation of the quality and effect of the bypass.
(e) Noncompliance with the conditions of this permit that may endanger health or the environment [40 CFR 122.41(l)(7)]	<ul style="list-style-type: none"> Within 24 hours, an oral or electronic notification. Within 7 calendar days, a report that contains a description of the noncompliance, and its causes; the period of noncompliance, including exact dates and times, and if the noncompliance has not been corrected, the anticipated time noncompliance is expected to continue; and steps taken or planned to reduce, eliminate, and prevent reoccurrence of the noncompliance. [40 CFR 122.41(l)(6). Division staff may waive the requirement for a written report on a case-by-case basis.

NCG01 SELF-INSPECTION, RECORDKEEPING AND REPORTING





EFFECTIVE: 04/01/19

100% CONSTRUCTION DOCUMENTS






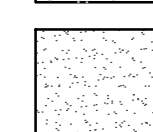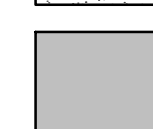




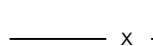
GENERAL CONSTRUCTION NOTES:


1. CONTRACTOR SHALL CALL NC 811 BEFORE DIGGING
2. ALL EROSION CONTROL MEASURES SHALL BE IN PLACE UNTIL PROJECT COMPLETION AND FINAL STABILIZATION
3. ALL CONTRACTORS TO HAVE APPROPRIATE BUSINESS LICENSES FOR WORK AT HAND
4. CONTRACTOR TO VERIFY DIMENSIONS PRIOR TO CONSTRUCTION.
5. ALL CONTOURS AND SPOT ELEVATIONS TO REFLECT FINISHED GRADE
6. ALL FILL FOR HARDSCAPE TO BE COMPACTED TO ASTM 95% COMPACTION UNLESS OTHERWISE DIRECTED.
7. ALL FILL FOR LANDSCAPE AREA TO BE COMPACTED TO ASTM 85% COMPACTION UNLESS OTHERWISE DIRECTED.
8. CONTRACTOR TO VERIFY POSITIVE DRAINAGE AND ADA ACCESSIBILITY ON ALL HARDSCAPE
9. ALL HARDSCAPE PEDESTRIAN AREAS NOT TO EXCEED A 2% CROSS SLOPE
10. SURVEY BENCHMARK TO BE VERIFIED BEFORE GRADING BEGINS
11. CONTRACTOR IS RESPONSIBLE FOR CHECKING ALL TRACK GRADES FOR NFHS COMPLIANCE.

SURFACING LEGEND

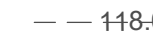-  PROPOSED TRACK SURFACE
-  PROPOSED CONCRETE
-  PROPOSED SHOT PUT THROW AREA
-  PROPOSED SOD AREA



LEGEND

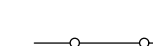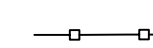-  SLOPE
-  PROPOSED 1' CONTOUR
-  EXISTING 1' CONTOUR
-  PROPOSED SPOT ELEVATION
-  TOP OF CURB
-  BOTTOM OF CURB
-  PROPOSED FENCE (4' HT.)
-  PROPOSED FENCE (6' HT.)
-  PROPOSED LIGHT POLE
-  EXISTING CHAIN LINK FENCE
-  EXISTING TREELINE

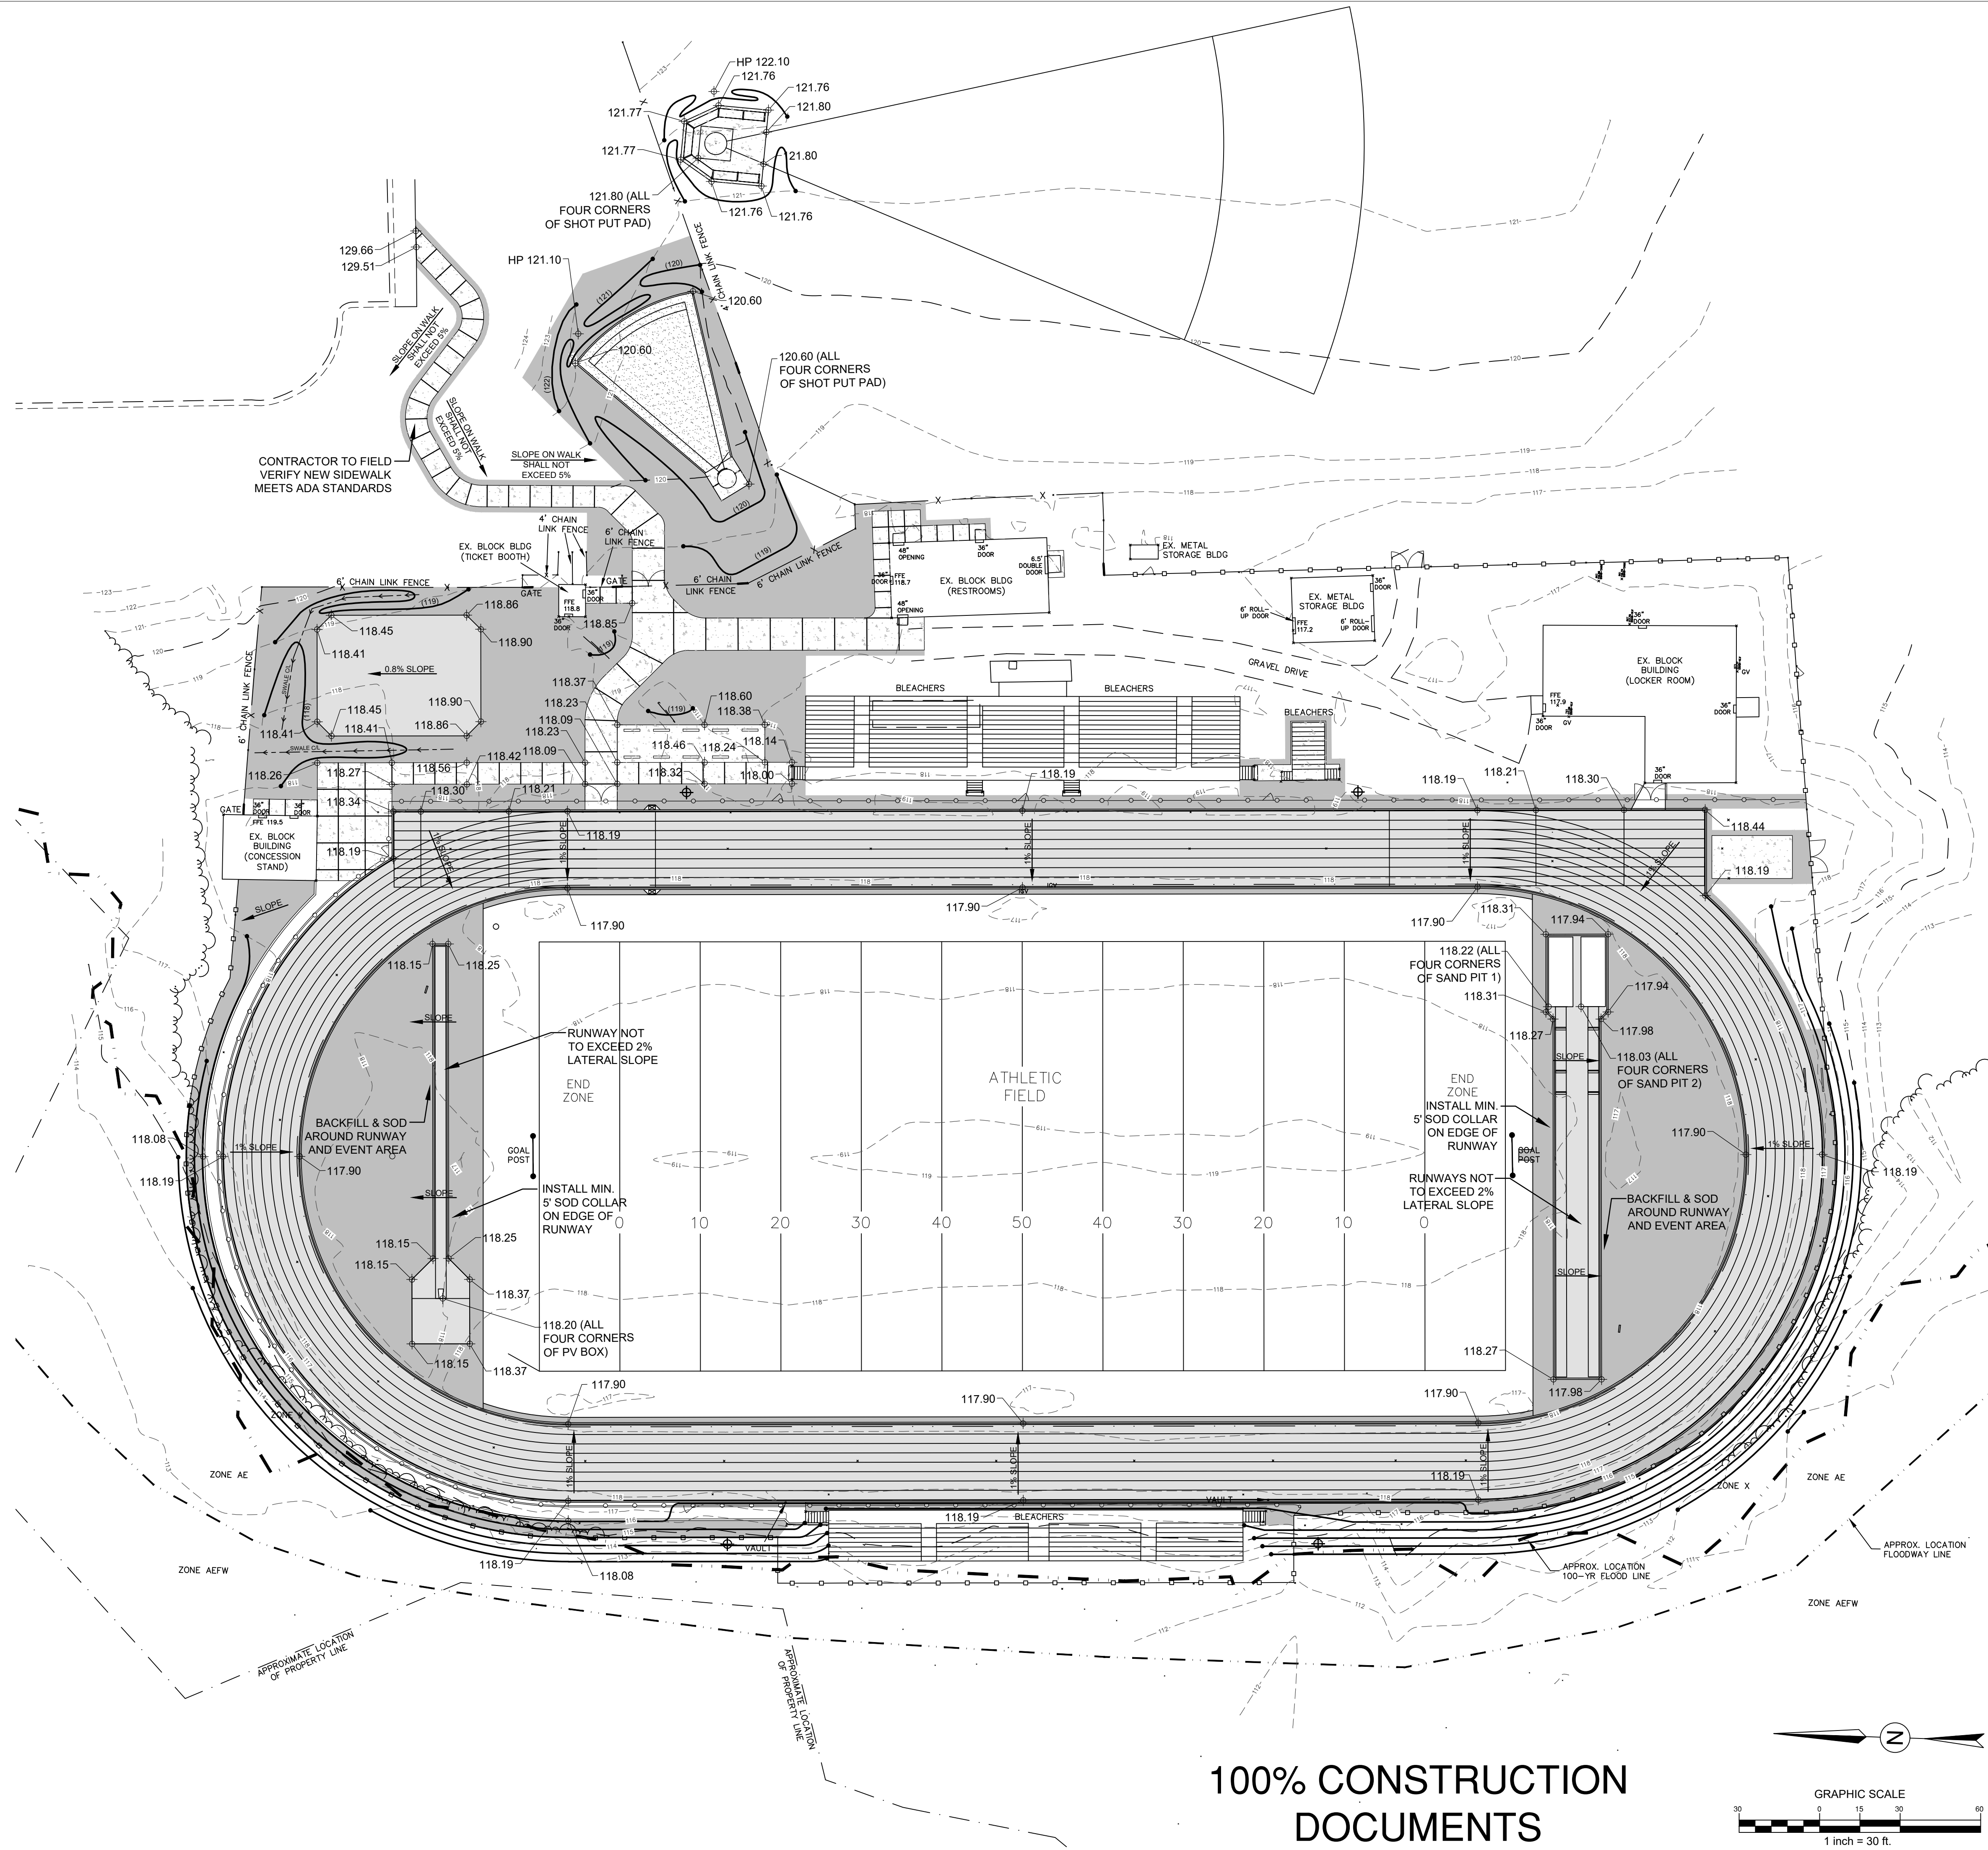

CONTRACTOR SHALL NOTIFY "NORTH CAROLINA ONE CALL" (811) OR (1-800-632-4949) AT LEAST 48 HOURS PRIOR TO BEGINNING CONSTRUCTION OR EXCAVATION TO HAVE EXISTING UTILITIES LOCATED. CONTRACTOR SHALL CONTACT ANY LOCAL UTILITIES THAT PROVIDE THEIR OWN LOCATOR SERVICES INDEPENDENT OF "NORTH CAROLINA ONE CALL". REPORT ANY DISCREPANCIES TO THE ENGINEER IMMEDIATELY.

100% CONSTRUCTION DOCUMENTS

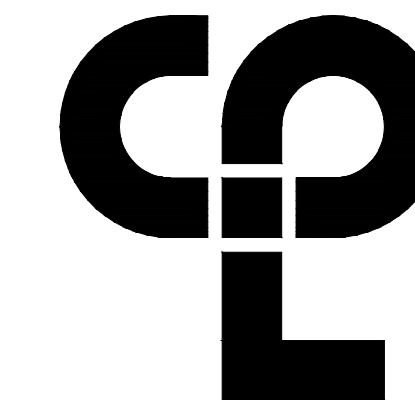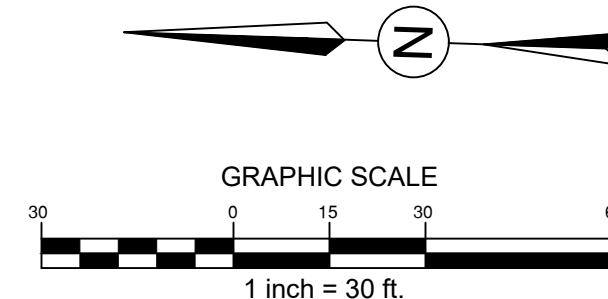

CPL | Architecture Engineering Planning
1620 Hillsborough Street Suite A,
Raleigh, NC 27605
CPLteam.com



FITFIELDS

314 Tom Hall St.
Fort Mill, SC 29715
(T) 803.981.4330
www.fitfields.com

PROJECT INFORMATION

Project Number
R22.16900.00

Client Name
WILSON COUNTY SCHOOLS

Project Name
HUNT HS - ATHLETICS RENOVATION
HUNT HIGH SCHOOL

District Office Address
4559 Lamm Rd., Wilson, NC 27893

PROJECT ISSUE & REVISION SCHEDULE

No. Code Description



NEW YORK STATE EDUCATION STATEMENT
I, THE UNDERSIGNED, BEING A LICENSED PROFESSIONAL ENGINEER, ARCHITECT, LANDSCAPE ARCHITECT, OR SURVEYOR, HAVE PREPARED THE DESIGN OR SUPERVISION OF THE WORK SHOWN ON THIS DRAWING AND I AM A MEMBER OF THE BOARD OF THE SEAL OF AN ARCHITECT, ENGINEER OR SURVEYOR AS REQUIRED BY THE ALABAMA PROFESSIONAL SERVICE ACT AND THE ALABAMA PROFESSIONAL SERVICE ACT. THE SEALING OF THIS DRAWING IS VALID AND THE DESIGN AND SUPERVISION OF THE WORK SHOWN ON THIS DRAWING ARE THE SOLE RESPONSIBILITY OF THE UNDERSIGNED. I HAVE REVIEWED AND APPROVED THE DESIGN AND SUPERVISION OF THE WORK SHOWN ON THIS DRAWING AND I AM A MEMBER OF THE BOARD OF THE SEAL OF AN ARCHITECT, ENGINEER OR SURVEYOR AS REQUIRED BY THE ALABAMA PROFESSIONAL SERVICE ACT AND THE ALABAMA PROFESSIONAL SERVICE ACT.

SHEET INFORMATION

Issued
09.15.2023
Scale
1" = 30'-0"
Project Status
CONSTRUCTION DOCUMENTS
Drawn By
BG
Checked By
DD
Drawing Title
Grading Plan





Drawing Number

C300






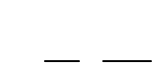

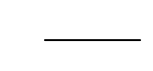
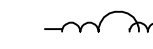

GENERAL CONSTRUCTION NOTES:


1. CONTRACTOR SHALL CALL NC 811 BEFORE DIGGING
2. ALL EROSION CONTROL MEASURES SHALL BE IN PLACE UNTIL PROJECT COMPLETION AND FINAL STABILIZATION
3. ALL CONTRACTORS TO HAVE APPROPRIATE BUSINESS LICENSES FOR WORK AT HAND
4. CONTRACTOR TO VERIFY DIMENSIONS PRIOR TO CONSTRUCTION.
5. ALL CONTOURS AND SPOT ELEVATIONS TO REFLECT FINISHED GRADE
6. ALL FILL FOR HARDSCAPE TO BE COMPACTED TO ASTM 95% COMPACTION UNLESS OTHERWISE DIRECTED.
7. ALL FILL FOR LANDSCAPE AREA TO BE COMPACTED TO ASTM 85% COMPACTION UNLESS OTHERWISE DIRECTED.
8. CONTRACTOR TO VERIFY POSITIVE DRAINAGE AND ADA ACCESSIBILITY ON ALL HARDSCAPE
9. ALL HARDSCAPE PEDESTRIAN AREAS NOT TO EXCEED A 2% CROSS SLOPE
10. SURVEY BENCHMARK TO BE VERIFIED BEFORE GRADING BEGINS
11. CONTRACTOR IS RESPONSIBLE FOR CHECKING ALL TRACK GRADES FOR NFHS COMPLIANCE.

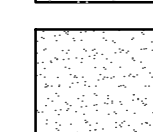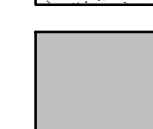SURFACING LEGEND

-  PROPOSED TRACK SURFACE
-  PROPOSED CONCRETE
-  PROPOSED SHOT PUT THROW AREA
-  PROPOSED SOD AREA


LEGEND

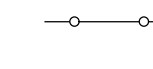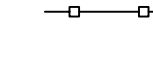-  PROPOSED DRAIN BASIN
-  PROPOSED COLLECTOR PIPE
-  PROPOSED FENCE (4' HT.)
-  PROPOSED FENCE (6' HT.)
-  PROPOSED LIGHT POLE
-  EXISTING 1' CONTOUR
-  EXISTING 5' CONTOUR
-  EXISTING STORM DRAIN
-  EXISTING CHAIN LINK FENCE
-  EXISTING TREELINE

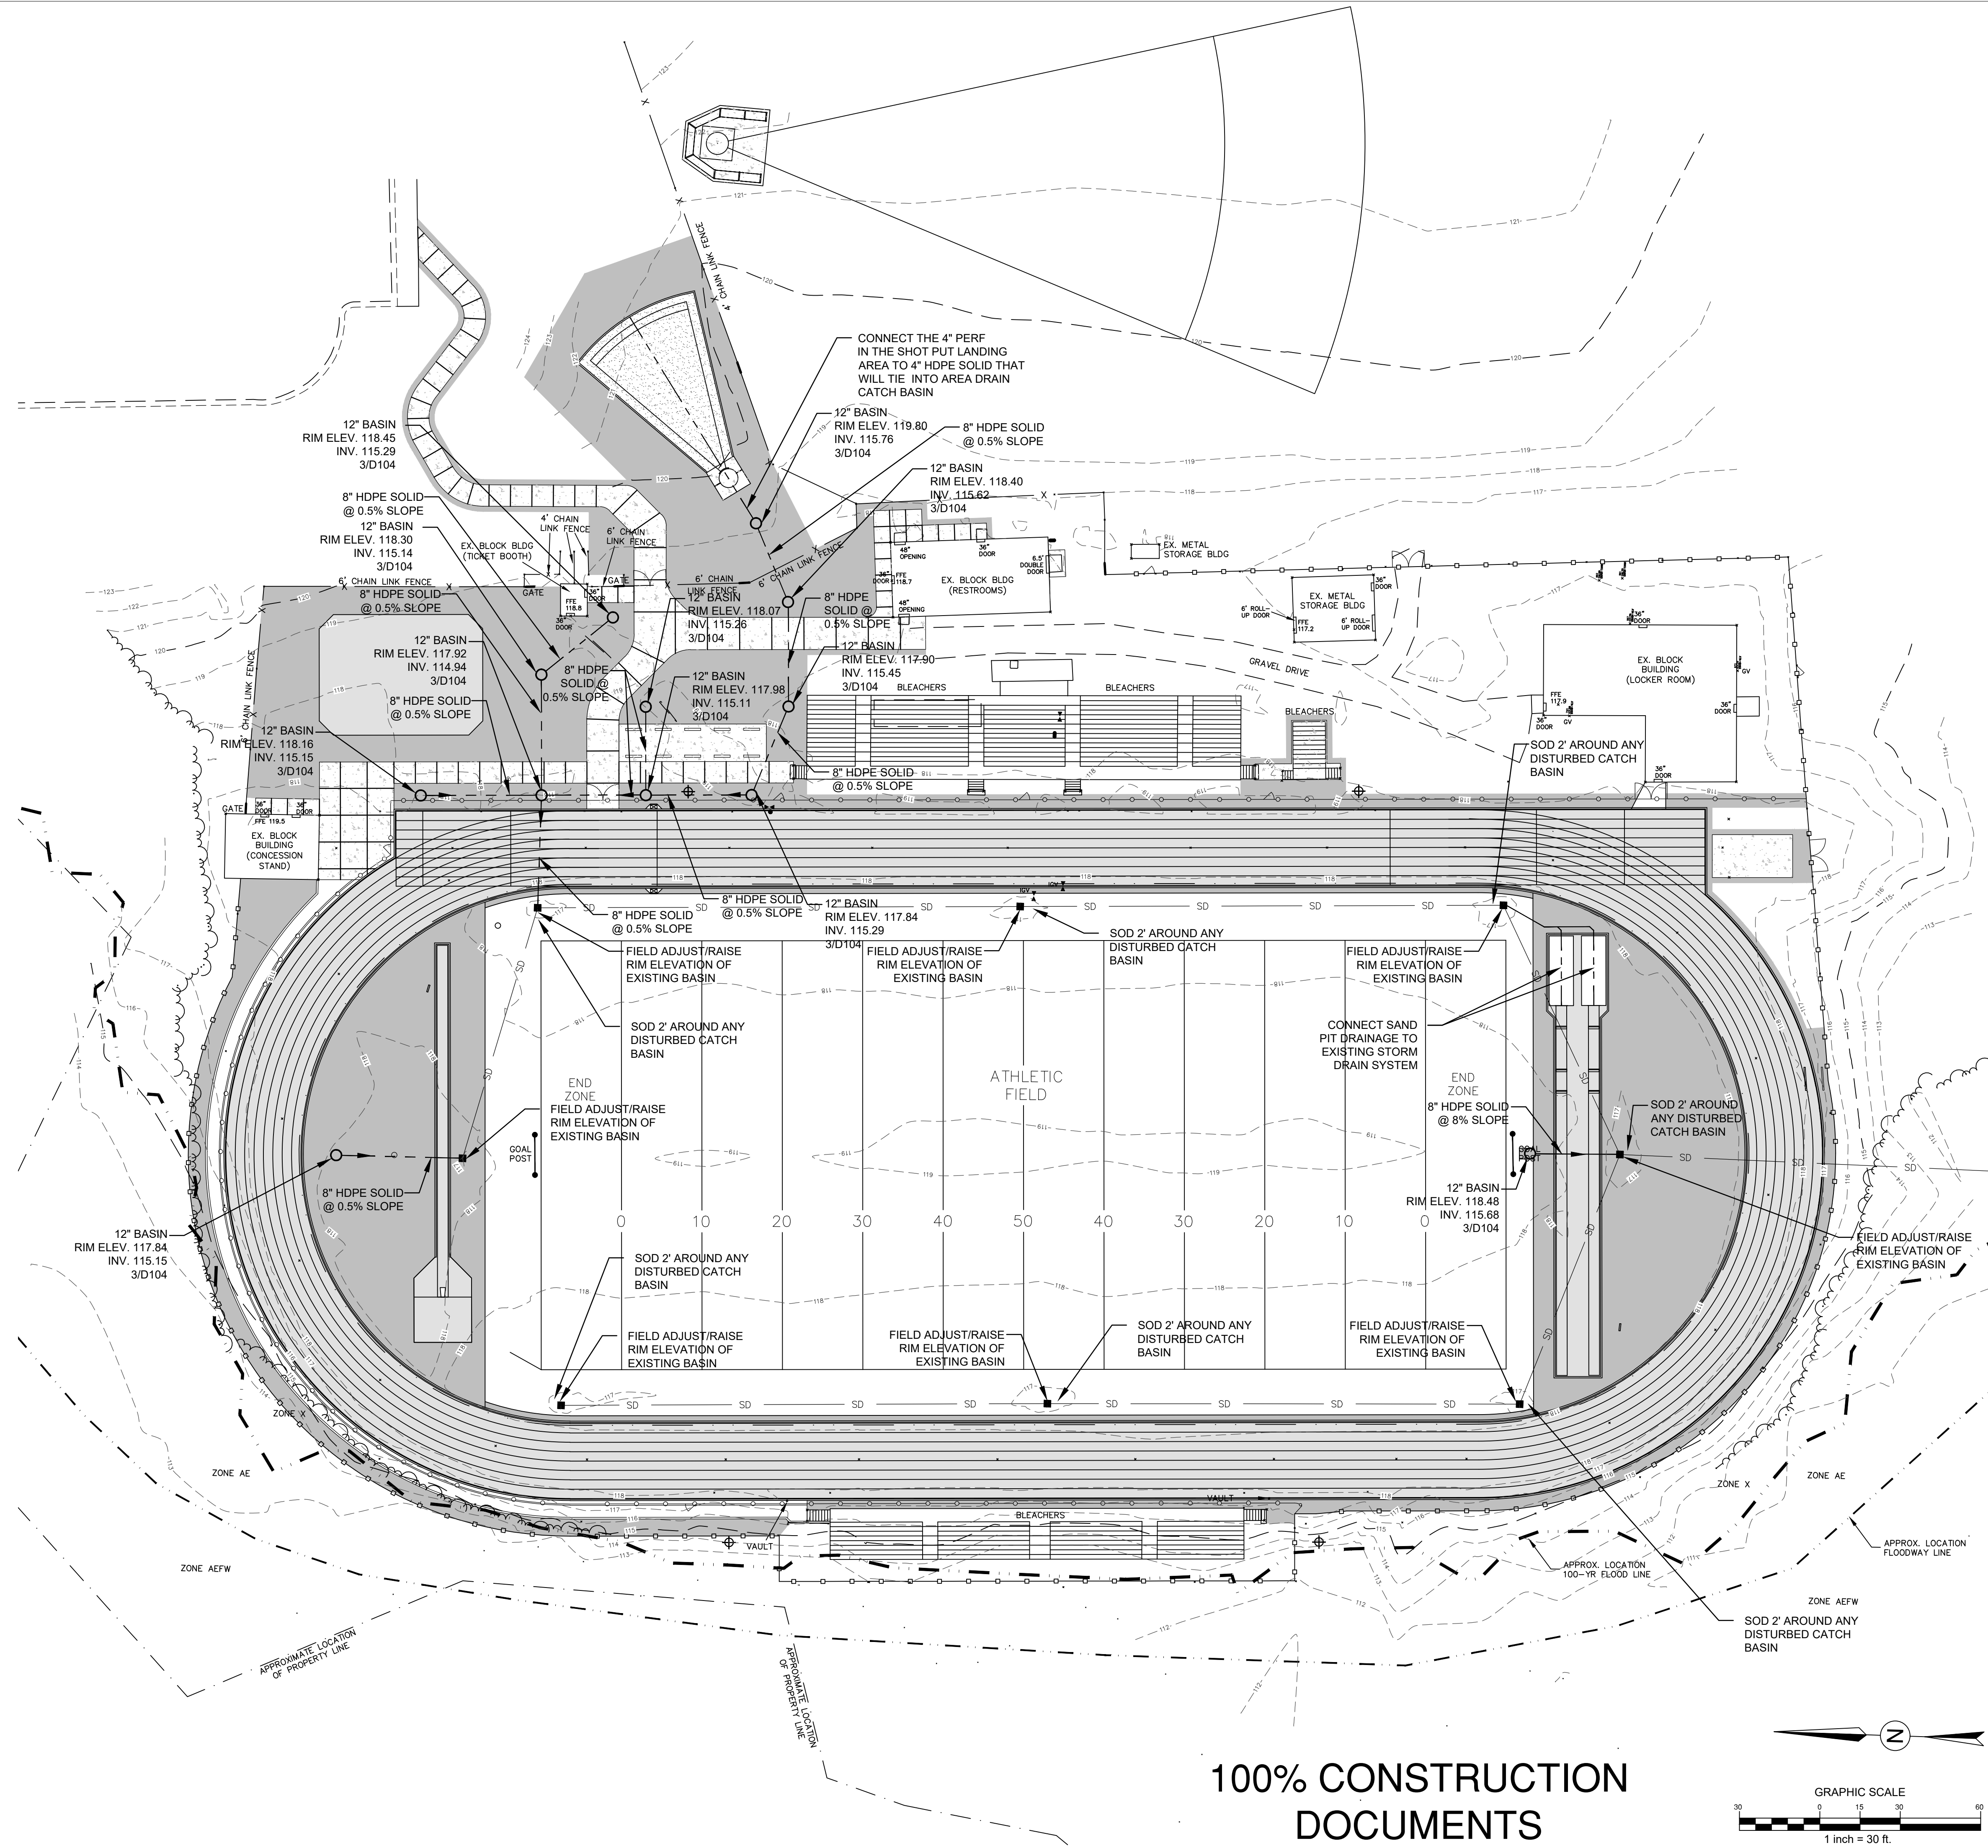

CONTRACTOR SHALL NOTIFY "NORTH CAROLINA ONE CALL" (811) OR (1-800-632-4949) AT LEAST 48 HOURS PRIOR TO BEGINNING CONSTRUCTION OR EXCAVATION TO HAVE EXISTING UTILITIES LOCATED. CONTRACTOR SHALL CONTACT ANY LOCAL UTILITIES THAT PROVIDE THEIR OWN LOCATOR SERVICES INDEPENDENT OF "NORTH CAROLINA ONE CALL". REPORT ANY DISCREPANCIES TO THE ENGINEER IMMEDIATELY.

100% CONSTRUCTION DOCUMENTS

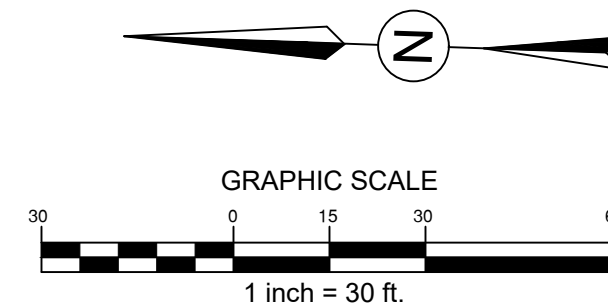

NEW YORK STATE EDUCATION STATEMENT
 I, THE UNDERSIGNED, BEING A LICENSED PROFESSIONAL ENGINEER IN THE STATE OF NORTH CAROLINA, HAVE REVIEWED THE CONSTRUCTION DOCUMENTS FOR ANY PROJECT, UNLESS ALREADY UNDER THE DIRECTION OF A LICENSED ARCHITECT, ENGINEER OR LANDSCAPE ARCHITECT, AND I AM NOT PROVIDING ANY SERVICE BEYOND THE SEAL OF AN ARCHITECT, ENGINEER OR LANDSCAPE ARCHITECT. THE ALDING PARTIAL AREA TO BE SHOWN HEREON AND THE REVISIONS ACCESSED BY FOLLOWING THE REVISION PROCEDURE AND THE DATE OF SUCH ADDITION AND A BRIEF DESCRIPTION OF THE ADDITION.

SHEET INFORMATION
 Issued: 09.15.2023 Scale: 1" = 30'-0"
 Project Status: CONSTRUCTION DOCUMENTS
 Drawn By: BG Checked By: DD
 Drawing Title: Drainage Plan
 Drawing Number: C301

10/09/2021 9:53:09 AM S:\Projects\Wilson\CS\Track\Regr\Pln2\DD\Design\06_CAD\Rev\H\Centrifugal - Bldg_306.rvt

LAYOUT NOTES:

- 1. ALL IMPROVEMENTS AND CONSTRUCTION SHALL BE IN ACCORDANCE WITH THE COUNTY OF WILSON, NC, AND STATE OF NORTH CAROLINA STANDARDS.
2. SHOULD ANY DISCREPANCIES BE FOUND IN THE FIELD THE CONTRACTOR SHALL CONTACT THE OWNER AND LANDSCAPE ARCHITECT PRIOR TO PROCEEDING.
3. ALL DIMENSIONS ARE TO FACE OF CURB, EDGE OF PAVEMENT UNLESS OTHERWISE NOTED.
4. PRIOR TO BEGINNING CONSTRUCTION, THE CONTRACTOR SHALL BE RESPONSIBLE FOR VERIFYING THAT ALL REQUIRED PERMITS AND APPROVALS HAVE BEEN OBTAINED FROM ALL REGULATORY AUTHORITIES.
5. THE CONTRACTOR IS RESPONSIBLE FOR DAMAGE TO ANY EXISTING ITEM AND/OR MATERIAL INSIDE OR OUTSIDE THE CONSTRUCTION LIMITS.
6. THE CONTRACTOR IS CAUTIONED THAT THE LOCATION AND/OR ELEVATION OF EXISTING UTILITIES AS SHOWN ON THESE PLANS IS BASED ON RECORDS OF VARIOUS UTILITY COMPANIES AND, WHERE POSSIBLE, MEASUREMENTS TAKEN IN THE FIELD. THE INFORMATION IS NOT TO BE RELIED ON AS BEING EXACT OR COMPLETE. THE LOCATION OF ALL UTILITIES MUST BE VERIFIED IN THE FIELD BY THE CONTRACTOR PRIOR TO BEGINNING.

7. ELECTRICAL, TELEPHONE, AND CABLE LINES AND POLES TO BE ELIMINATED OR RELOCATED, SHALL BE COORDINATED WITH COUNTY OF WILSON AND ASSOCIATED UTILITY PROVIDERS.

8. DO NOT SCALE DRAWING FOR ACTUAL DIMENSIONS AS IT IS A REPRODUCTION AND IS SUBJECT TO DISTORTION.

9. CONTRACTOR SHALL MAINTAIN THE SITE IN A SAFE AND CLEAN MANNER.

10. STAKE LAYOUT PRIOR TO CONSTRUCTION. VERIFY LOCATIONS WITH LANDSCAPE ARCHITECT OR OWNER


CONSTRUCTION NOTES

- 1 EXISTING GRASS FIELD.
2 NEW TRACK SYNTHETIC SURFACE WITH 8 X 42" LANES AND A 100.932' RADIUS. CONSTRUCT PER DETAIL SHEET D100. ALL TRACK LINE MARKINGS MUST MEET THE SPECIFICATIONS.
3 CONSTRUCT RADIUS POINT PER DETAIL 4/D100.
4 COMMON FINISH LINE.
5 CONSTRUCT HIGH JUMP AREA PER DETAIL 5/D102 (NO PAINTED LINES).
6 CONSTRUCT POLE VAULT BOX PER DETAILS 3/D101 AND 5/D101.
7 CONSTRUCT POLE VAULT RUNWAY PER DETAIL 6/D101.
8 CONSTRUCT LONG/TRIPLE JUMP RUNWAYS PER DETAIL 1/D101.
9 CONSTRUCT SAND PIT PER DETAILS 2/D101 AND 4/D101.
10 PAINTED LINES FOR LONG JUMP AND TRIPLE JUMP.
11 CONSTRUCT SHOT PUT PAD AND THROW AREA PER DETAILS ON SHEET D102. CONTRACTOR TO FIELD VERIFY EXACT LOCATION WITH DESIGNER PRIOR TO CONSTRUCTION.
12 CONSTRUCT DISCUS PER DETAILS ON SHEET D103.
13 BACKFILL AND SOD ALL DISTURBED AREAS WITH BERMUDA 419 SOD OR APPROVED EQUAL. VARIETY OF SOD TO BE APPROVED BY LANDSCAPE ARCHITECT.
14 CONSTRUCT COMM. BOXES PER DETAIL 6/D102.
15 ALTERNATE 5 - PERIMETER 4' HT. CHAIN LINK FENCE AROUND TRACK. INSTALLED PER DETAIL 4/D103.
16 ALTERNATE 5 - CHAIN LINK FENCE (4' HT.) SINGLE SWING GATE (4' WIDE) PER DETAIL 5/D103.
17 ALTERNATE 5 - CHAIN LINK FENCE (4' HT.) DOUBLE SWING GATE (12' WIDE) PER DETAIL 6/D103.
18 ALTERNATE 6 - 6' HT. CHAIN LINK FENCE AROUND STADIUM. INSTALLED PER DETAIL 5/D104.
19 ALTERNATE 6 - CHAIN LINK FENCE (6' HT.) SINGLE SWING GATE (4' WIDE) PER DETAIL 7/D104.
20 ALTERNATE 6 - CHAIN LINK FENCE (6' HT.) DOUBLE SWING GATE (12' WIDE) PER DETAIL 6/D104.
21 CONCRETE SIDEWALK PER DETAIL 1/D104. CONTRACTOR TO MAINTAIN SLOPE NO GREATER THAN 1:20 FOR SIDEWALK.
22 BASE BID - GRAVEL TRAIL OUTSIDE 4' HT. CHAIN LINK FENCE PER DETAIL 5/D100. ALTERNATE 12 - CONCRETE SIDEWALK OUTSIDE 4' HT. CHAIN LINK FENCE PER DETAIL 6/D100.
23 AROUND THE RUNWAYS TO HAVE A 5' MIN. SOD COLLAR.
24 HEAVY DUTY CONCRETE SIDEWALK/PAD PER DETAIL 2/D104.

- LEGEND
PROPOSED FENCE (4' HT.)
PROPOSED FENCE (6' HT.)
PROPOSED LIGHT POLE
PROPOSED GATE LOCATION
EXISTING CHAIN LINK FENCE
EXISTING TREELINE



CONTRACTOR SHALL NOTIFY "NORTH CAROLINA ONE CALL" (811) OR (1-800-632-4949) AT LEAST 48 HOURS PRIOR TO BEGINNING CONSTRUCTION OR EXCAVATION TO HAVE EXISTING UTILITIES LOCATED. CONTRACTOR SHALL CONTACT ANY LOCAL UTILITIES THAT PROVIDE THEIR OWN LOCATOR SERVICES INDEPENDENT OF "NORTH CAROLINA ONE CALL". REPORT ANY DISCREPANCIES TO THE ENGINEER IMMEDIATELY.

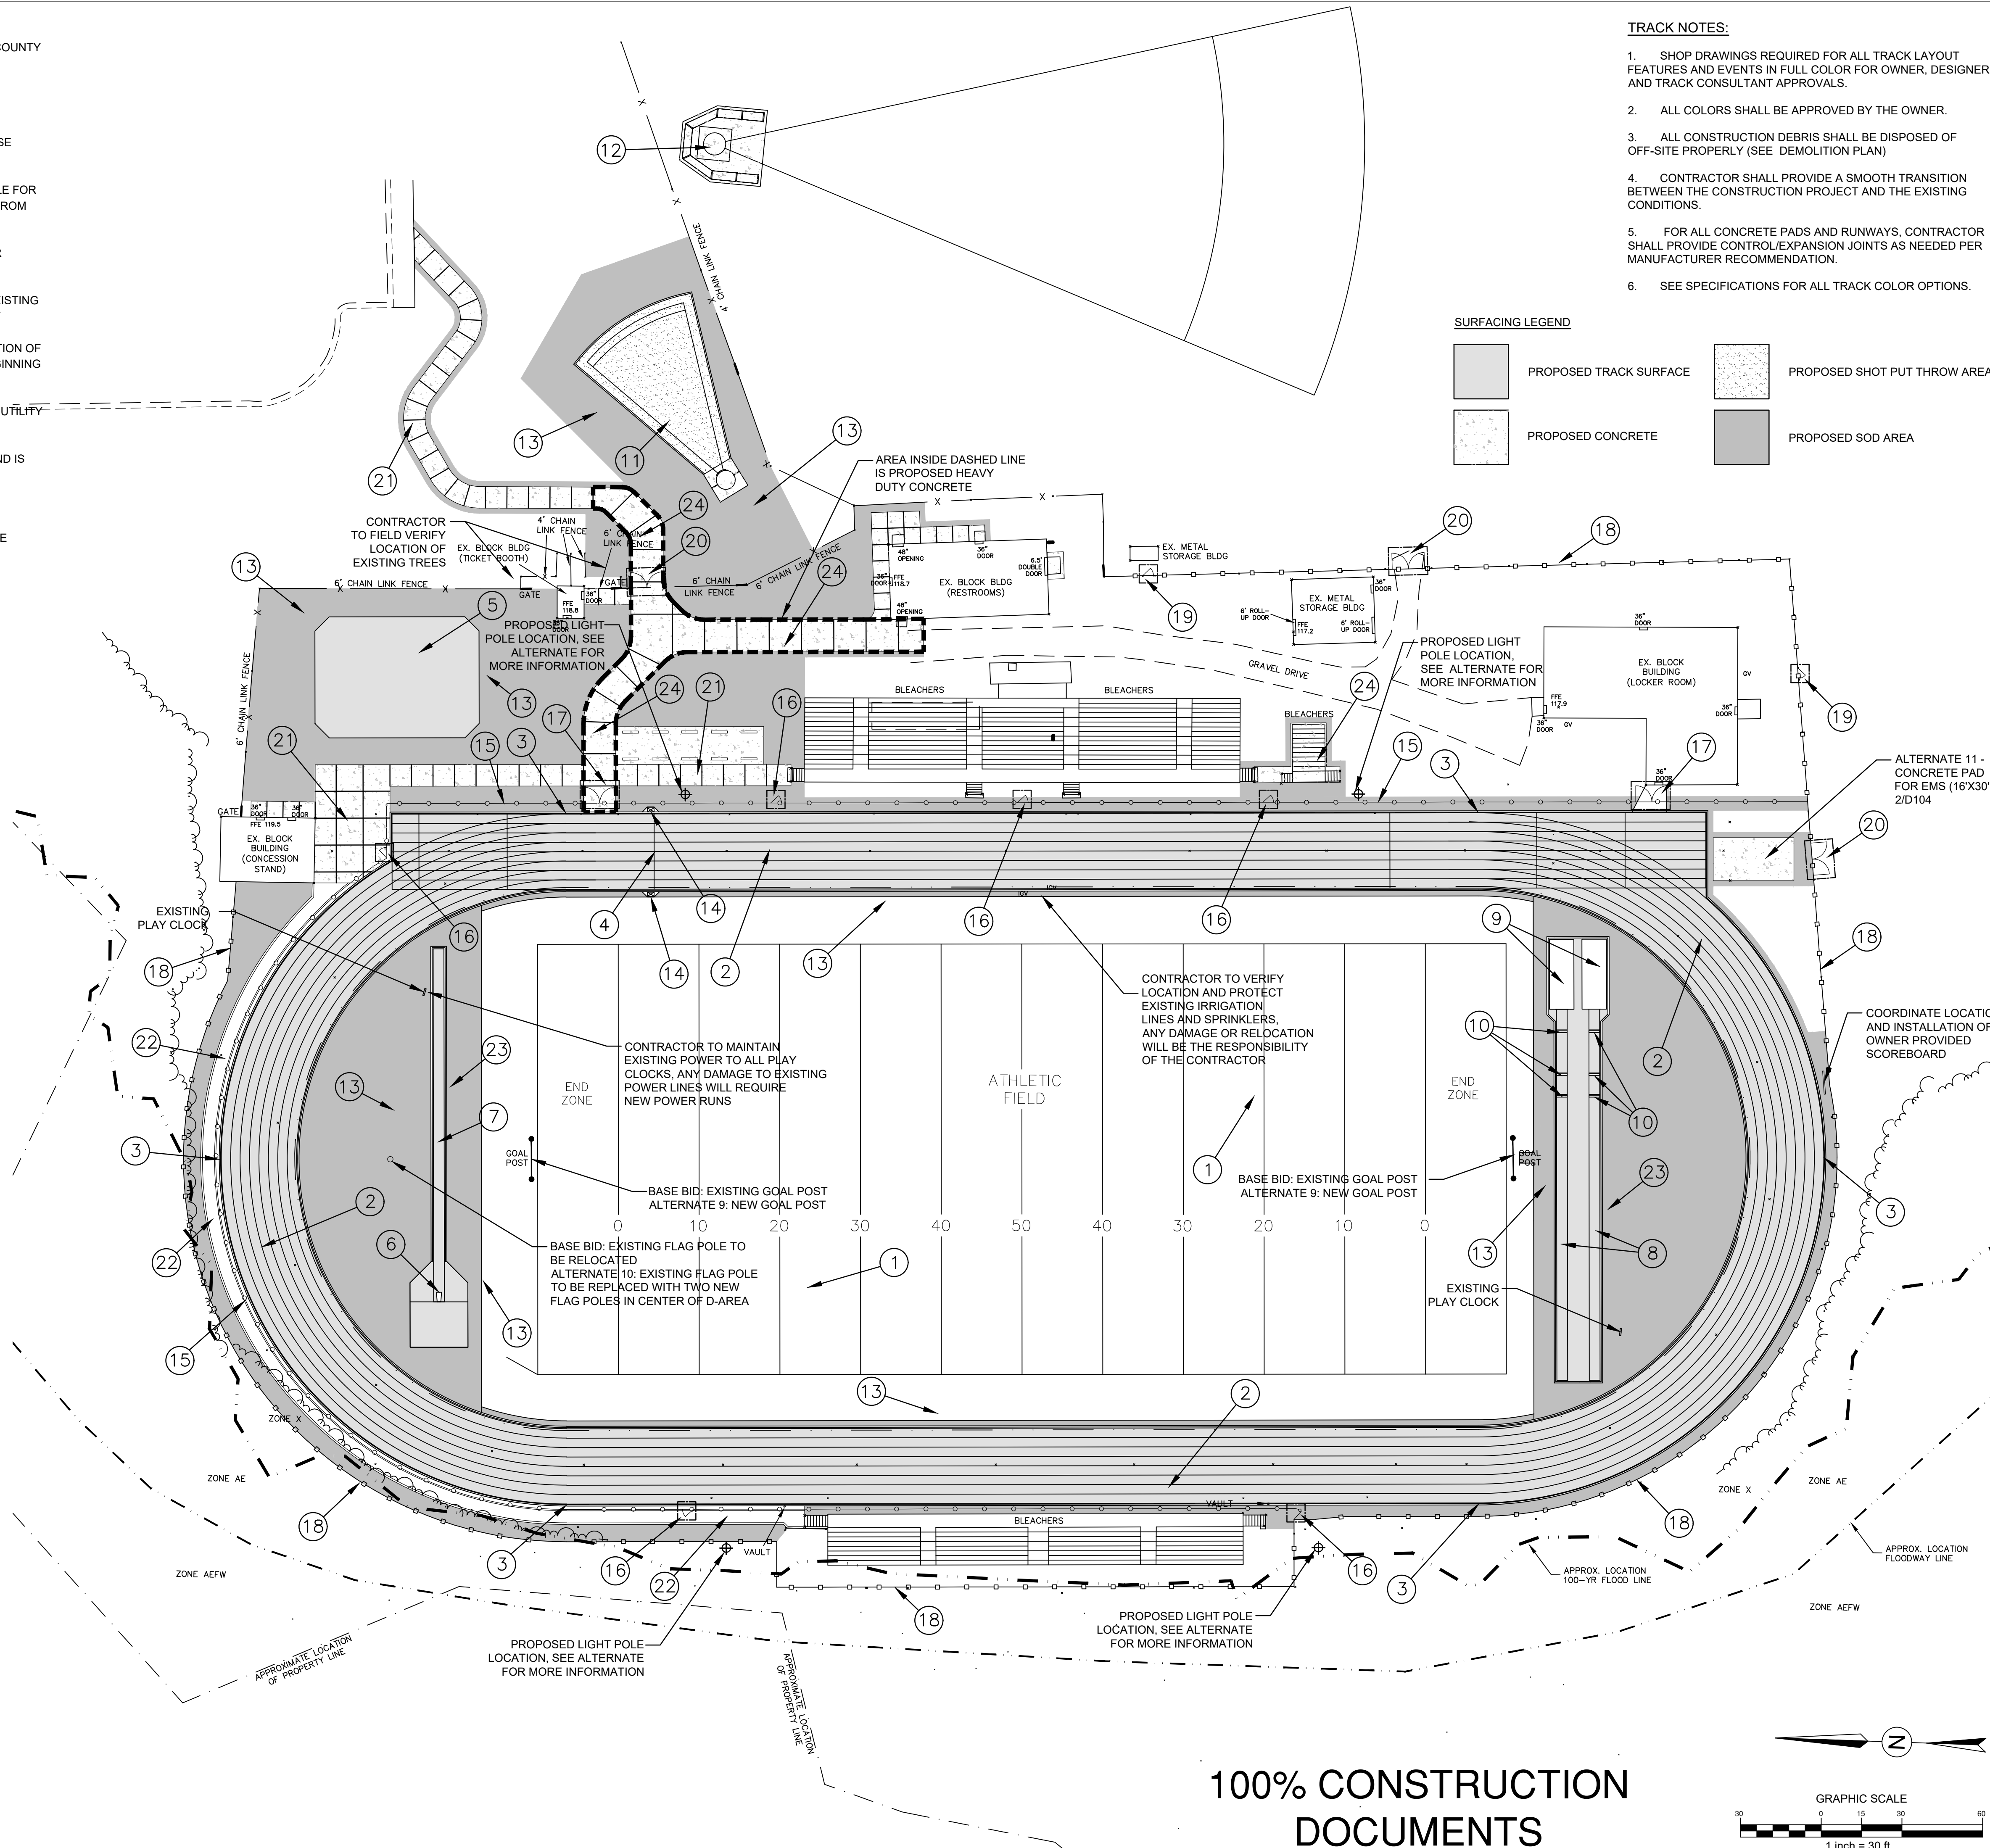

TRACK NOTES:

- 1. SHOP DRAWINGS REQUIRED FOR ALL TRACK LAYOUT FEATURES AND EVENTS IN FULL COLOR FOR OWNER, DESIGNER AND TRACK CONSULTANT APPROVALS.
2. ALL COLORS SHALL BE APPROVED BY THE OWNER.
3. ALL CONSTRUCTION DEBRIS SHALL BE DISPOSED OF OFF-SITE PROPERLY (SEE DEMOLITION PLAN)
4. CONTRACTOR SHALL PROVIDE A SMOOTH TRANSITION BETWEEN THE CONSTRUCTION PROJECT AND THE EXISTING CONDITIONS.
5. FOR ALL CONCRETE PADS AND RUNWAYS, CONTRACTOR SHALL PROVIDE CONTROL/EXPANSION JOINTS AS NEEDED PER MANUFACTURER RECOMMENDATION.
6. SEE SPECIFICATIONS FOR ALL TRACK COLOR OPTIONS.

SURFACING LEGEND

- PROPOSED TRACK SURFACE
PROPOSED SHOT PUT THROW AREA
PROPOSED CONCRETE
PROPOSED SOD AREA



PROJECT INFORMATION

Project Number: R22.16900.00
Client Name:

WILSON COUNTY SCHOOLS

Project Name: HUNT HS - ATHLETICS RENOVATION
HUNT HIGH SCHOOL

District Office Address: 4559 Lamm Rd., Wilson, NC 27893

PROJECT ISSUE & REVISION SCHEDULE

Table with columns: No., Code, Description



NEW YORK STATE EDUCATION STATEMENT


I HEREBY CERTIFY THAT I AM A LICENSED PROFESSIONAL ENGINEER IN THE STATE OF NEW YORK AND THE CONSTRUCTION OF THIS DRAWING WAS UNDER MY CLOSE PERSONAL SUPERVISION AND I AM A MEMBER OF THE SOCIETY OF PROFESSIONAL ENGINEERS AND ARCHITECTS.

SHEET INFORMATION

Issued: 09.15.2023
Scale: 1" = 30'-0"
Project Status: CONSTRUCTION DOCUMENTS
Drawn By: BG
Checked By: DD
Drawing Title: Layout Plan

10/09/2021 9:53:09 AM
S:\Projects\Wilson_Cs\Track_Rep\12\12\Design\06_CAD\Rev\1\Centered - 1m_300.rvt
Drawing Number: L100

100% CONSTRUCTION DOCUMENTS

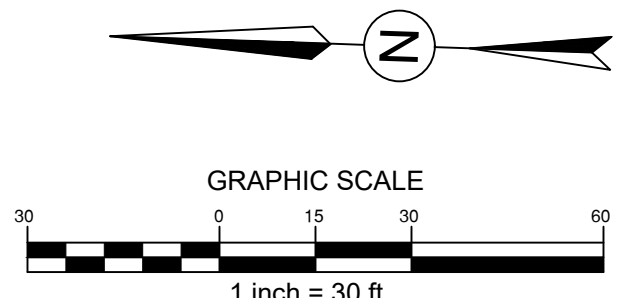





LAYOUT NOTES:

1. ALL IMPROVEMENTS AND CONSTRUCTION SHALL BE IN ACCORDANCE WITH THE COUNTY OF WILSON, NC, AND STATE OF NORTH CAROLINA STANDARDS.
2. SHOULD ANY DISCREPANCIES BE FOUND IN THE FIELD THE CONTRACTOR SHALL CONTACT THE OWNER AND LANDSCAPE ARCHITECT PRIOR TO PROCEEDING.
3. ALL DIMENSIONS ARE TO FACE OF CURB, EDGE OF PAVEMENT UNLESS OTHERWISE NOTED.
4. PRIOR TO BEGINNING CONSTRUCTION, THE CONTRACTOR SHALL BE RESPONSIBLE FOR VERIFYING THAT ALL REQUIRED PERMITS AND APPROVALS HAVE BEEN OBTAINED FROM ALL REGULATORY AUTHORITIES.
5. THE CONTRACTOR IS RESPONSIBLE FOR DAMAGE TO ANY EXISTING ITEM AND/OR MATERIAL INSIDE OR OUTSIDE THE CONSTRUCTION LIMITS.
6. THE CONTRACTOR IS CAUTIONED THAT THE LOCATION AND/OR ELEVATION OF EXISTING UTILITIES AS SHOWN ON THESE PLANS IS BASED ON RECORDS OF VARIOUS UTILITY COMPANIES AND, WHERE POSSIBLE, MEASUREMENTS TAKEN IN THE FIELD. THE INFORMATION IS NOT TO BE RELIED ON AS BEING EXACT OR COMPLETE. THE LOCATION OF ALL UTILITIES MUST BE VERIFIED IN THE FIELD BY THE CONTRACTOR PRIOR TO BEGINNING.
7. ELECTRICAL, TELEPHONE, AND CABLE LINES AND POLES TO BE ELIMINATED OR RELOCATED, SHALL BE COORDINATED WITH COUNTY OF WILSON AND ASSOCIATED UTILITY PROVIDERS.
8. DO NOT SCALE DRAWING FOR ACTUAL DIMENSIONS AS IT IS A REPRODUCTION AND IS SUBJECT TO DISTORTION.
9. CONTRACTOR SHALL MAINTAIN THE SITE IN A SAFE AND CLEAN MANNER.
10. STAKE LAYOUT PRIOR TO CONSTRUCTION. VERIFY LOCATIONS WITH LANDSCAPE ARCHITECT OR OWNER.




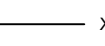

DIMENSION NOTES:


1. ALL DIMENSIONS ARE IN DECIMAL FEET.
2. LONG/TRIPLE JUMP SAND PIT DIMENSIONS ARE TO THE CENTER LEADING EDGE OF THE PIT.
3. POLE VAULT BOX DIMENSIONS ARE TO CENTER OF BACK EDGE OF THE VAULT BOX.
4. RADIUS POINT DIMENSIONS ARE TO CENTER OF THE POINT.
5. THROWING CIRCLE DIMENSIONS ARE TO CENTER OF THE CIRCLE.
6. THROWING CIRCLE ANGLES ARE TO RADIAL/CENTER LINES.
7. ALL OTHER DIMENSIONS ARE TO FACE OF CONCRETE.
8. REFER TO TRACK LAYOUT PLAN FOR PROPOSED SURFACES AND ADDITIONAL CALL OUTS.
9. ALL RADIUS POINTS AND TRACK DIMENSIONS TO BE APPROVED BY PAIGE DESIGN GROUP.

SURFACING LEGEND

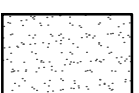-  PROPOSED TRACK SURFACE
-  PROPOSED CONCRETE
-  PROPOSED SHOT PUT THROW AREA
-  PROPOSED SOD AREA


LEGEND

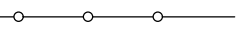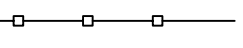-  PROPOSED FENCE (4' HT.)
-  PROPOSED FENCE (6' HT.)
-  PROPOSED LIGHT POLE
-  EXISTING CHAIN LINK FENCE
-  EXISTING TREELINE

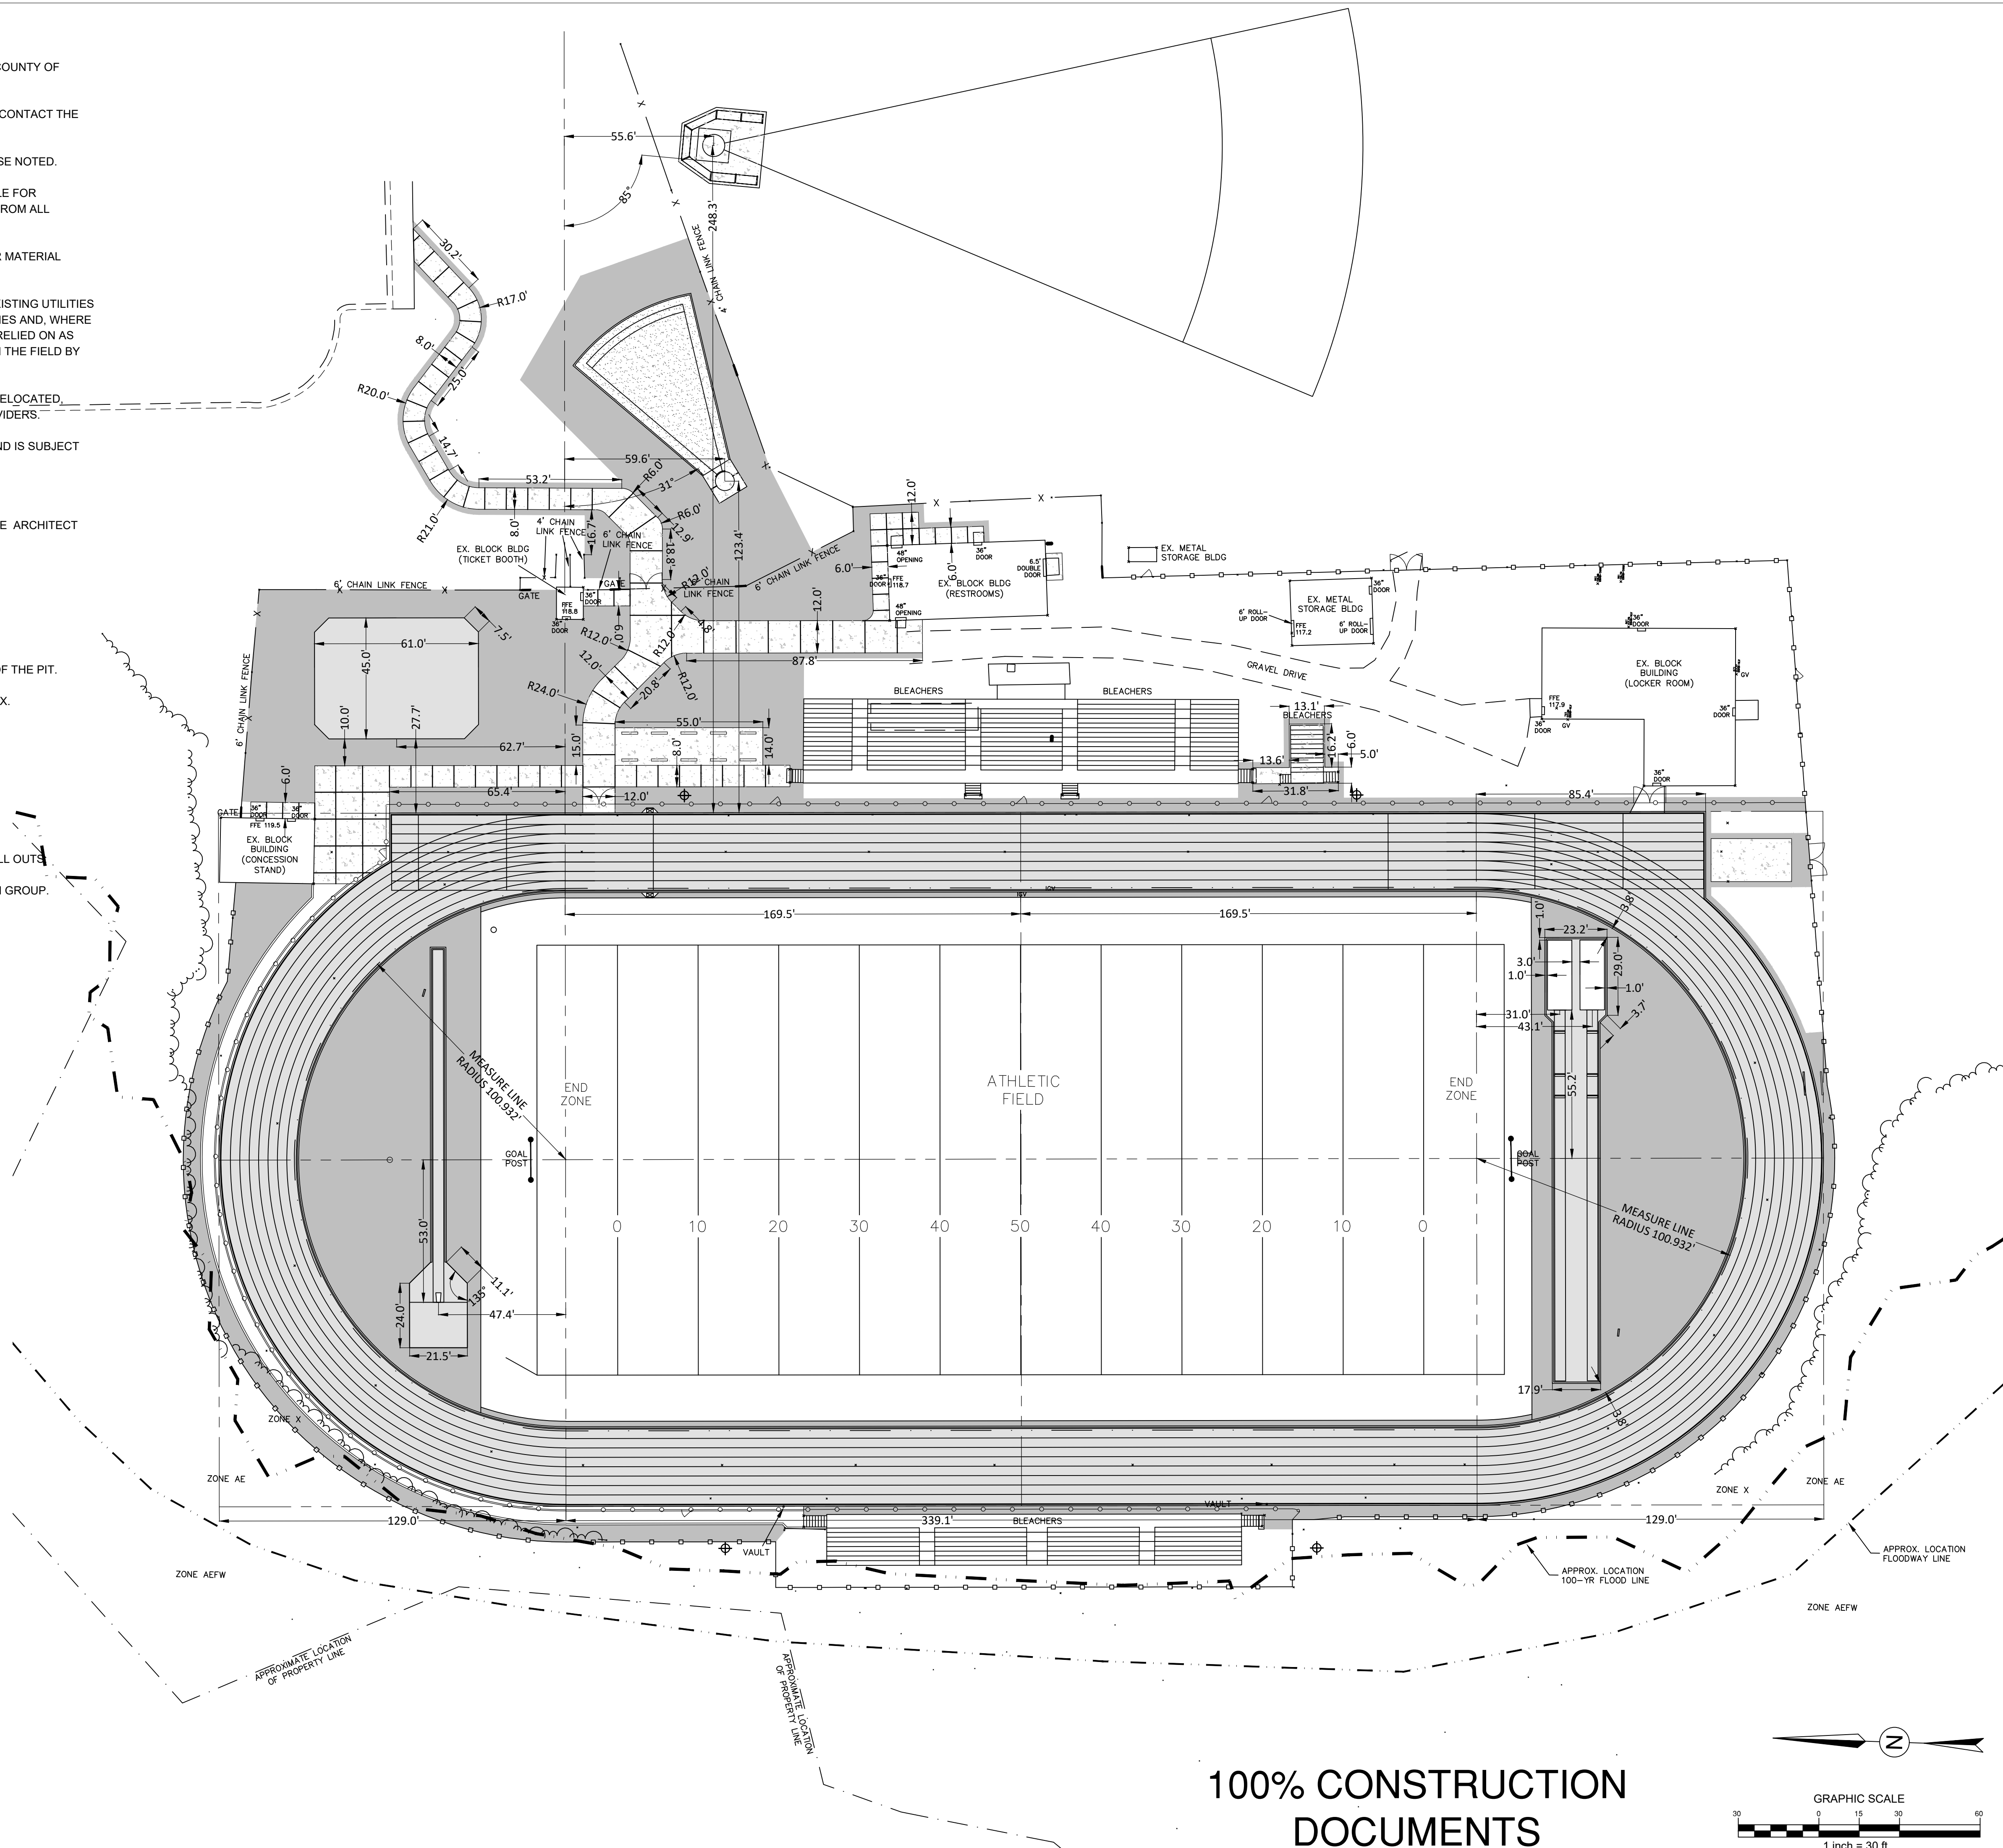

CONTRACTOR SHALL NOTIFY "NORTH CAROLINA ONE CALL" (811) OR (1-800-632-4949) AT LEAST 48 HOURS PRIOR TO BEGINNING CONSTRUCTION OR EXCAVATION TO HAVE EXISTING UTILITIES LOCATED. CONTRACTOR SHALL CONTACT ANY LOCAL UTILITIES THAT PROVIDE THEIR OWN LOCATOR SERVICES INDEPENDENT OF "NORTH CAROLINA ONE CALL". REPORT ANY DISCREPANCIES TO THE ENGINEER IMMEDIATELY.


100% CONSTRUCTION DOCUMENTS

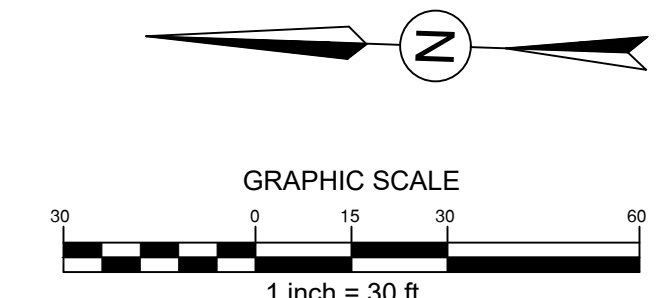


NEW YORK STATE EDUCATION STATEMENT
 I, THE UNDERSIGNED, BEING A LICENSED PROFESSIONAL ENGINEER IN THE STATE OF NEW YORK, DO HEREBY CERTIFY THAT I AM THE DESIGNER OF THE ABOVE WORK AND THAT I AM A MEMBER OF THE BOARD OF REGISTRATION OF PROFESSIONAL ENGINEERS AND ARCHITECTS IN THE STATE OF NEW YORK. I AM NOT PROVIDING ANY SERVICES TO THE STATE OF NEW YORK AND THE ABOVE WORK IS NOT BEING PROVIDED IN CONNECTION WITH MY REGISTRATION AND THE DATE OF SUCH REGISTRATION AND A SPECIFIC DESCRIPTION OF THE ALTERNATION.

SHEET INFORMATION
 Issued: 09.15.2023
 Scale: 1" = 30'-0"
 Project Status: CONSTRUCTION DOCUMENTS
 Drawn By: BG
 Checked By: DD
 Drawing Title: Dimension Plan
 Drawing Number: L101


10/09/2021 9:53:09 AM S:\Projects\Wilson\CS\Track\Regr\Pln\2\DD\Design\06_CAD\Regr\Centrifugal - Bm_306.rvt

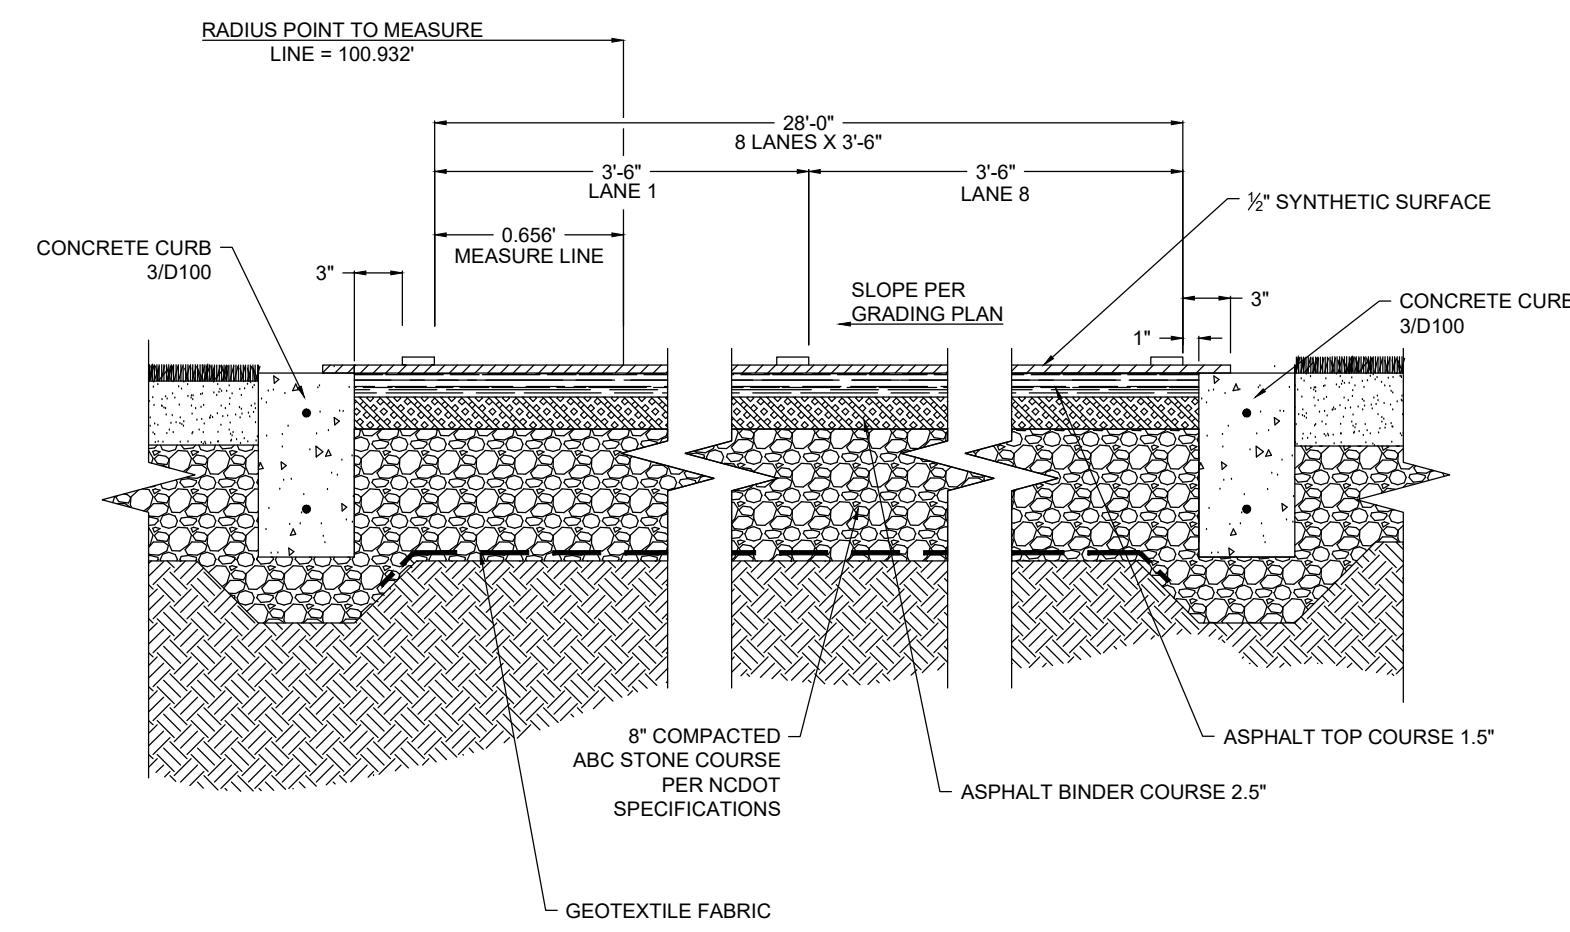


1 TRACK PAVEMENT SECTION
NOT TO SCALE

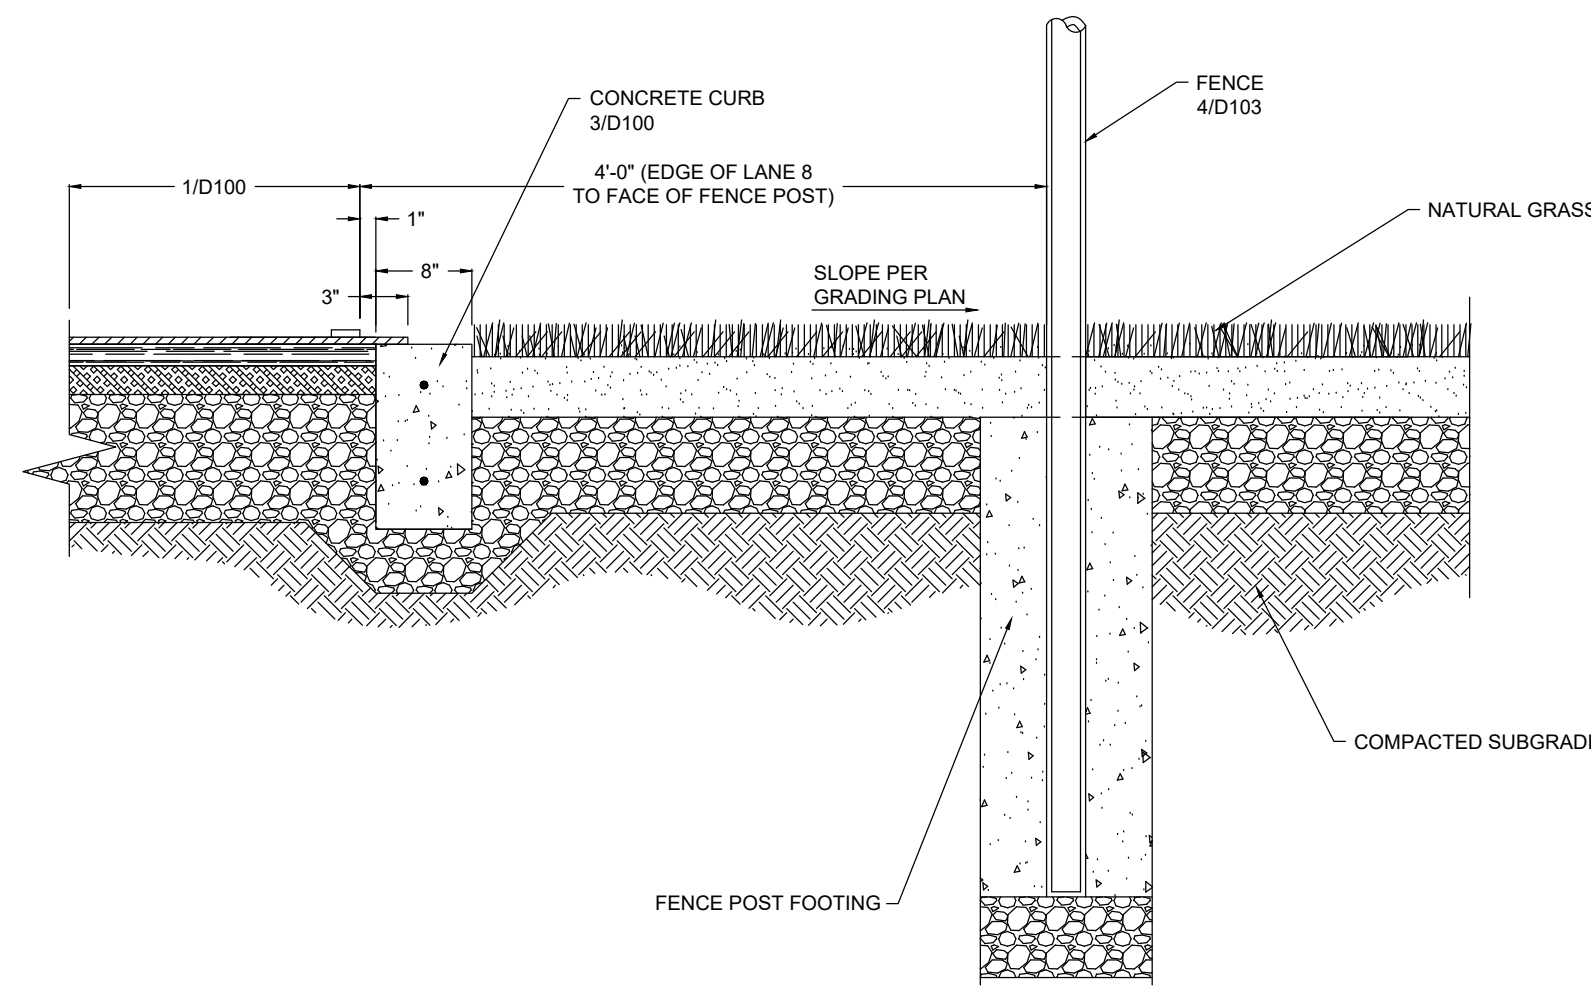

2 GRASS TRACK APRON AND PERIMETER FENCE
NOT TO SCALE

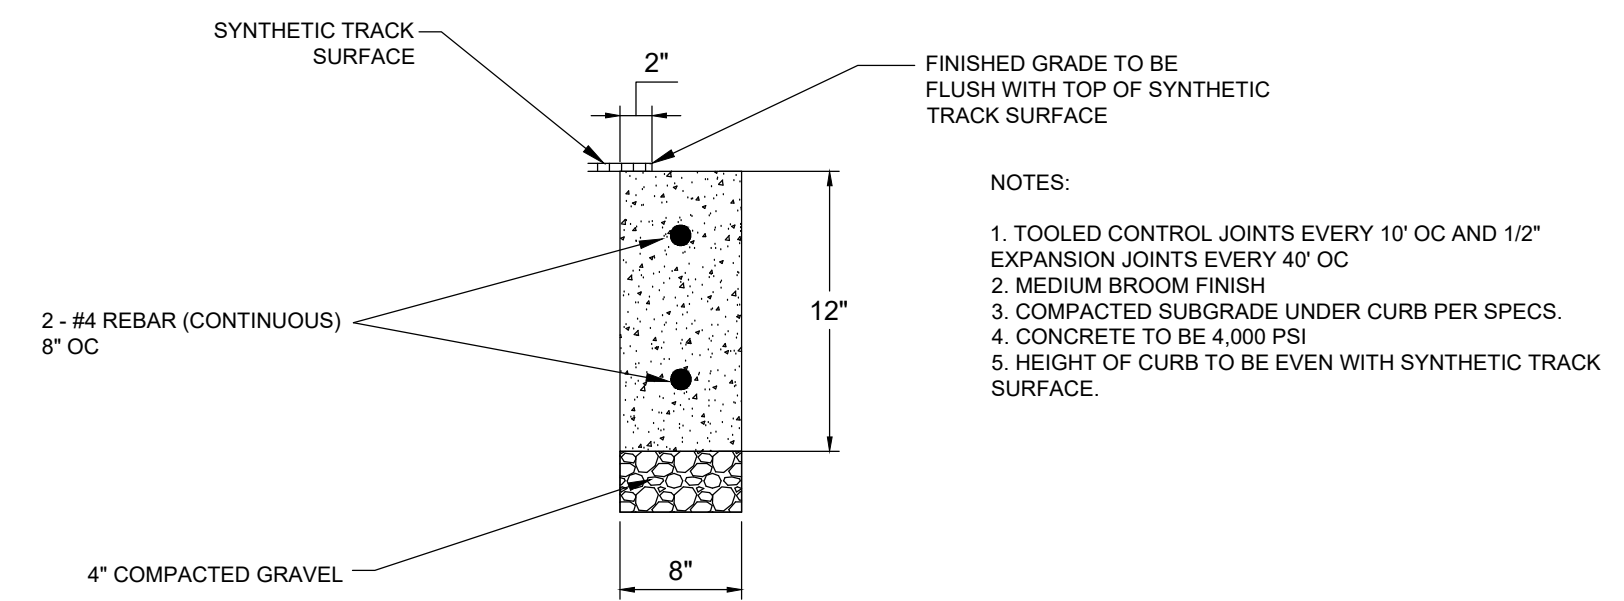


3 CONCRETE CURB
NOT TO SCALE

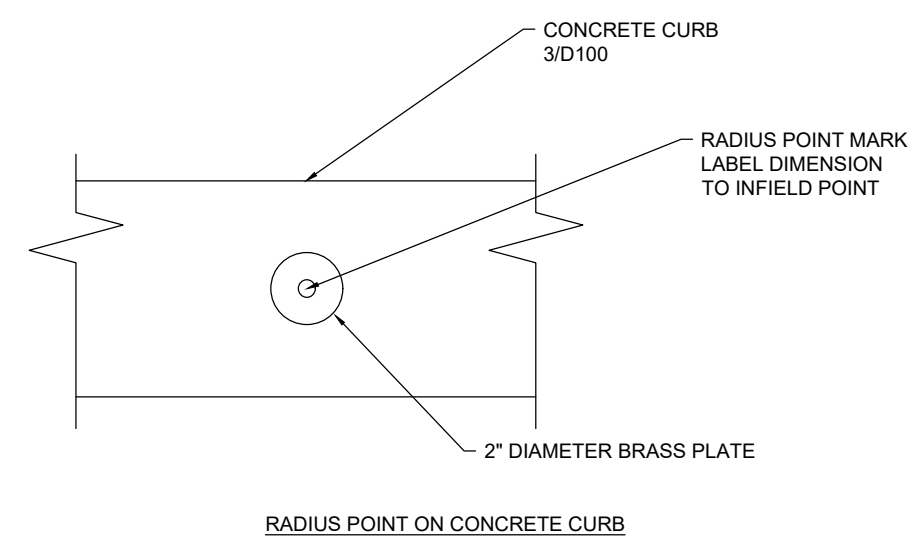


4 RADIUS POINT
NOT TO SCALE

NOTE:
1. PROVIDE LOCATION PINS IN OUTSIDE CONCRETE CURBS AT 4 POINTS OF CURVATURE (PC-S) AND APEX OF BOTH TURNS (SEE PLAN)

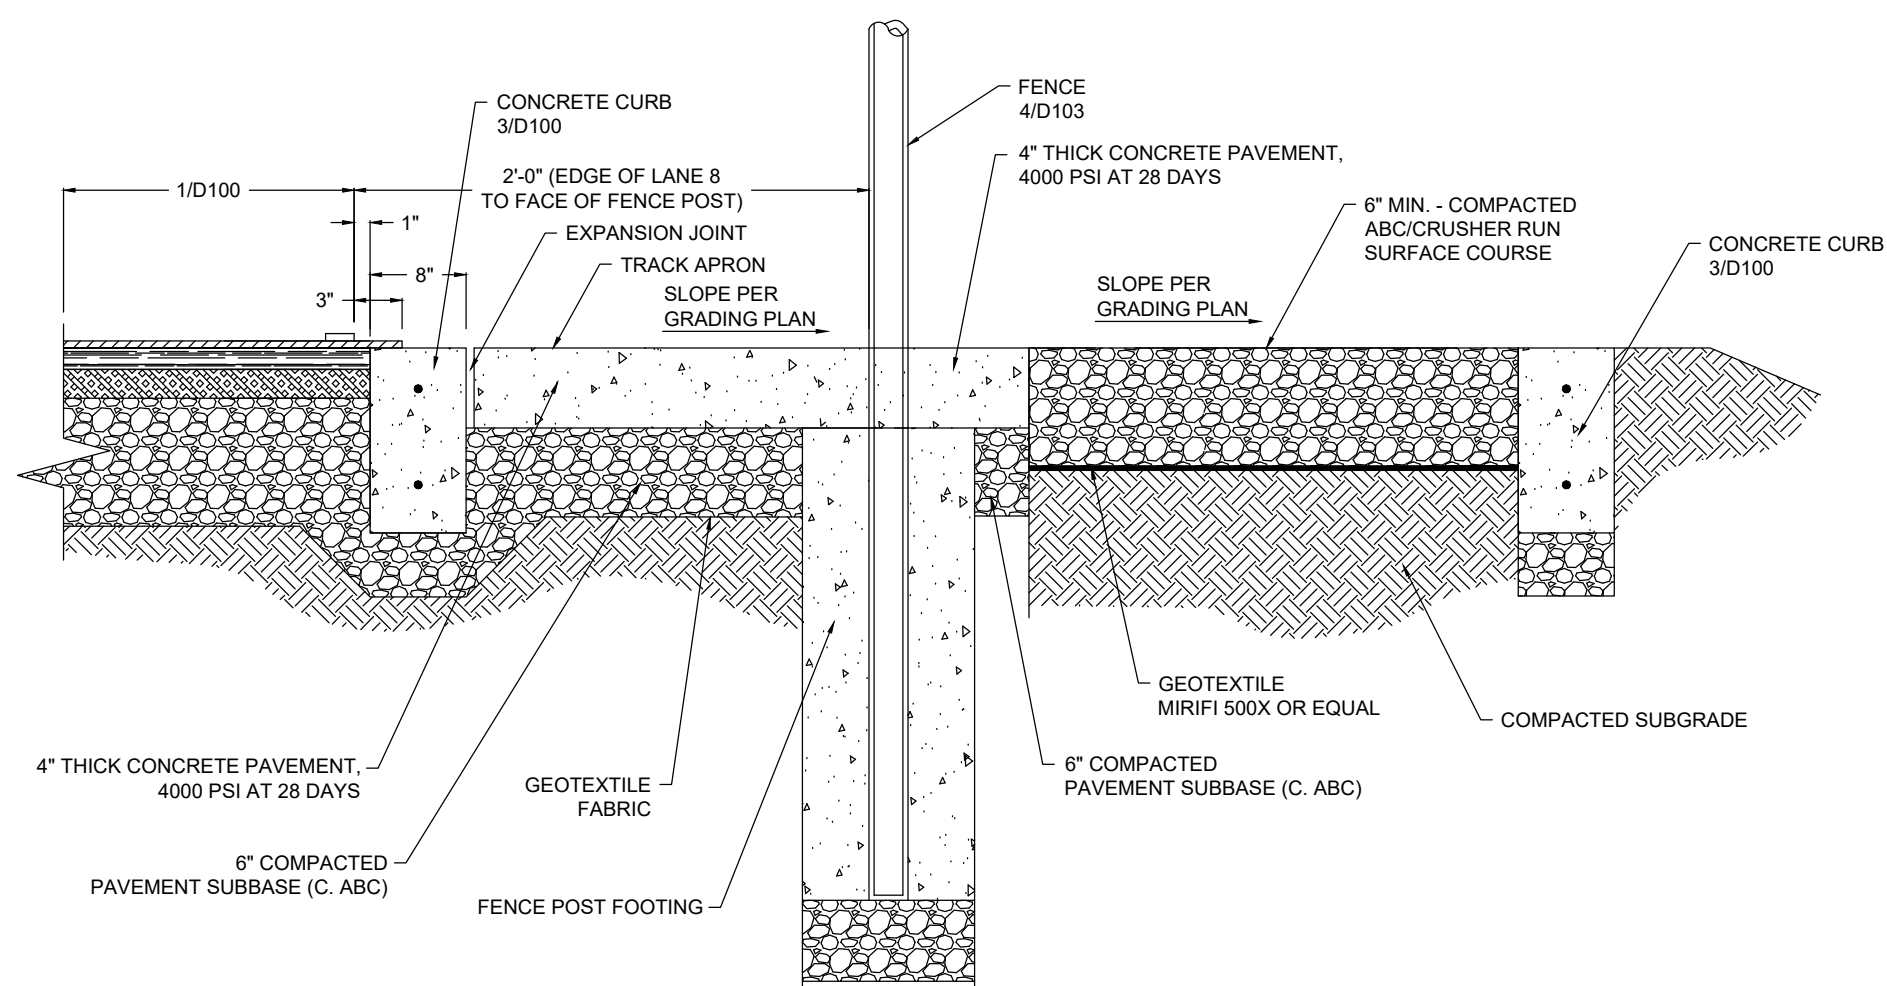

5 TRACK APRON, FENCE & GRAVEL PATH
NOT TO SCALE

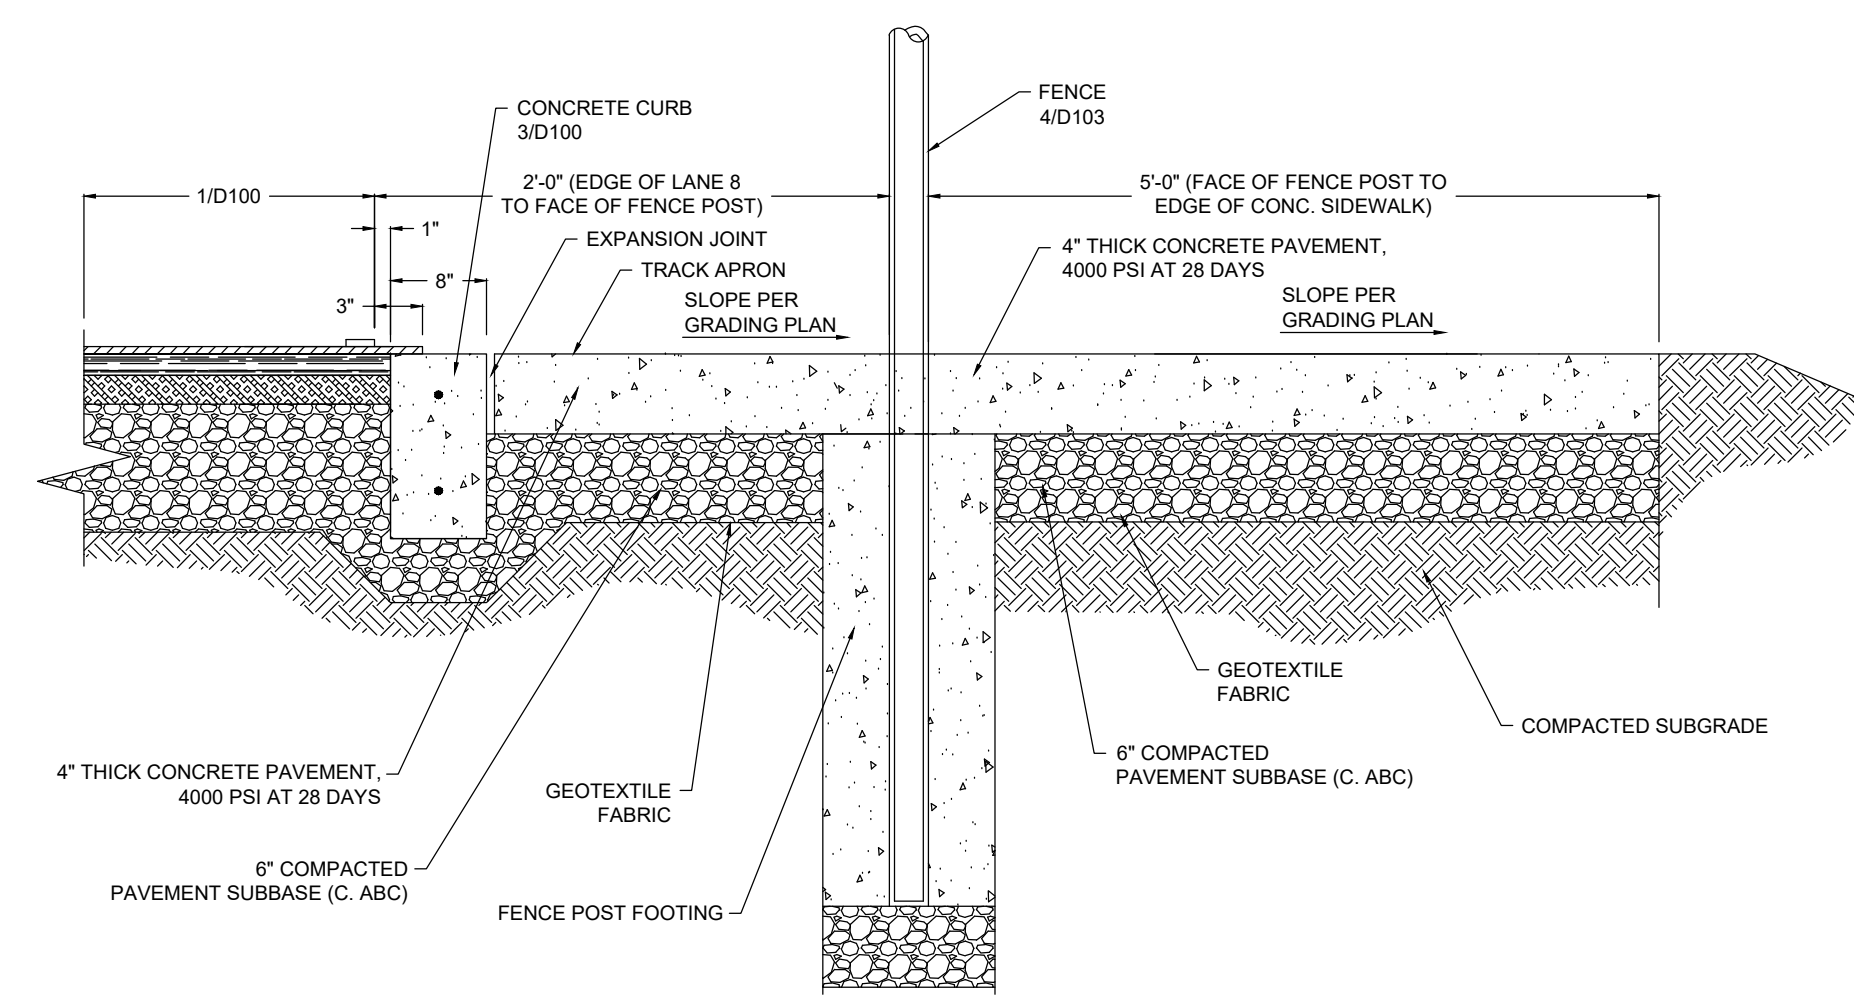


6 ALTERNATE 12 - TRACK APRON, FENCE & CONC. SIDEWALK
NOT TO SCALE

7 RESERVED
NOT TO SCALE

8 RESERVED
NOT TO SCALE

9 RESERVED
NOT TO SCALE

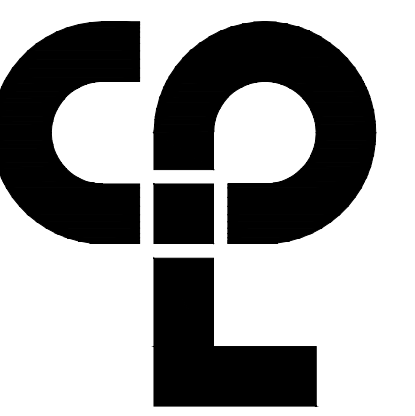

CPL | Architecture Engineering Planning
1620 Hillsborough Street Suite A,
Raleigh, NC 27605
CPLteam.com



314 Tom Hall St.
Fort Mill, SC 29715
(717) 803.981.4330
www.fitfields.com

PROJECT INFORMATION

Project Number
R22.16900.00
Client Name
WILSON COUNTY SCHOOLS

PROJECT NAME

HUNT HS - ATHLETICS RENOVATION
HUNT HIGH SCHOOL

District Office Address
4559 Lamm Rd, Wilson, NC 27893

PROJECT ISSUE & REVISION SCHEDULE

No. Date Description




NEW YORK STATE EDUCATION STATEMENT

IT IS THE POLICY OF THE NEW YORK STATE EDUCATION LAW AND THE COMMISSIONER'S REGULATION FOR ANY PERSON, QUALIFIED UNDER THE PROVISIONS OF A LICENSED ARCHITECT, ENGINEER OR LAND SURVEYOR, TO EXERCISE HIS OR HER PROFESSIONAL FUNCTIONS IN THE STATE OF NEW YORK ONLY IF HE OR SHE BEARS THE SEAL OF AN ARCHITECT, ENGINEER OR SURVEYOR IN ALTERNATE. THE ALTERNATE PART SHALL APPEAR TO THE SEAL HEREON, AND THE REGISTRATION ACTED BY FOLLOWING THE REGISTRATION AND THE DATE OF SUCH ALTERNATE, AND A PRECISE DESCRIPTION OF THE ALTERNATE.

SHEET INFORMATION

Issued
09.15.2023
Project Status
CONSTRUCTION DOCUMENTS
Drawn By
BG
Checked By
DD
Drawing Title
DETAILS


Drawing Number

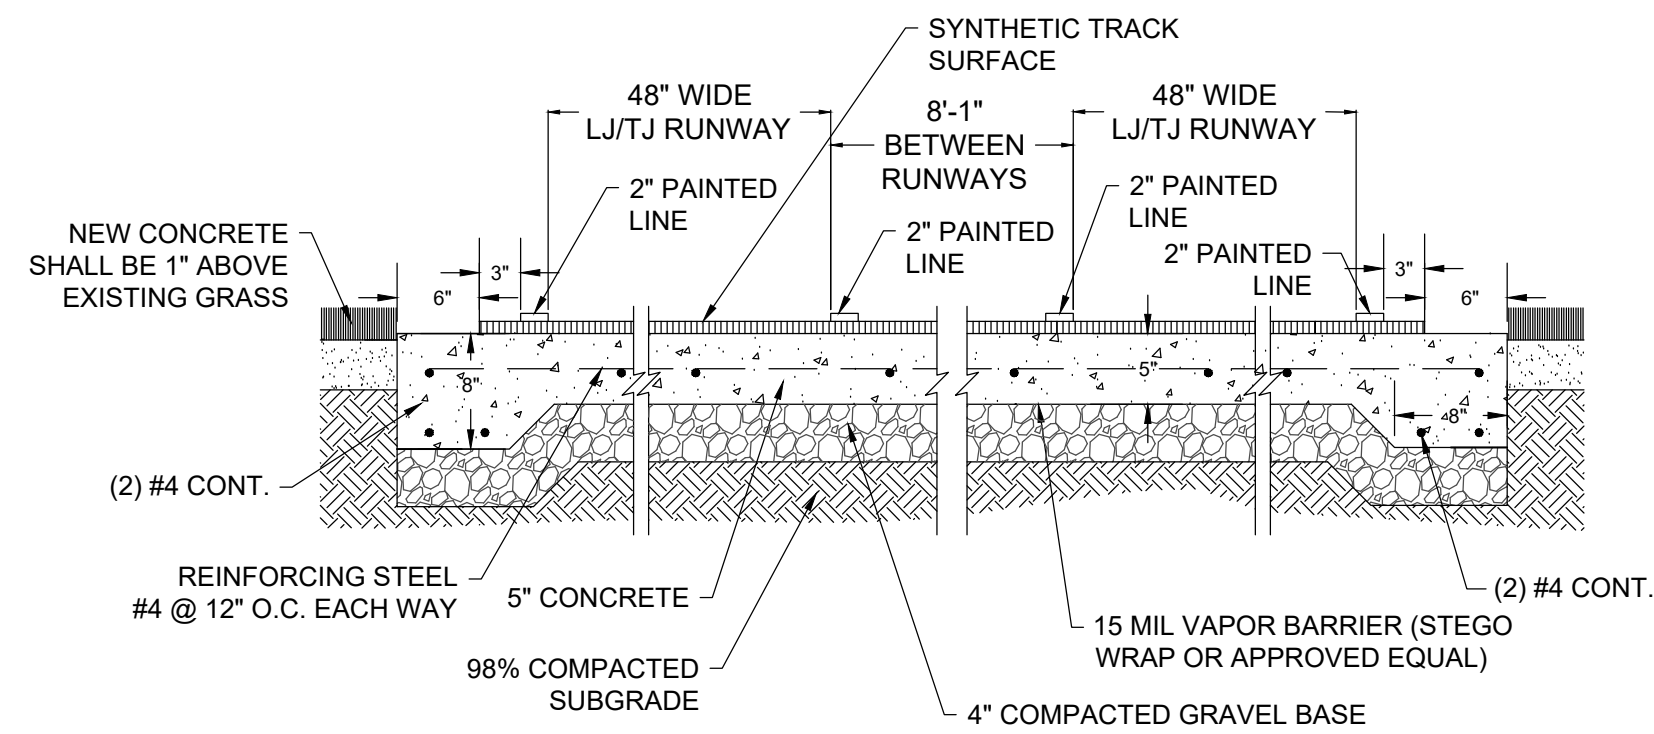

- NOTES:
 1. FOR ALL CONCRETE PADS AND RUNWAYS, CONTRACTOR TO PROVIDE CONTROL/EXPANSION JOINTS SHOP DRAWING PER MANUFACTURERS RECOMMENDATION/SPECIFICATION.
 2. ALL CONCRETE JOINT PLANS TO BE SUBMITTED AS SHOP DRAWINGS FOR REVIEW.
 3. NO FLY ASH IN CONCRETE.
 4. CONCRETE MIX TO BE DELEGATED BY MANUFACTURER TO ENSURE APPROVAL WITH THE SYNTHETIC TRACK SURFACING REQUIREMENTS SET FORTH BY THE TRACK MANUFACTURER. PLEASE SUBMIT MIX FOR REVIEW.

1 LONG/TRIPLE JUMP RUNWAY SECTION


NOT TO SCALE

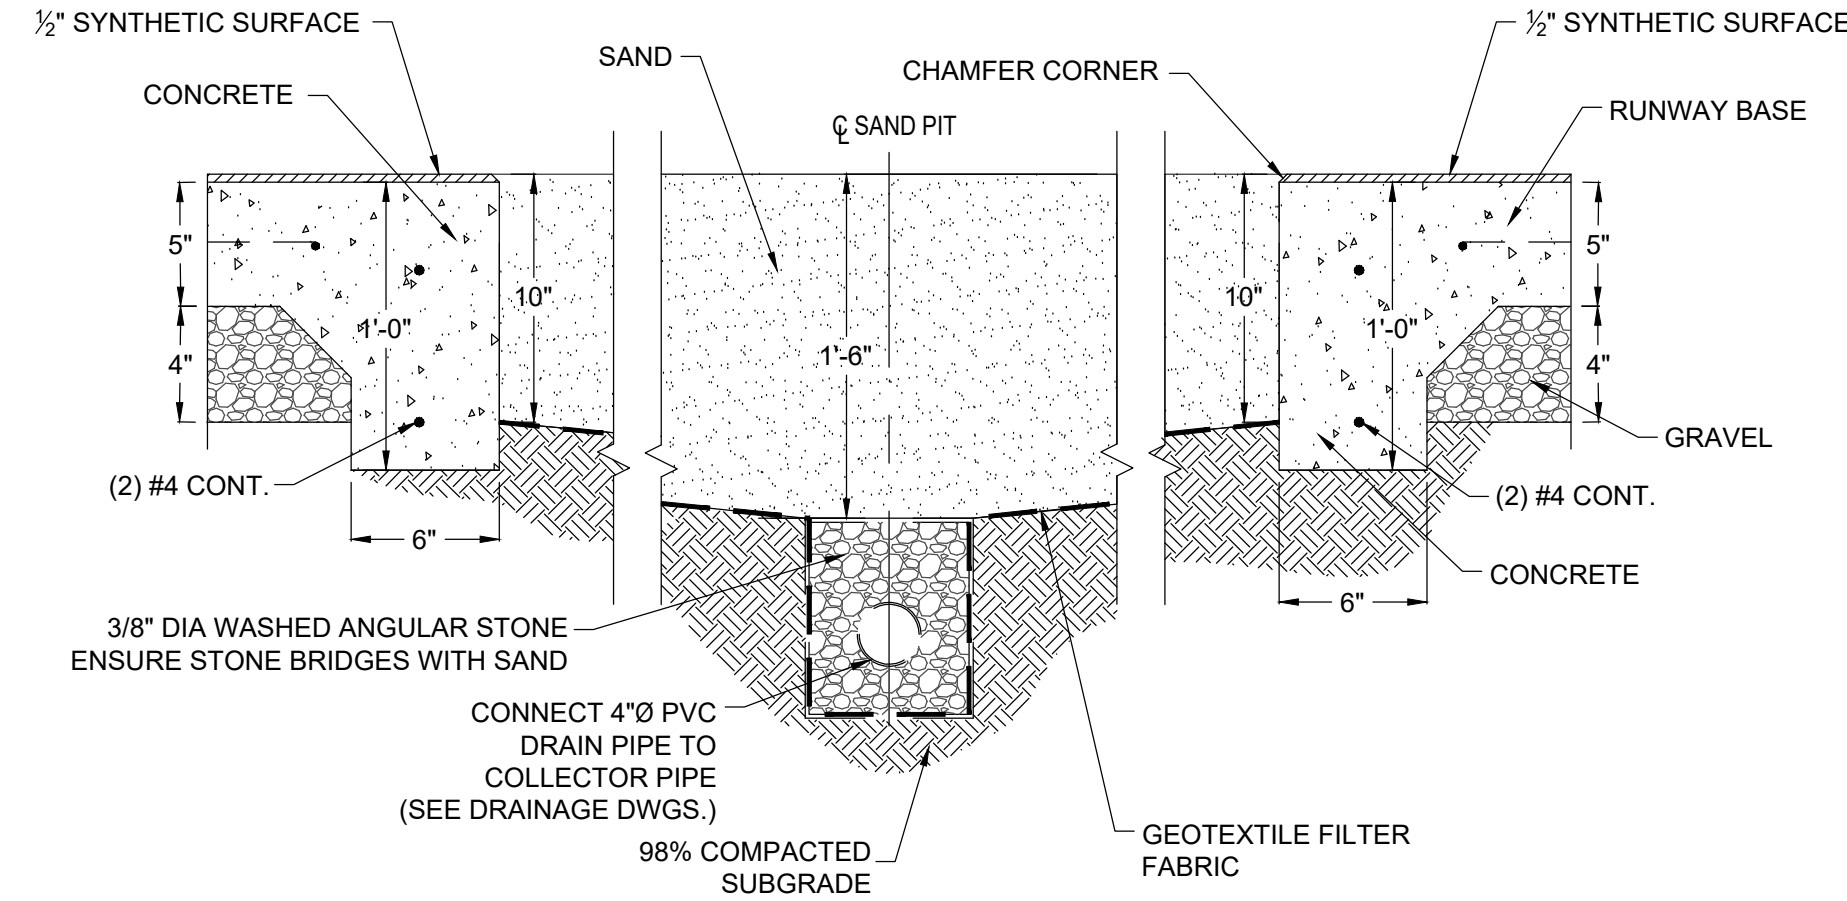

- NOTES:
 1. ALL DRAWINGS DEPICTING IN-GROUND EQUIPMENTS ARE FOR BIDDING ONLY. REFER TO SHOP DRAWINGS FOR INSTALLATION DIMENSIONS AND INSTRUCTIONS.

2 LONG/TRIPLE JUMP SANDPIT SECTION


NOT TO SCALE

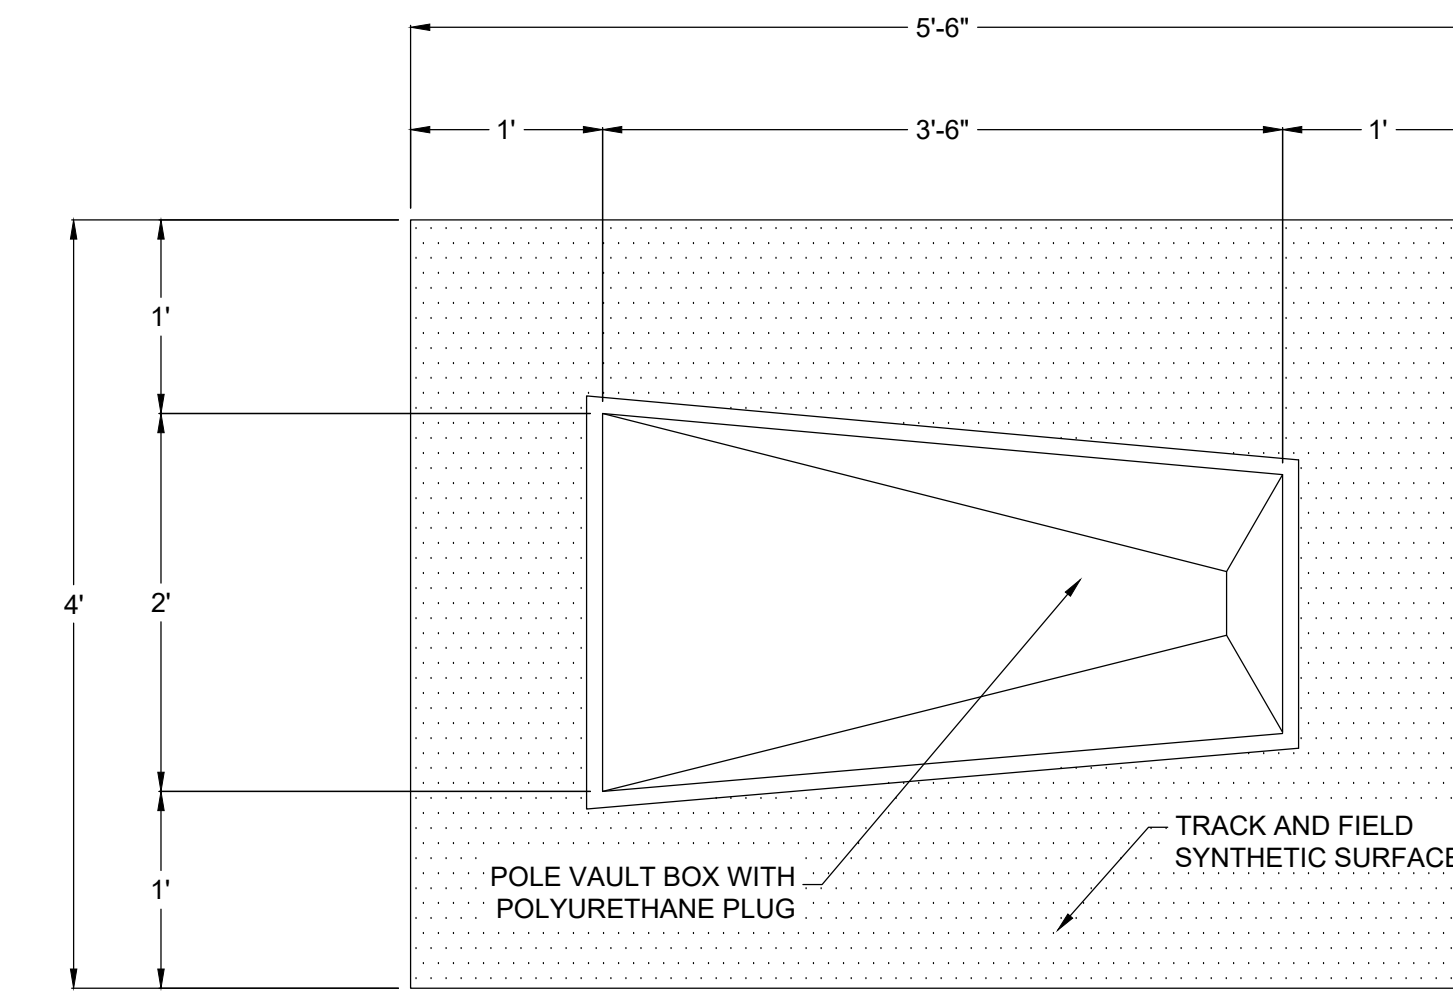

- NOTE:
 1. REFER TO SHOP DRAWINGS FOR INSTALLATION DIMENSIONS AND INSTRUCTIONS.


3 POLE VAULT BOX PLAN

NOT TO SCALE

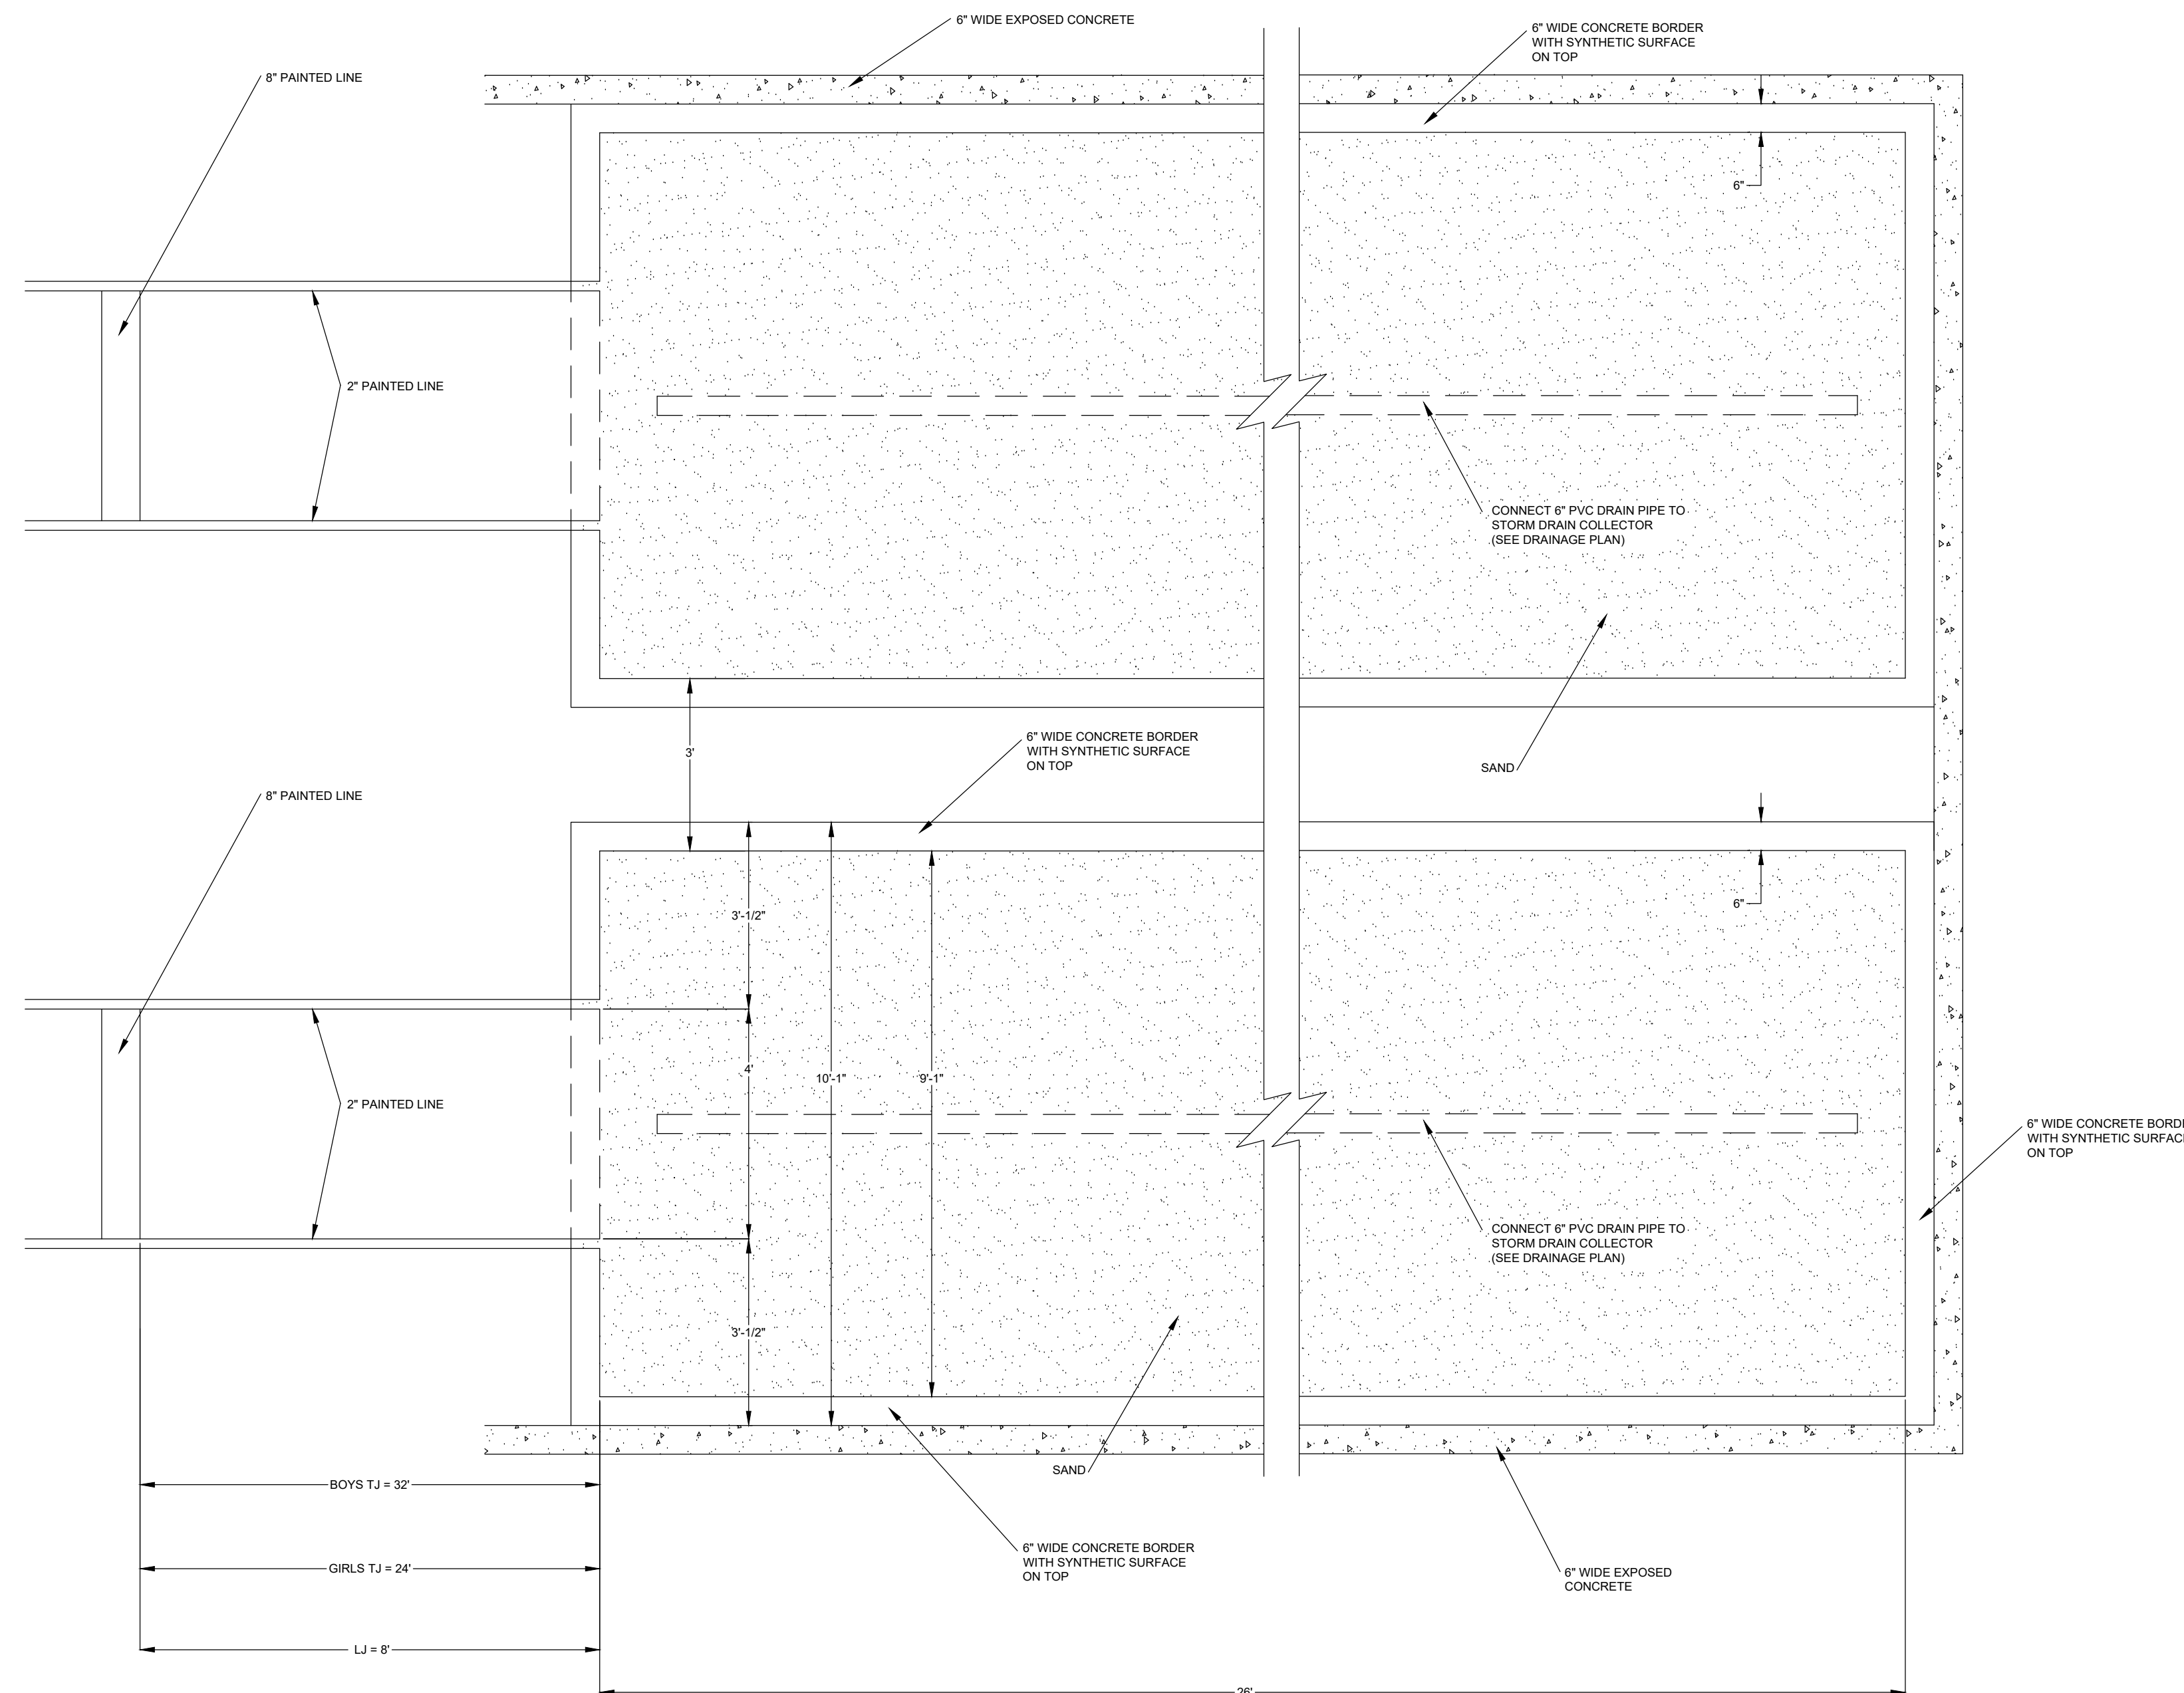

4 LONG/TRIPLE JUMP SANDPIT PLAN


NOT TO SCALE

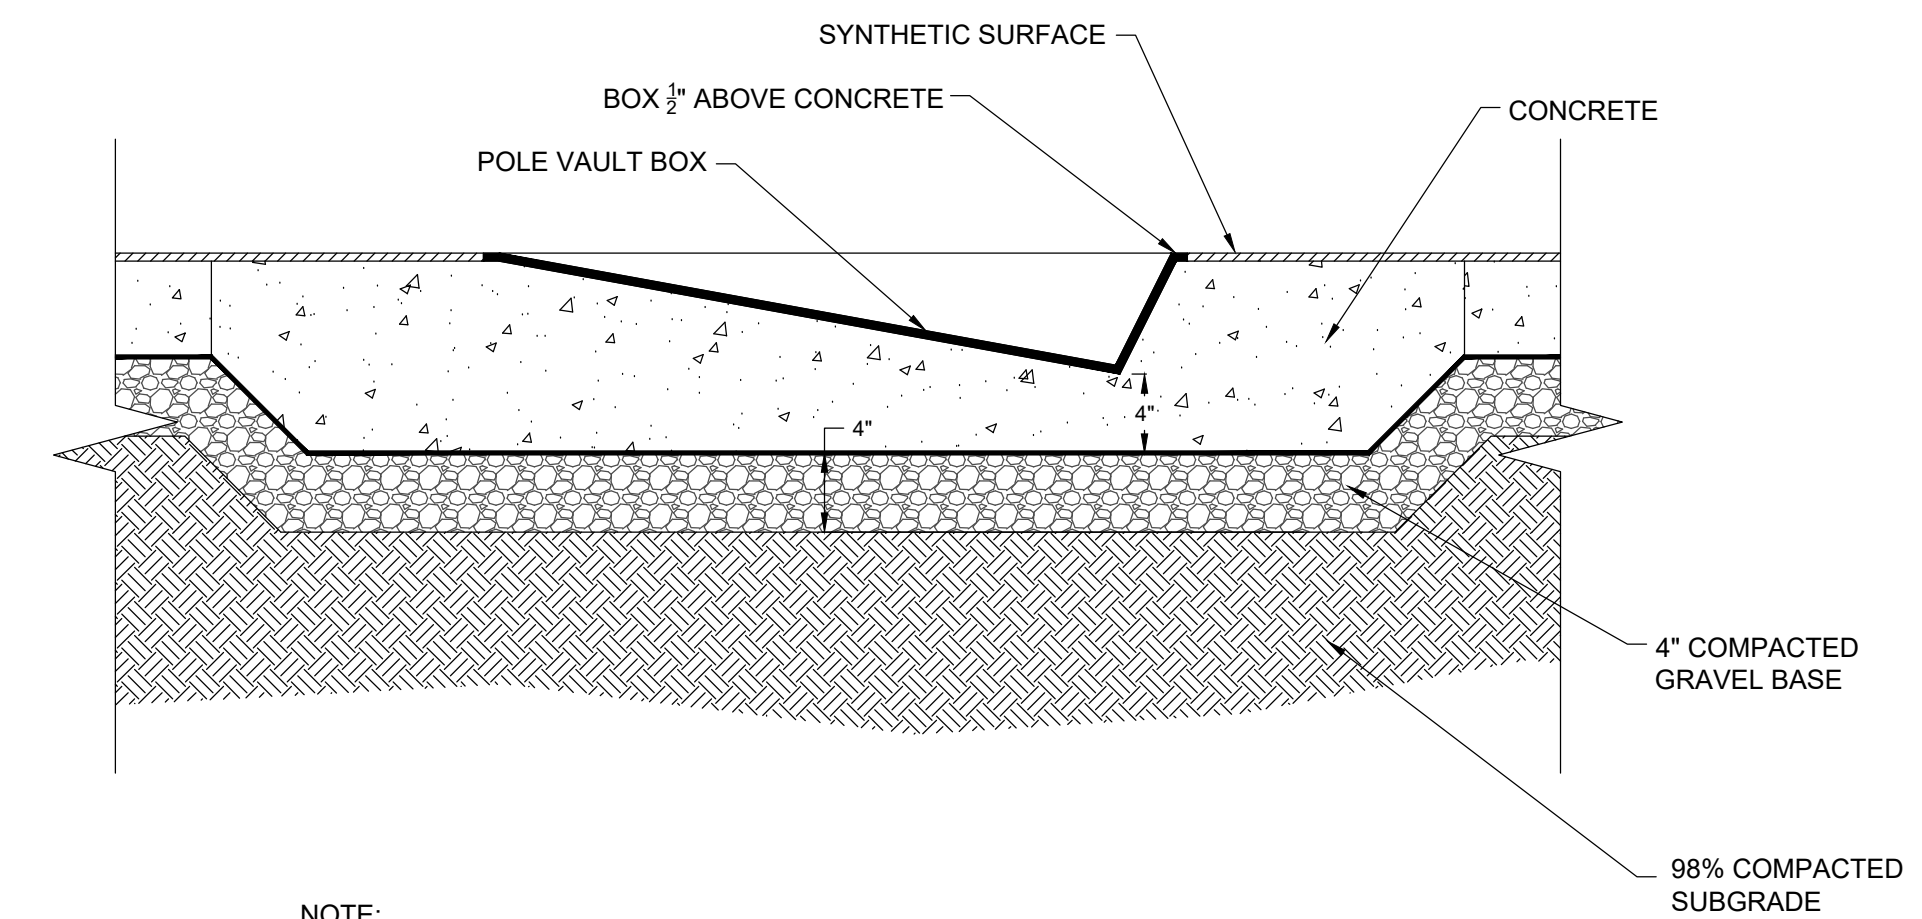

- NOTE:
 1. REFER TO SHOP DRAWINGS FOR INSTALLATION DIMENSIONS AND INSTRUCTIONS.
 2. POLE VAULT BOX EXTENDS ABOVE CONCRETE AND SYNTHETIC SURFACE IS FLUSH TO TOP OF BOX.
 3. ALL POLE VAULT BOXES TO RECEIVE POLYURETHANE PLUG.
 4. CONCRETE TO EXTENTS OF MANUFACTURES SPECIFICATIONS.

5 POLE VAULT BOX SECTION


NOT TO SCALE

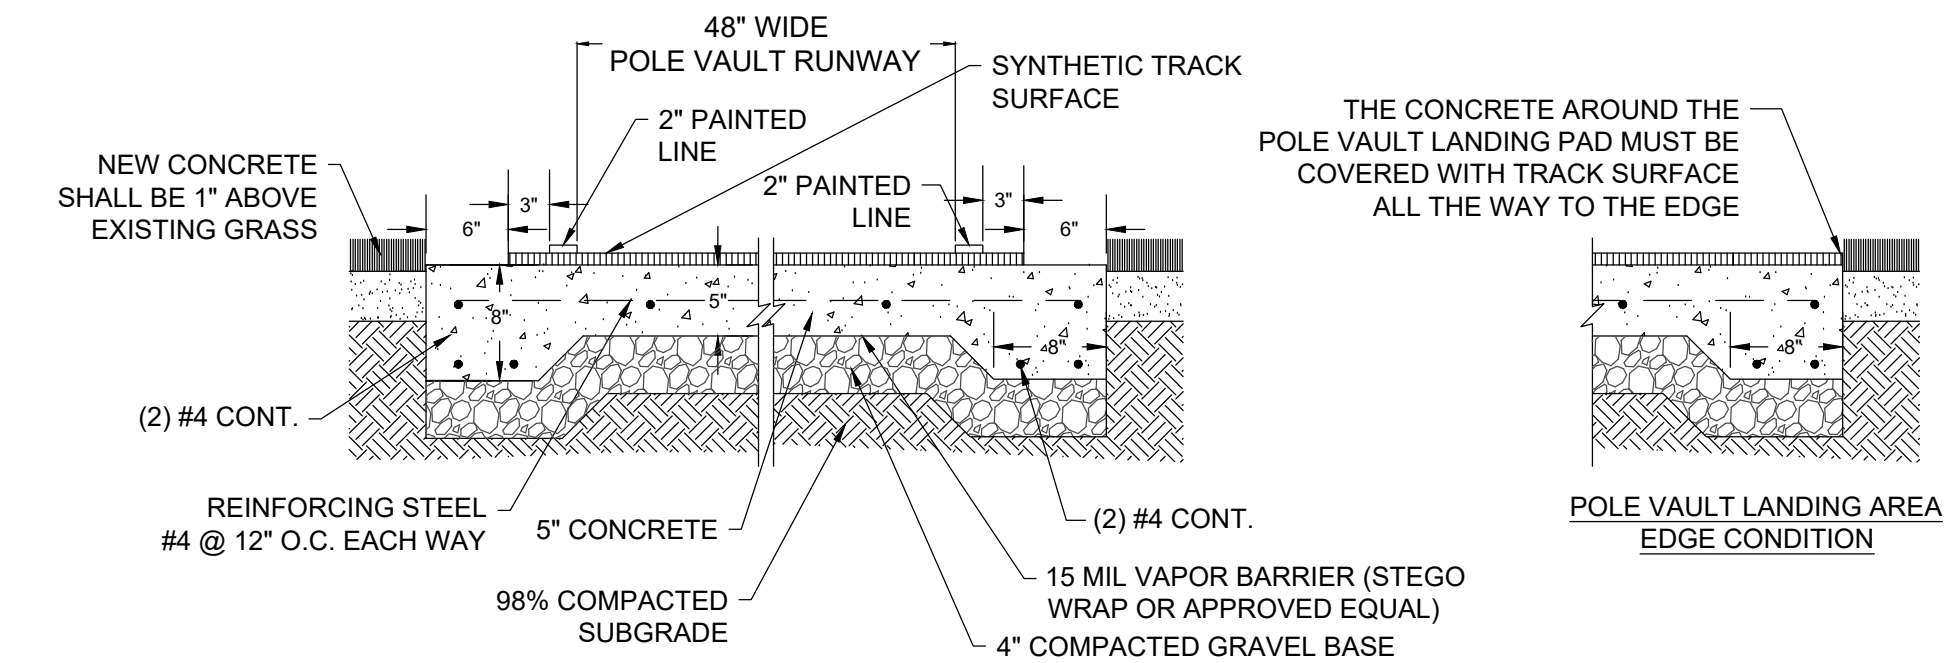

- NOTES:
 1. FOR ALL CONCRETE PADS AND RUNWAYS, CONTRACTOR TO PROVIDE CONTROL/EXPANSION JOINTS SHOP DRAWING PER MANUFACTURERS RECOMMENDATION/SPECIFICATION.
 2. ALL CONCRETE JOINT PLANS TO BE SUBMITTED AS SHOP DRAWINGS FOR REVIEW.
 3. NO FLY ASH IN CONCRETE.
 4. CONCRETE MIX TO BE DELEGATED BY MANUFACTURER TO ENSURE APPROVAL WITH THE SYNTHETIC TRACK SURFACING REQUIREMENTS SET FORTH BY THE TRACK MANUFACTURER. PLEASE SUBMIT MIX FOR REVIEW.

6 POLE VAULT RUNWAY SECTION

NOT TO SCALE

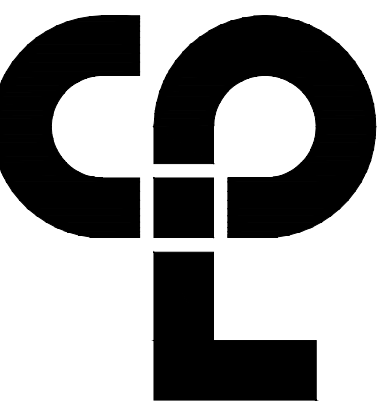

CPL | Architecture Engineering Planning
 1620 Hillsborough Street Suite A,
 Raleigh, NC 27605
 CPLteam.com



FITFIELDS

314 Tom Hall St.
 Fort Mill, SC 29715
 (T) 803.981.4330
 www.fitfields.com

PROJECT INFORMATION

Project Number
 R22.16900.00

Client Name
 WILSON COUNTY SCHOOLS

Project Name
 HUNT HS - ATHLETICS RENOVATION

HUNT HIGH SCHOOL

District Office Address
 4559 Lamm Rd., Wilson, NC 27893

PROJECT ISSUE & REVISION SCHEDULE

No. Issue Description



NEW YORK STATE EDUCATION STATEMENT

IT IS THE POLICY OF THE NEW YORK STATE EDUCATION LAW AND THE COMMISSIONER'S REGULATION FOR ANY PERSON, UNLESS ACTING UNDER THE DIRECTION OF A LICENSED ARCHITECT, ENGINEER OR LAND SURVEYOR, TO MAKE OR BE MADE BY ANY OTHER PERSON BEARING THE SEAL OF AN ARCHITECT, ENGINEER OR LAND SURVEYOR, THE ALTERING, FALSIFYING, OR THE SIGNING OF ANY DRAWING, SPECIFICATION, REPORT, OR OTHER DOCUMENT, WITHOUT THE SIGNATURE AND THE DATE OF SUCH ALTERATION, AND A PRECISE DESCRIPTION OF THE ALTERATION.

SHEET INFORMATION

Issued Scale

09.15.2023

Project Status

CONSTRUCTION DOCUMENTS

Drawn By Checked By


BG DD

Drawing Title


DETAILS

Drawing Number


10/09/2021 9:53:09 AM S:\Projects\Wilson_Cs\Track_Repl\Plan\2\DD\Design\06_CAD\Revit\Cenitral - Bldg_300.rvt

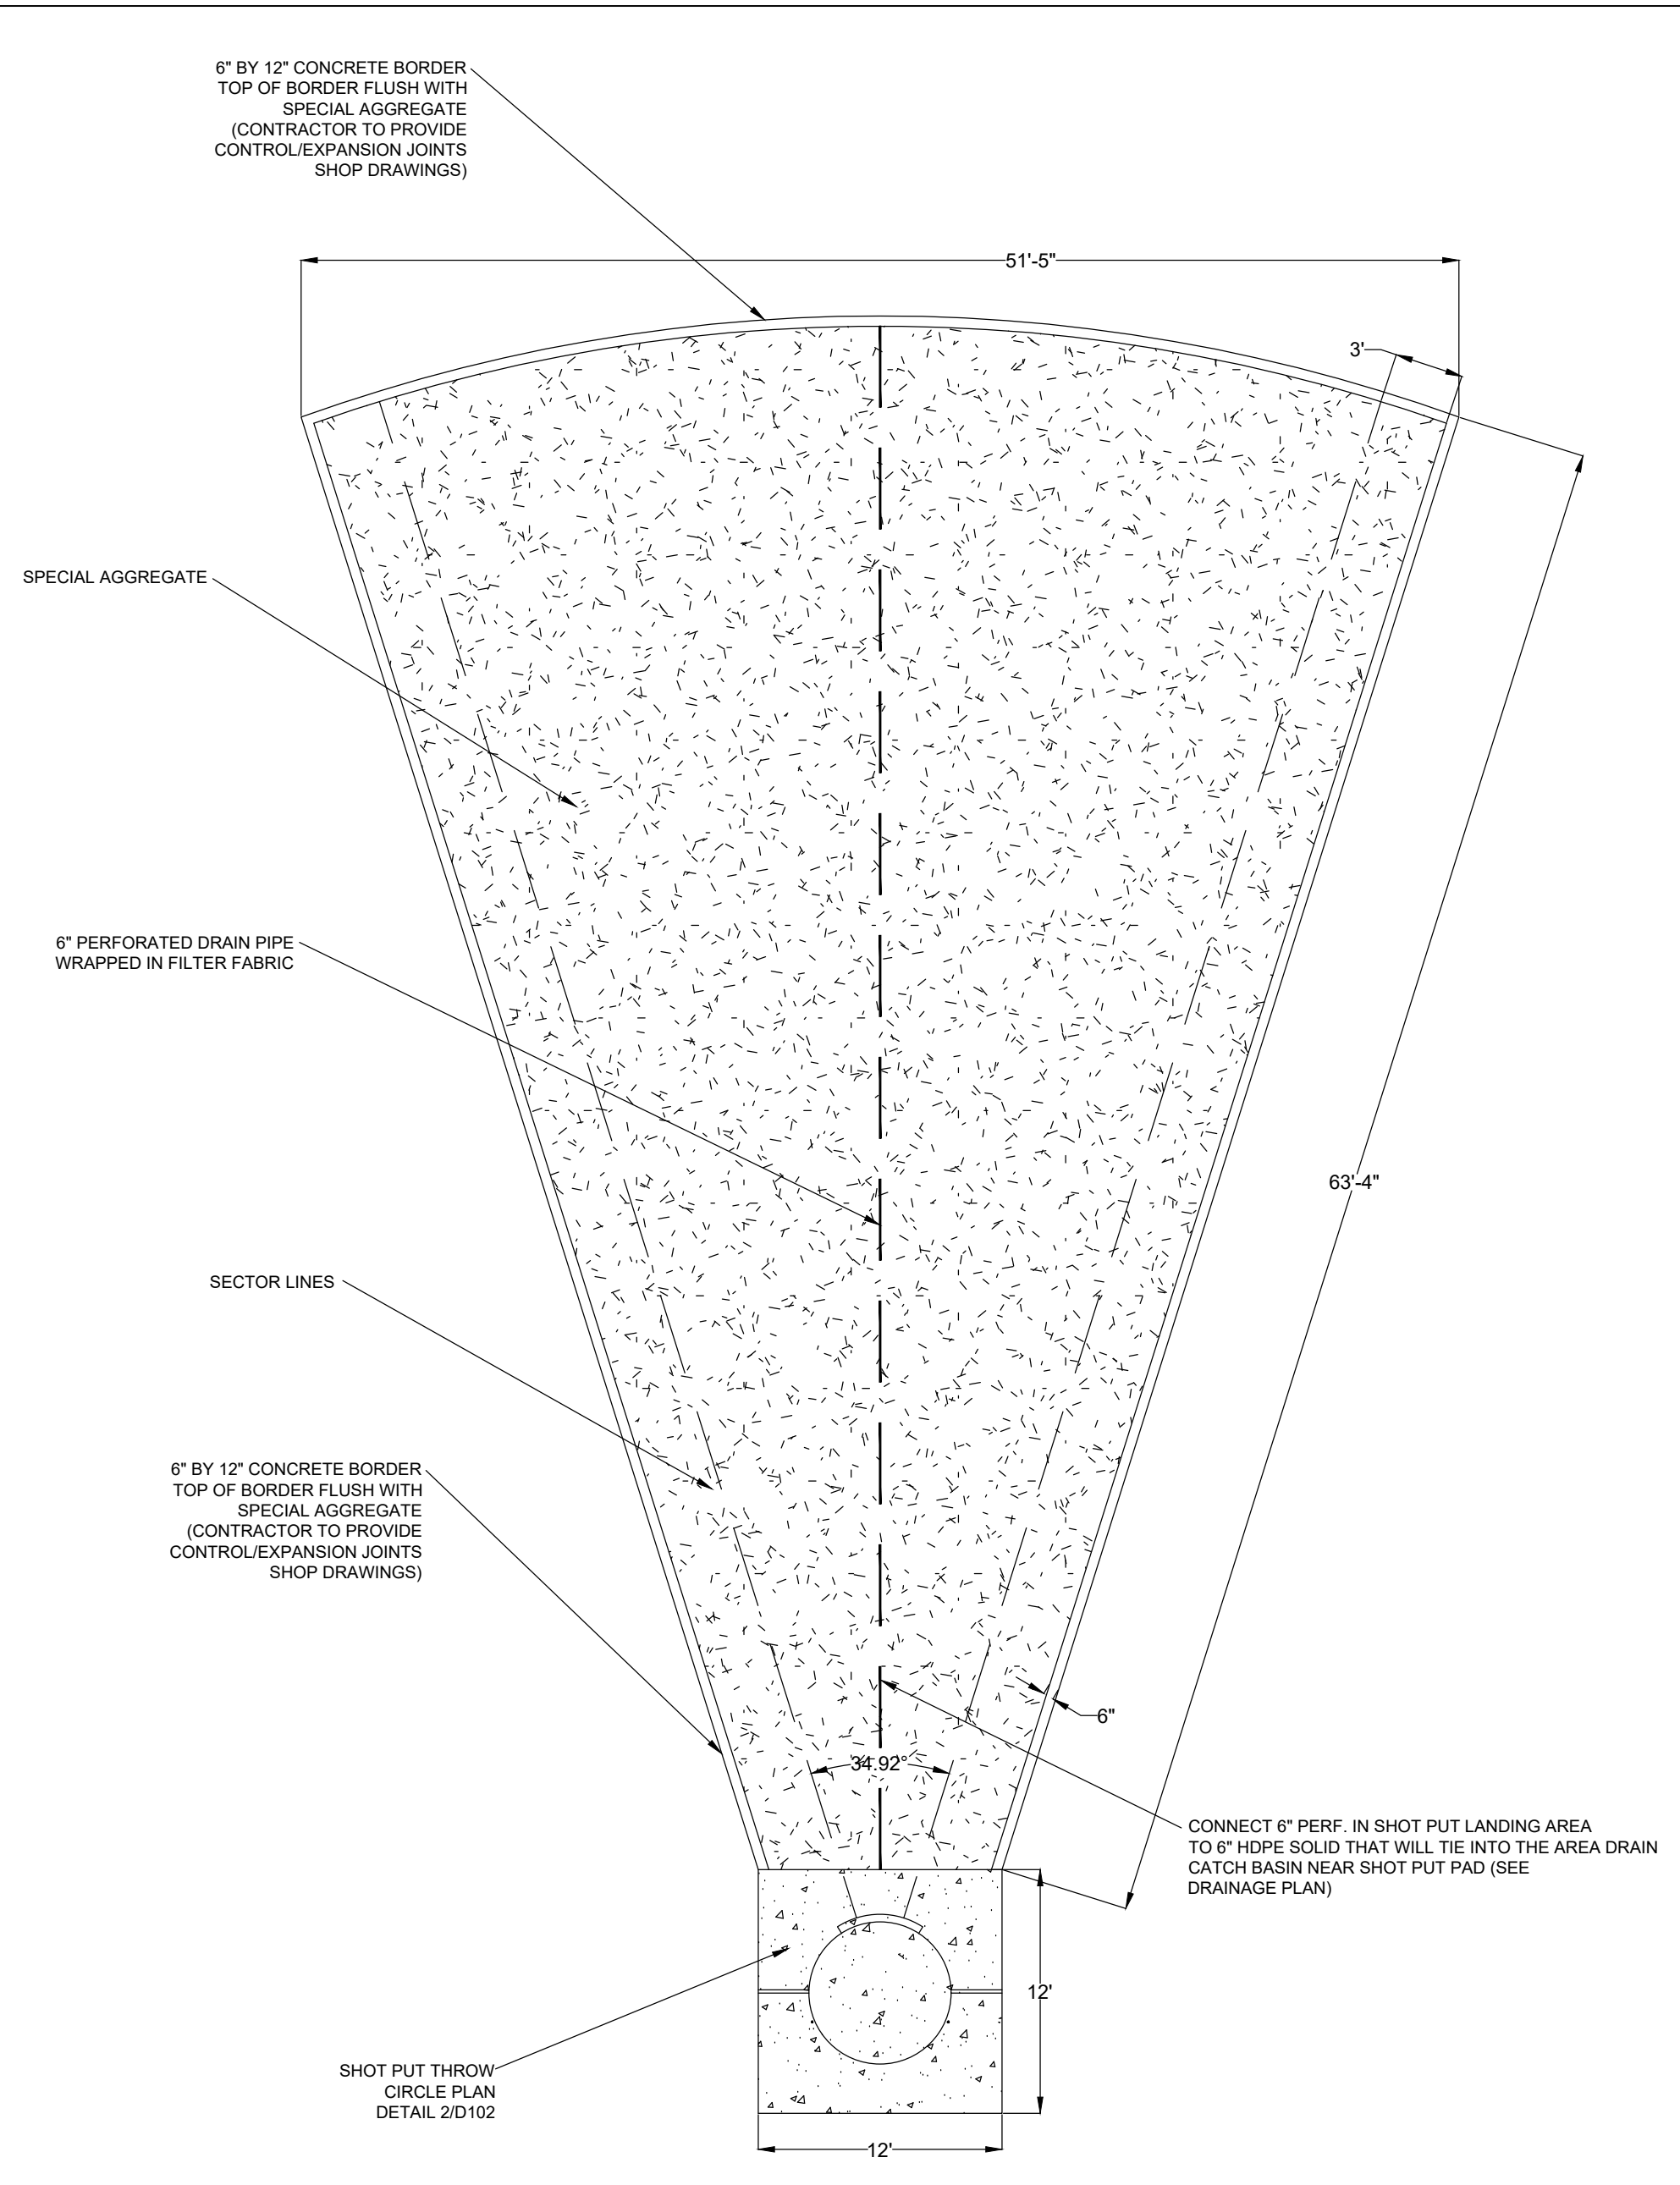


1 SHOT PUT PLAN
NOT TO SCALE

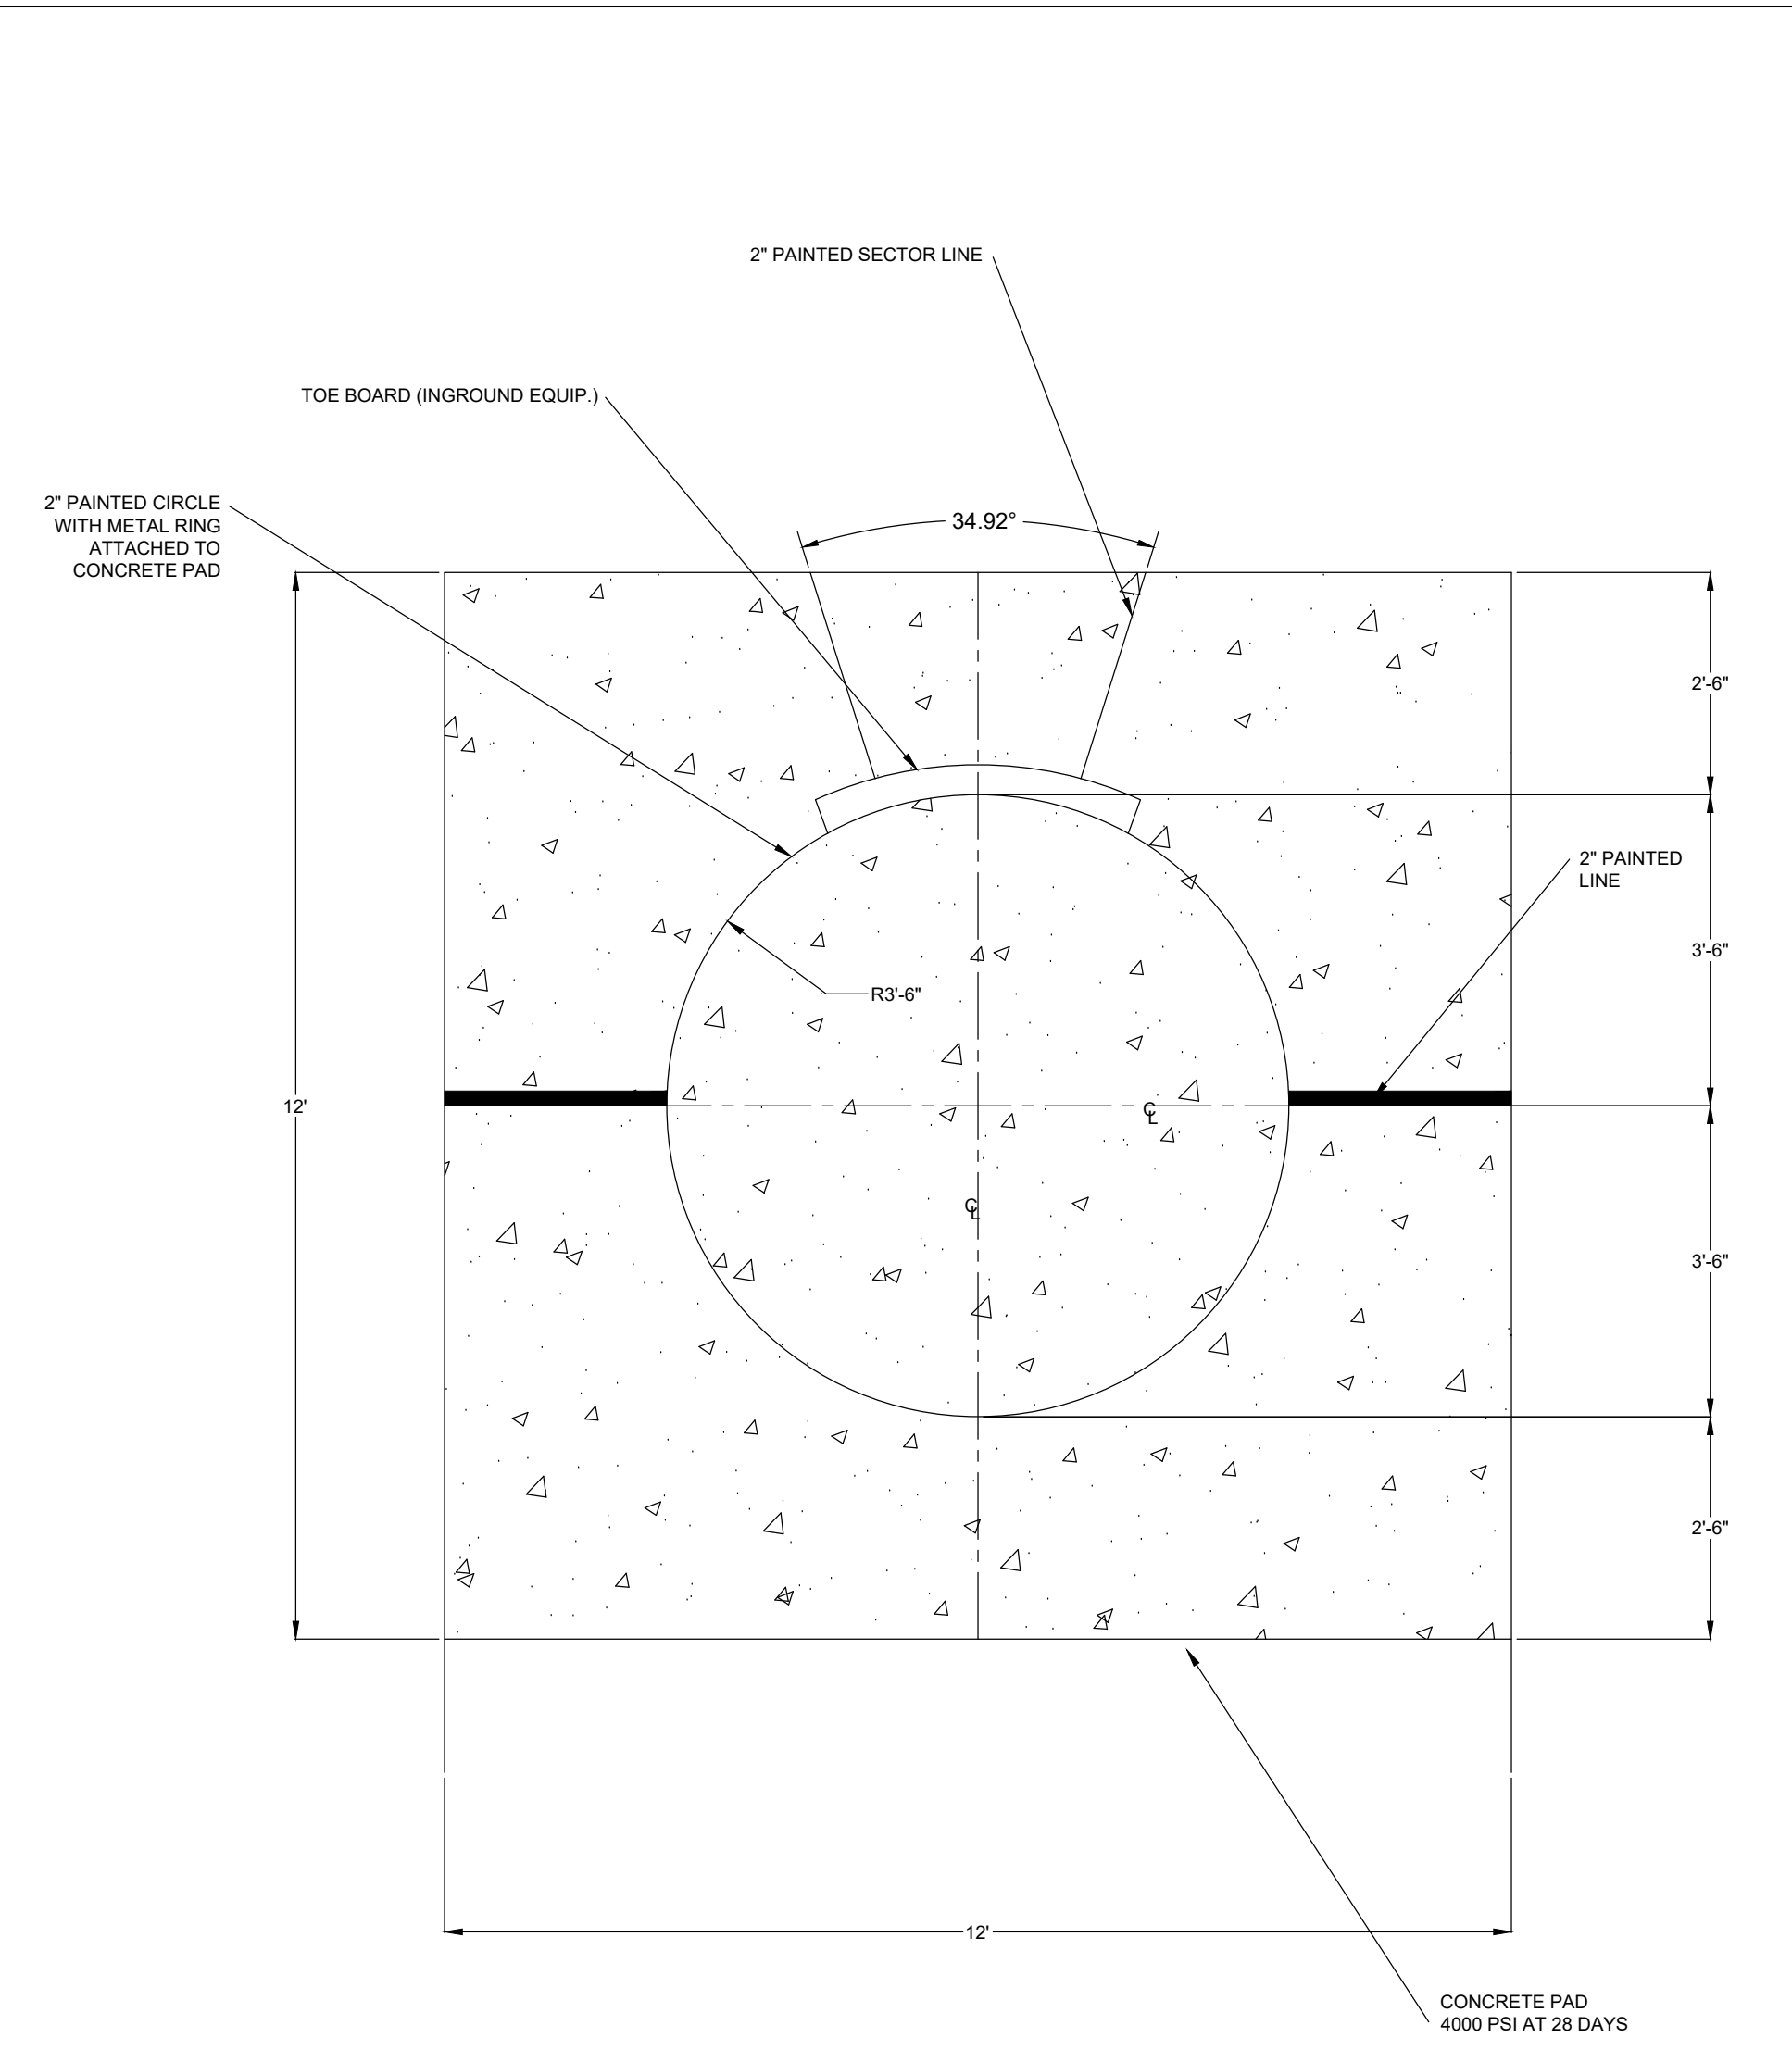


2 SHOT PUT THROW CIRCLE PLAN
NOT TO SCALE

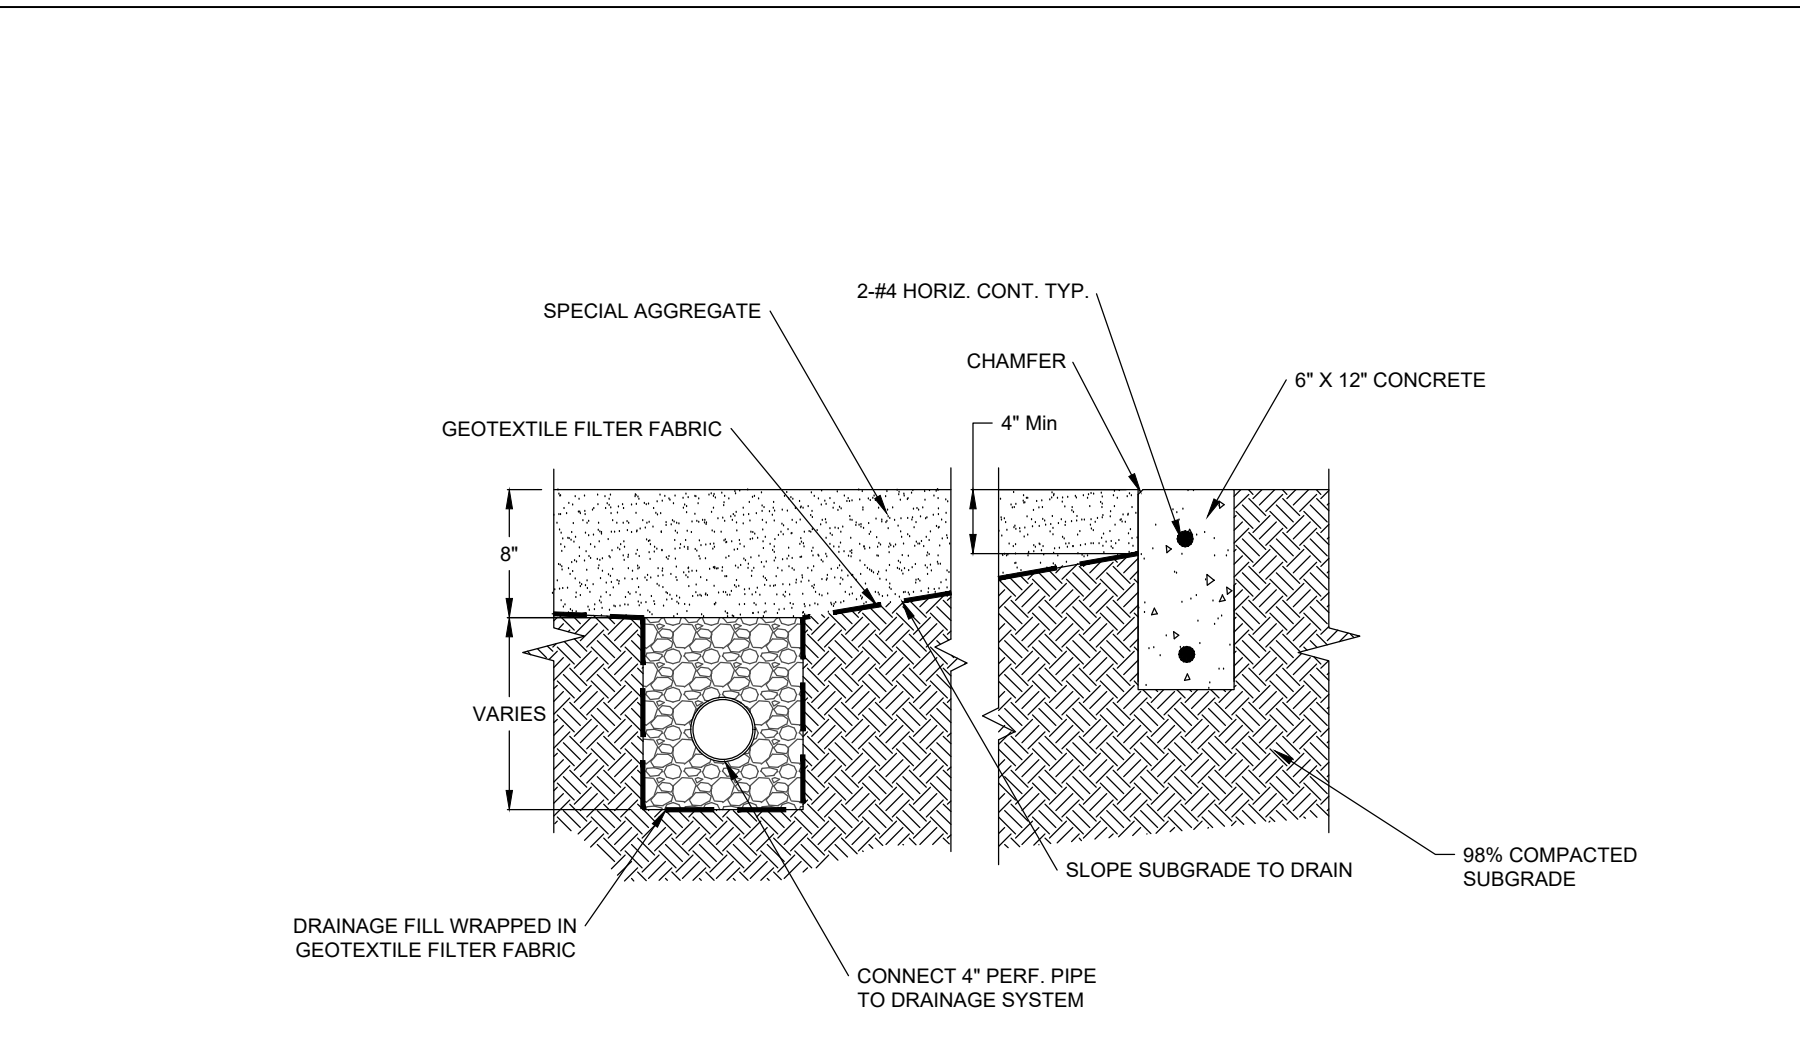


3 SHOT PUT SIDE SECTION
NOT TO SCALE

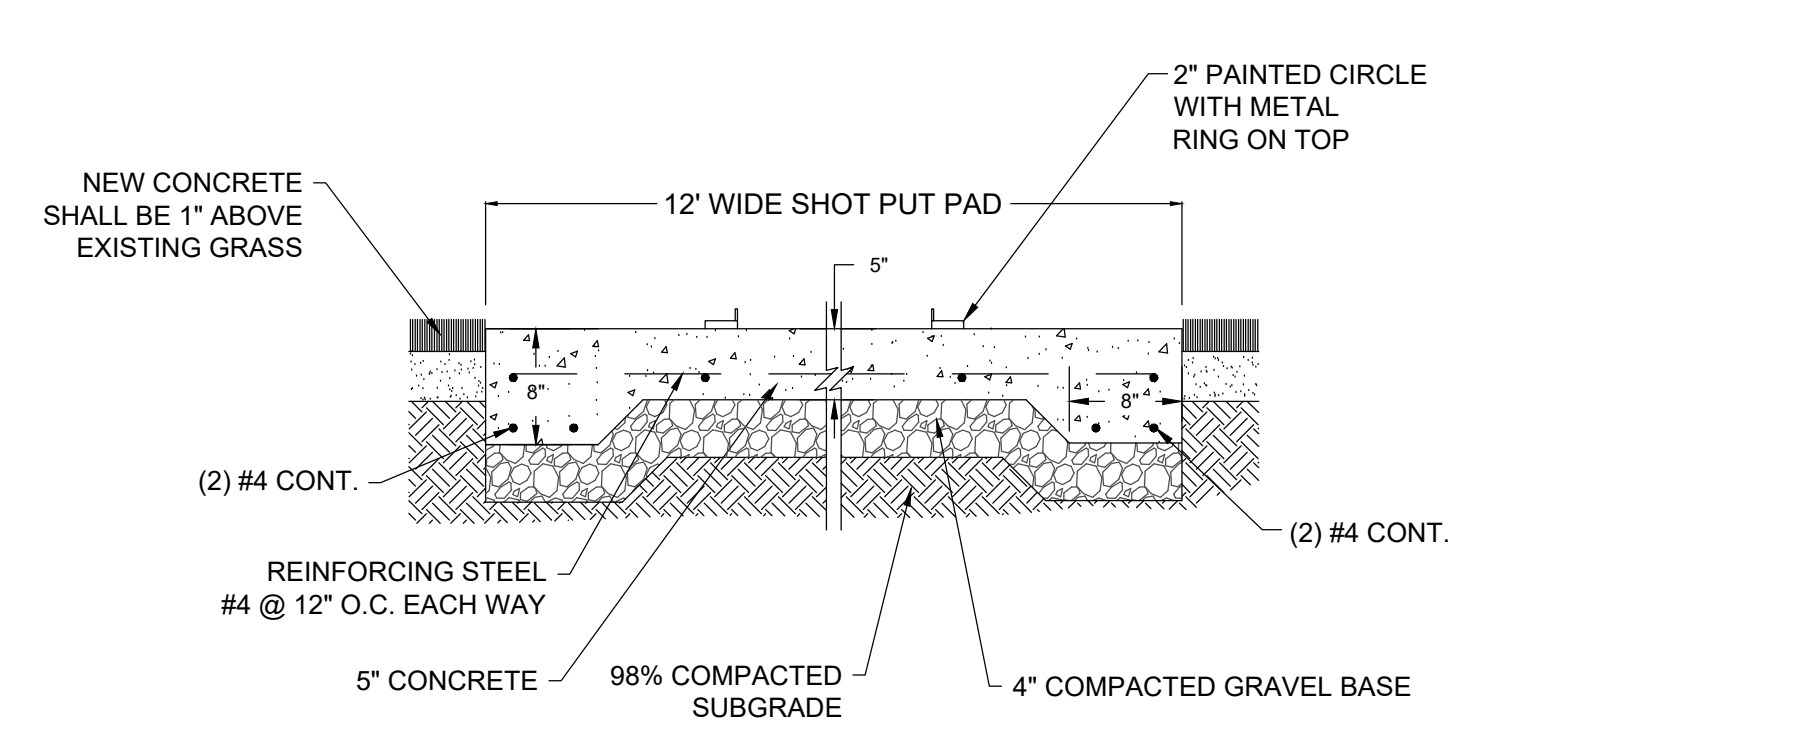


4 SHOT PUT THROW CIRCLE SECTION
NOT TO SCALE

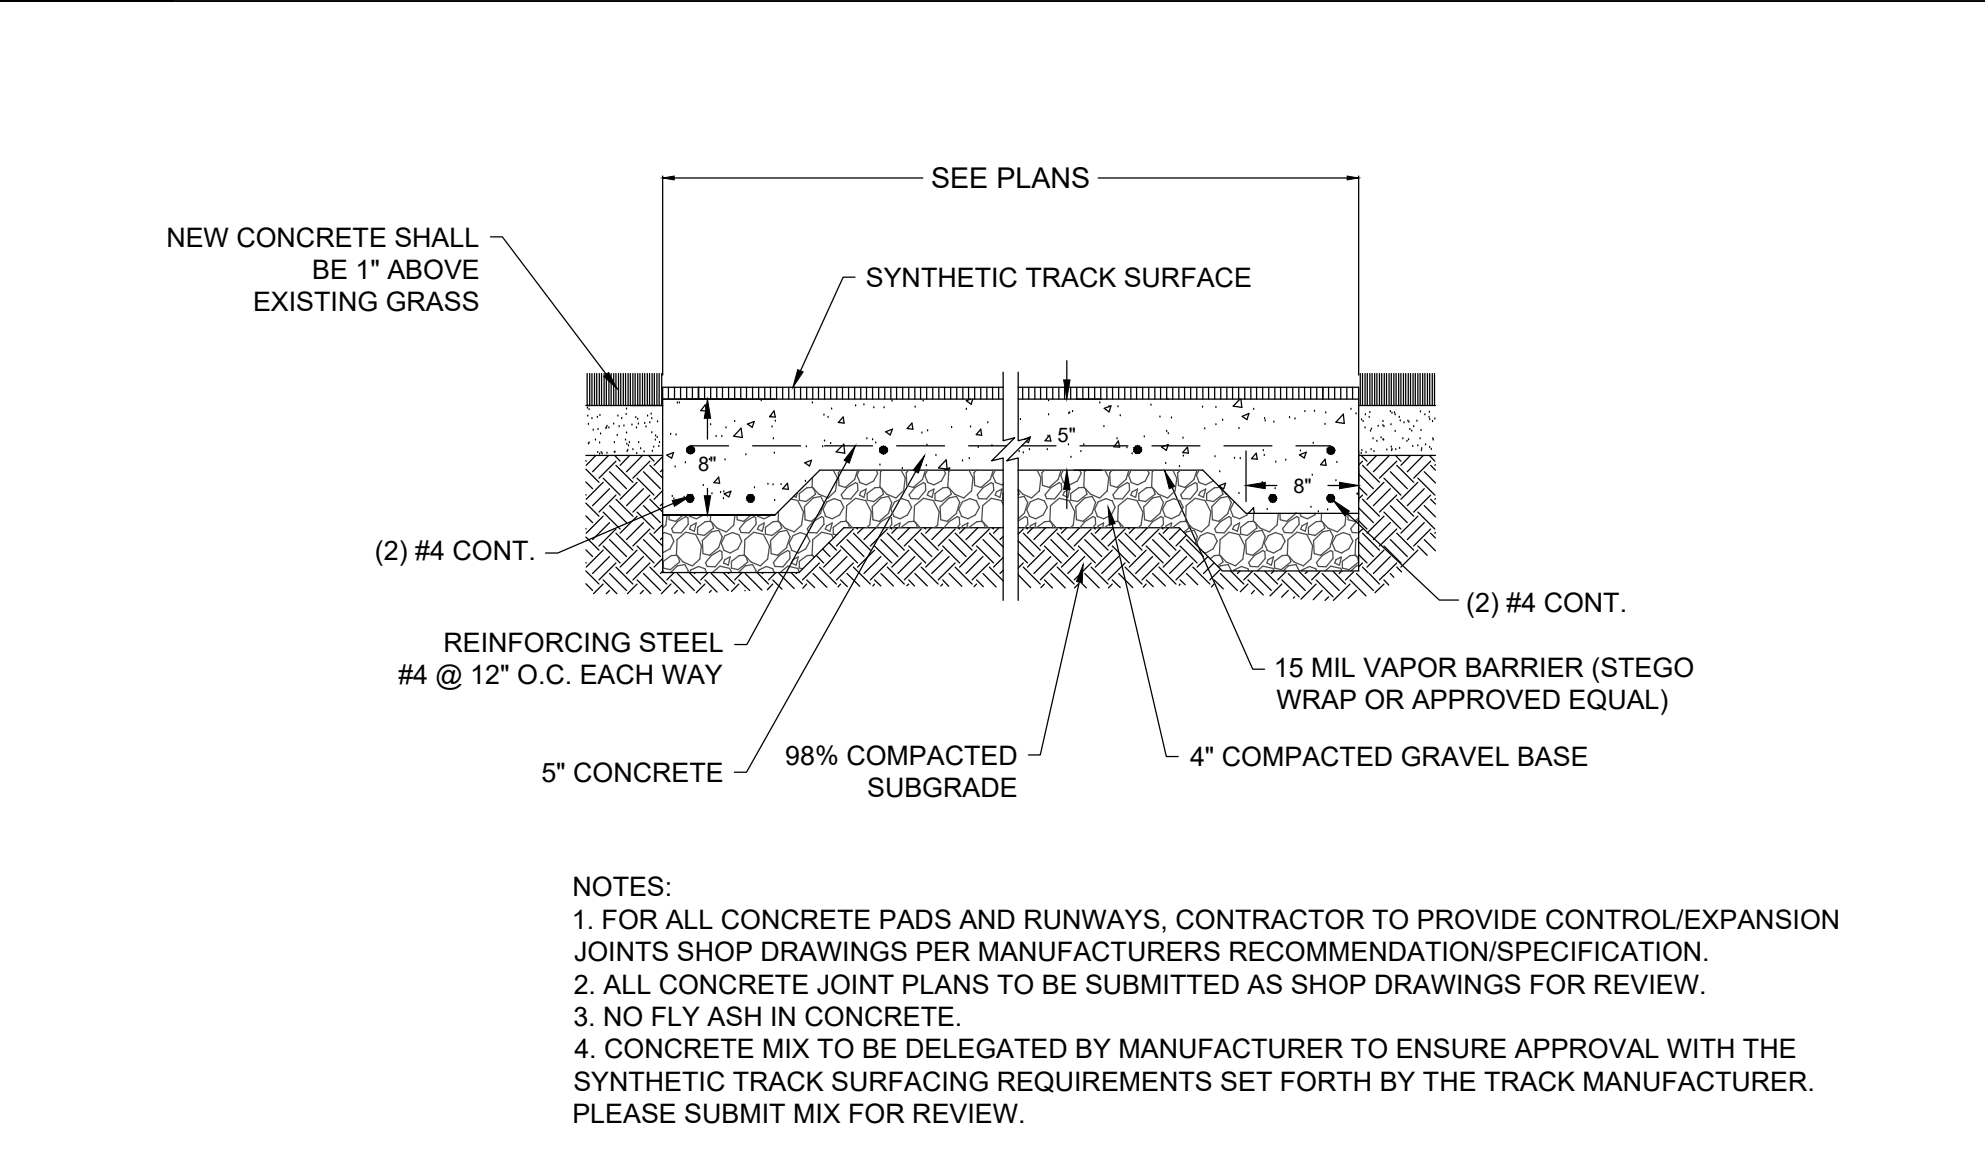

5 HIGH JUMP AREA SECTION
NOT TO SCALE

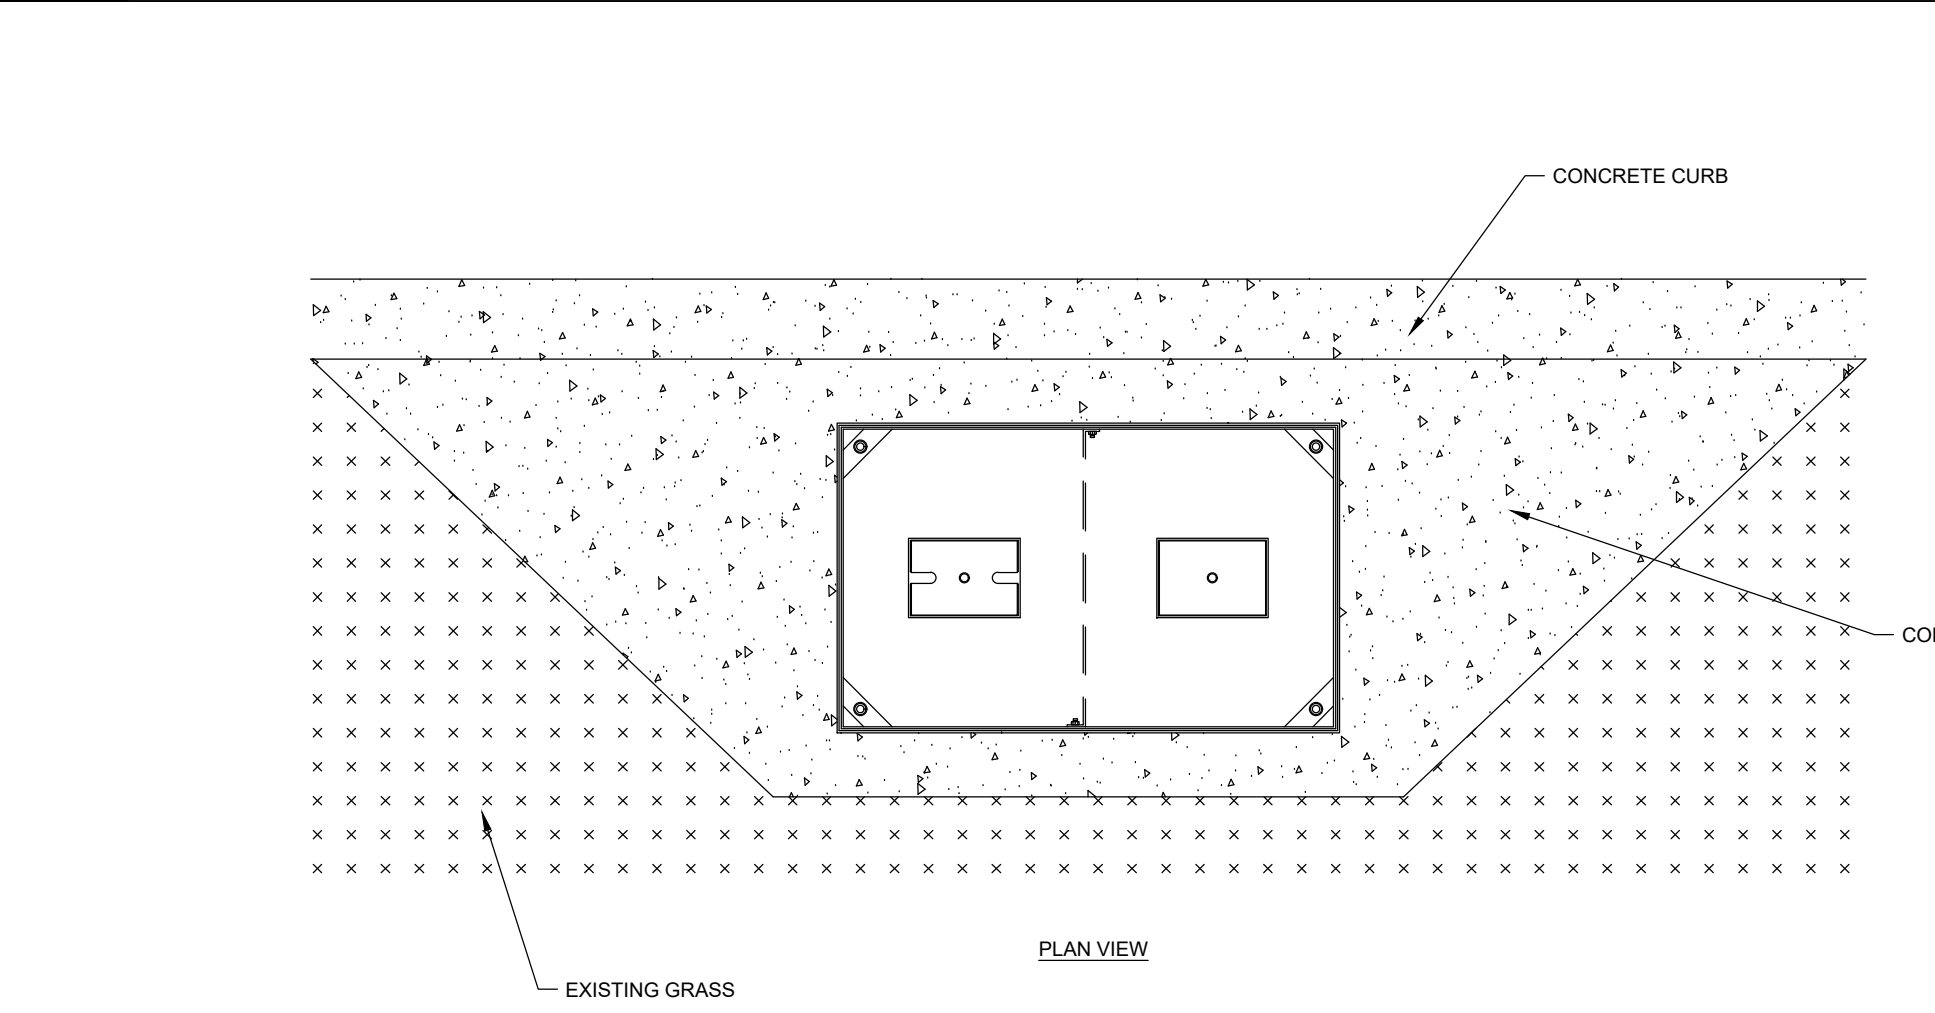


6 COMM. BOX
NOT TO SCALE

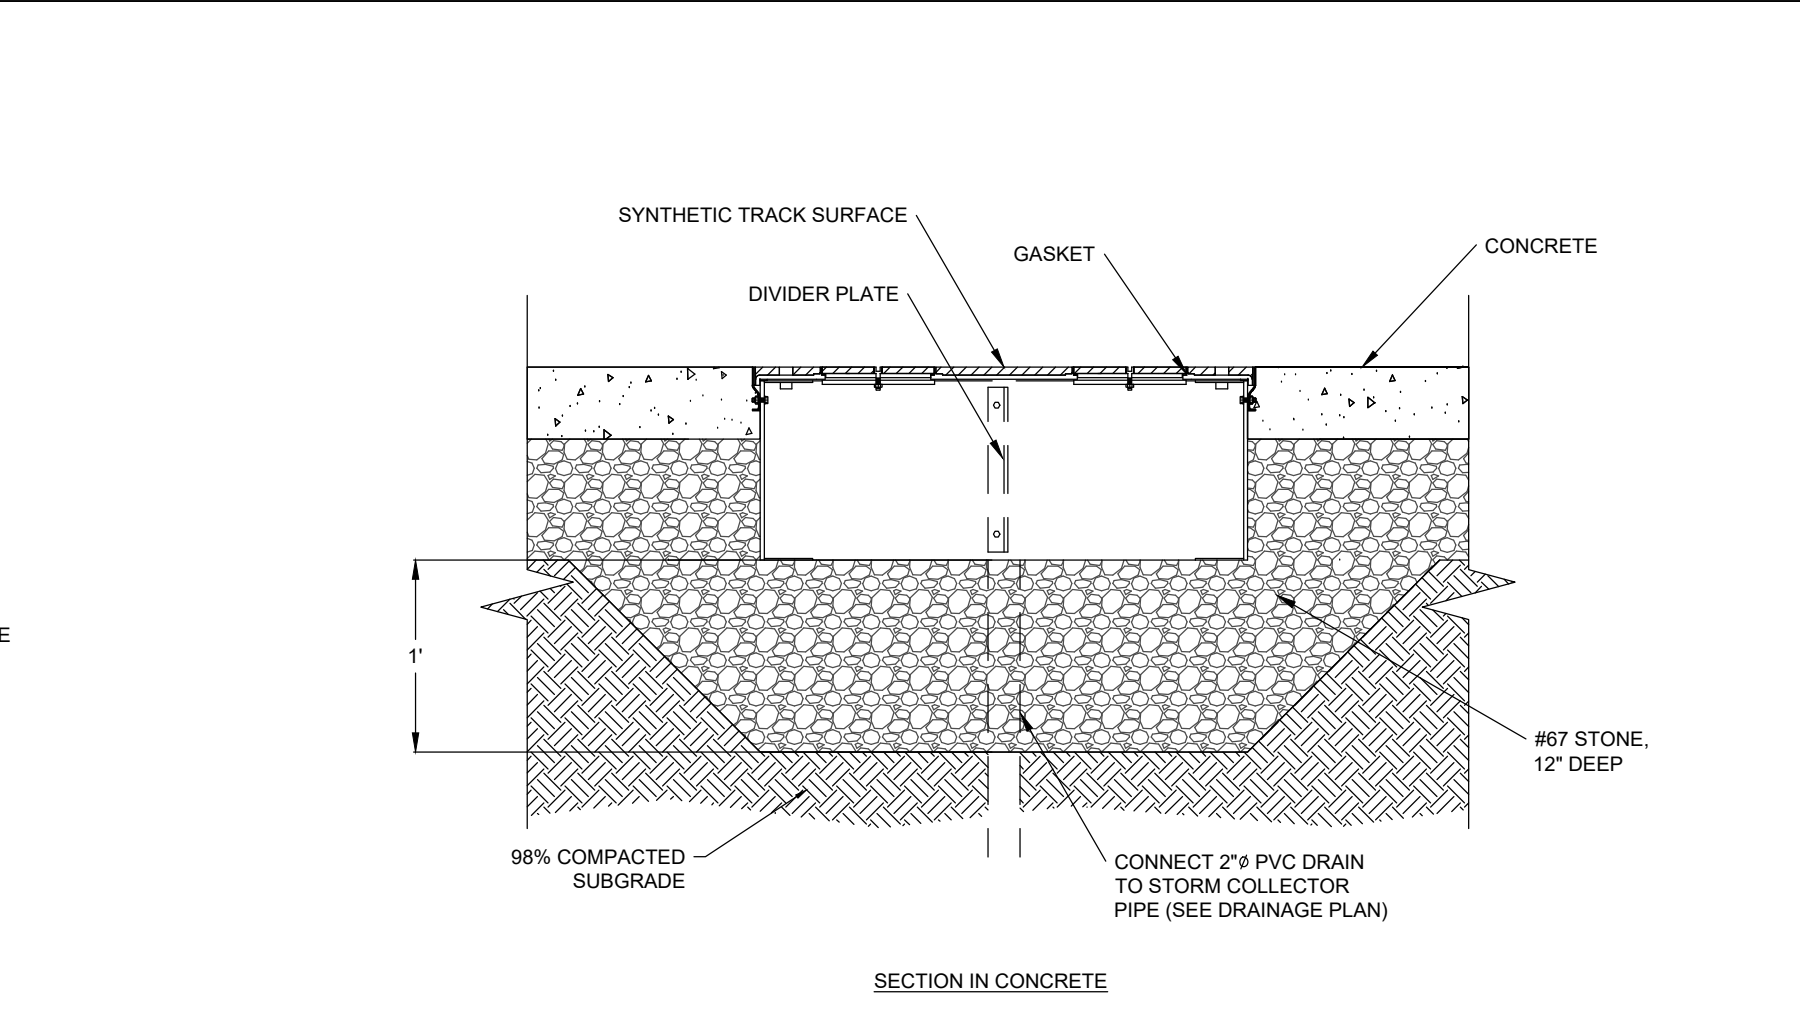


SECTION IN CONCRETE



10/09/2021 9:53:09 AM S:\Projects\Wilson\CS\Track\Repl\Pln\2\DD\Design\06_CAD\Rev\1\Centrifugal - Bldg_300.rvt

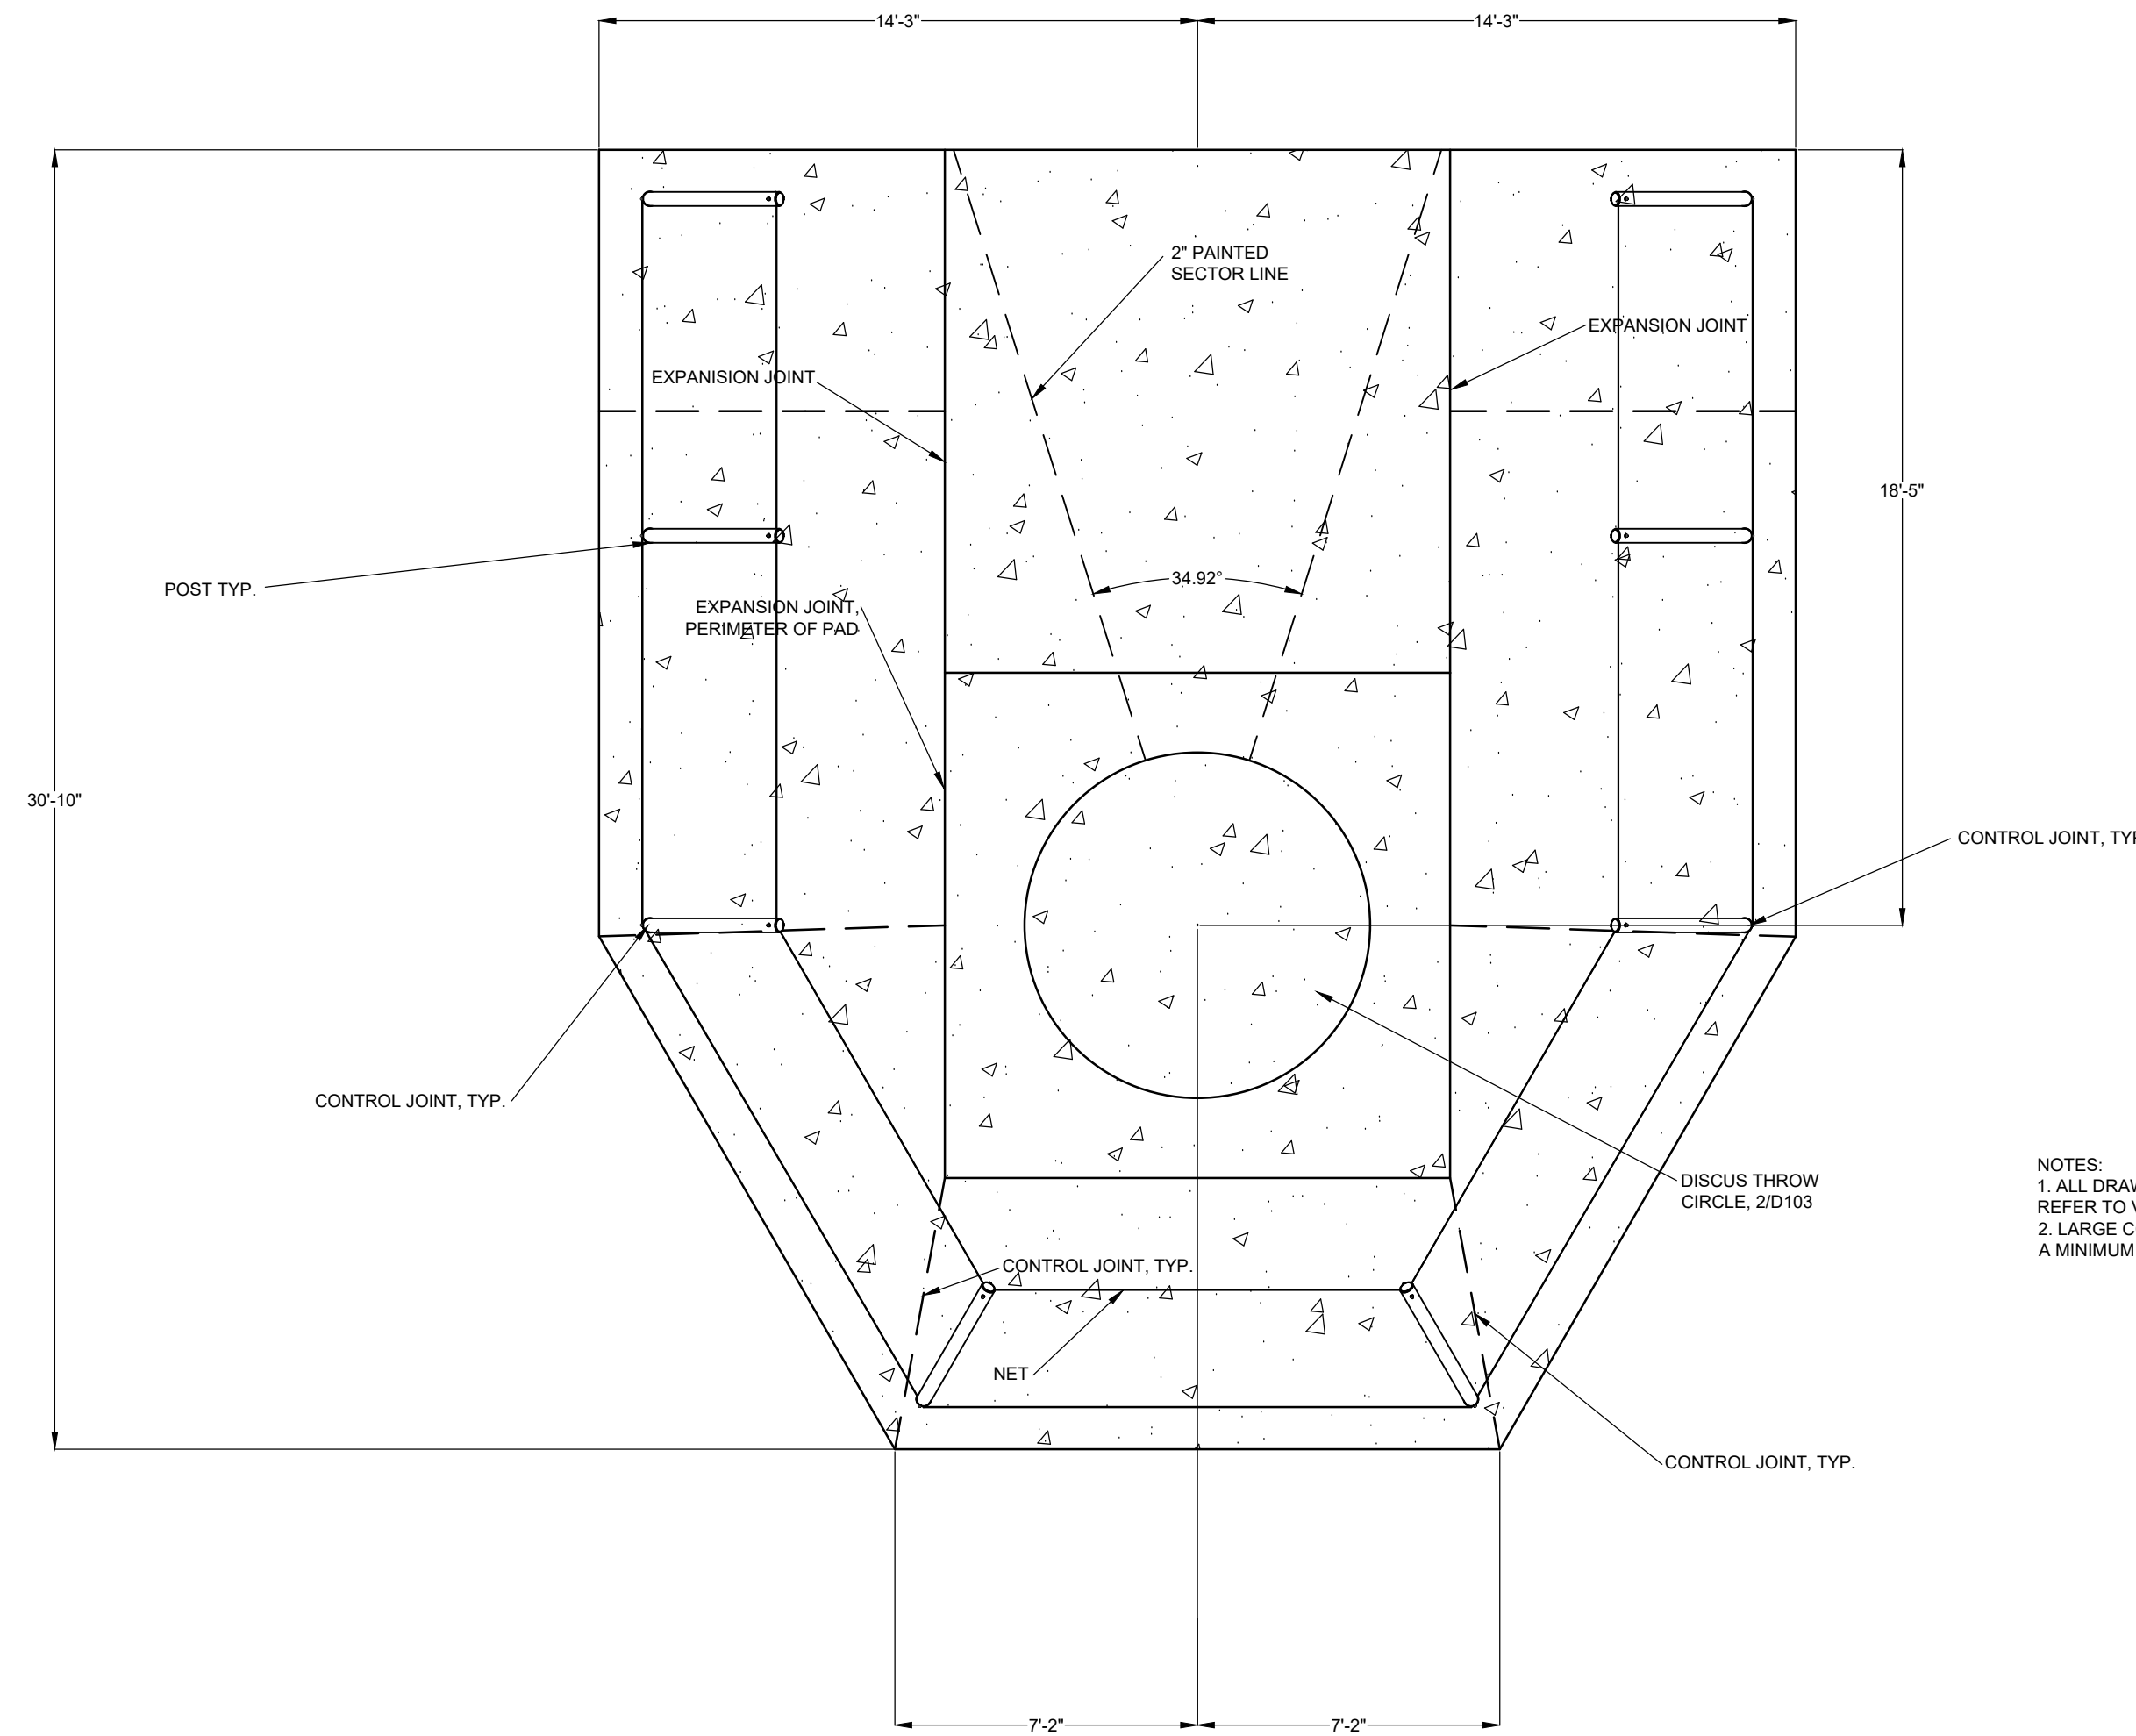


NOTES:
 1. ALL DRAWINGS DEPICTING IN-GROUND EQUIPMENT ARE FOR INFORMATION ONLY. REFER TO VENDOR DRAWINGS FOR INSTALLATION DIMENSIONS AND INSTRUCTIONS.
 2. LARGE CONCRETE PAD IS TO BE SIZED AS PER THE VENDOR CAGE DIMENSIONS. A MINIMUM OF 12" OF CONCRETE OUTSIDE OF ALL POSTS TO PREVENT CRACKING.

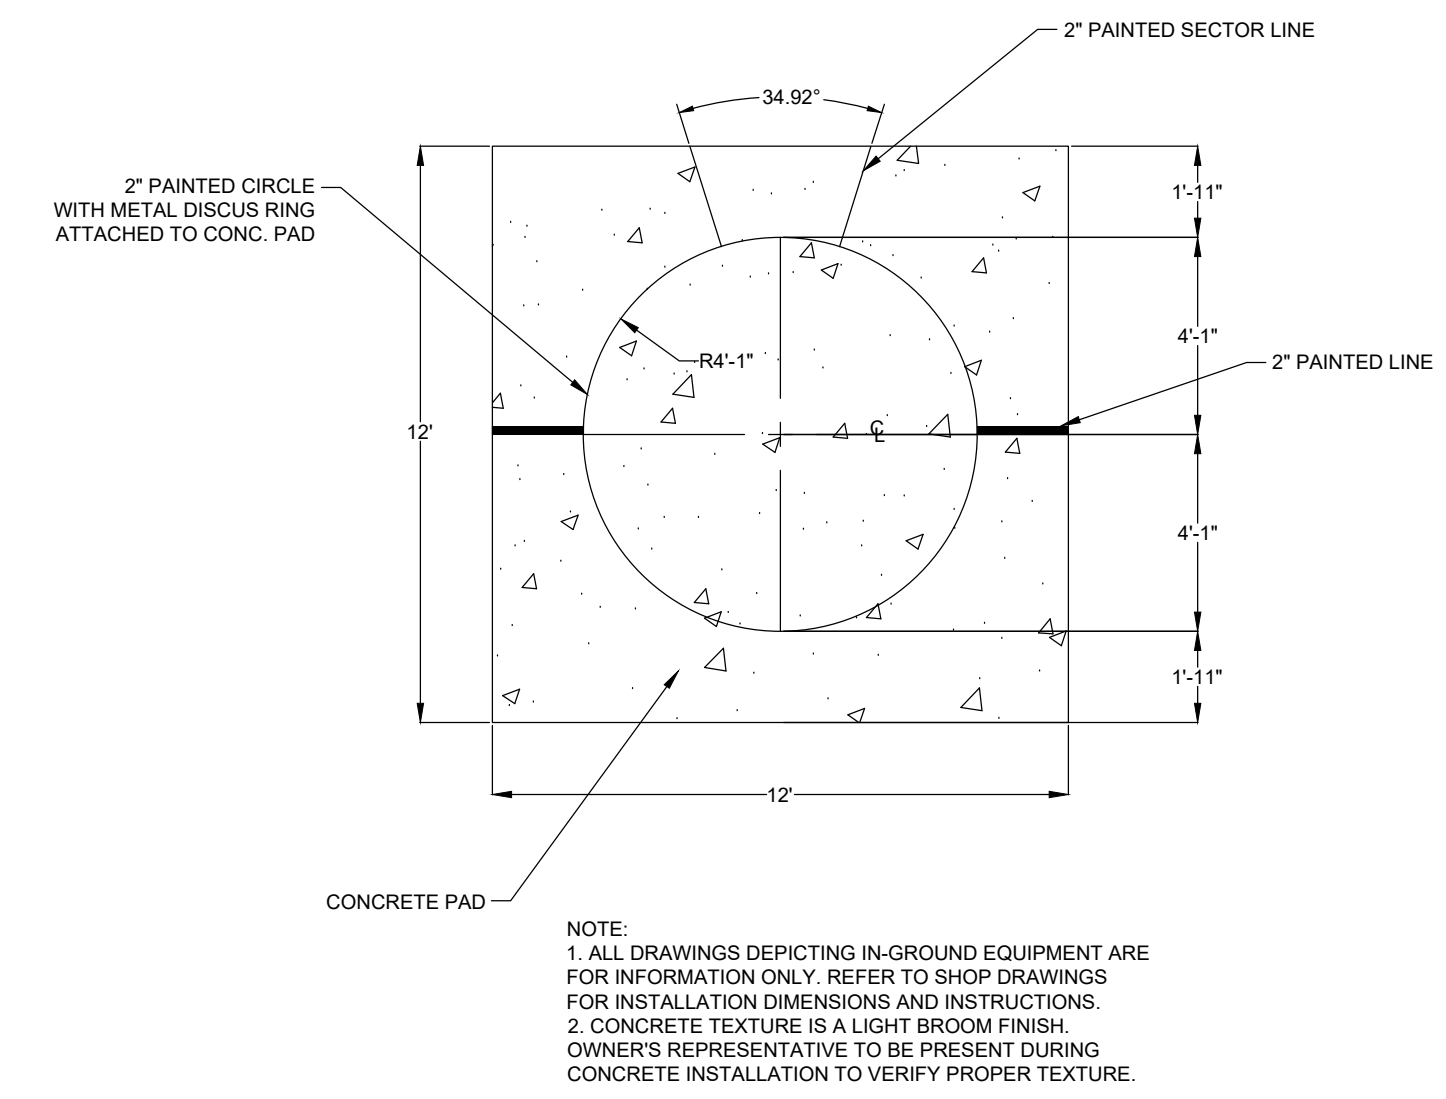

NOTE:
 1. ALL DRAWINGS DEPICTING IN-GROUND EQUIPMENT ARE FOR INFORMATION ONLY. REFER TO SHOP DRAWINGS FOR INSTALLATION DIMENSIONS AND INSTRUCTIONS.
 2. CONCRETE TEXTURE IS A LIGHT BROOM FINISH. OWNER'S REPRESENTATIVE TO BE PRESENT DURING CONCRETE INSTALLATION TO VERIFY PROPER TEXTURE.


2 DISCUS THROW CIRCLE PLAN
 NOT TO SCALE

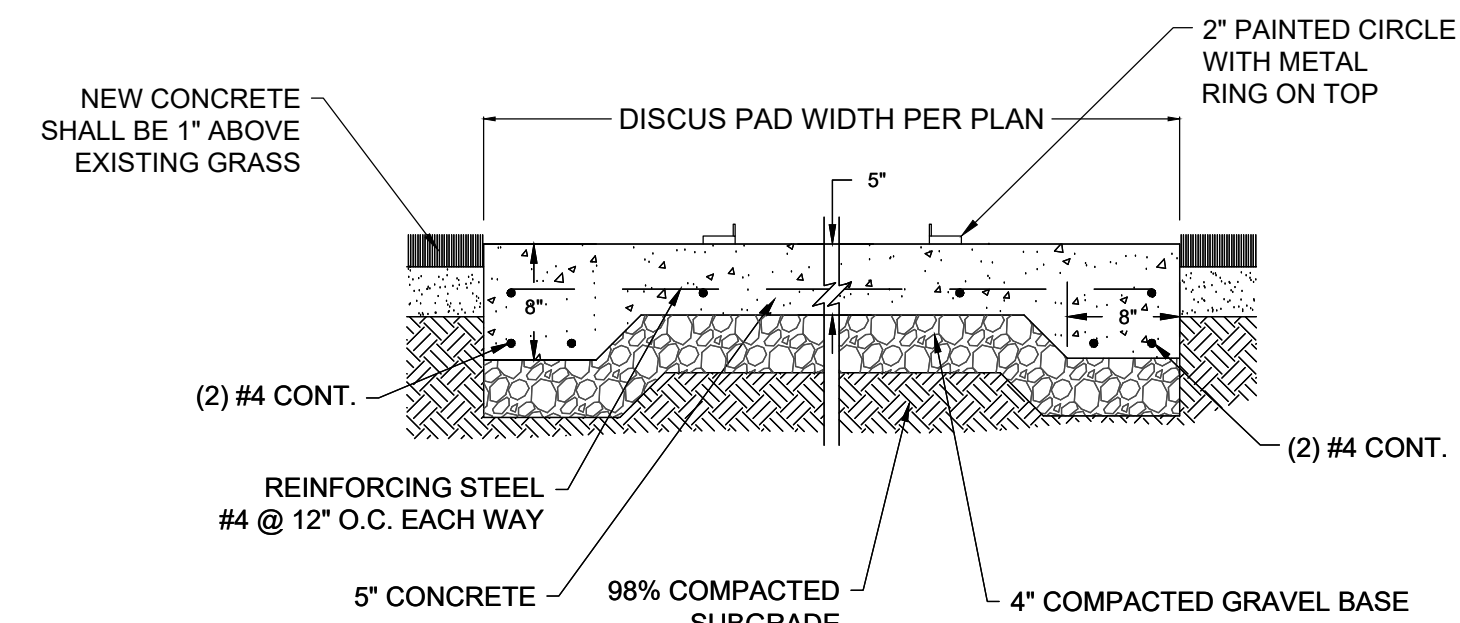

NOTES:
 1. FOR ALL CONCRETE PADS AND RUNWAYS, CONTRACTOR TO PROVIDE CONTROL/EXPANSION JOINTS SHOP DRAWINGS PER MANUFACTURERS RECOMMENDATION/SPECIFICATION.
 2. ALL CONCRETE JOINT PLANS TO BE SUBMITTED AS SHOP DRAWINGS FOR REVIEW.
 3. NO FLY ASH IN CONCRETE.


3 DISCUS THROW CIRCLE CONCRETE PAD
 NOT TO SCALE

1 DISCUS CAGE PLAN
 NOT TO SCALE

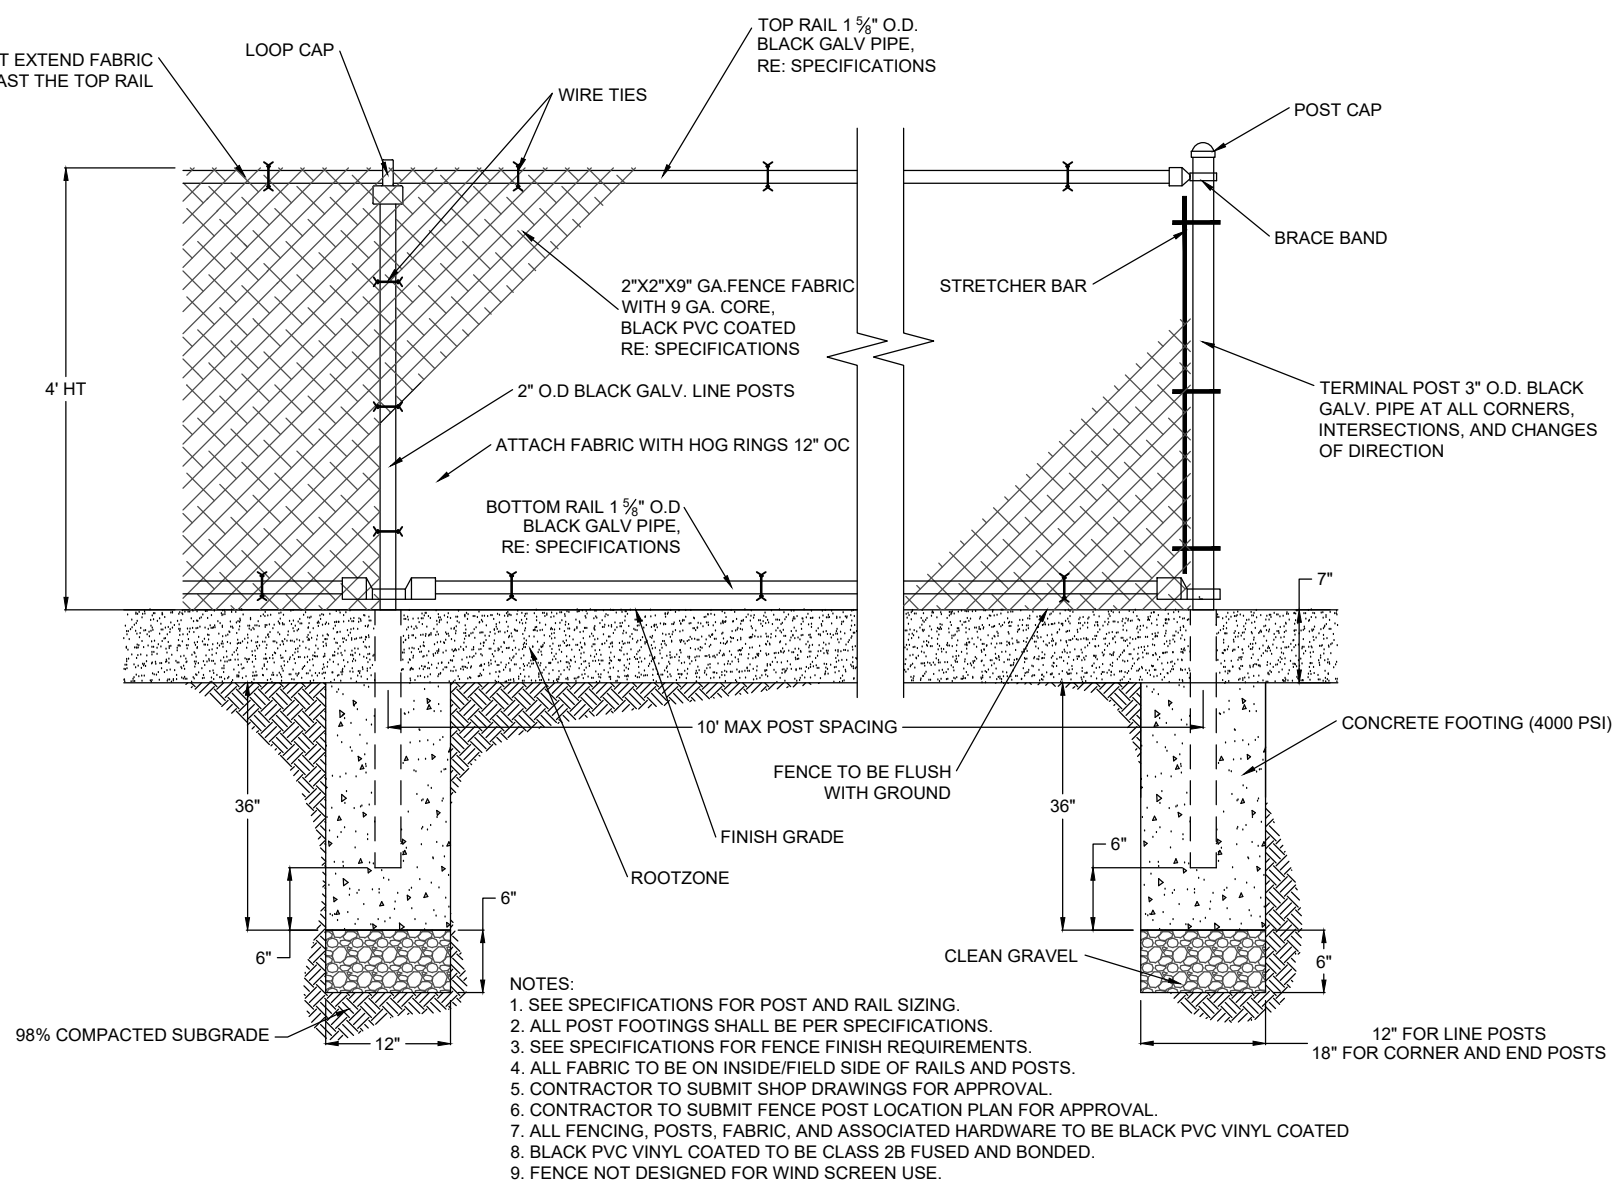


NOTES:
 1. SEE SPECIFICATIONS FOR POST AND RAIL SIZING.
 2. ALL POST FOOTINGS SHALL BE PER SPECIFICATIONS.
 3. SEE SPECIFICATIONS FOR FENCE FINISH REQUIREMENTS.
 4. ALL FABRIC TO BE ON INSIDE/FIELD SIDE OF RAILS AND POSTS.
 5. CONTRACTOR TO SUBMIT SHOP DRAWINGS FOR APPROVAL.
 6. CONTRACTOR TO SUBMIT FENCE POST LOCATION PLAN FOR APPROVAL.
 7. ALL FENCING POSTS, FABRIC, AND ASSOCIATED HARDWARE TO BE BLACK PVC VINYL COATED.
 8. BLACK PVC VINYL COATED TO BE CLASS 2B FUSED AND BONDED.
 9. FENCE NOT DESIGNED FOR WIND SCREEN USE.

4 CHAIN LINK FENCE (4' HT)
 NOT TO SCALE

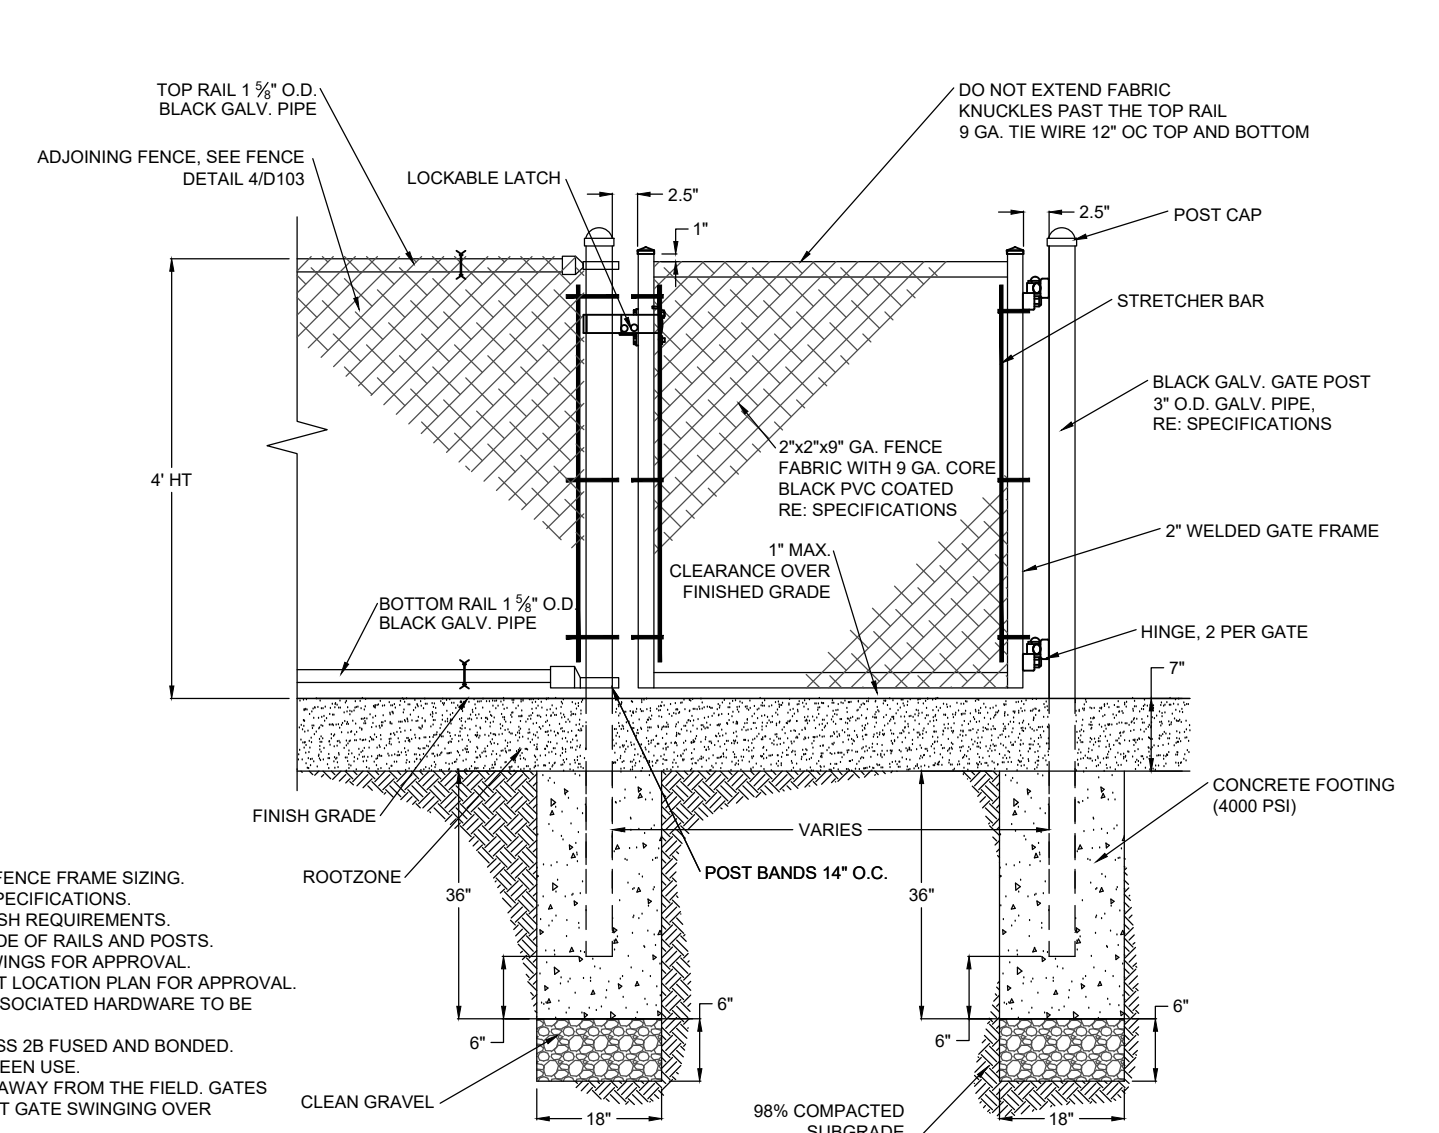

NOTES:
 1. SEE SPECIFICATIONS FOR POST AND FENCE FRAME SIZING.
 2. ALL POST FOOTINGS SHALL BE PER SPECIFICATIONS.
 3. SEE SPECIFICATIONS FOR FENCE FINISH REQUIREMENTS.
 4. ALL FABRIC TO BE ON INSIDE/FIELD SIDE OF RAILS AND POSTS.
 5. CONTRACTOR TO SUBMIT SHOP DRAWINGS FOR APPROVAL.
 6. CONTRACTOR TO SUBMIT FENCE POST LOCATION PLAN FOR APPROVAL.
 7. ALL FENCING POSTS, FABRIC, AND ASSOCIATED HARDWARE TO BE BLACK PVC VINYL COATED.
 8. BLACK PVC VINYL COATED TO BE CLASS 2B FUSED AND BONDED.
 9. FENCE NOT DESIGNED FOR WIND SCREEN USE.
 10. ALL GATES SHALL OPEN OUTWARDS AWAY FROM THE FIELD. GATES TO HAVE WELDED STOPS TO PREVENT GATE SWINGING OVER TRACK SURFACE.


5 CHAIN LINK SINGLE GATE (4' HT)
 NOT TO SCALE

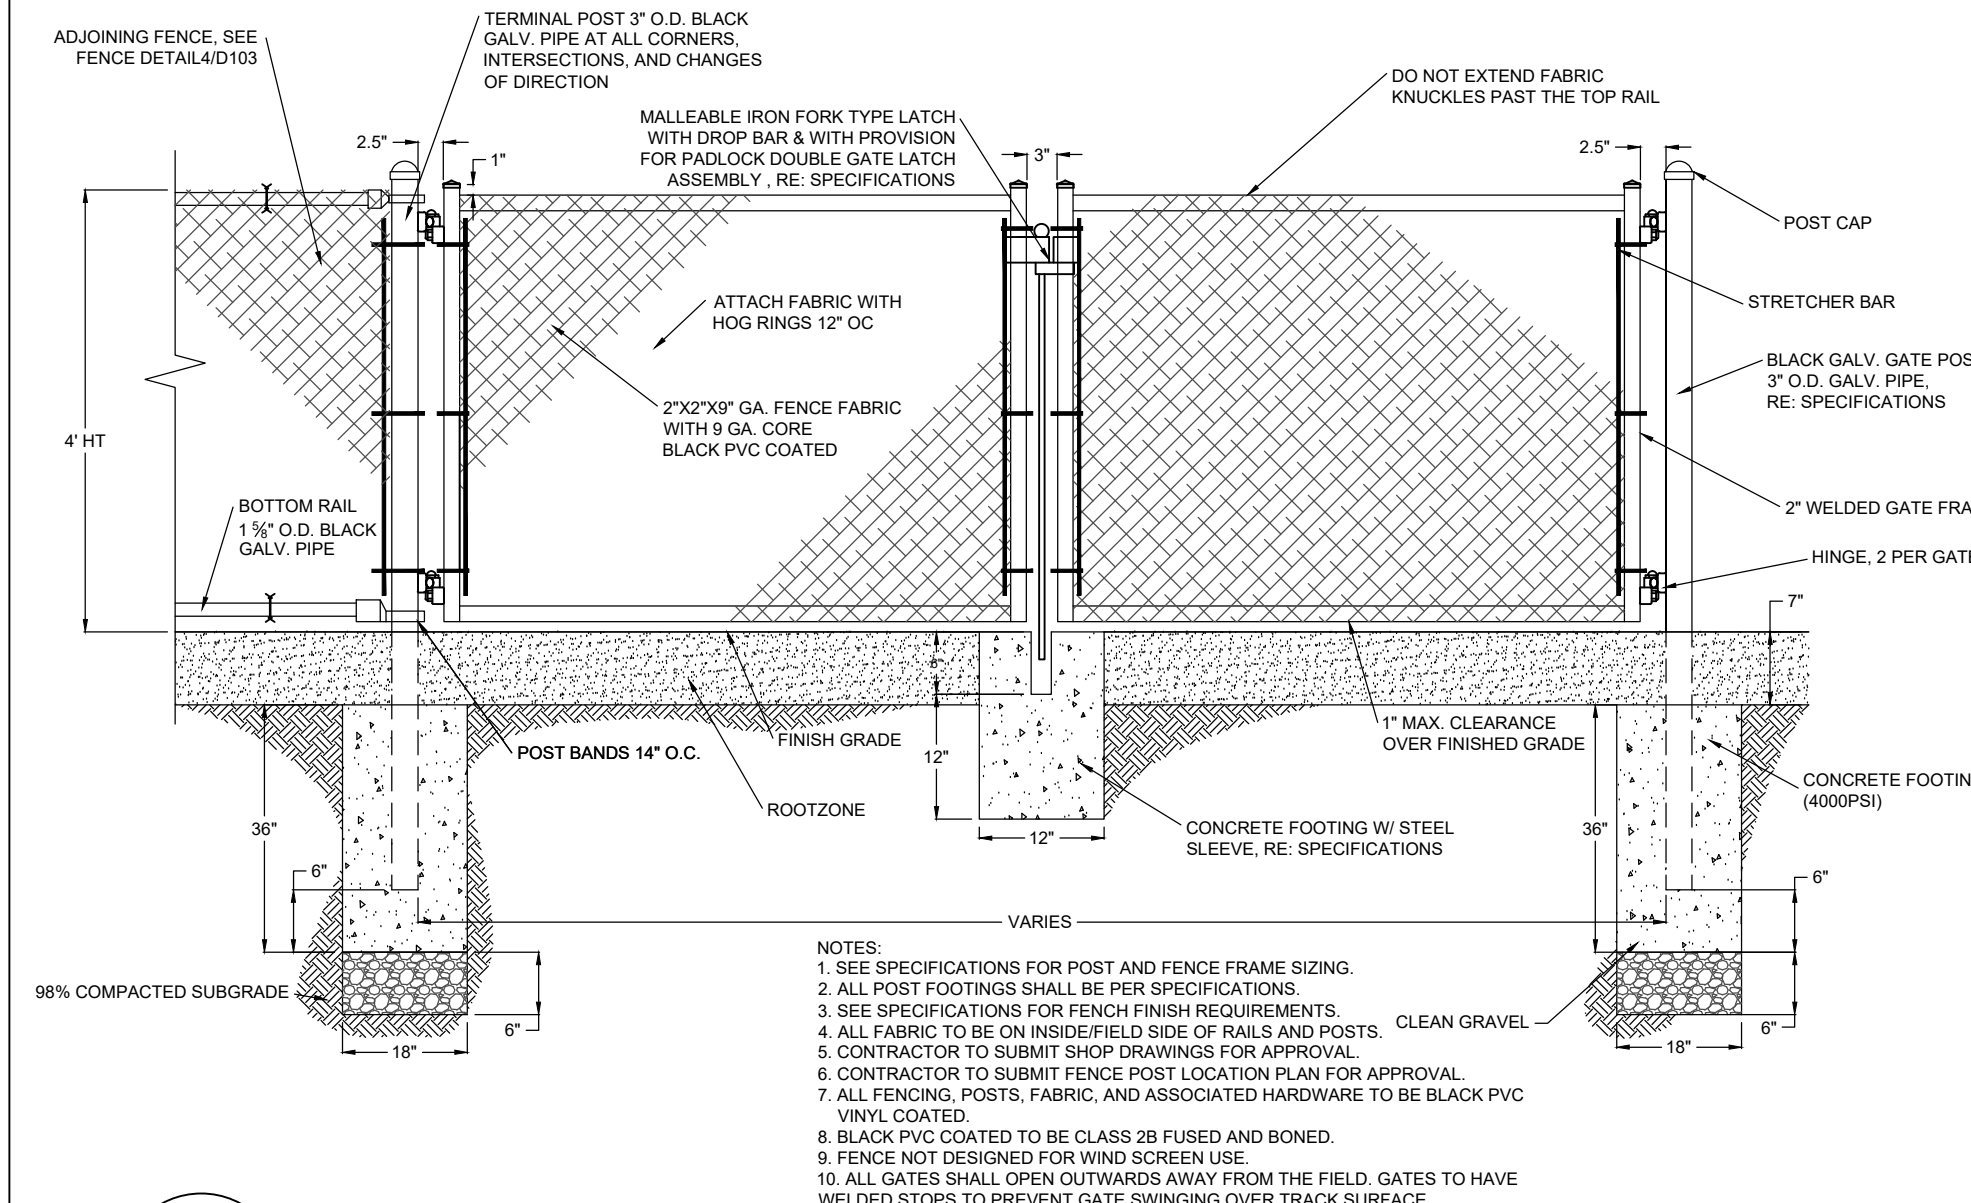


NOTES:
 1. SEE SPECIFICATIONS FOR POST AND FENCE FRAME SIZING.
 2. ALL POST FOOTINGS SHALL BE PER SPECIFICATIONS.
 3. SEE SPECIFICATIONS FOR FENCE FINISH REQUIREMENTS.
 4. ALL FABRIC TO BE ON INSIDE/FIELD SIDE OF RAILS AND POSTS.
 5. CONTRACTOR TO SUBMIT SHOP DRAWINGS FOR APPROVAL.
 6. CONTRACTOR TO SUBMIT FENCE POST LOCATION PLAN FOR APPROVAL.
 7. ALL FENCING POSTS, FABRIC, AND ASSOCIATED HARDWARE TO BE BLACK PVC VINYL COATED.
 8. BLACK PVC COATED TO BE CLASS 2B FUSED AND BONDED.
 9. FENCE NOT DESIGNED FOR WIND SCREEN USE.
 10. ALL GATES SHALL OPEN OUTWARDS AWAY FROM THE FIELD. GATES TO HAVE WELDED STOPS TO PREVENT GATE SWINGING OVER TRACK SURFACE.

6 CHAIN LINK DOUBLE GATE (4' HT)
 NOT TO SCALE


10/09/2021 9:53:09 AM
 S:\Projects\Wilson\CS\Track\Repl\Plan\2D\Design\06 CAD\Revit\Cermetel - BIM_300 FILE

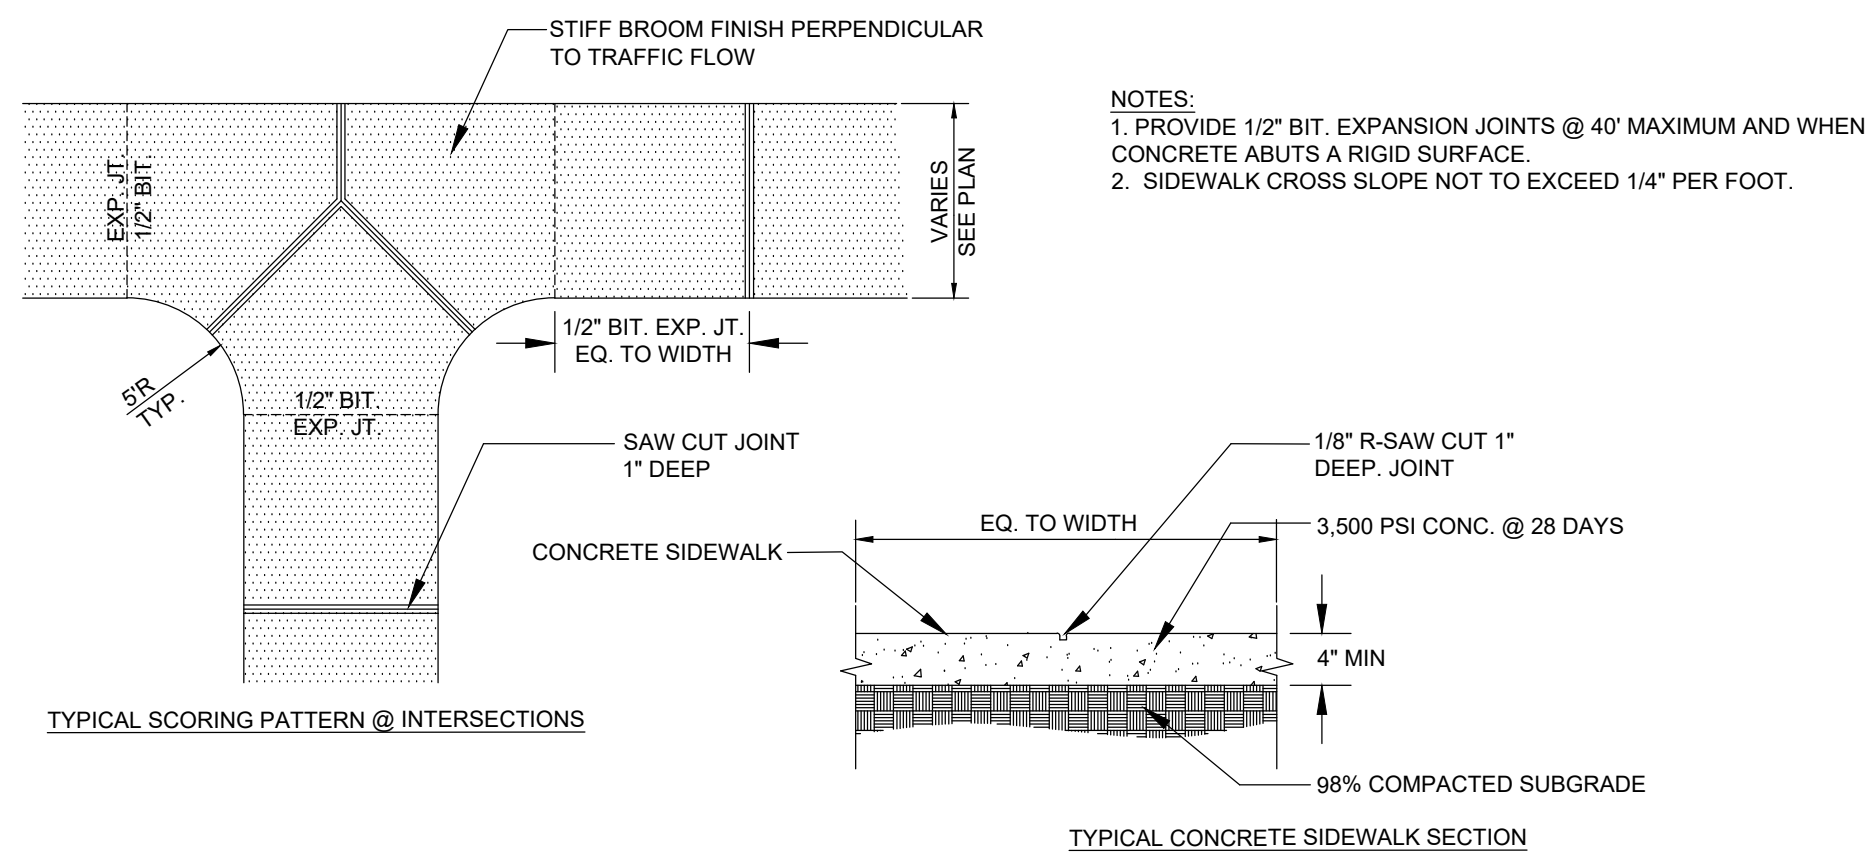

1 CONCRETE SIDEWALK
NOT TO SCALE

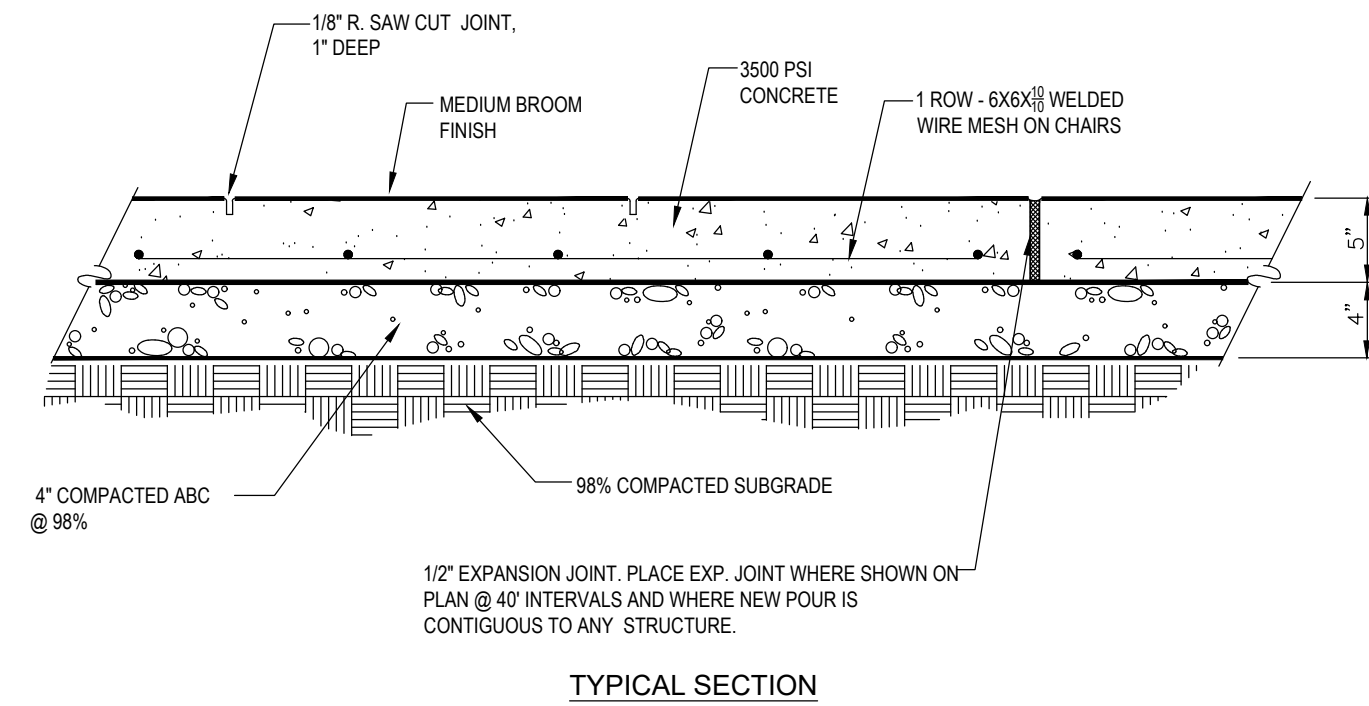

2 HEAVY DUTY CONCRETE
NOT TO SCALE

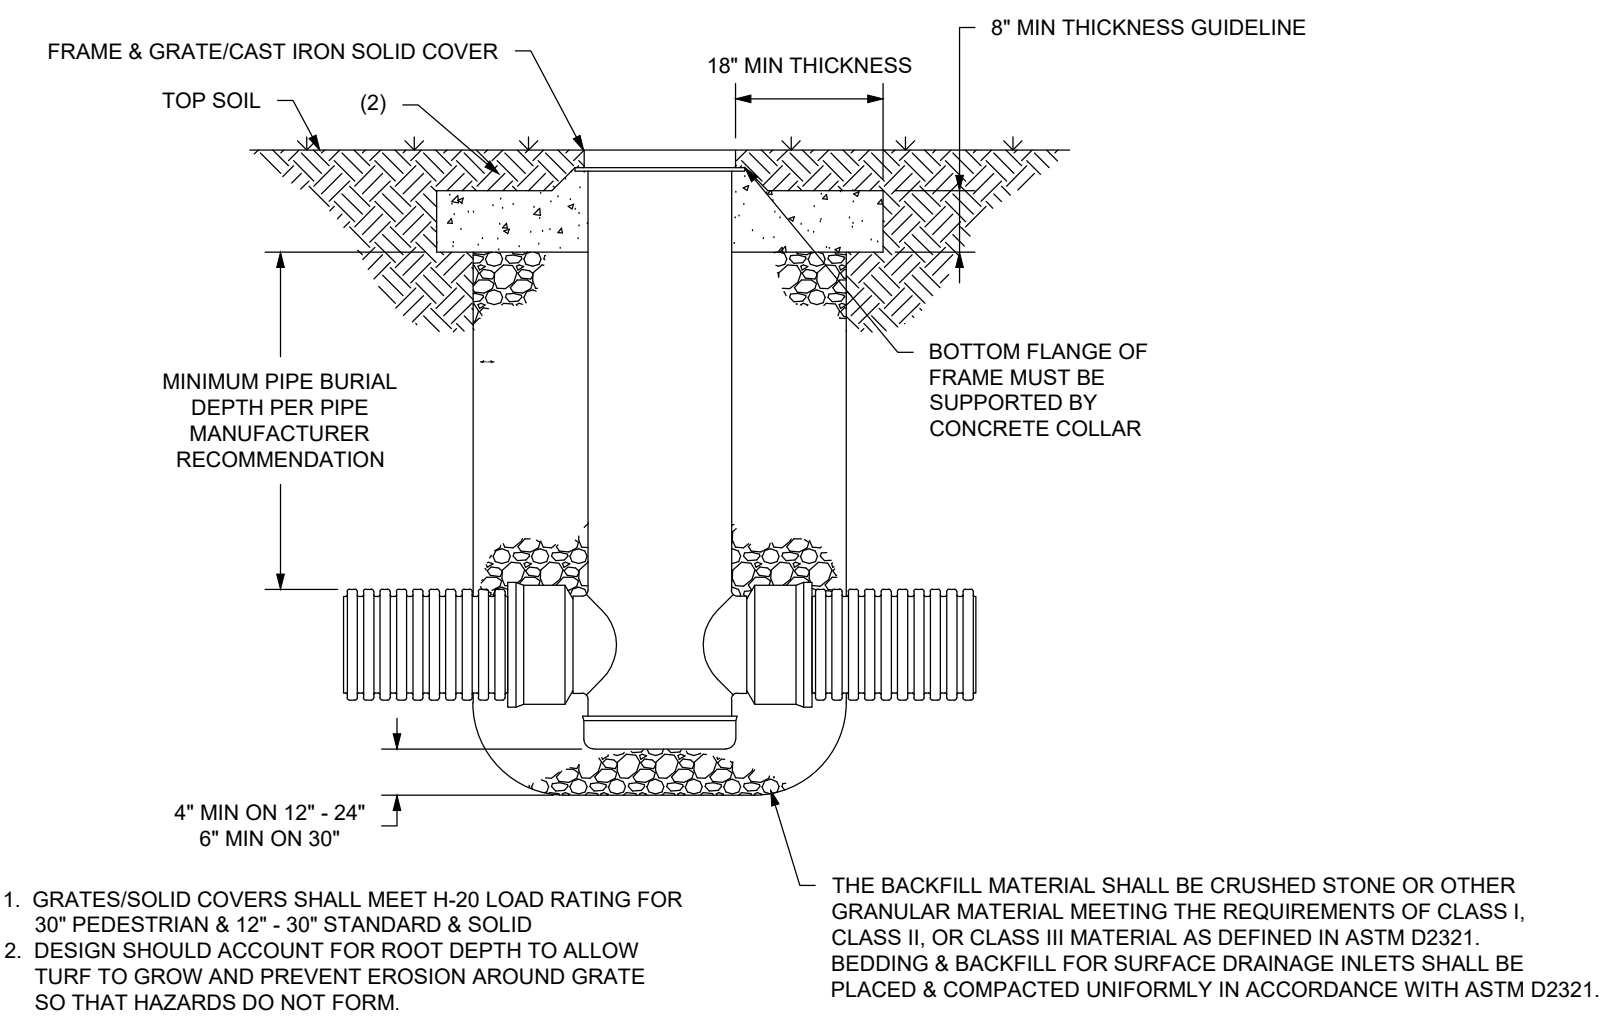


3 DRAIN BASIN
NOT TO SCALE




NOTES:
 1. BENCH TO BE GLOBAL INDUSTRIAL ITEM # WBB2310949 OR APPROVED EQUAL.
 2. BENCH TO BE INSTALLED PER MANUFACTURER'S SPECIFICATIONS.


4 6' ALUMINUM BENCH
NOT TO SCALE

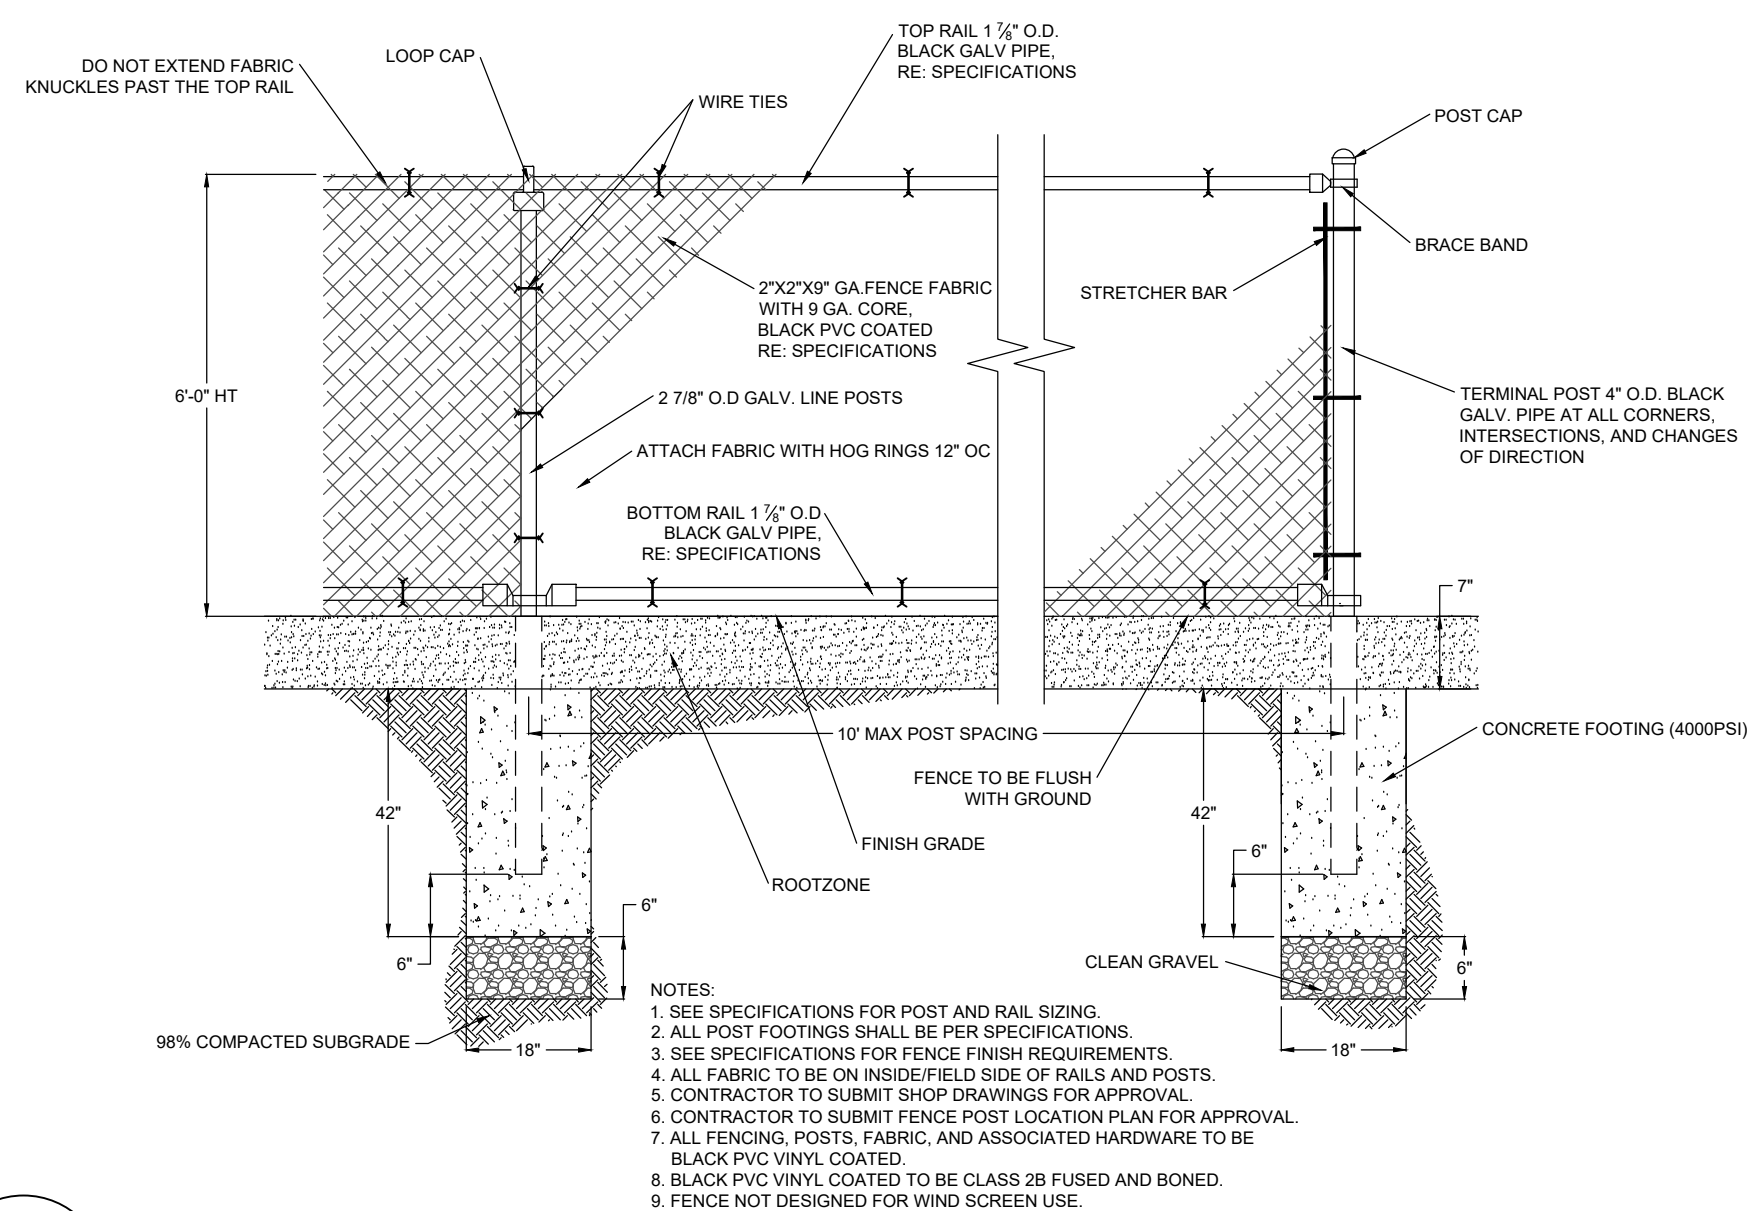

5 CHAIN LINK FENCE (6' HT)
NOT TO SCALE

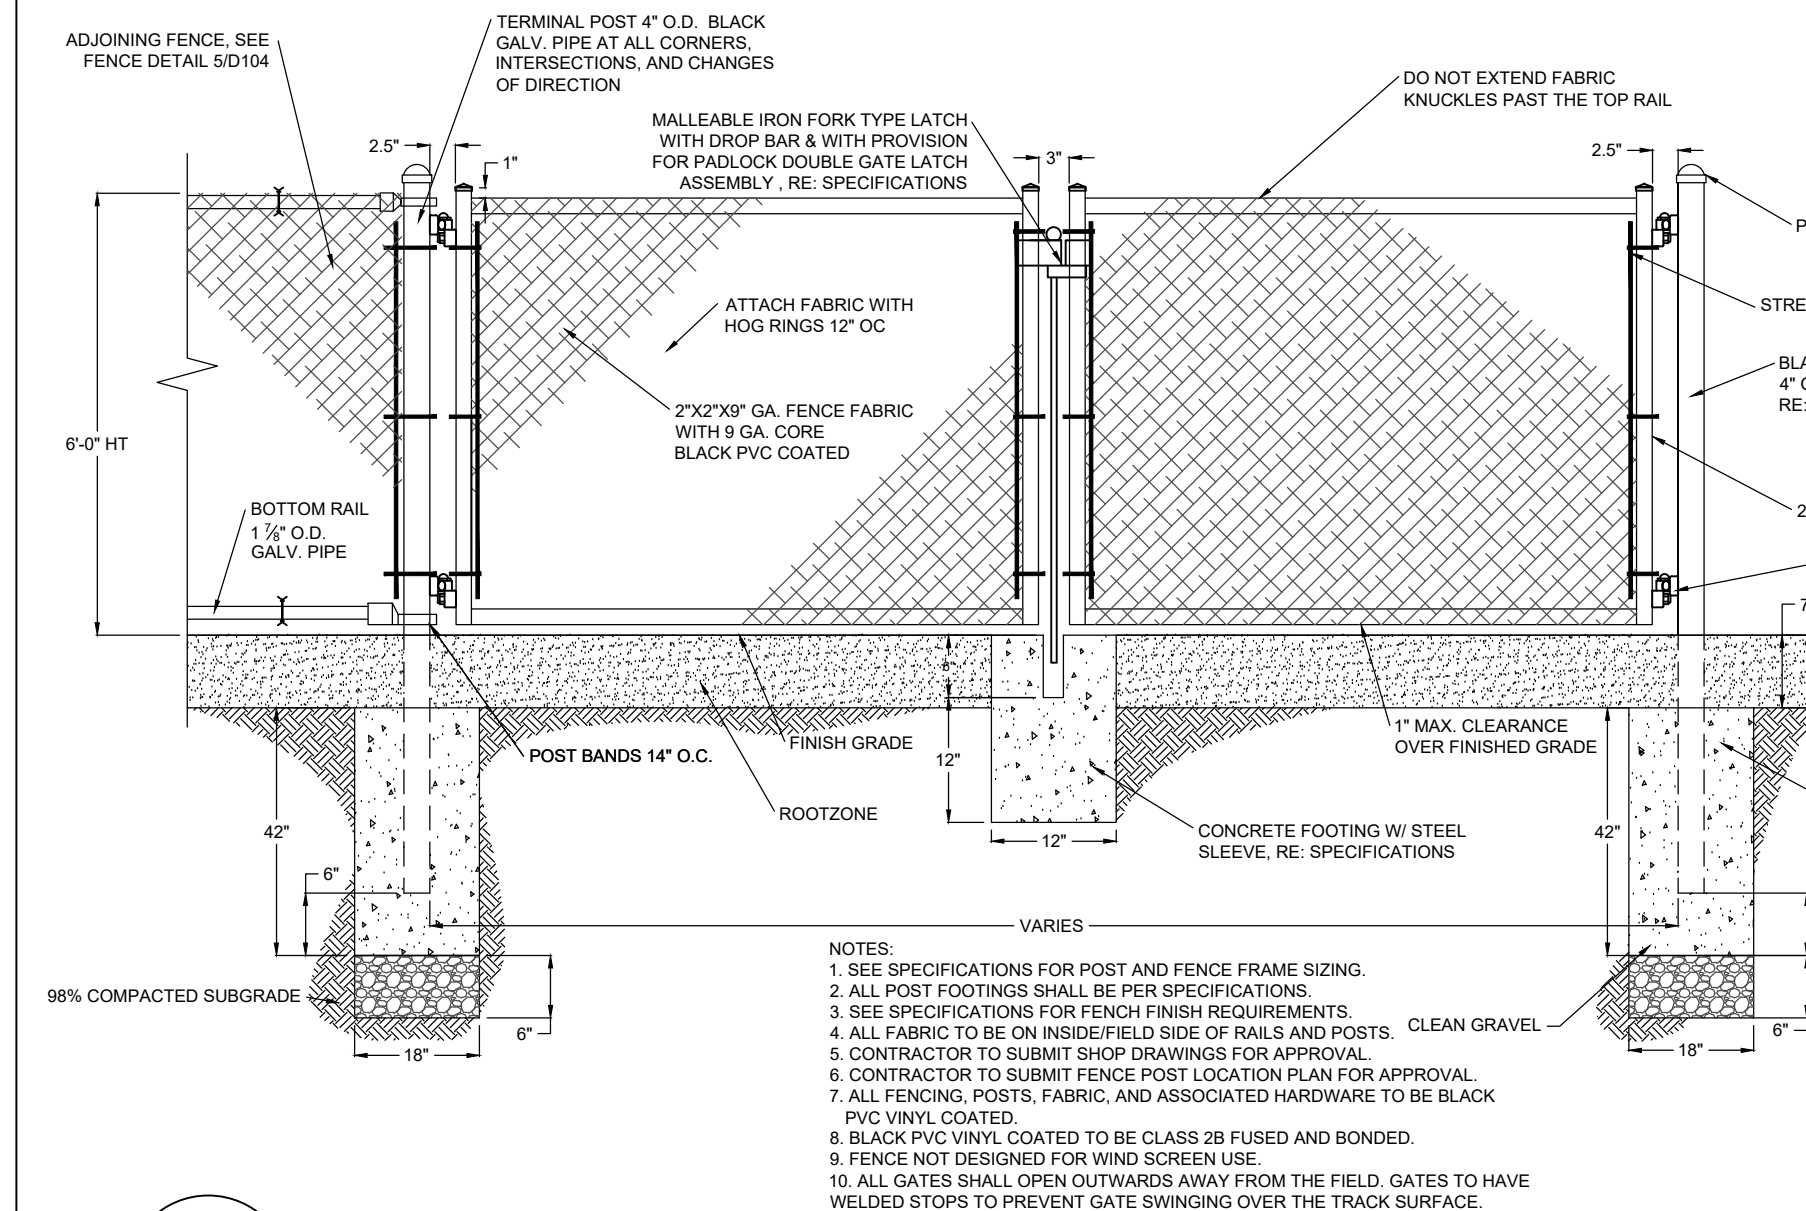

6 CHAIN LINK DOUBLE GATE (6' HT)
NOT TO SCALE

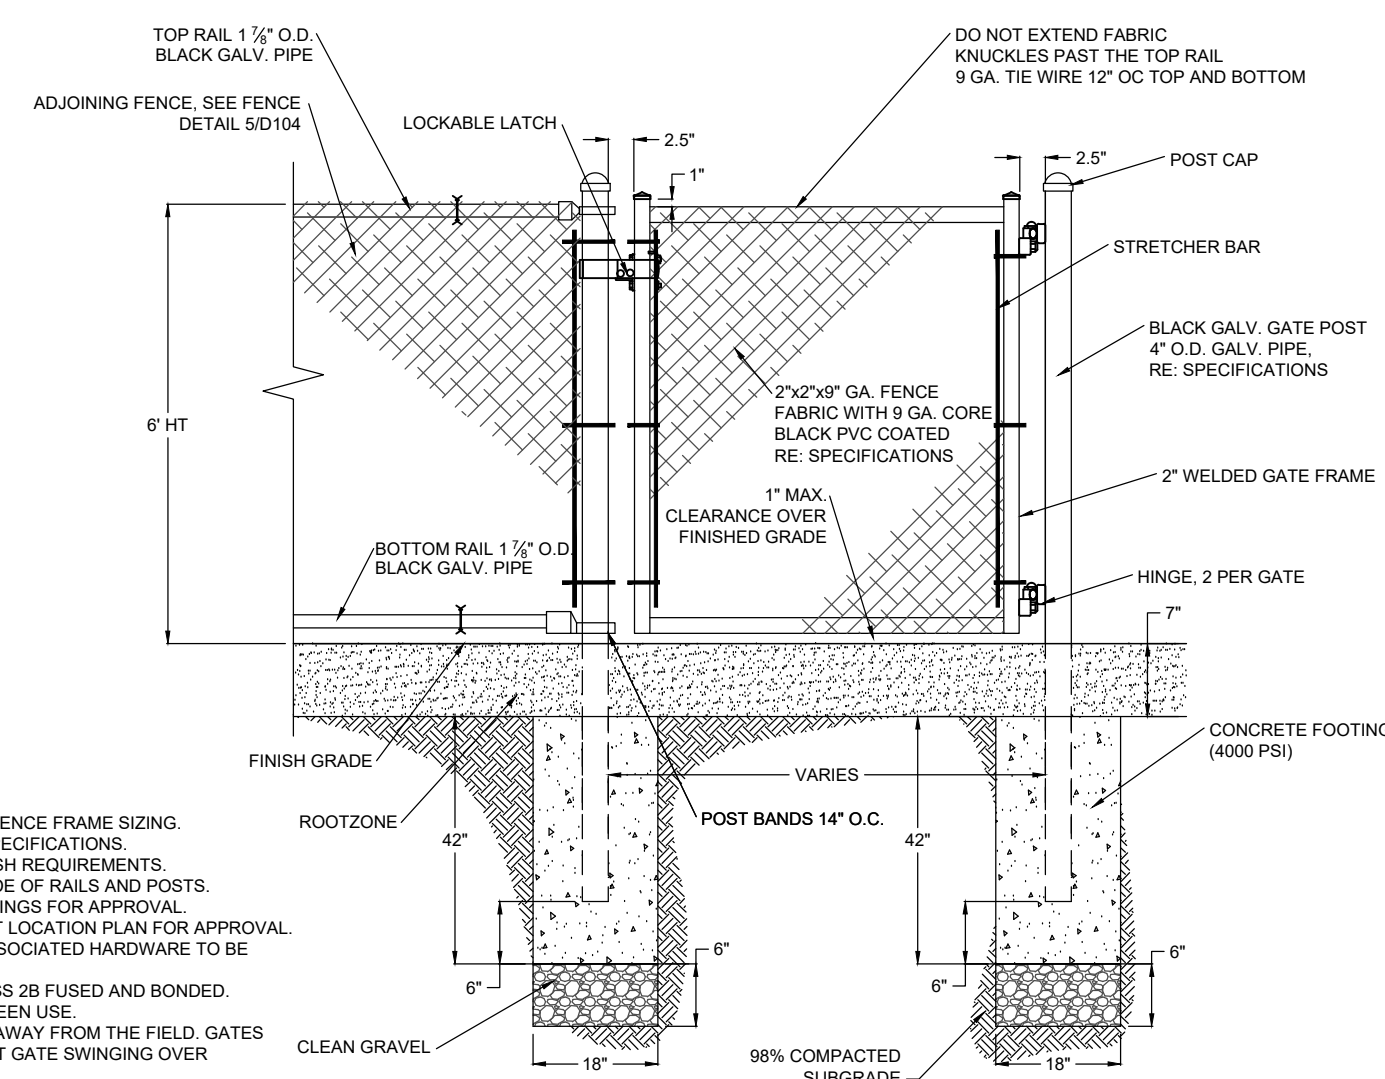


7 CHAIN LINK SINGLE GATE (6' HT.)
NOT TO SCALE

8 RESERVED
NOT TO SCALE

9 RESERVED
NOT TO SCALE



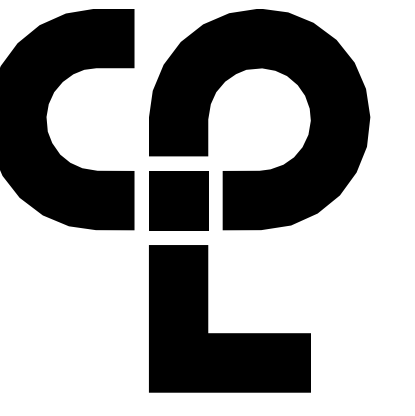

DEMOLITION GENERAL NOTES


- ALL DRAWINGS ARE GRAPHIC REPRESENTATION OF APPROXIMATE LOCATIONS OF MATERIALS TO BE REMOVED. IT IS THE CONTRACTORS RESPONSIBILITY TO FIELD VERIFY ALL EXISTING CONDITIONS & DIMENSIONS PRIOR TO COMMENCEMENT OF ALL DEMOLITION WORK.
- REFER TO THE MECHANICAL, ELECTRICAL AND PLUMBING DRAWINGS FOR DEMOLITION OF EXISTING UTILITIES AND SERVICES.
- ALL ITEMS TO BE SALVAGED WITHIN THE DEMOLITION AREA WILL BE REMOVED BY THE OWNER PRIOR TO ONSET OF DEMOLITION WORK.
- REMAINING SUBSTRATES SHALL BE LEFT IN A CONDITION ACCEPTABLE TO RECEIVE NEW WORK. WHERE NEW FINISHES ARE SCHEDULED AT EXISTING CONDITIONS, REMOVE EXISTING FINISHES DOWN TO SUBSTRATE AND PREPARE SURFACE FOR NEW FINISH.
- THE CONTRACTOR IS RESPONSIBLE FOR DAMAGE TO ANY EXISTING FINISHES AND EQUIPMENT NOT REMOVED UNDER THE SCOPE OF WORK. ANY DAMAGE WILL BE REPAIRED TO THE OWNER/ARCHITECT'S SATISFACTION.
- REMOVE AND REPLACE EXISTING CEILINGS, UNLESS OTHERWISE NOTED ON THE DRAWINGS, FOR PERFORMING DEMOLITION OF ALL WORK INDICATED ON THE CONSTRUCTION DRAWINGS. THE EXISTING CEILING SHALL BE REMOVED AND REPLACED IN A MANNER TO AVOID DAMAGE TO THE WALL SYSTEM.
- NOTIFY ARCHITECT AND OWNER OF EXISTING DUCTWORK, PIPE AND CONDUIT PENETRATIONS EXPOSED AFTER DEMOLITION THAT ARE NOT FIRESTOPPED THROUGH EXISTING FLOORS AND WALLS IDENTIFIED AS FIRE AND/OR SMOKE RATED ON LIFE SAFETY PLANS. EXISTING NON-COMPLIANT PENETRATIONS ARE TO BE FIRESTOPPED.
- WORK AREAS SHALL BE MAINTAINED AND ALL WORK AREAS SHALL BE LEFT BROOM CLEANED AT END OF EACH DAY.
- IN ALL LOCATIONS THAT A DOOR IS ILLUSTRATED TO BE DEMOLISHED, REMOVE AND DISPOSE OF DOOR, FRAME, HARDWARE AND ALL ASSOCIATED ITEMS, UNLESS NOTED OTHERWISE.
- ALL ITEMS SHOWN WITH A DASHED LINE ARE TO BE REMOVED AND DISPOSED OF UNLESS OTHERWISE NOTED.
- SINKS INDICATED WITHIN MILLWORK BEING REMOVED SHALL ALSO BE REMOVED AND DISPOSED OF, ALONG WITH ALL ASSOCIATED ITEMS, UNLESS OTHERWISE NOTED. COORDINATE WITH PLUMBING DRAWINGS.
- TYPICAL BUILDING COMPONENTS TO BE LEFT IN PLACE WHICH ARE NOT TO BE DEMOLISHED, UNLESS NOTED OTHERWISE:
 - ELECTRIC, PLUMBING AND HVAC LINES FEEDING AREAS TO REMAIN IN OPERATION. COORDINATE WITH MEP DRAWINGS.
 - ANY STRUCTURES UNCOVERED AS A RESULT OF DEMOLITION WHICH APPEAR TO BE SUPPORTING IN NATURE AND REQUIRING VERIFICATION PRIOR TO DEMOLITION. THIS INCLUDES EQUIPMENT SUPPORTS AND STRUCTURE ADDED AS A RESULT OF PREVIOUS CONSTRUCTION OR ADDITIONS.
- THE OWNER WILL REMOVE ALL MOVEABLE OR UNATTACHED ITEMS TO BE SAVED OR STORED PRIOR TO CONTRACTORS' SALVAGE OPERATIONS. ITEMS TO BE SALVAGED INCLUDE BUT ARE NOT LIMITED TO, THOSE ITEMS SHOWN ON THE DRAWINGS.
- OWNER HAS THE RIGHT TO SALVAGE ANY FIXTURES AND/OR MILLWORK WITHIN AN AREA OF DEMOLITION PRIOR TO CONTRACTOR STARTING WORK IN THAT ZONE. COORDINATE TIMING OF SUCH REMOVALS WITH OWNER.
- IN THE CASE THAT ANY SUSPICIOUS MATERIALS ARE UNCOVERED THAT APPEAR TO CONTAIN HAZARDOUS MATERIALS SUCH AS BUT NOT LIMITED TO MOLD, LEAD PAINT OR ASBESTOS, LEAVE THE PREMISES AND NOTIFY THE OWNER & ABATEMENT CONTRACTOR FOR REQUIRED TESTING AND/OR REMOVALS.

PROJECT INFORMATION


Project Number
R22.16900.00
Client Name
WILSON COUNTY SCHOOLS
Project Name
HUNT HS - ATHLETICS RENOVATION
HUNT HIGH SCHOOL
Project Address
4559 Lamm Rd, Wilson, NC 27893

PROJECT ISSUE & REVISION SCHEDULE


No.	Date	Description

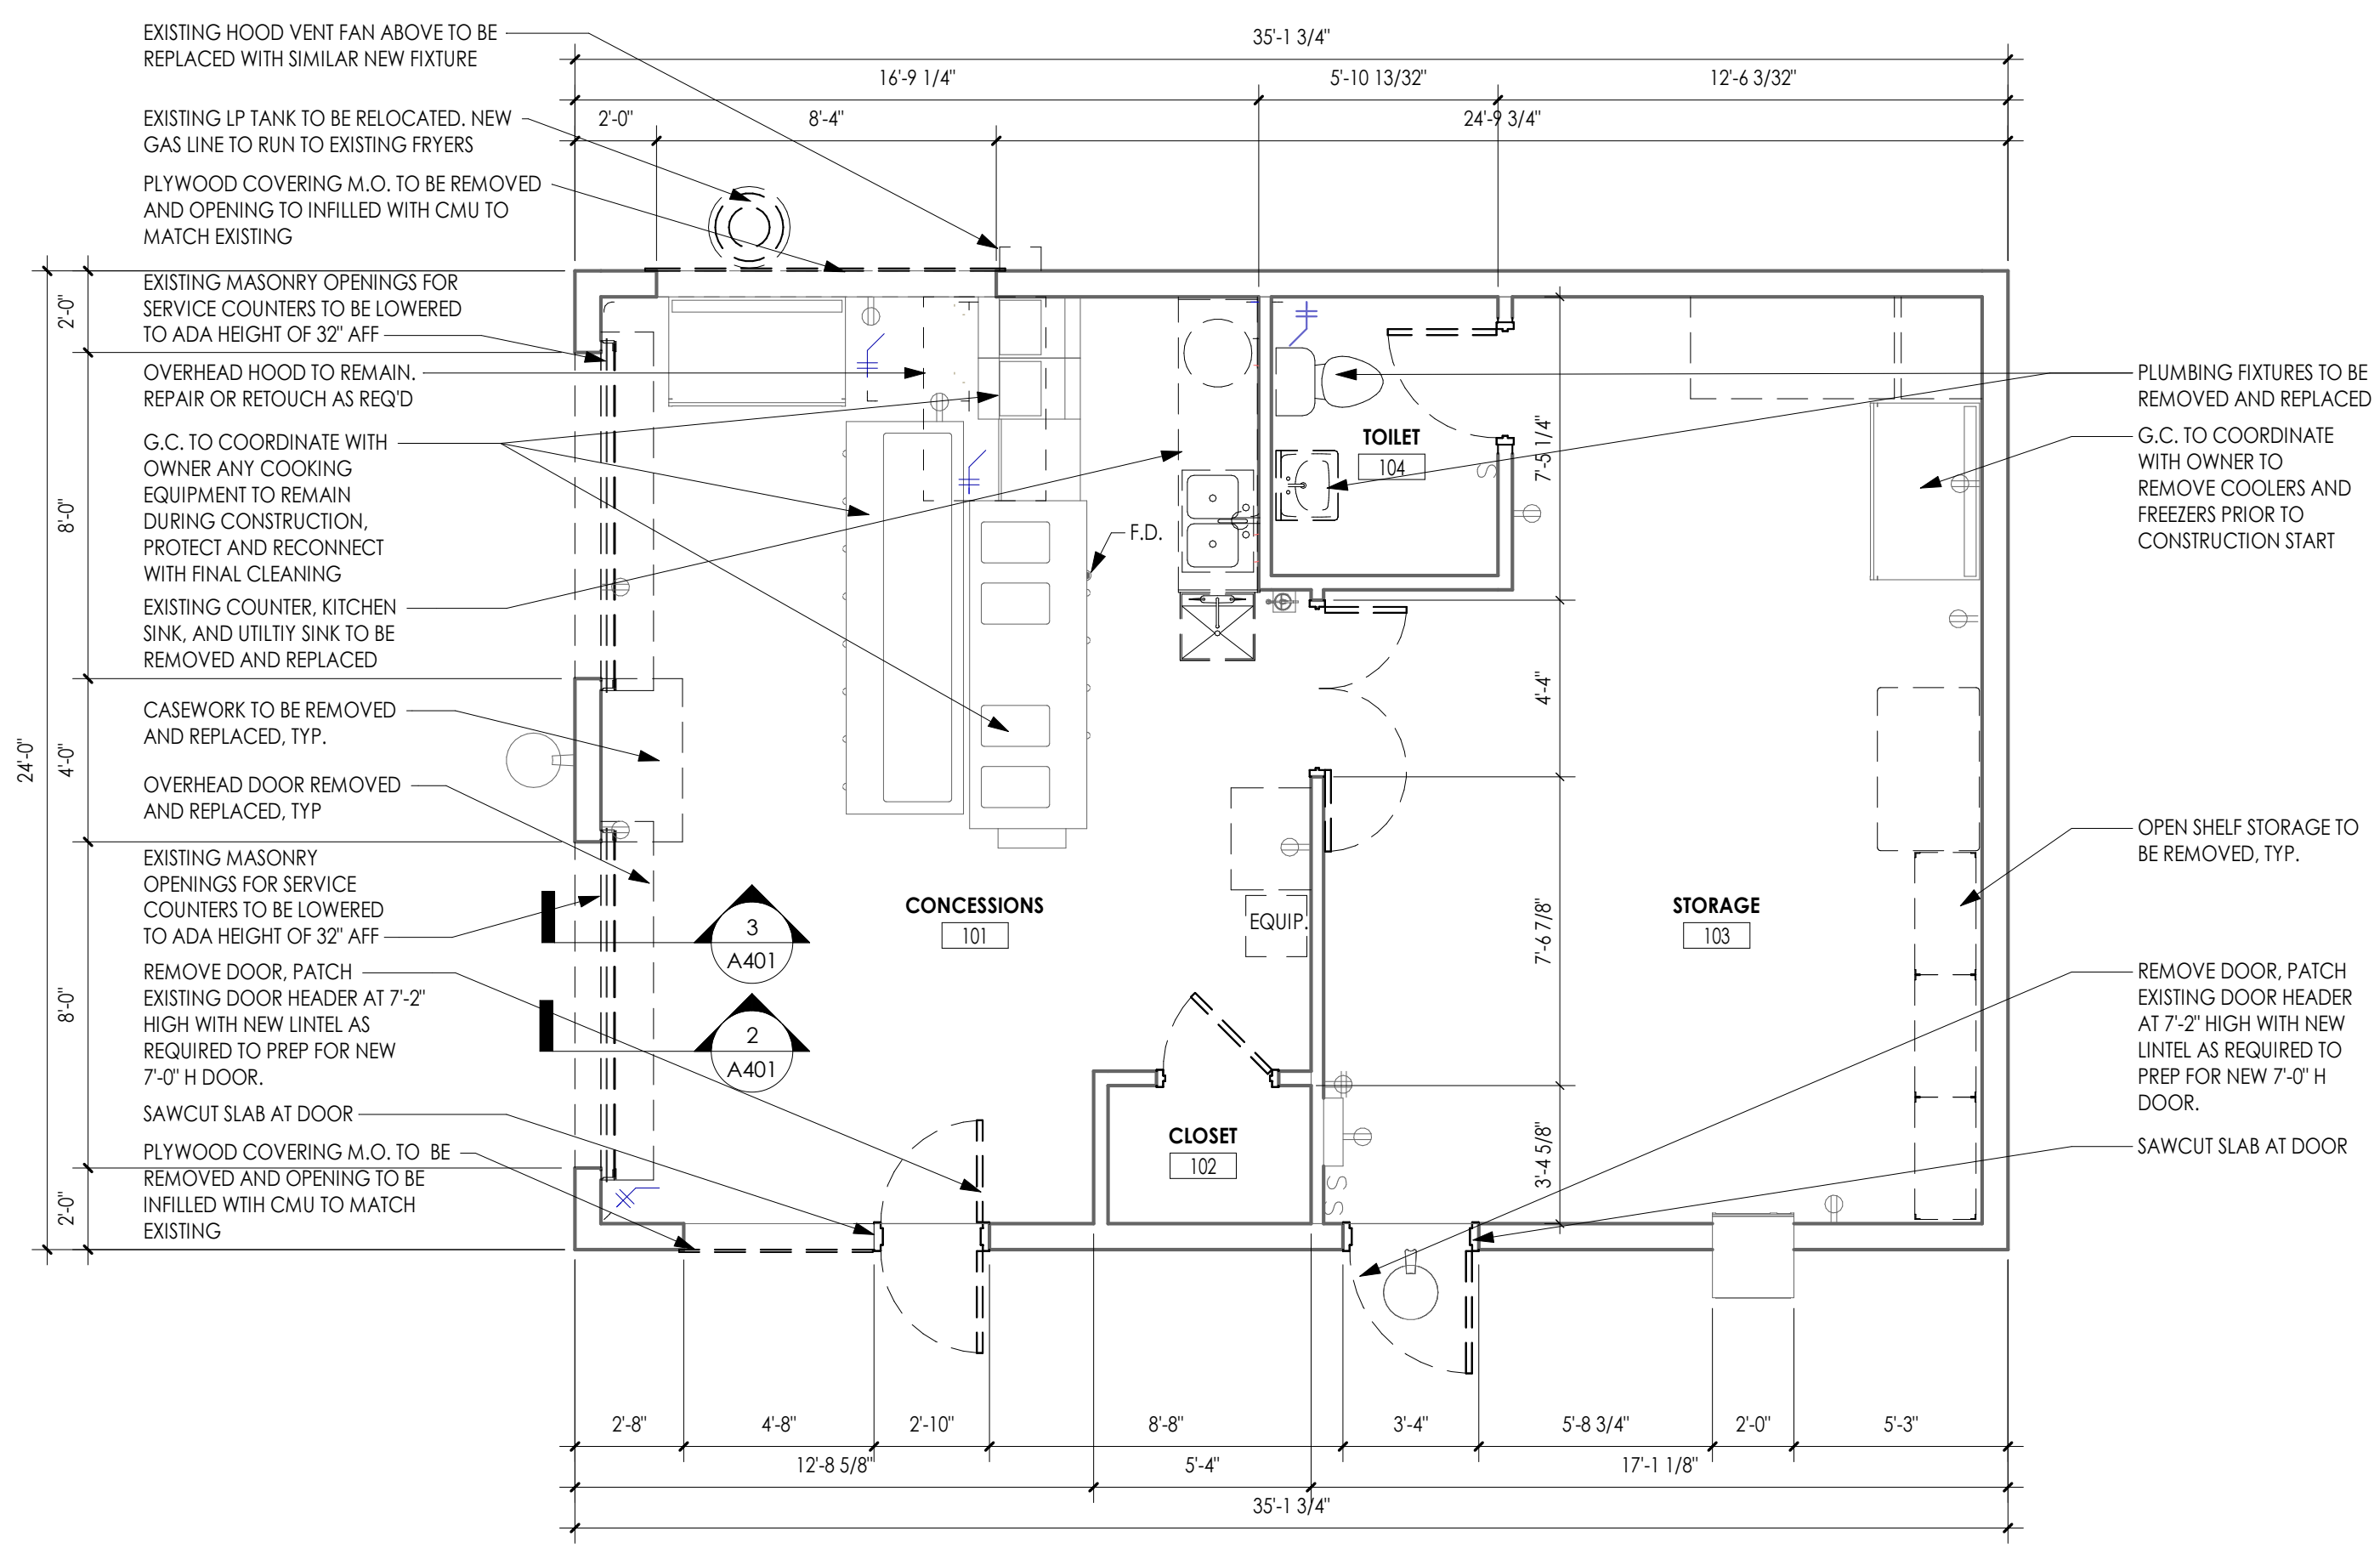

2
A001
CONCESSIONS BUILDING DEMOLITION FLOOR PLAN
1/4" = 1'-0"

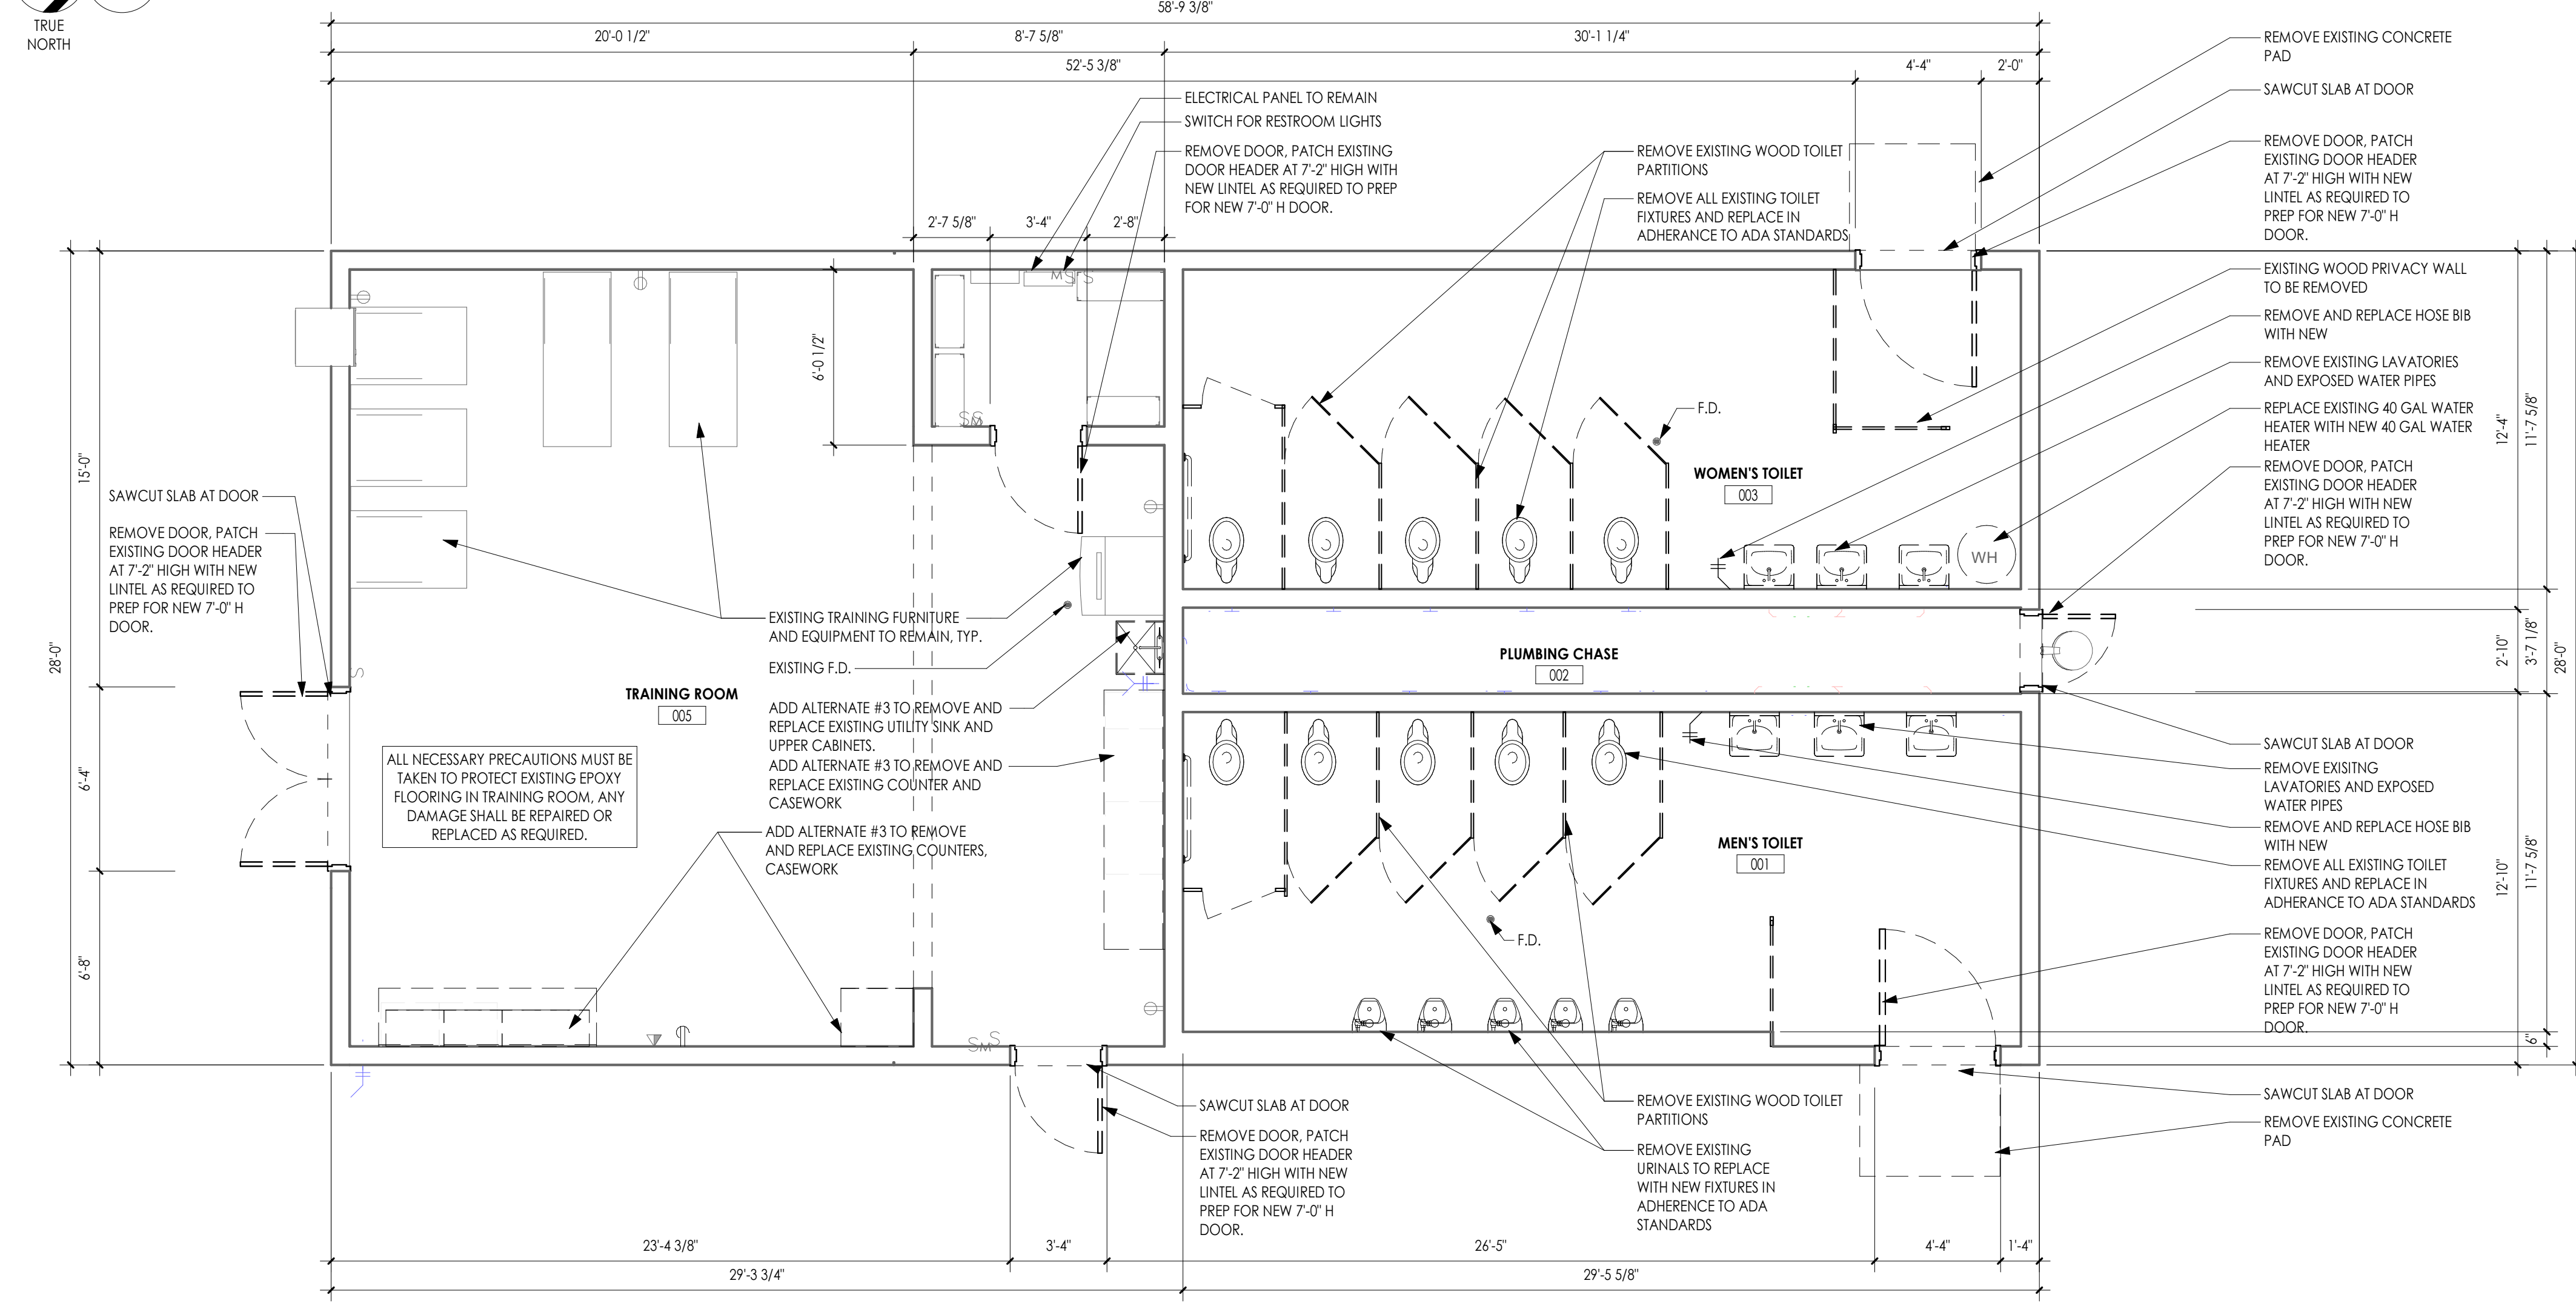

1
A001
RESTROOM BUILDING DEMOLITION FLOOR PLAN
1/4" = 1'-0"

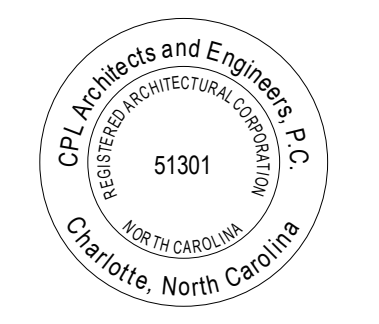



SHEET INFORMATION

Issued: 09.15.2023
Scale: As indicated
Project Status: 100% CONSTRUCTION DOCUMENTS
Drawn By: EG
Checked By: GB
Drawing Title: OVERALL DEMOLITION PLAN

Drawing Number

A001

9/22/2023 9:59:26 AM S:\Projects\Wilson\CS\Hunt HS Athletic Renovation\Design\CAD\Revit\Central

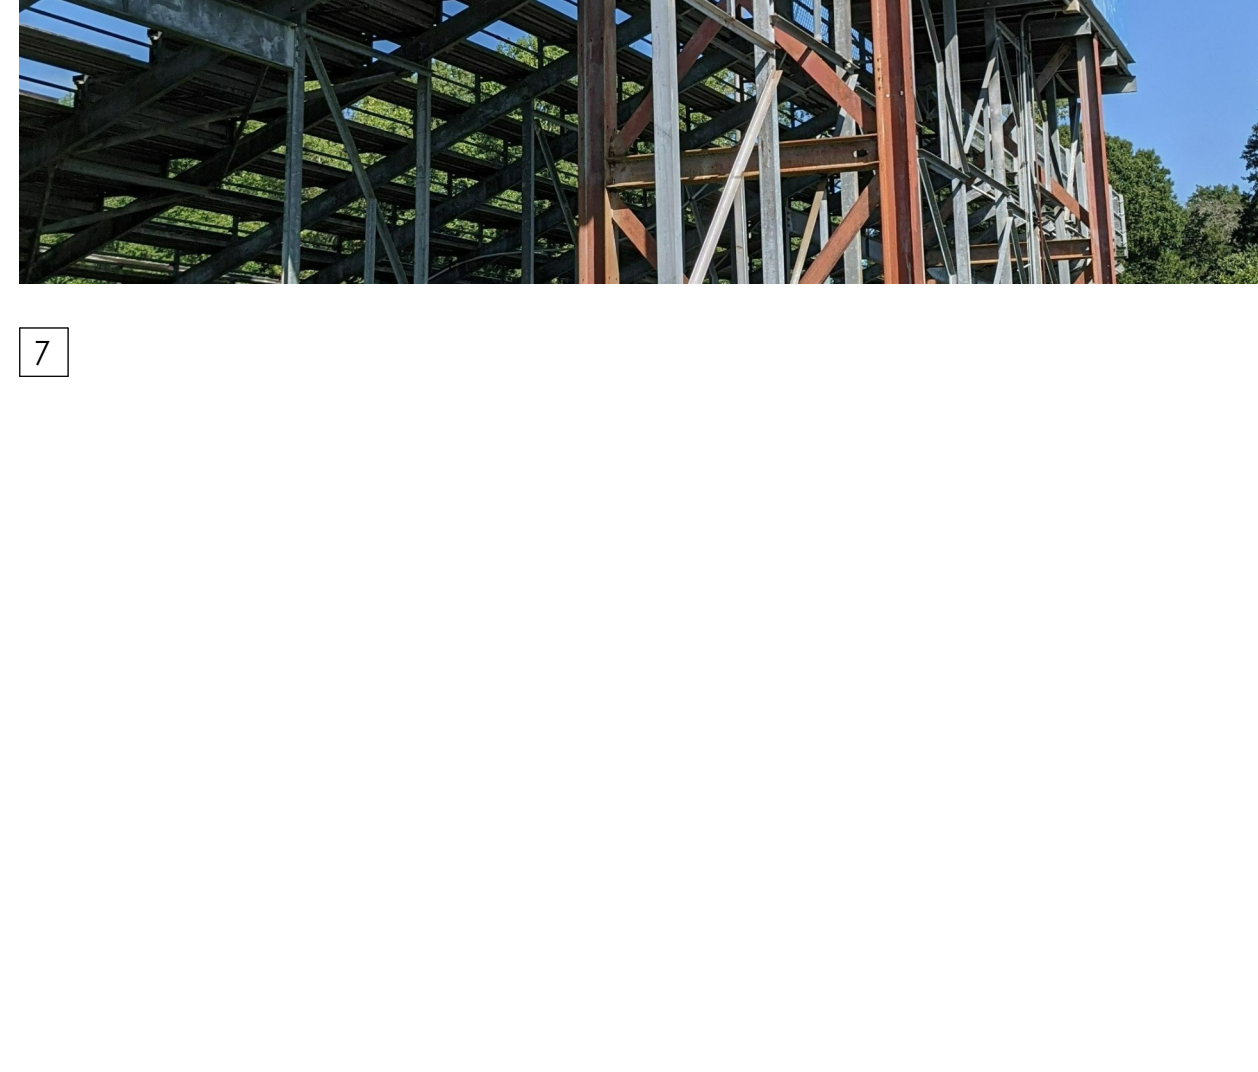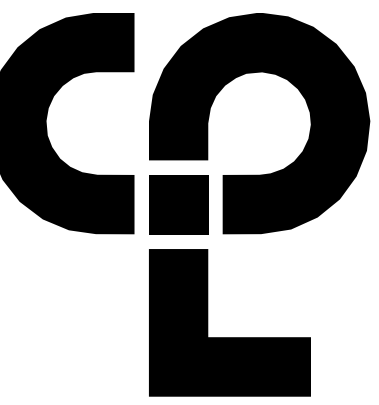

GENERAL STADIUM SEATING NOTES

HOME BLEACHER SEATING IS GENERALLY IN ACCEPTABLE CONDITION, ALUMINUM PLANKS & RISERS ON GALVANIZED STEEL STRUCTURE. [IMAGE 1]

VISITOR BLEACHER SEATING IS IN ACCEPTABLE CONDITION, ALUMINUM PLANKS & RISERS ON GALVANIZED STEEL STRUCTURE. [IMAGE 2]


ANCILLARY HOME BLEACHER SEATING IS GENERALLY IN ACCEPTABLE CONDITION, ALUMINUM PLANKS & RISERS ON GALVANIZED STEEL STRUCTURE. THESE BLEACHERS ARE TO BE DISASSEMBLED, CLEANED, AND REASSEMBLED ON NEW CONCRETE PAD. [IMAGE 3]

CONTRACTOR SHALL CONDUCT BLEACHER REPAIR ASSESSMENT AND NOTIFY ARCHITECT / OWNER OF ANY FOUND DEFICIENCIES NOT IDENTIFIED HERE.

- ON BLEACHERS: ALL BOLTS, CONNECTORS, AND FASTENERS SHALL BE CHECKED AND ANY LOOSE FITTINGS SHALL BE TIGHTENED OR REPLACED AS REQUIRED. [IMAGE 4]
- ON BLEACHERS: SEATS, RISERS, FOOT BOARDS & WALKWAY PLANKS SHALL BE CHECKED FOR STRAIGHTNESS, SPLICES CHECKED, BOLTS AND RIVET CONNECTIONS CHECKED AND ANY BOWED OR BROKEN PLANKS SHALL BE REPLACED [IMAGE 5]
- SURFACE RUST ON PRESS BOX COLUMNS SHALL BE CLEANED OFF, PREPPED, AND REPAINTED [IMAGE 7]
- ON BLEACHERS: ALL RUSTED BOLTS, FASTENERS, OR CONNECTORS SHALL BE CLEANED OR REPLACED, ANY RUST STAINING ON GALVANIZED STEEL SHOULD BE THOROUGHLY CLEANED. [IMAGE 6]
- ALL ANCHORS & GROUND SILL ATTACHMENTS SHALL BE CHECKED AND REPAIRED IF NEEDED.
- ALL WELDED CONNECTIONS SHALL BE INSPECTED, CLEANED AND REPLACED IF DEFICIENT.
- ALL ALUMINUM PLANKS, RISERS, GUARDRAILS, HANDRAILS, OR CONNECTION PIECES SHALL BE CLEANED THOROUGHLY.
- CHAINLINK FABRIC THAT IS RUSTED IS TO BE REPLACED WITH NEW FABRIC, MATCHING THE EXISTING

SURFACE PREP TO FOLLOW SSPC-SP6 / NACE 3 Commercial Blast Cleaning
When viewed without magnification, the surface shall be free of all visible oil, grease, dust, dirt, mill scale, rust, coating, oxides, corrosion products and other foreign matter of at least 66-2/3% of unit area, which shall be a square 3 in. x 3 in. (9 sq. in.). Light shadows, slight streaks, or minor discolorations caused by stains of rust, stains of mill scale, or stains of previously applied coating in less than 33-1/3% of the unit area is acceptable.

FOR COATING OF STEEL STRUCTURE AND ANY NON-GALVANIZED STEEL:
1st Coat: S-W Macropoxy 446 Fast Cure Epoxy, B58-600/B58V600
2nd Coat: S-W Acrolon 218 HS Acrylic Polyurethane Semi-Gloss, B65-650/B65V600
3rd Coat: S-W Acrolon 218 HS Acrylic Polyurethane Semi-Gloss, B65-650/B65V600

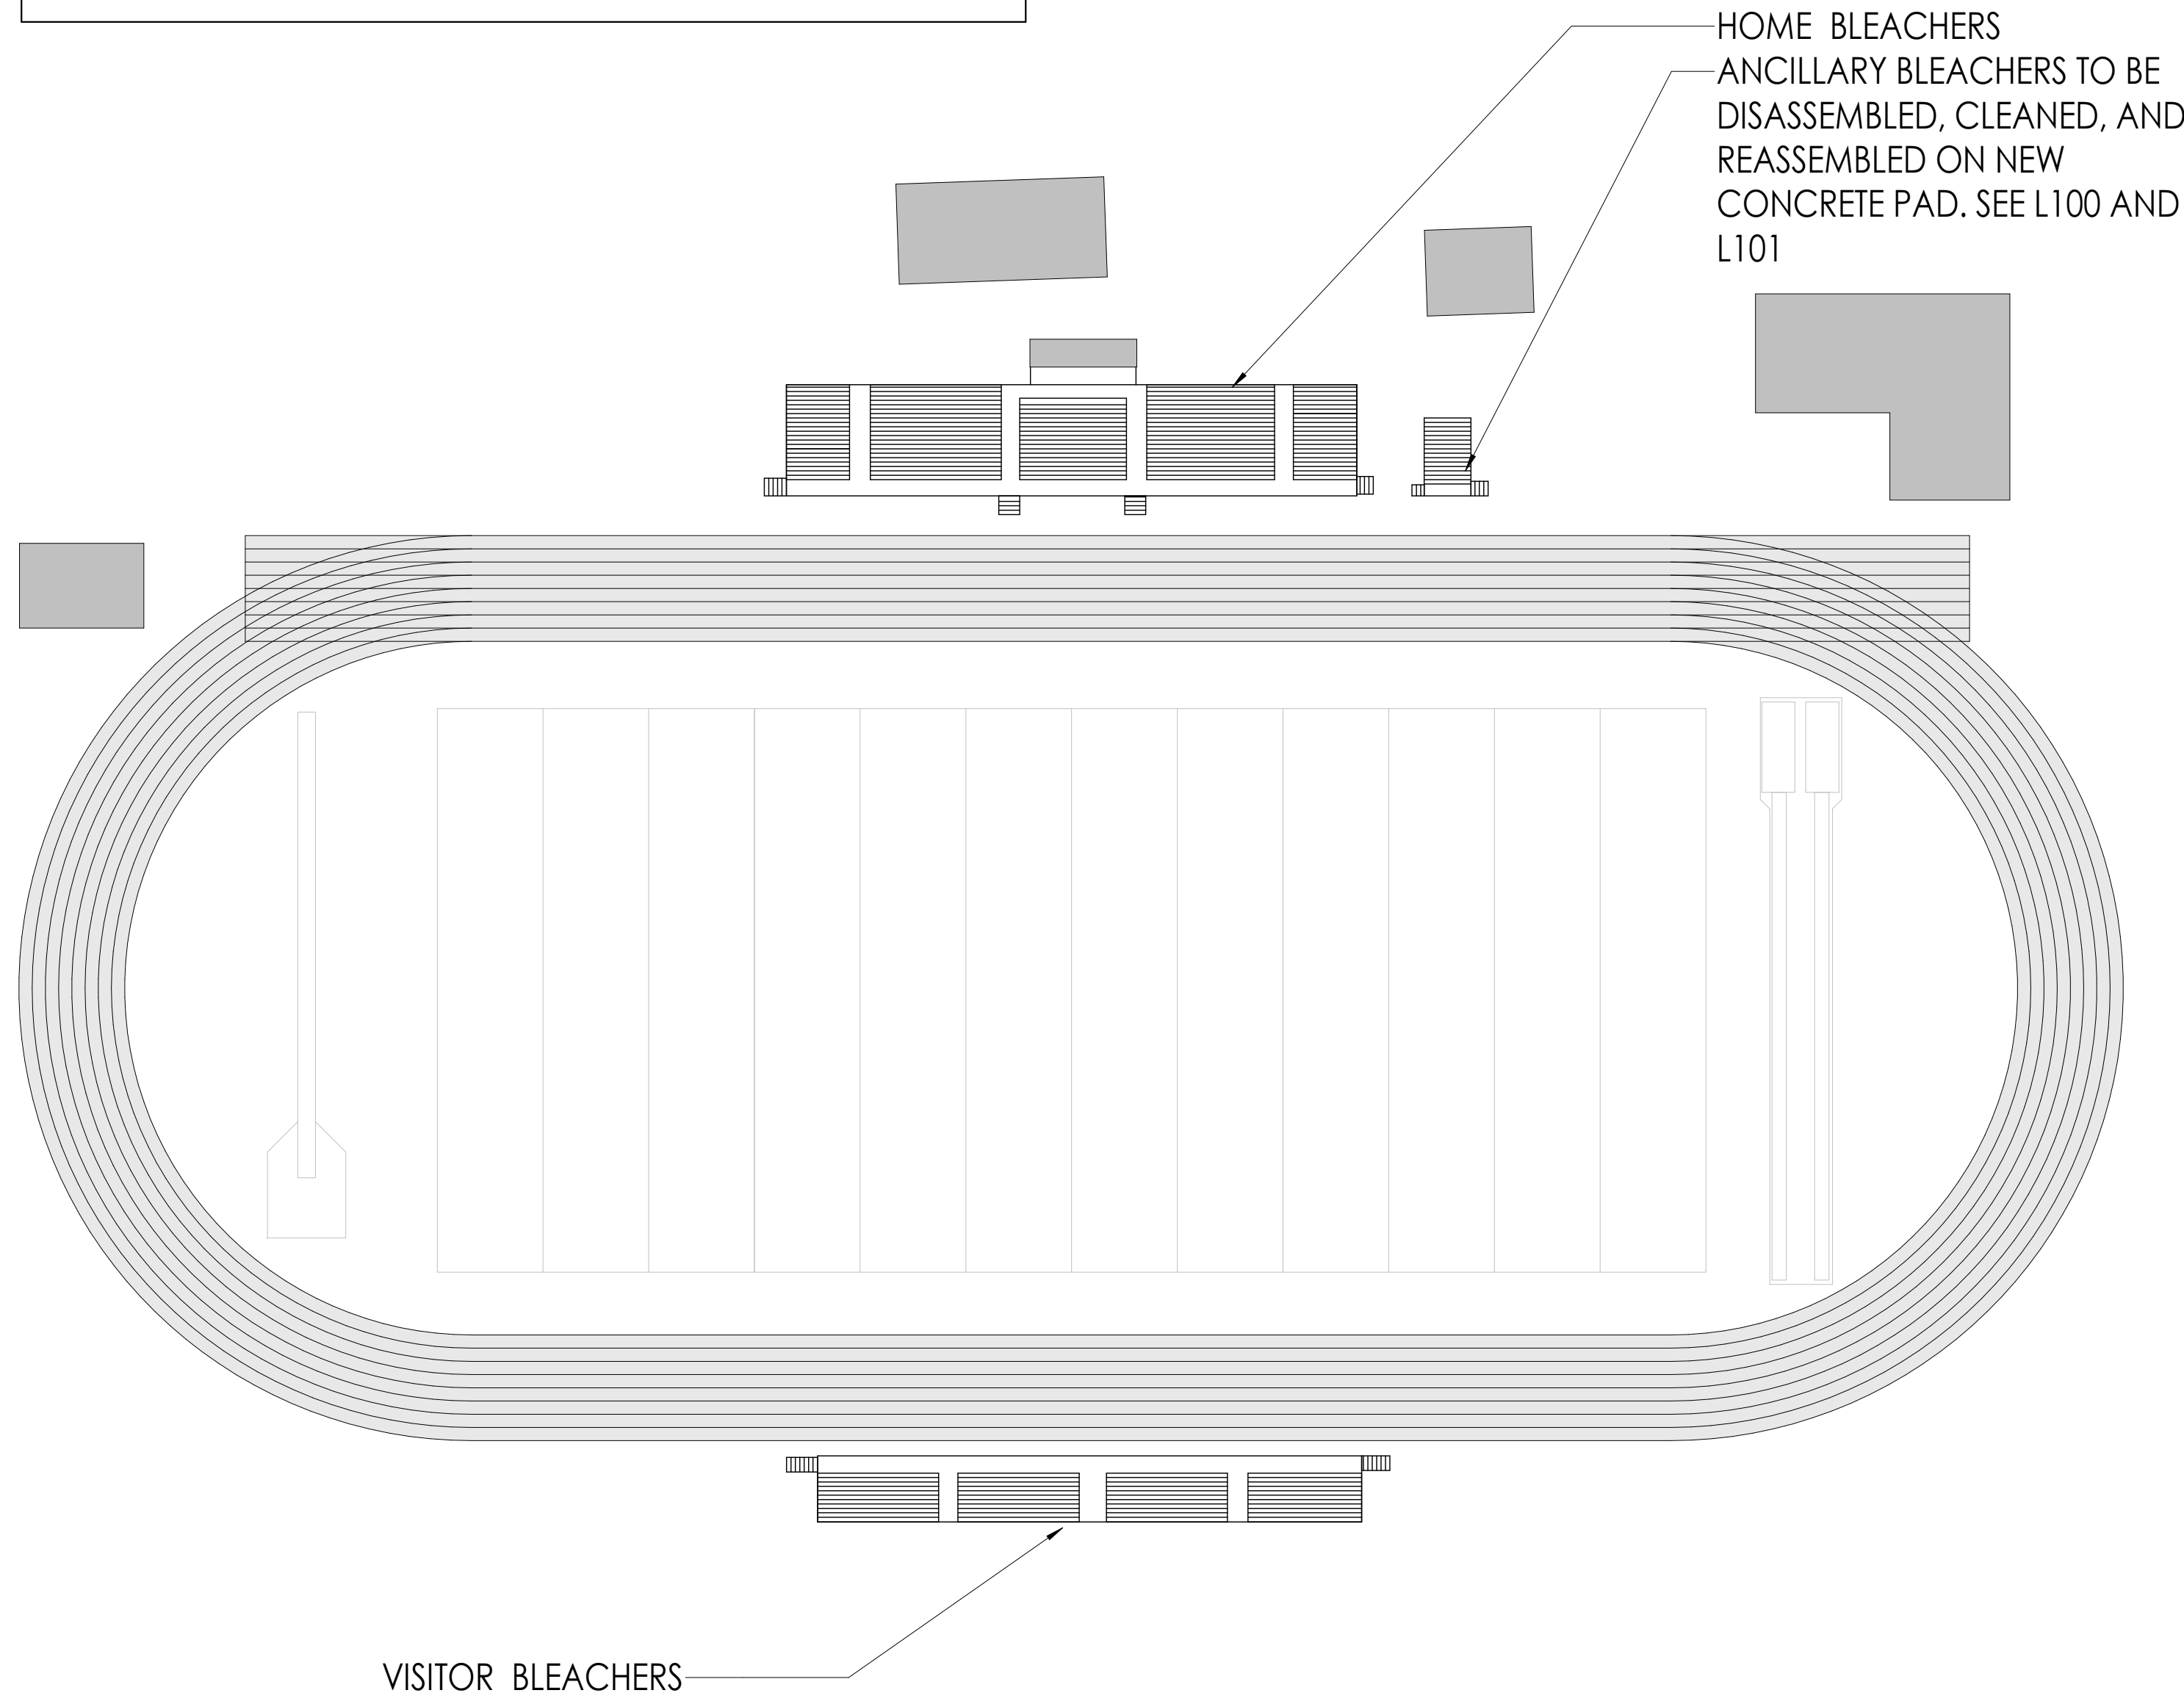

PROJECT INFORMATION

Project Number
R22.16900.00


Client Name
WILSON COUNTY SCHOOLS

Project Name
HUNT HS - ATHLETICS RENOVATION
HUNT HIGH SCHOOL

Project Address
4559 Lamm Rd, Wilson, NC 27893

PROJECT ISSUE & REVISION SCHEDULE

No.	Date	Description

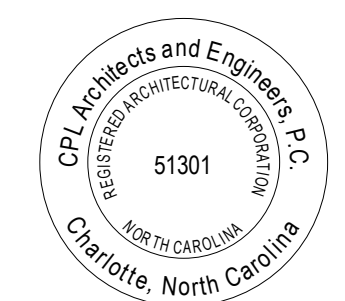

SHEET INFORMATION

Issued
09.15.2023

Scale
As indicated

Project Status
100% CONSTRUCTION DOCUMENTS


Drawn By
EG

Checked By
GB

Drawing Title
BLEACHER RENOVATION

Drawing Number

A002

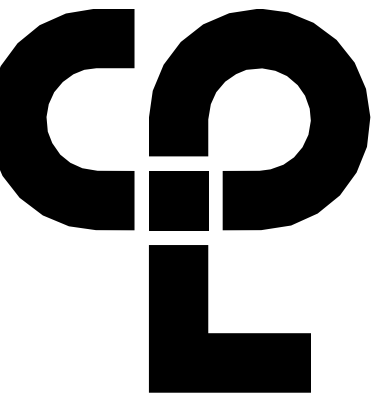

FLOOR PLAN GENERAL NOTES

1. ALL DRAWINGS ARE GRAPHIC REPRESENTATIONS OF APPROXIMATE LOCATIONS OF NEW MATERIALS. IT IS THE CONTRACTOR'S RESPONSIBILITY TO FIELD VERIFY ALL EXISTING CONDITIONS PRIOR TO COMMENCEMENT OF WORK.
2. ALL WALL DIMENSIONS INDICATED ON FLOOR PLANS ARE TO FINISHED FACE OF WALL TO FINISHED FACE OF WALL UNLESS OTHERWISE NOTED.
3. SEE A400 FOR INTERIOR AND EXTERIOR DOORS.
4. WORK AREAS SHALL BE MAINTAINED AND ALL WORK AREAS SHALL BE LEFT BROOMED CLEAN AT END OF EACH DAY.
5. COORDINATE WITH OTHER TRADES FOR SEQUENCING OF WORK.
6. REFER TO A700s FOR TYPICAL FIXTURE MOUNTING HEIGHTS AND ACCESSORIES LEGEND.
7. REFER TO A700s FOR FINISH AND INSTALL SCOPE OF EQUIPMENT AND ACCESSORIES.
8. EQUIPMENT SHOWN ON THESE DOCUMENTS ARE FOR REFERENCE ONLY AND ARE FOR COORDINATION OF M.E.P. INFRASTRUCTURE TO OPERATE ITEMS INCLUDED UNDER THE SCOPE.
9. REFER TO OWNER FURNISHED EQUIPMENT DRAWINGS AND SUBMITTALS FOR FINAL COORDINATION AND INSTALLATION REQUIREMENTS INCLUDING BUT NOT LIMITED TO: DIMENSIONS, LOCATIONS & MEP CONNECTION LOCATION.
10. ALL FURNITURE IS PROVIDED BY OWNER UNLESS NOTED OTHERWISE.
11. PATCH AND FINISH ALL EXISTING WALLS TO REMAIN WITHIN THE PROJECT LIMIT AREA TO RECEIVE SPECIFIED FINISHES.
12. ALL EXISTING EXPANSION JOINT COVERS OR ASSEMBLIES ARE TO BE PROTECTED AND MAINTAINED DURING THE COURSE OF CONSTRUCTION UNLESS OTHERWISE NOTED.
13. ANY EXPOSED PLUMBING IN THE RESTROOMS NEEDS TO BE ROUTED THROUGH THE PLUMBING CHASE ROOM 002.
14. ANY EXPOSED CONDUIT NEEDS TO ROUTE THROUGH ABOVE CEILING WHERE POSSIBLE, OR BE REPLACED WITH NEW.

FLOOR PLAN LEGEND

NOTE: THIS LEGEND MAY CONTAIN SYMBOLS THAT ARE NOT USED IN THE PROJECT

- DOOR DOOR TARGET, SEE SCHEDULE
- ROOM NAME ROOM TAG
- WATER HEATER
- SECTION MARK
- INTERIOR ELEVATION MARK
- EXTERIOR ELEVATION MARK
- DETAIL FOR REFERENCE MARK
- WALL TYPE SEE A/400
- NEW FIRE EXTINGUISHER WALL MOUNTED WITH BRACKET

PROJECT INFORMATION

Project Number
R22.1.6900.00


Client Name
WILSON COUNTY SCHOOLS

Project Name
HUNT HS - ATHLETICS RENOVATION
HUNT HIGH SCHOOL


Project Address
4559 Lamm Rd, Wilson, NC 27893

PROJECT ISSUE & REVISION SCHEDULE


No. Date Description

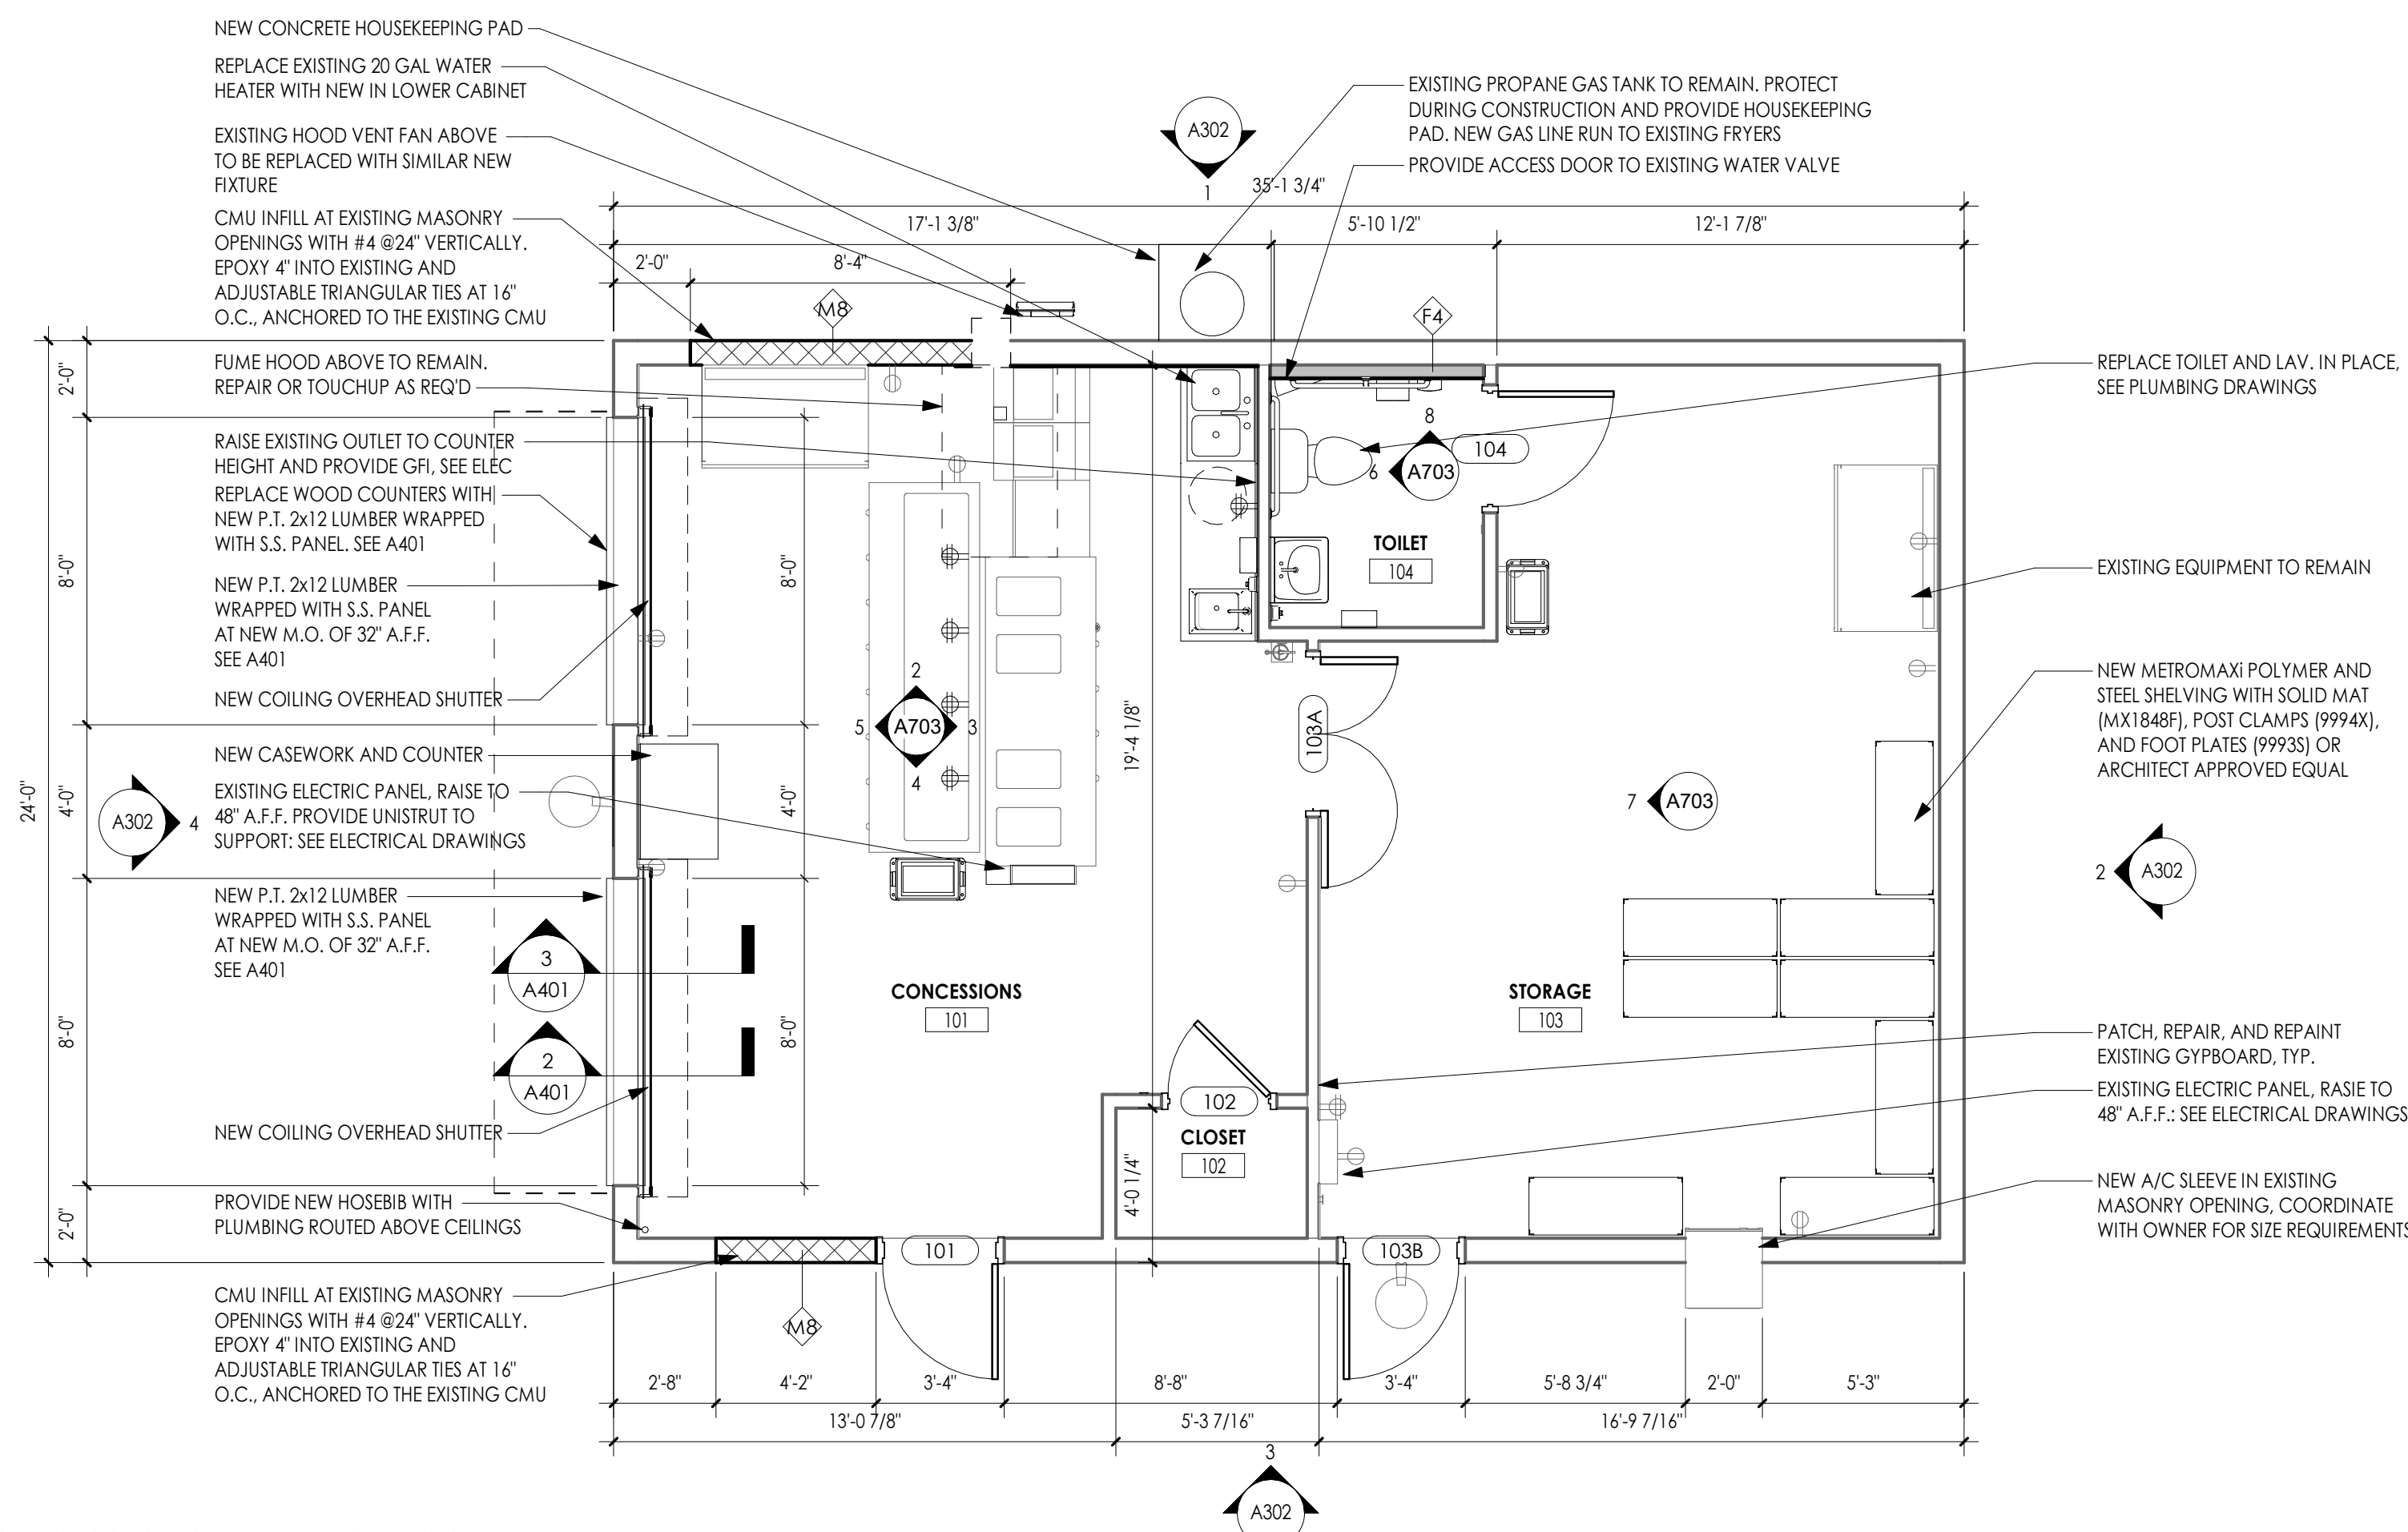

2 **A101** **CONCESSIONS BUILDING FLOOR PLAN**
1/4" = 1'-0"
TRUE NORTH

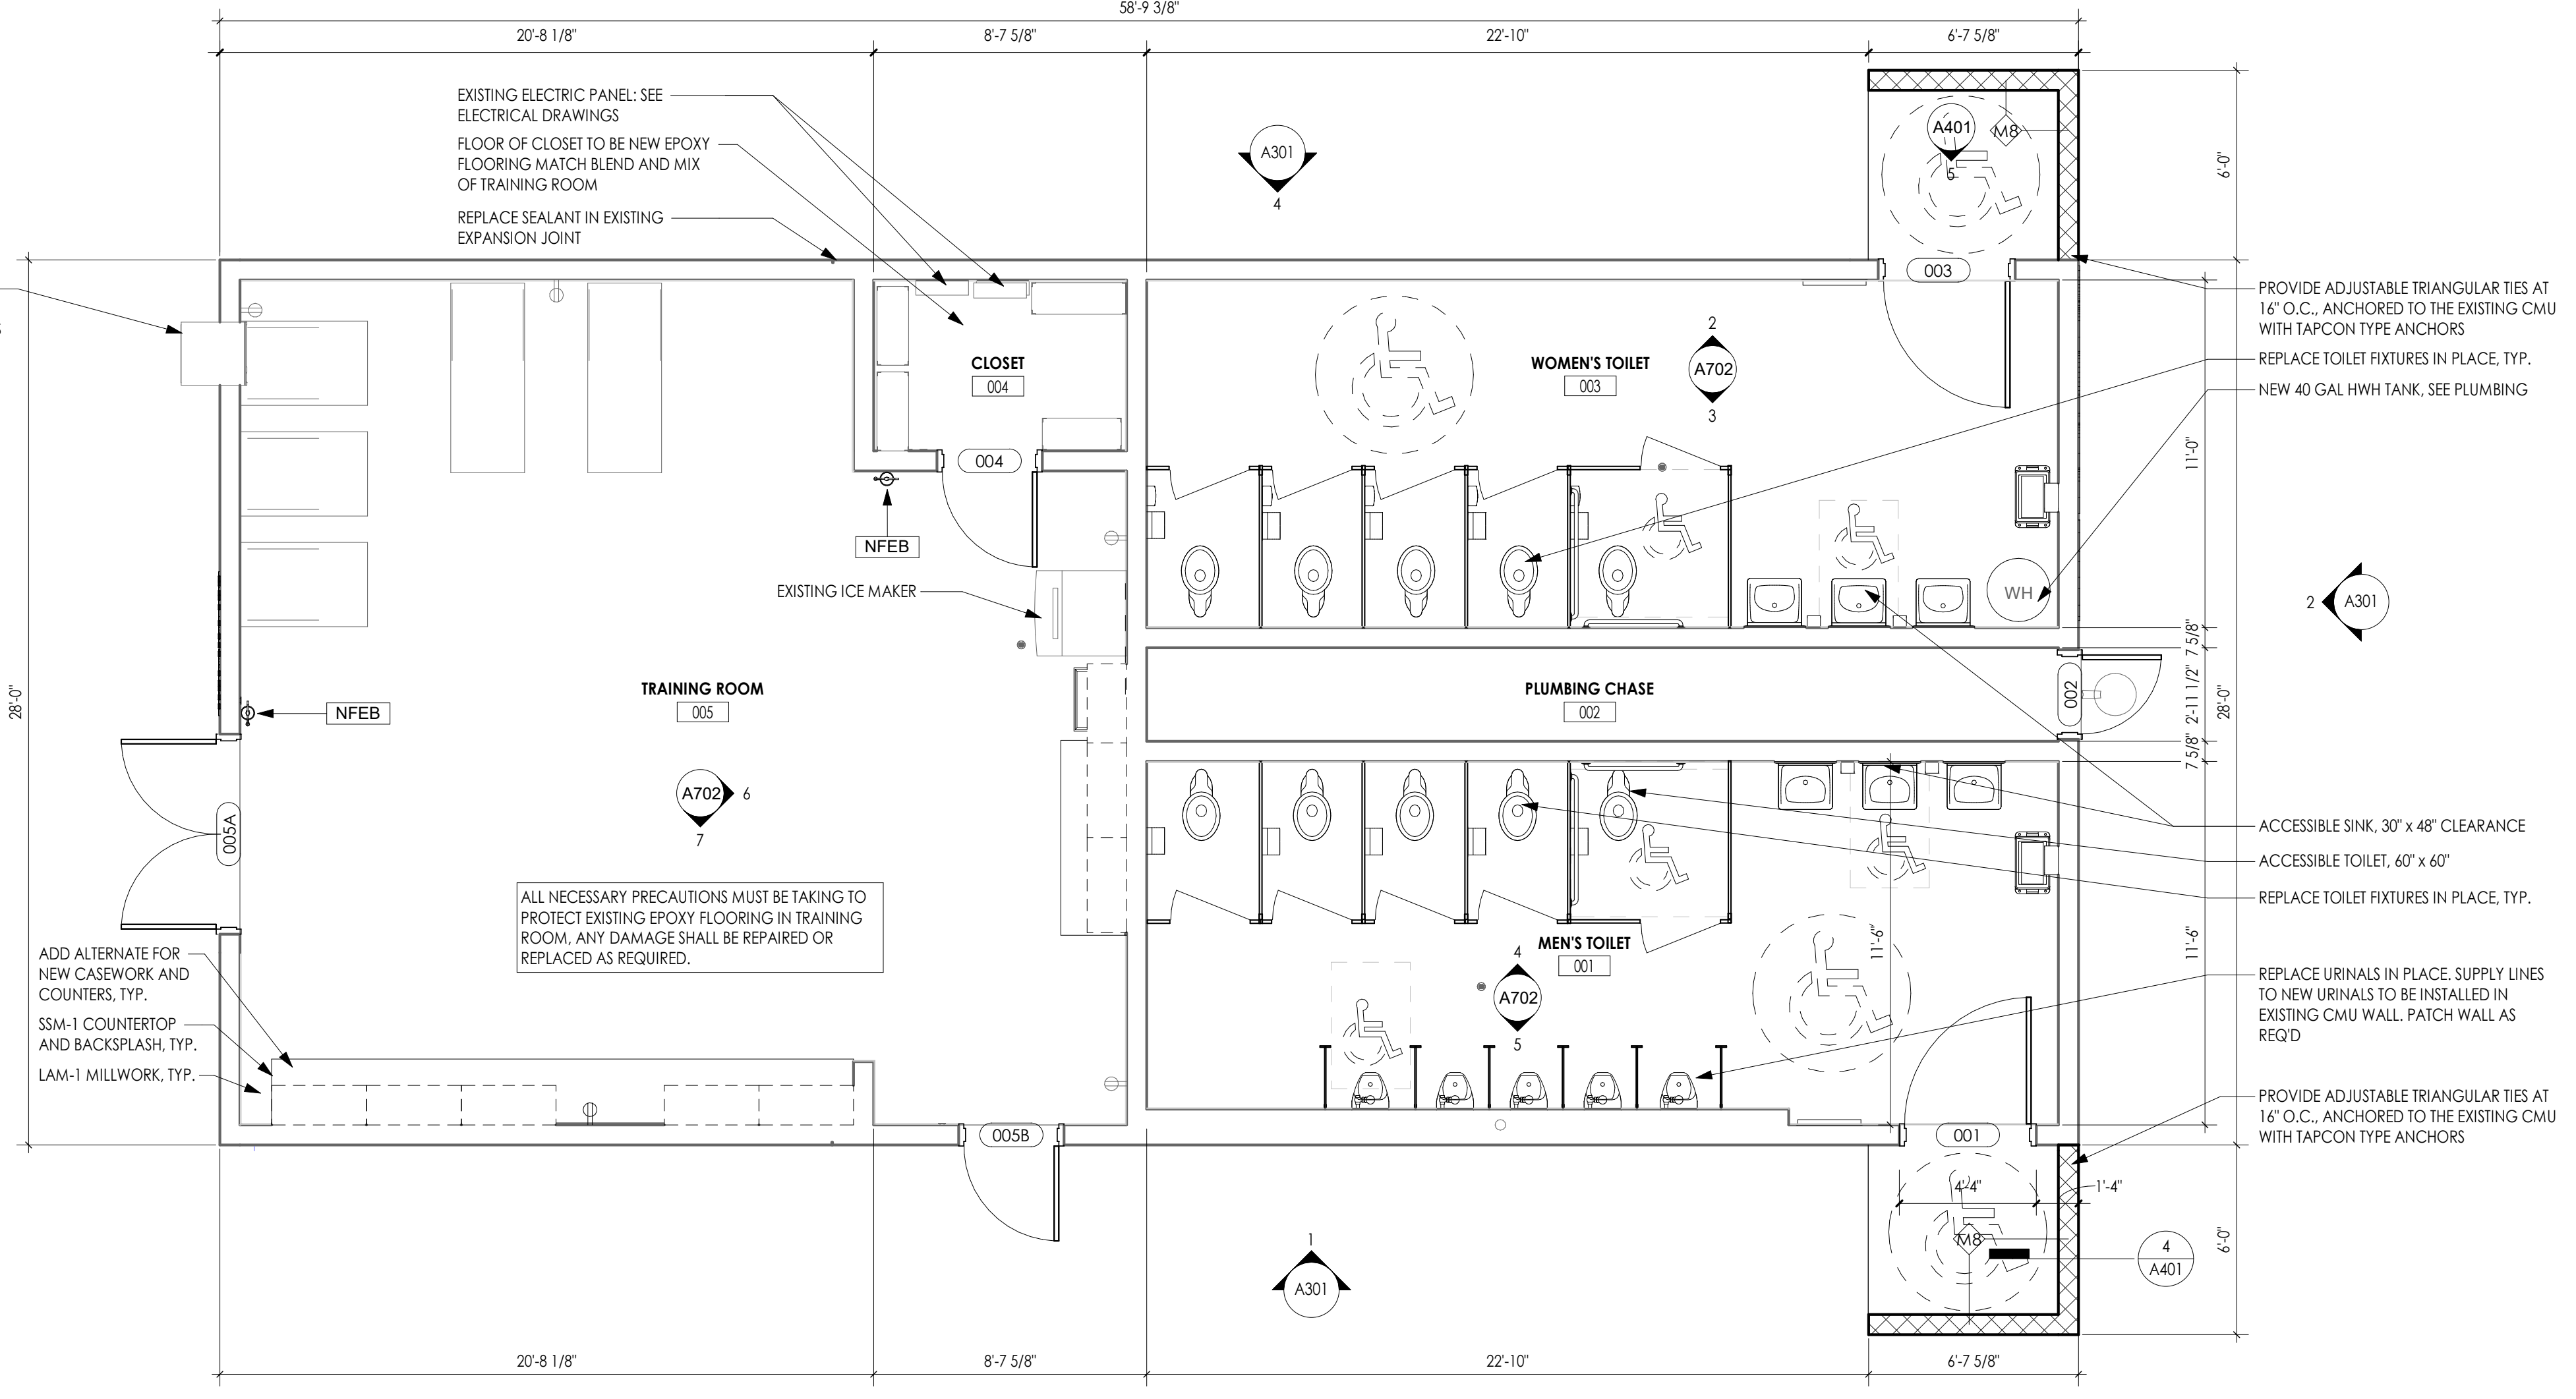

1 **A101** **RESTROOM BUILDING FLOOR PLAN**
1/4" = 1'-0"
TRUE NORTH

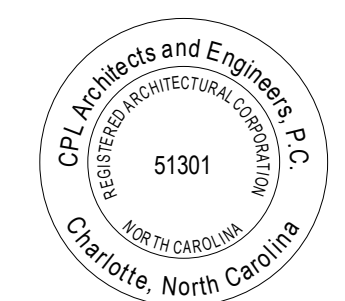

SHEET INFORMATION


Issued 09.15.2023 Scale As Indicated

Project Status 100% CONSTRUCTION DOCUMENTS

Drawn By EG Checked By GB

Drawing Title OVERALL FLOOR PLANS

Drawing Number

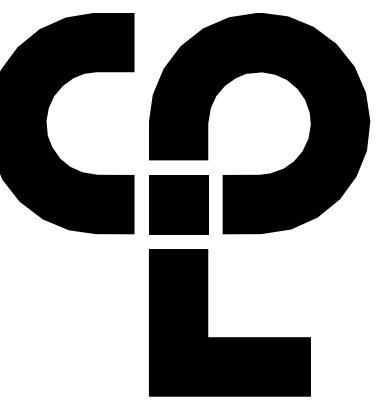


ROOF PLAN GENERAL NOTES


1. ALL DRAWINGS ARE GRAPHIC REPRESENTATIONS OF APPROXIMATE LOCATIONS OF MATERIALS. FIELD VERIFY ALL CONDITIONS PRIOR TO THE COMMENCEMENT OF WORK. REFER TO ALL DRAWINGS IN THE SET FOR LOCATIONS OF ALL ROOF PENETRATIONS. PROVIDE FRAMING AS REQUIRED.
2. PAINT ALL ROOF FASTENERS EXPOSED TO VIEW AT UNDERSIDE OF DECK TO MATCH.
3. WORK AREAS SHALL BE MAINTAINED AND ALL WORK AREAS SHALL BE BROOM CLEAN AT THE END OF EACH DAY.
4. ALL WOOD BLOCKING USED SHALL BE PRESSURE TREATED.
5. THE ROOF ELEVATIONS SHOWN ON THE PLAN ARE SHOWN TO ESTABLISH RELATIVE HEIGHTS OF THE INDIVIDUAL ROOFS.
6. MAINTAIN WATER TIGHTNESS AND PROVIDE PROTECTION AT ANY/ALL OPENINGS IN THE ROOF LEFT AT THE END OF EACH DAY.
7. UPON COMPLETION OF WORK, THE PLUMBING CONTRACTOR SHALL SNAKE OUT ALL ROOF DRAINS AND VERIFY ALL ARE CLEAR AND LEFT IN A FREE FLOWING CONDITION.

ROOF PLAN LEGEND

- VTR VENT THRU ROOF. PROVIDE FLASHING PER ROOF MANUFACTURER'S DETAILS AS REQUIRED
- EXISTING SLOPE ROOF SLOPE

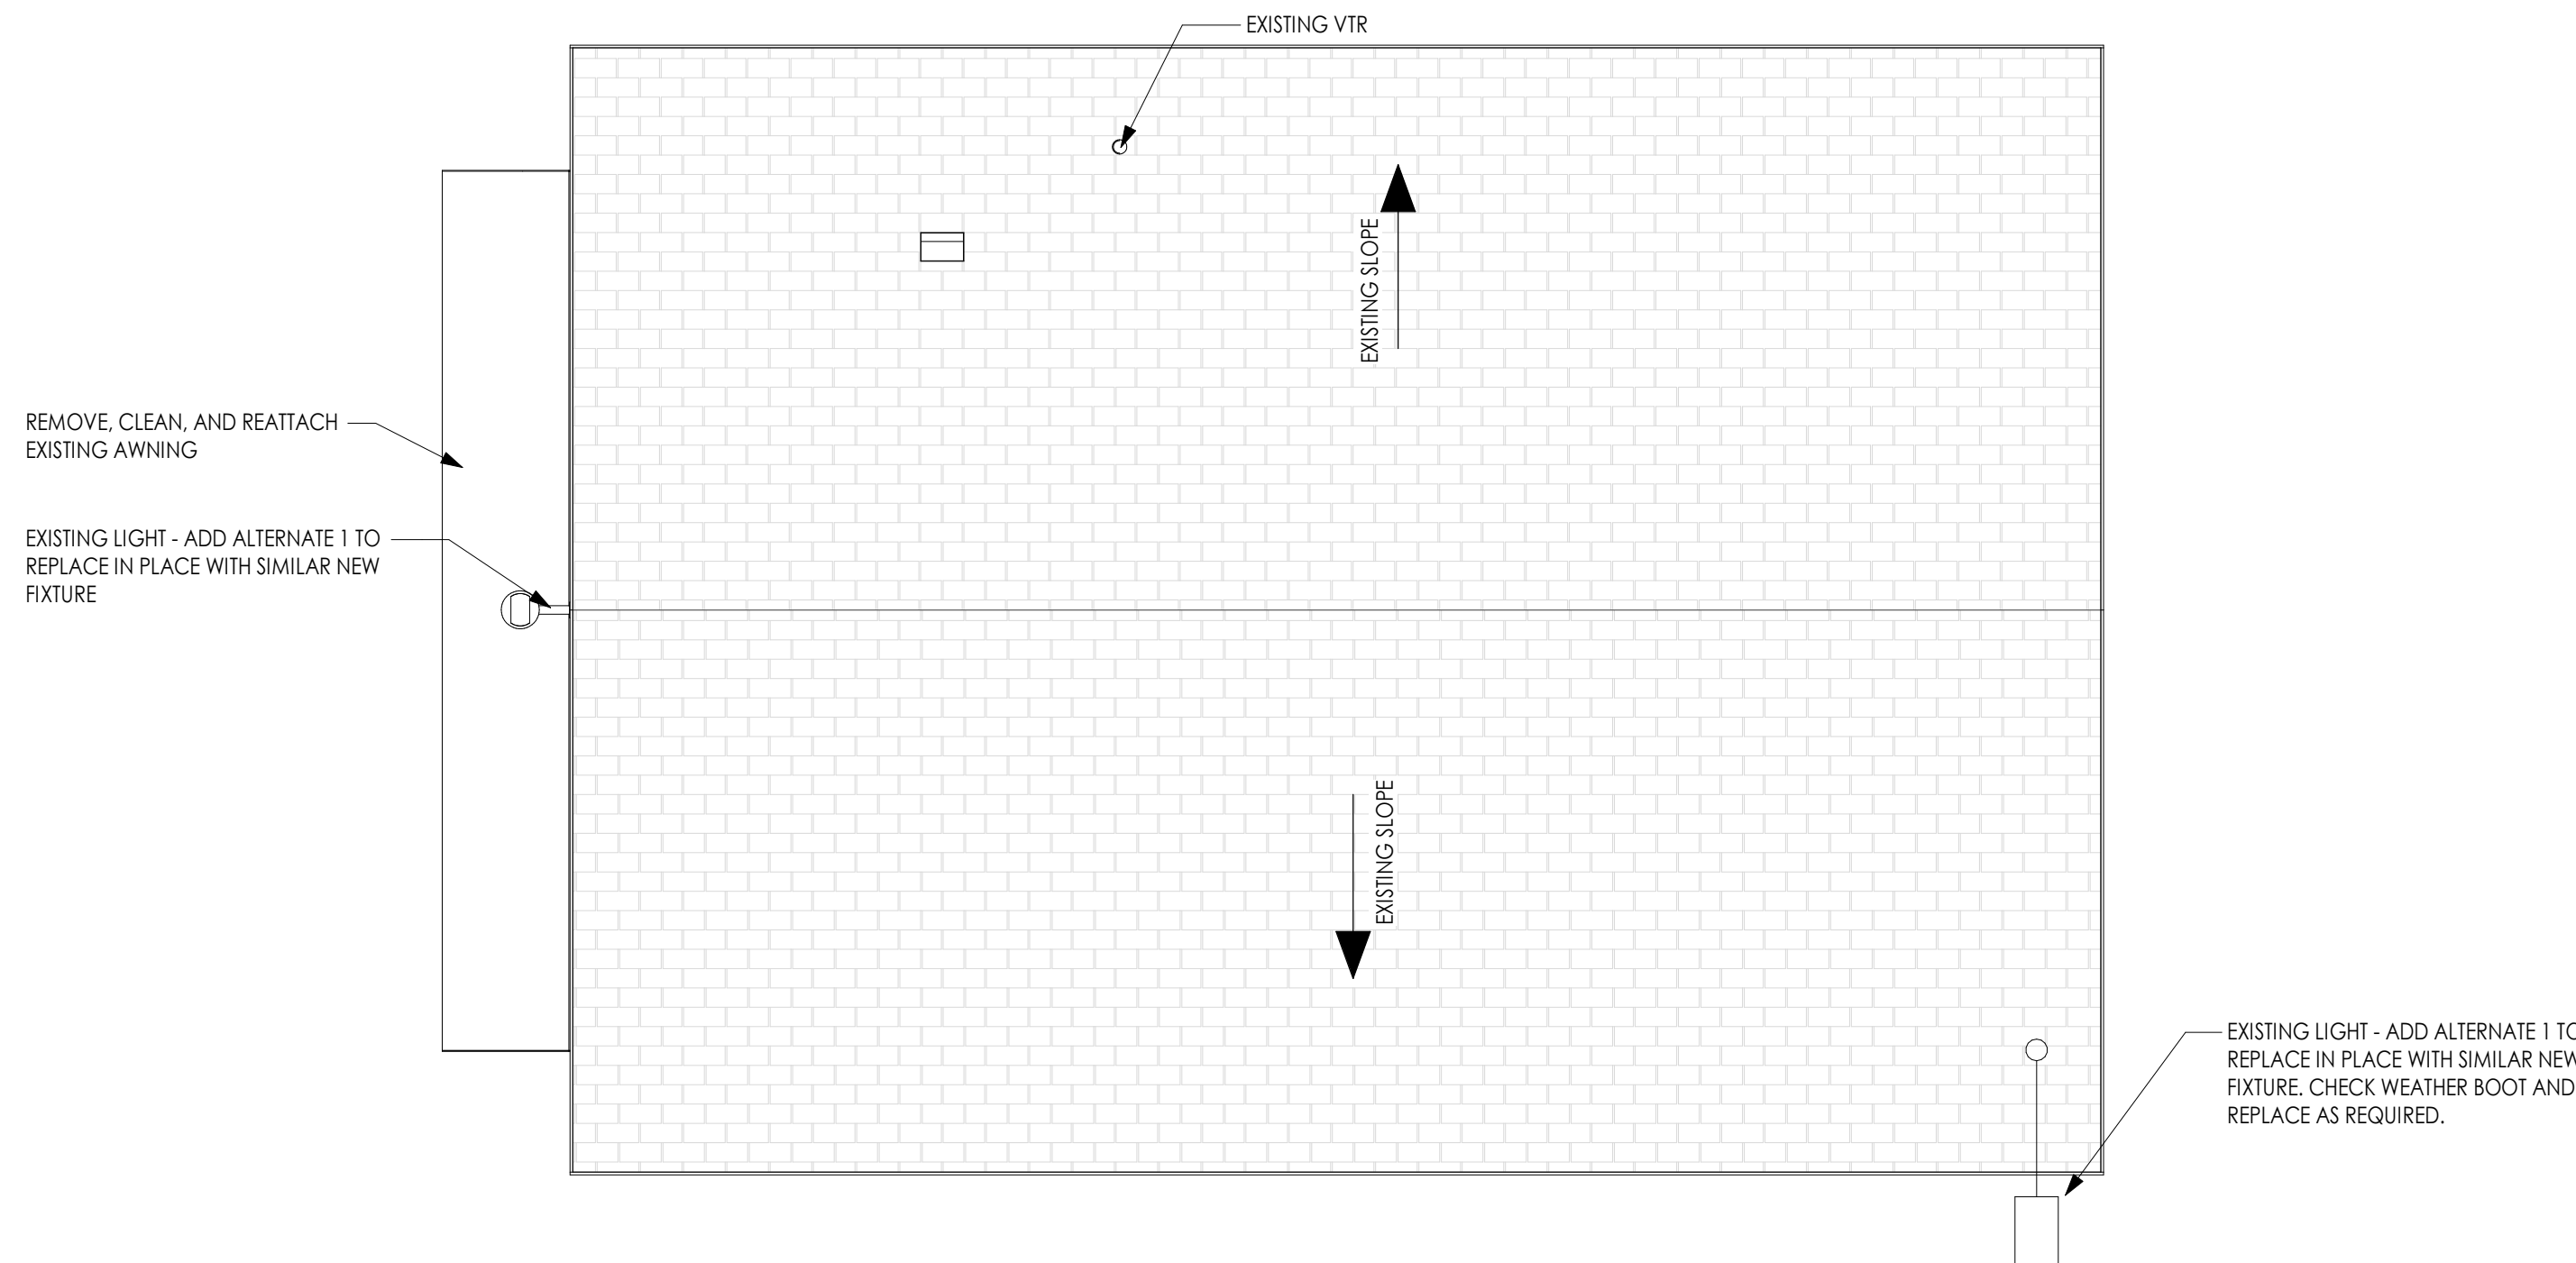

1
2
A201
CONCESSIONS BUILDING ROOF PLAN
1/4" = 1'-0"

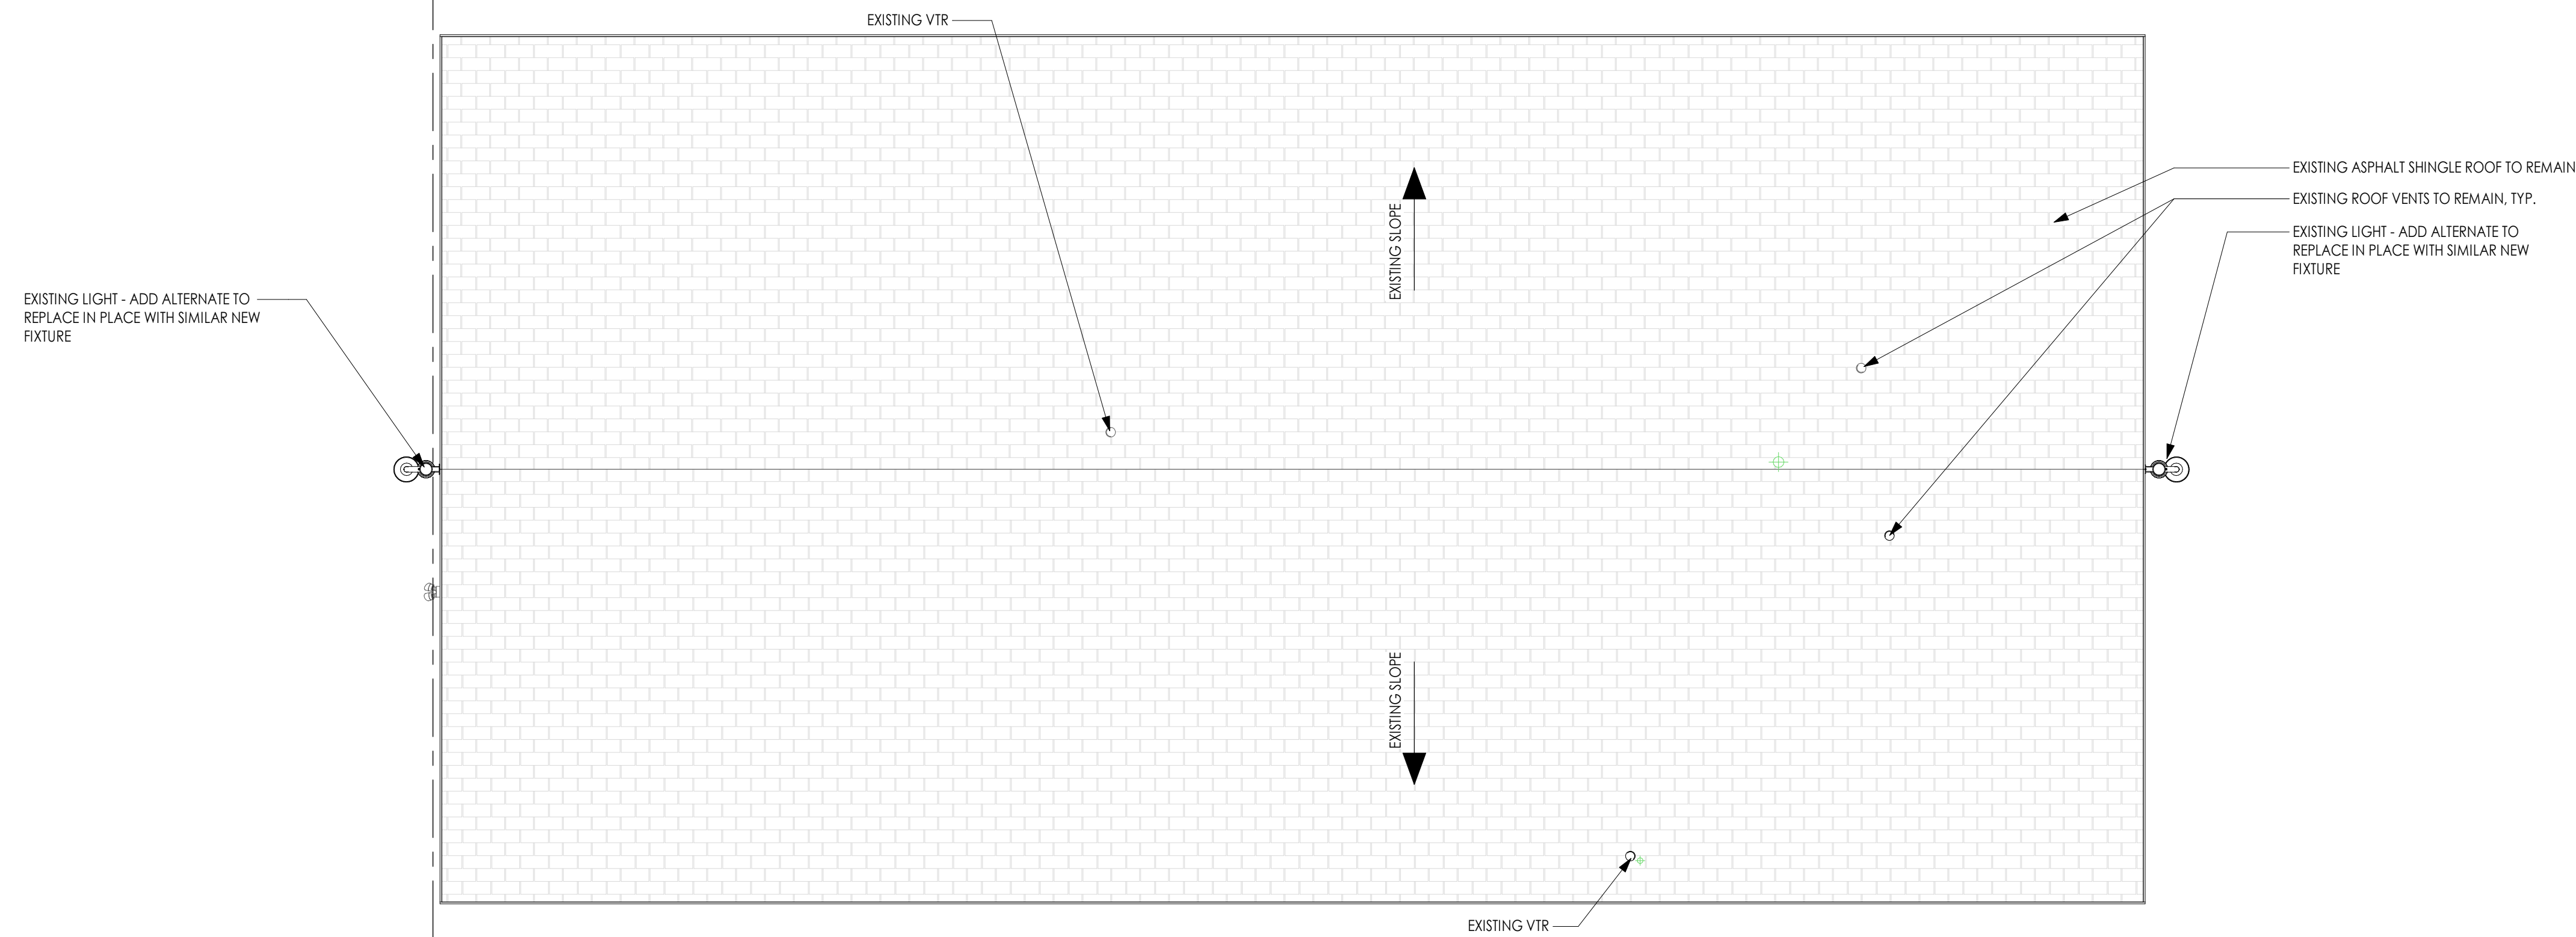

1
A201
RESTROOM BUILDING ROOF PLAN
1/4" = 1'-0"

PROJECT INFORMATION

Project Number
R22.16900.00

Client Name
WILSON COUNTY SCHOOLS

Project Name
HUNT HS - ATHLETICS RENOVATION
HUNT HIGH SCHOOL

Project Address
4559 Lamm Rd, Wilson, NC 27893

PROJECT ISSUE & REVISION SCHEDULE

No. Date Description






SHEET INFORMATION

Issued 09.15.2023 Scale As indicated
Project Status 100% CONSTRUCTION DOCUMENTS
Drawn By EG Checked By GB
Drawing Title OVERALL ROOF PLANS



Drawing Number

A201

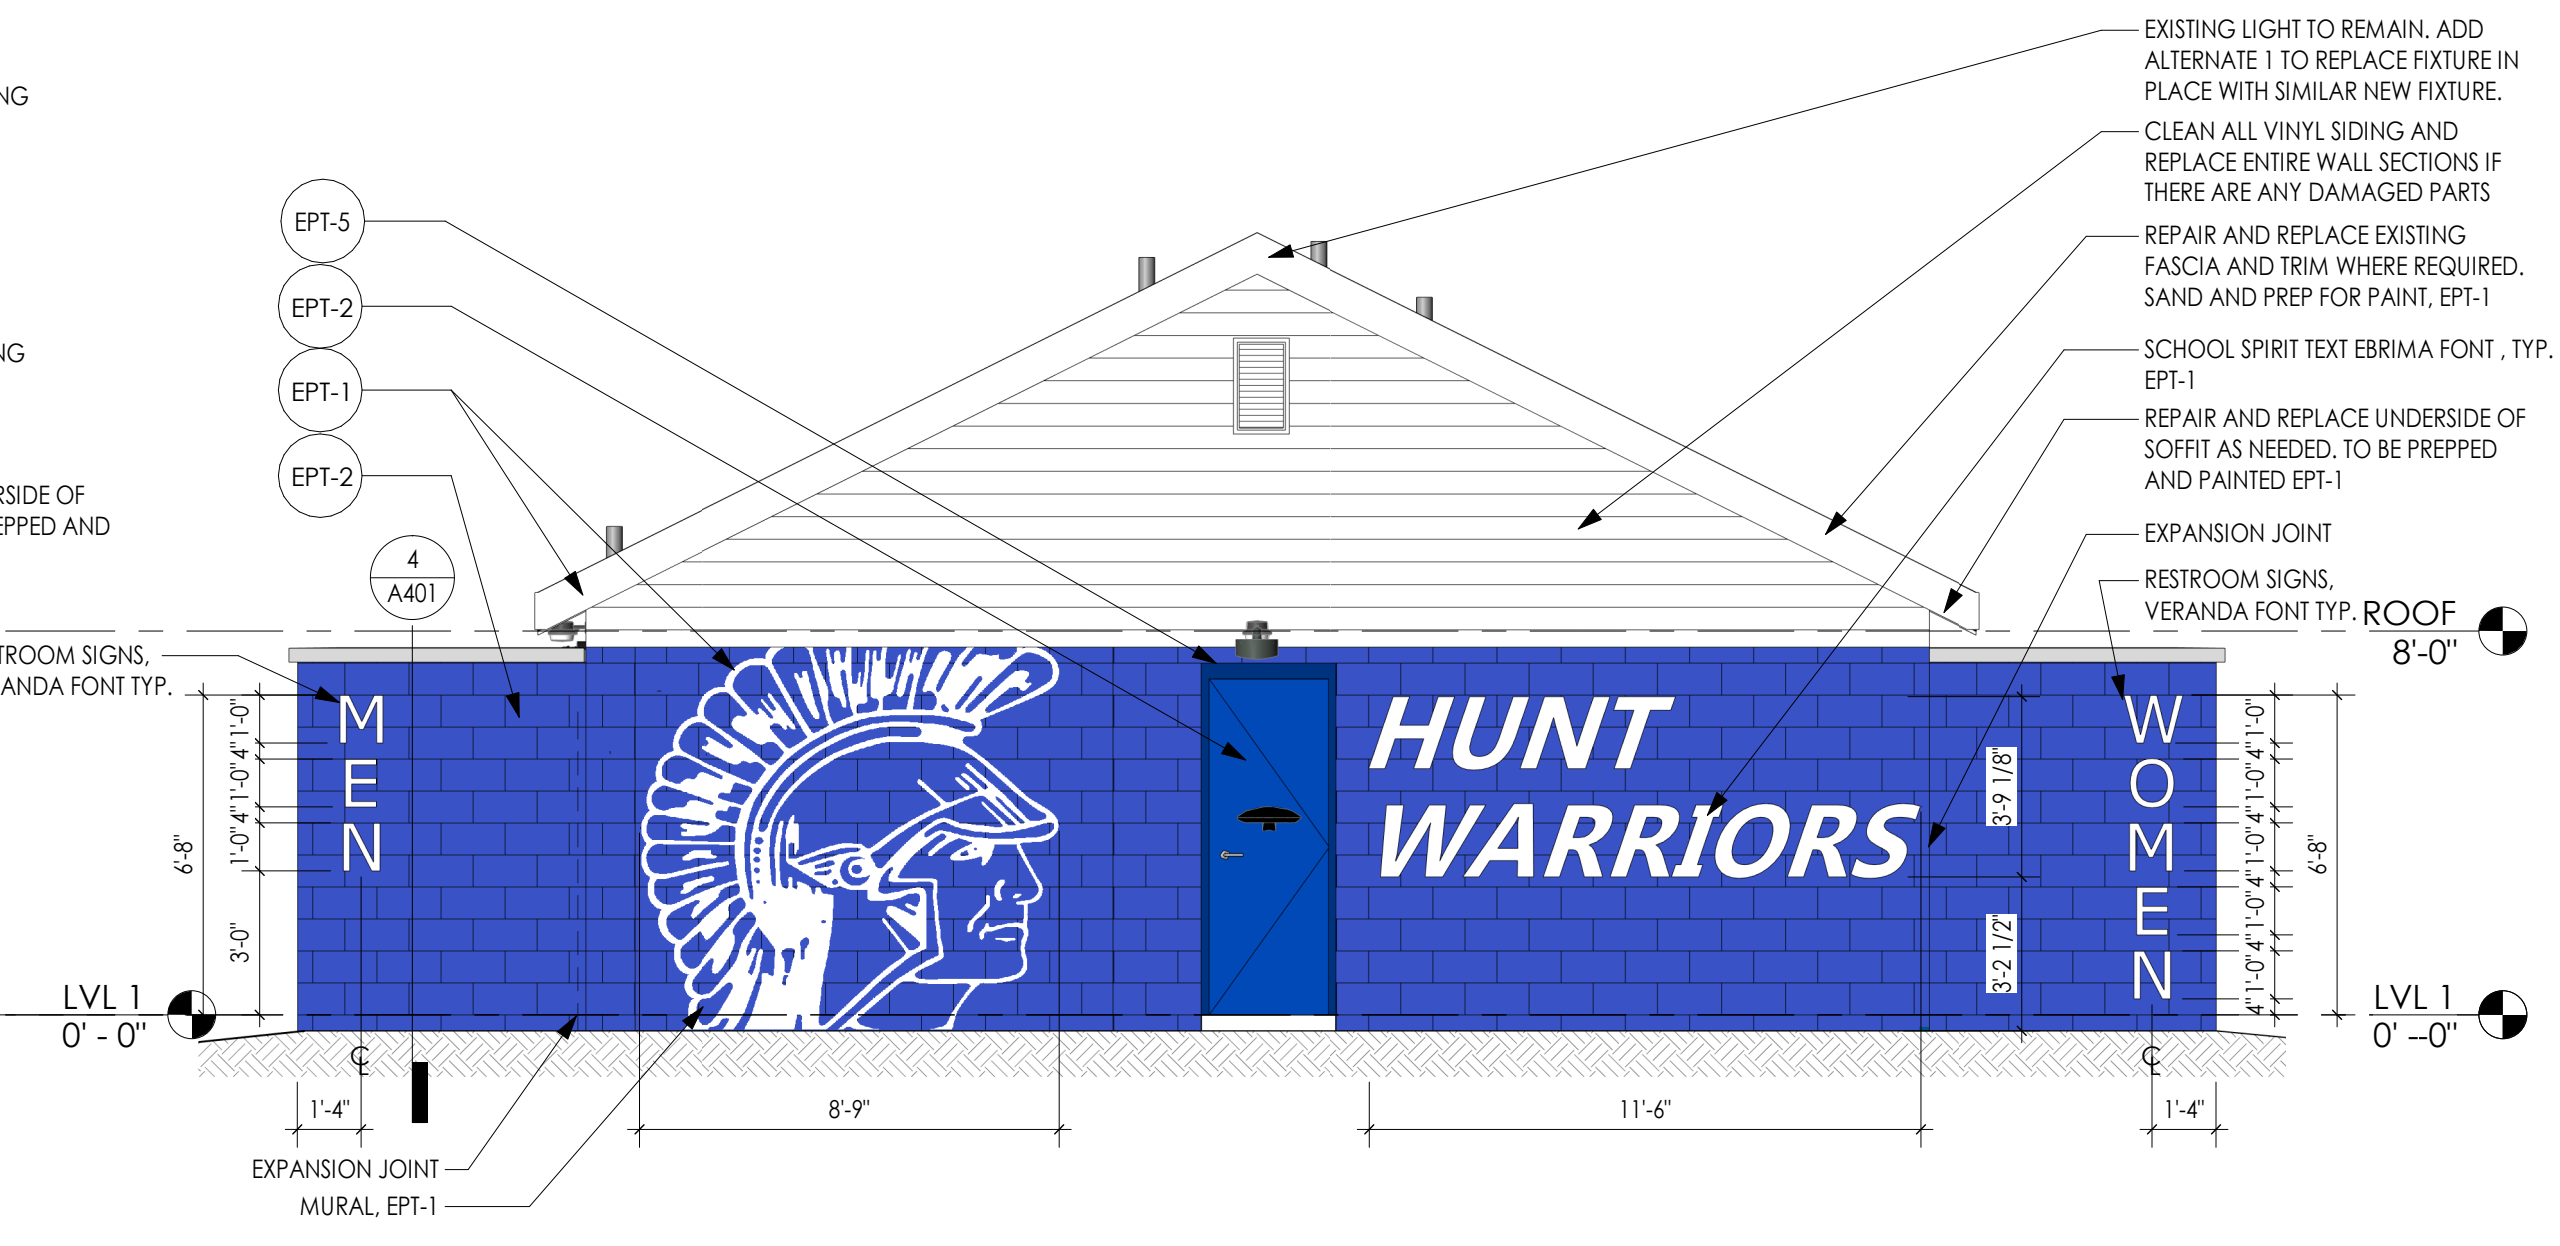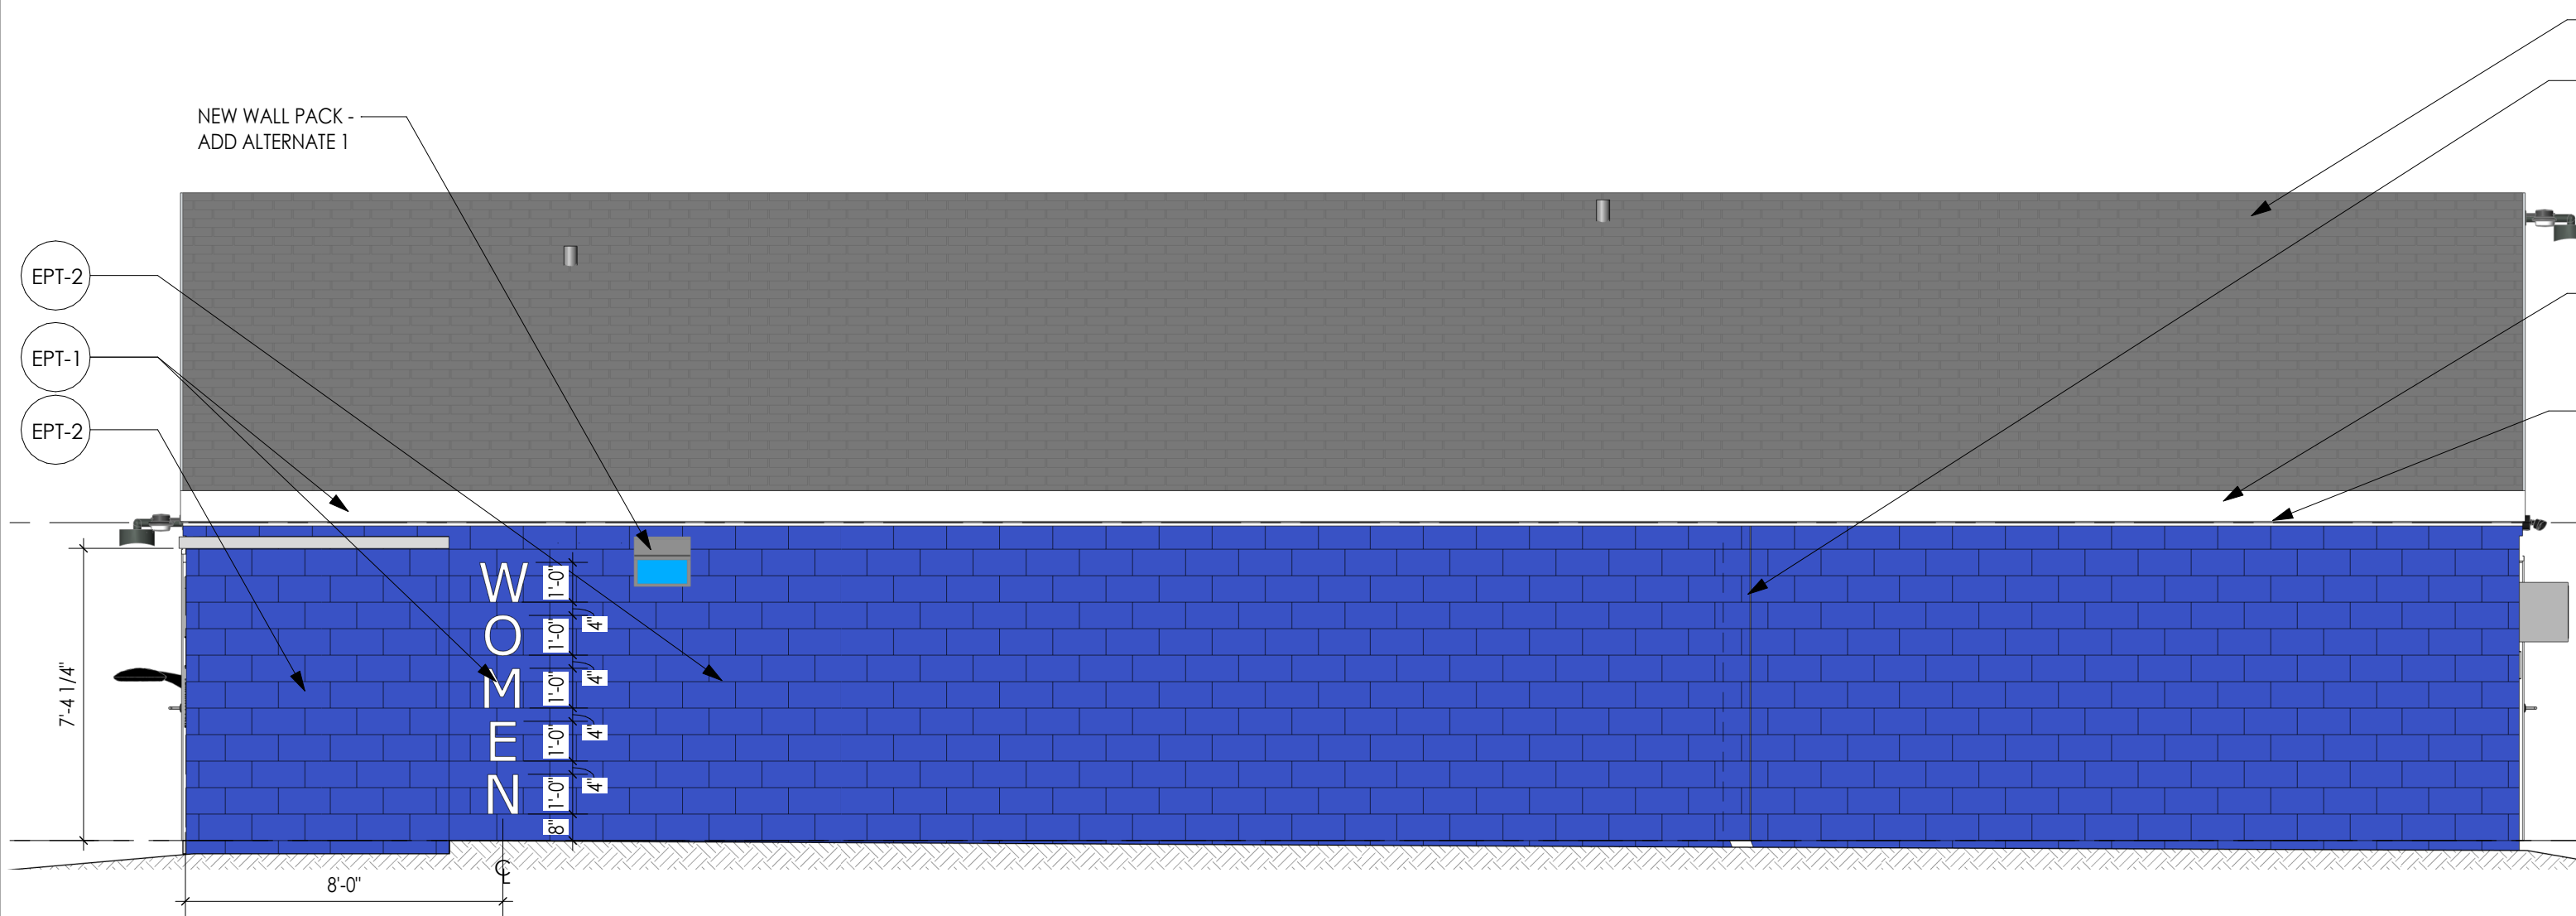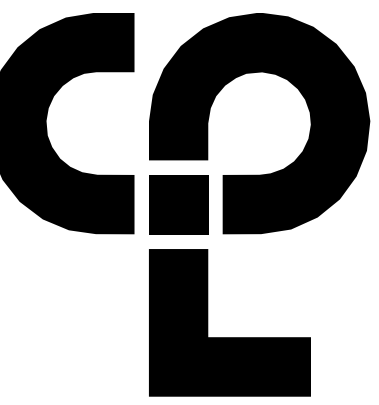

4 RESTROOM BUILDING ELEVATION - WEST
A301 1/4" = 1'-0"

2 RESTROOM BUILDING ELEVATION - NORTH
A301 1/4" = 1'-0"

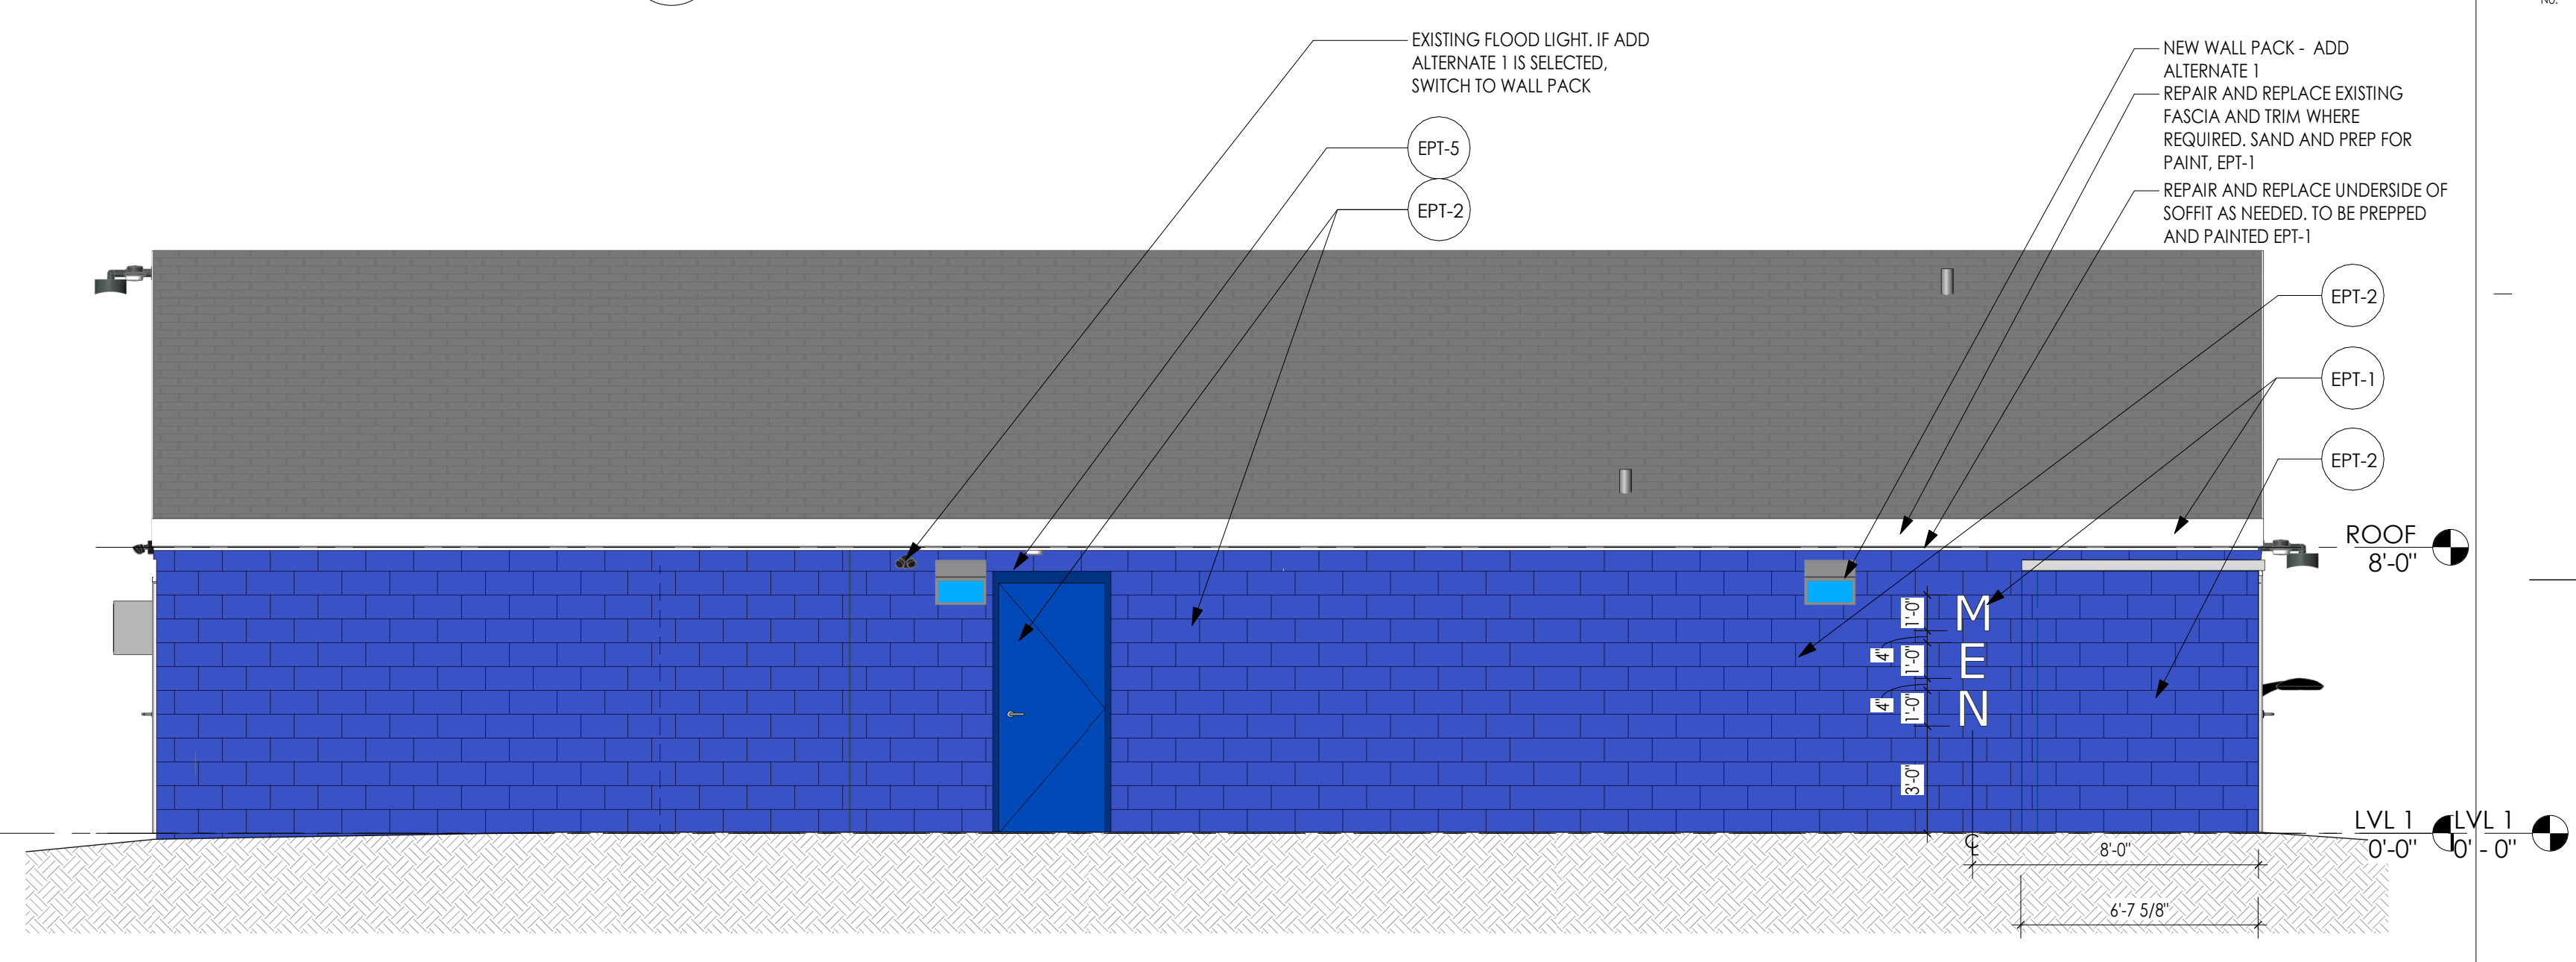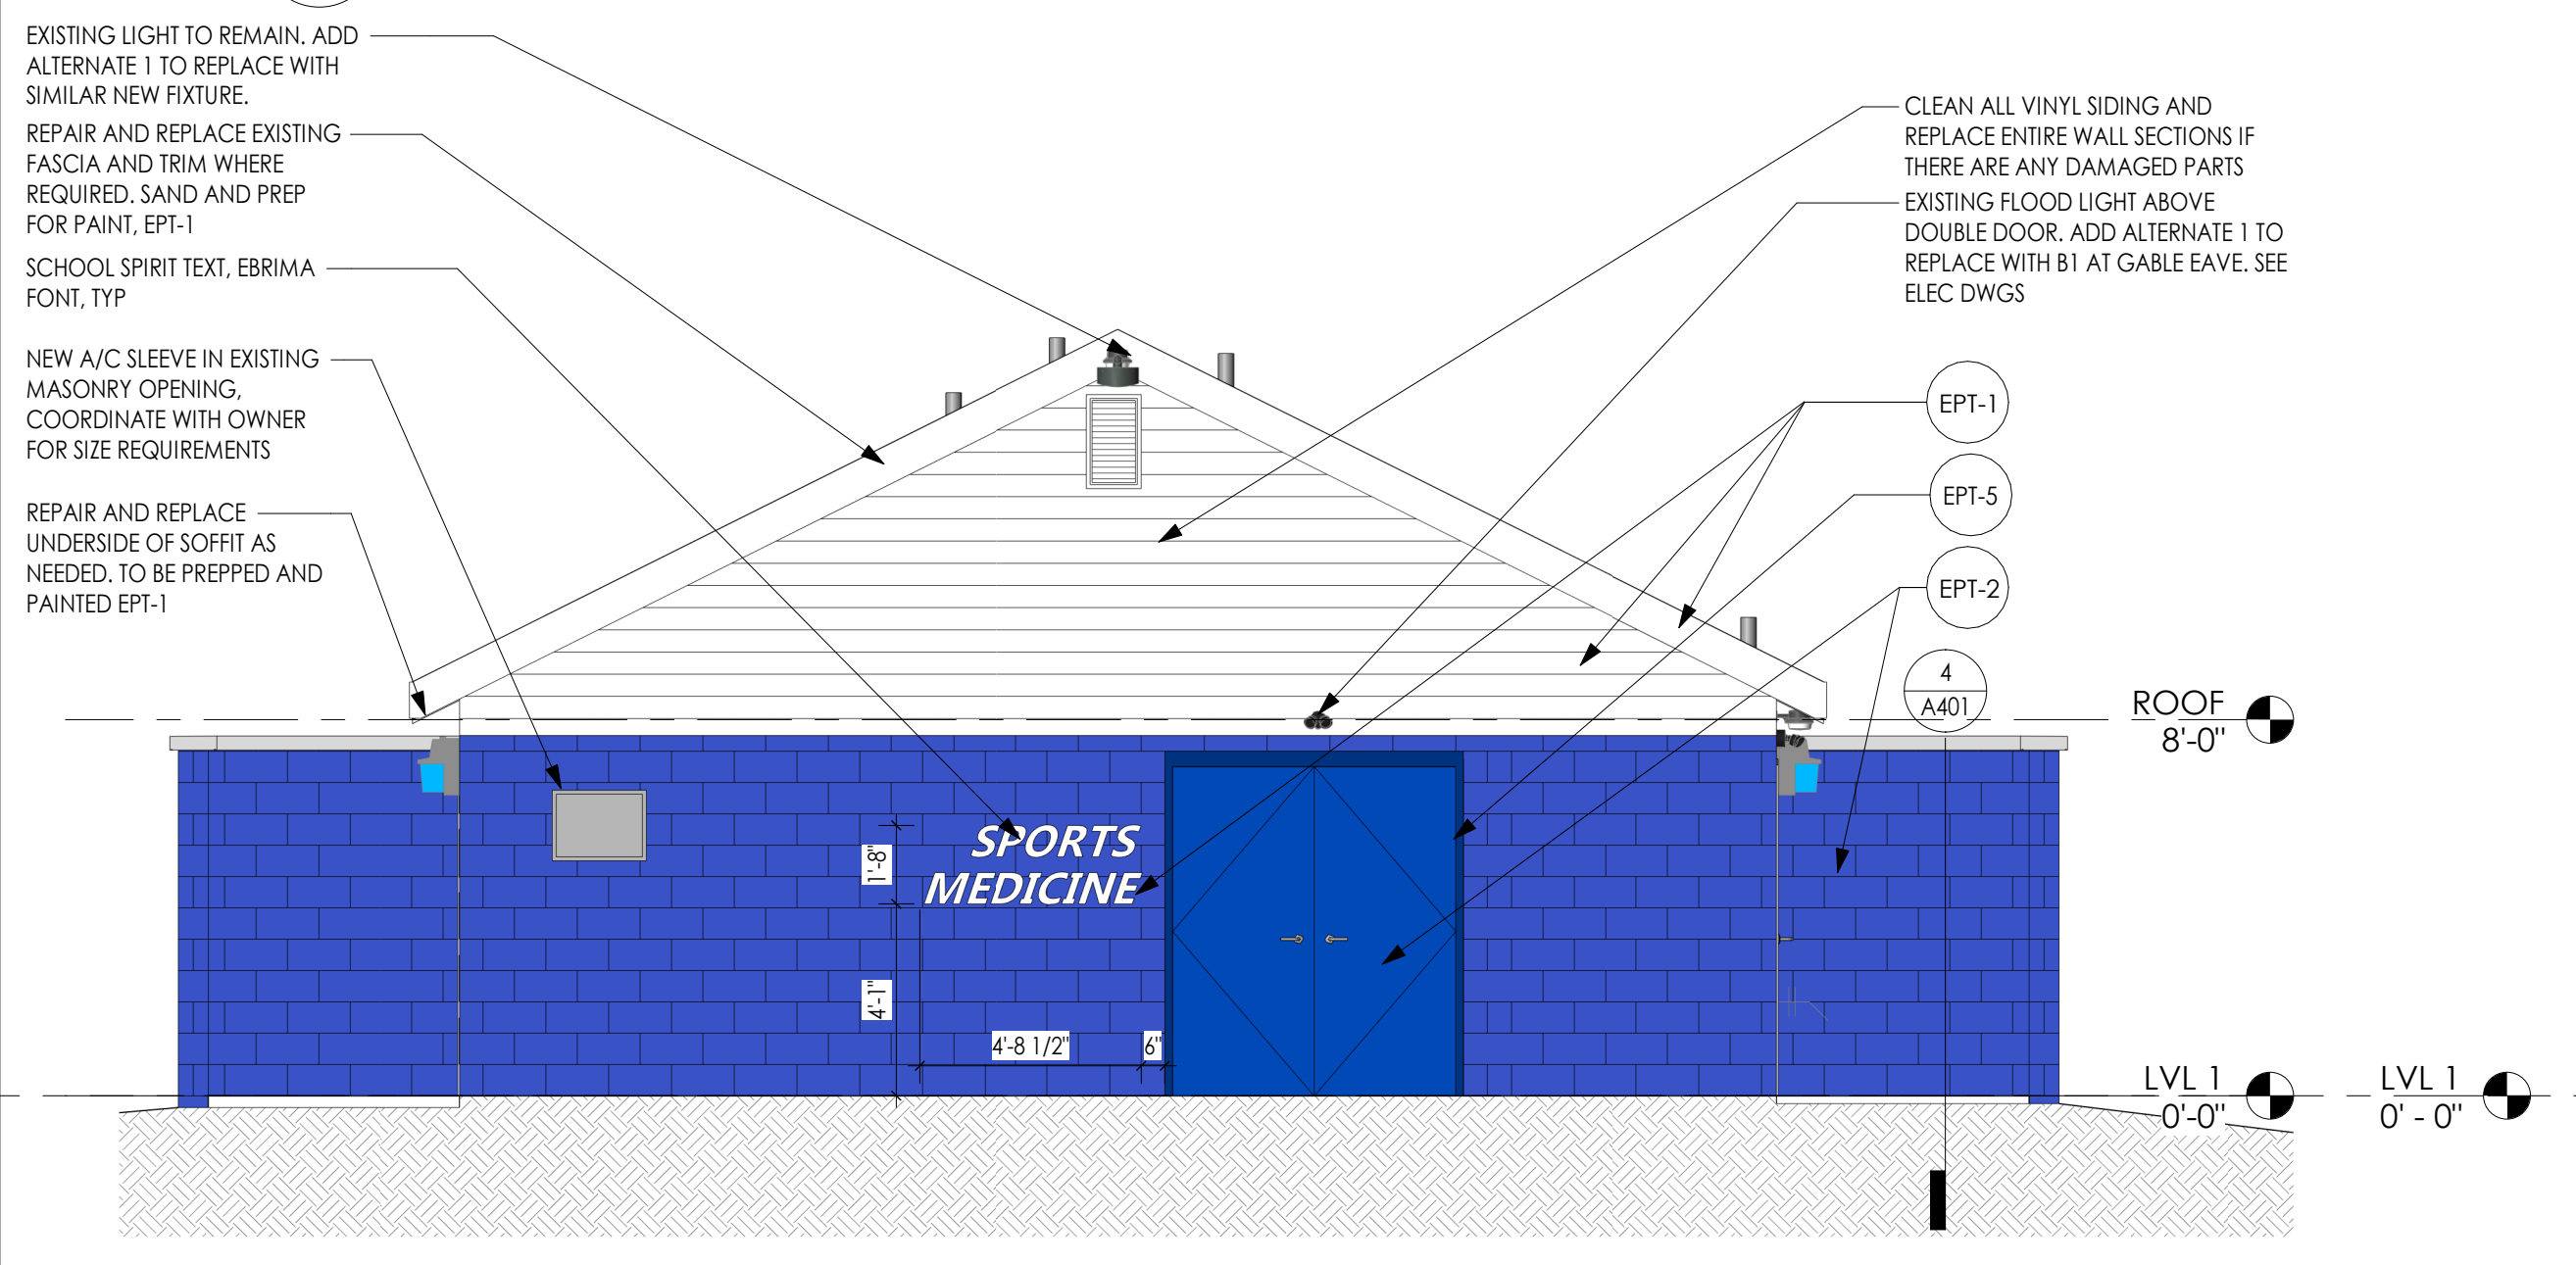

3 RESTROOM BUILDING ELEVATION - SOUTH
A301 1/4" = 1'-0"

1 RESTROOM BUILDING ELEVATION - EAST
A301 1/4" = 1'-0"

ELEVATION LEGEND	
	CAST STONE
	CMU (RUNNING)
	ASPHALT SHINGLE ROOF
	BUILDING EXPANSION JOINT (BE)
	EXPANSION JOINT (EJ)
PAINT COLORS	
EPT-1	- WHITE
EPT-2	- WARRIOR BLUE - PANTONE 288C
EPT-3	- GREY - PANTONE 8C
EPT-4	- BLACK
EPT-5	- DARKER BLUE - PANTONE 289C

ELEVATION GENERAL NOTES	
1.	ALL DRAWINGS ARE GRAPHIC REPRESENTATIONS OF APPROXIMATE LOCATIONS OF EXISTING AND NEW MATERIALS. IT IS THE CONTRACTOR'S RESPONSIBILITY TO FIELD VERIFY ALL EXISTING CONDITIONS PRIOR TO COMMENCEMENT OF WORK.
2.	MASONRY OPENINGS ARE APPROXIMATE. THE CONTRACTOR SHALL BE RESPONSIBLE FOR VERIFYING ALL CONDITIONS.
3.	REFER TO A400'S DRAWINGS FOR DOOR, FRAME, AND WALL TYPES.
4.	PROVIDE ALL LOUVER OPENINGS AS REQUIRED. ARCHITECTURAL ELEVATION 0' -0" EQUALS EXISTING FLOOR LEVEL
5.	CONTROL JOINT = CJ
6.	EXPANSION JOINT = EJ

PROJECT INFORMATION
Project Number: R22.16900.00
Client Name: WILSON COUNTY SCHOOLS
Project Name: HUNT HS - ATHLETICS RENOVATION
HUNT HIGH SCHOOL
Project Address: 4559 Lamm Rd, Wilson, NC 27893


PROJECT ISSUE & REVISION SCHEDULE
No. Date Description



SHEET INFORMATION
Issued: 09.15.2023
Scale: As Indicated
Project Status: 100% CONSTRUCTION DOCUMENTS
Drawn By: EG
Checked By: GB
Drawing Title: RESTROOM BUILDING ELEVATIONS
Drawing Number:

A301

9/22/2023 9:59:32 AM S:\Projects\Wilson\Wilson HS Athletic Renovation\Design\CAD\Revit\Civil

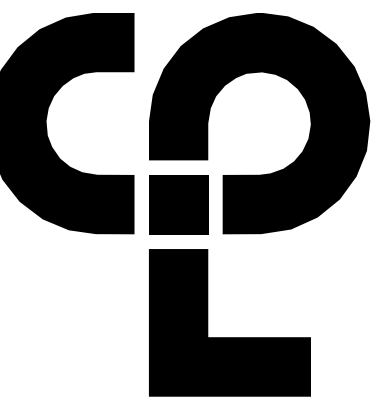

PROJECT INFORMATION

Project Number
R22.16900.00
Client Name


WILSON COUNTY SCHOOLS

Project Name
HUNT HS - ATHLETICS RENOVATION
HUNT HIGH SCHOOL

Project Address
4559 Lamm Rd, Wilson, NC 27893

PROJECT ISSUE & REVISION SCHEDULE

No. Date Description

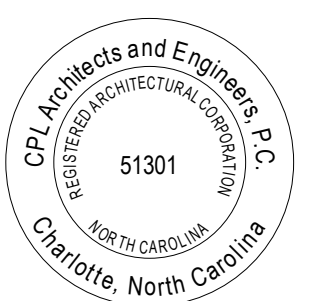


SHEET INFORMATION


Issued 09.15.2023 Scale As Indicated
Project Status 100% CONSTRUCTION DOCUMENTS
Drawn By EG Checked By GB
Drawing Title CONCESSION BUILDING ELEVATIONS

Drawing Number


A302

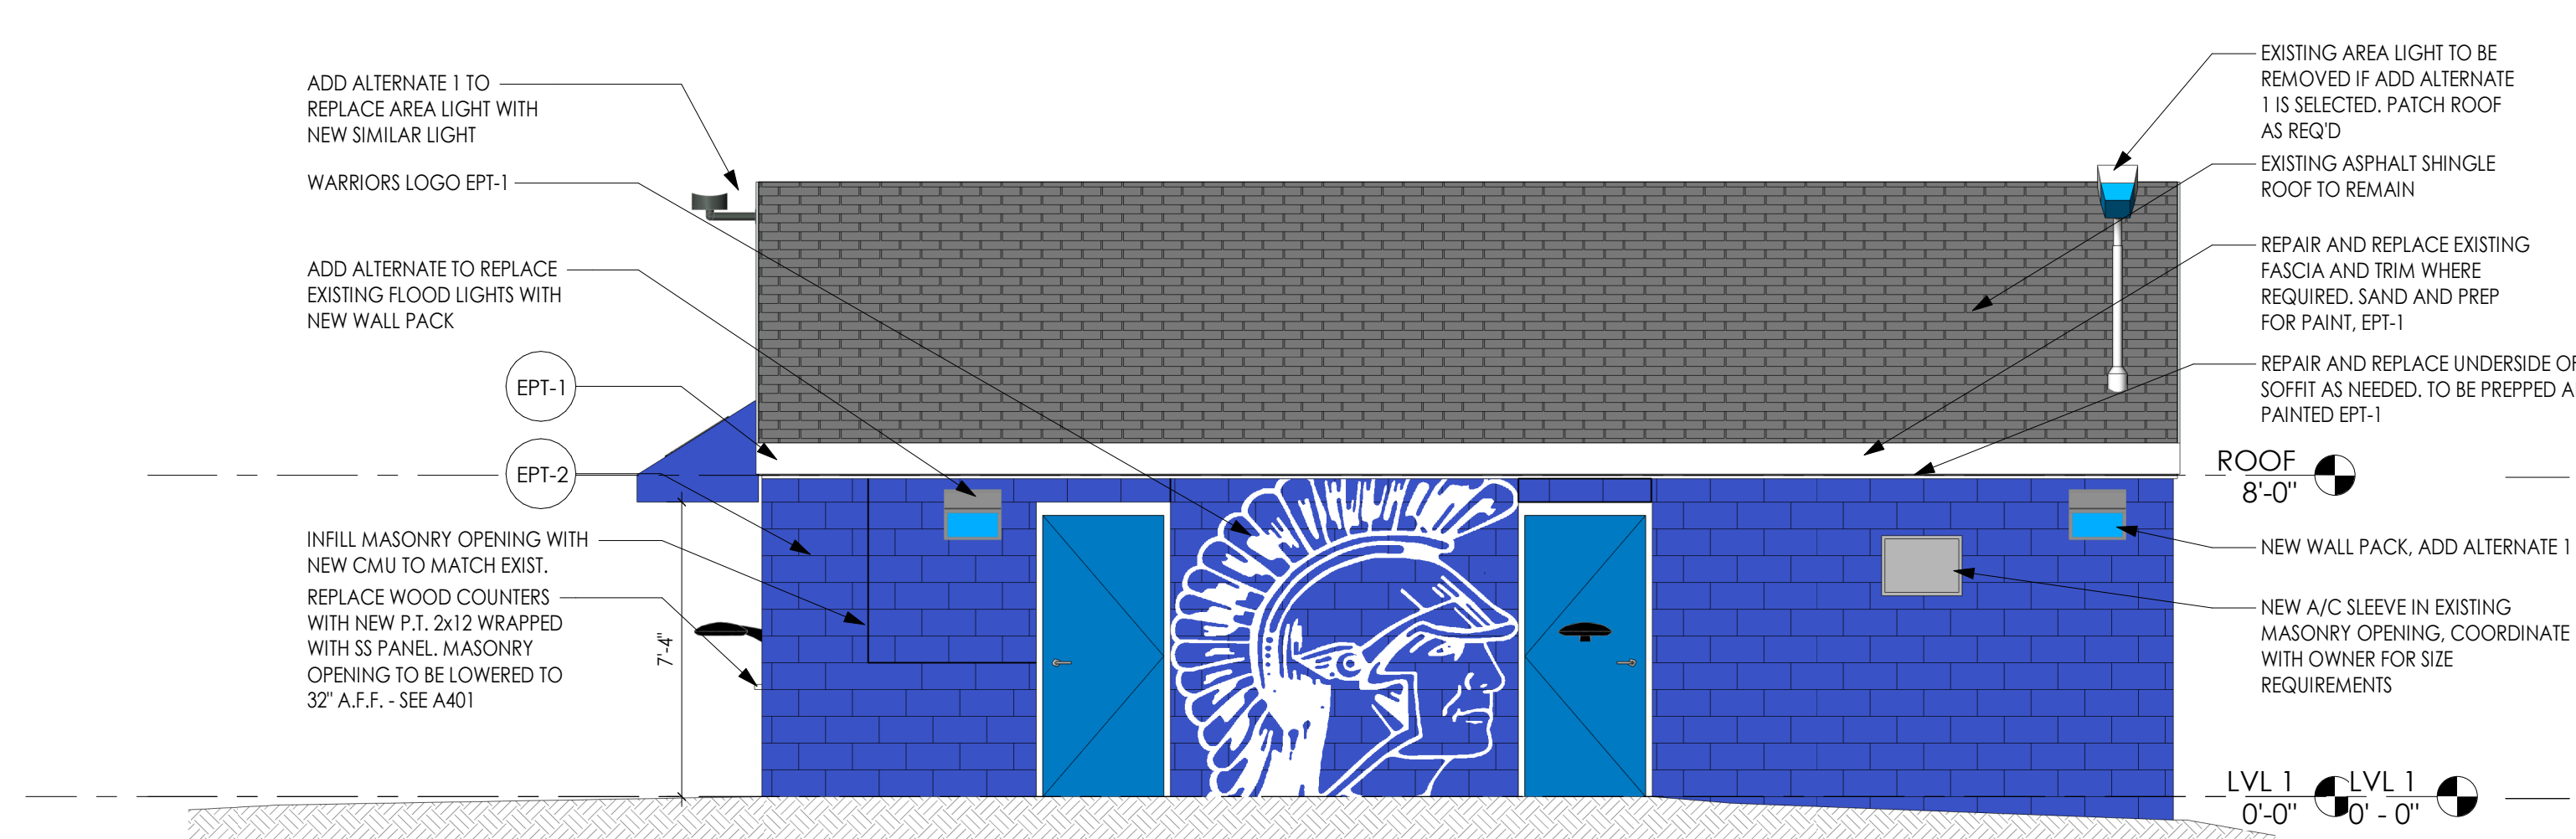


3 CONCESSIONS BUILDING ELEVATION - EAST
A302 1/4" = 1'-0"

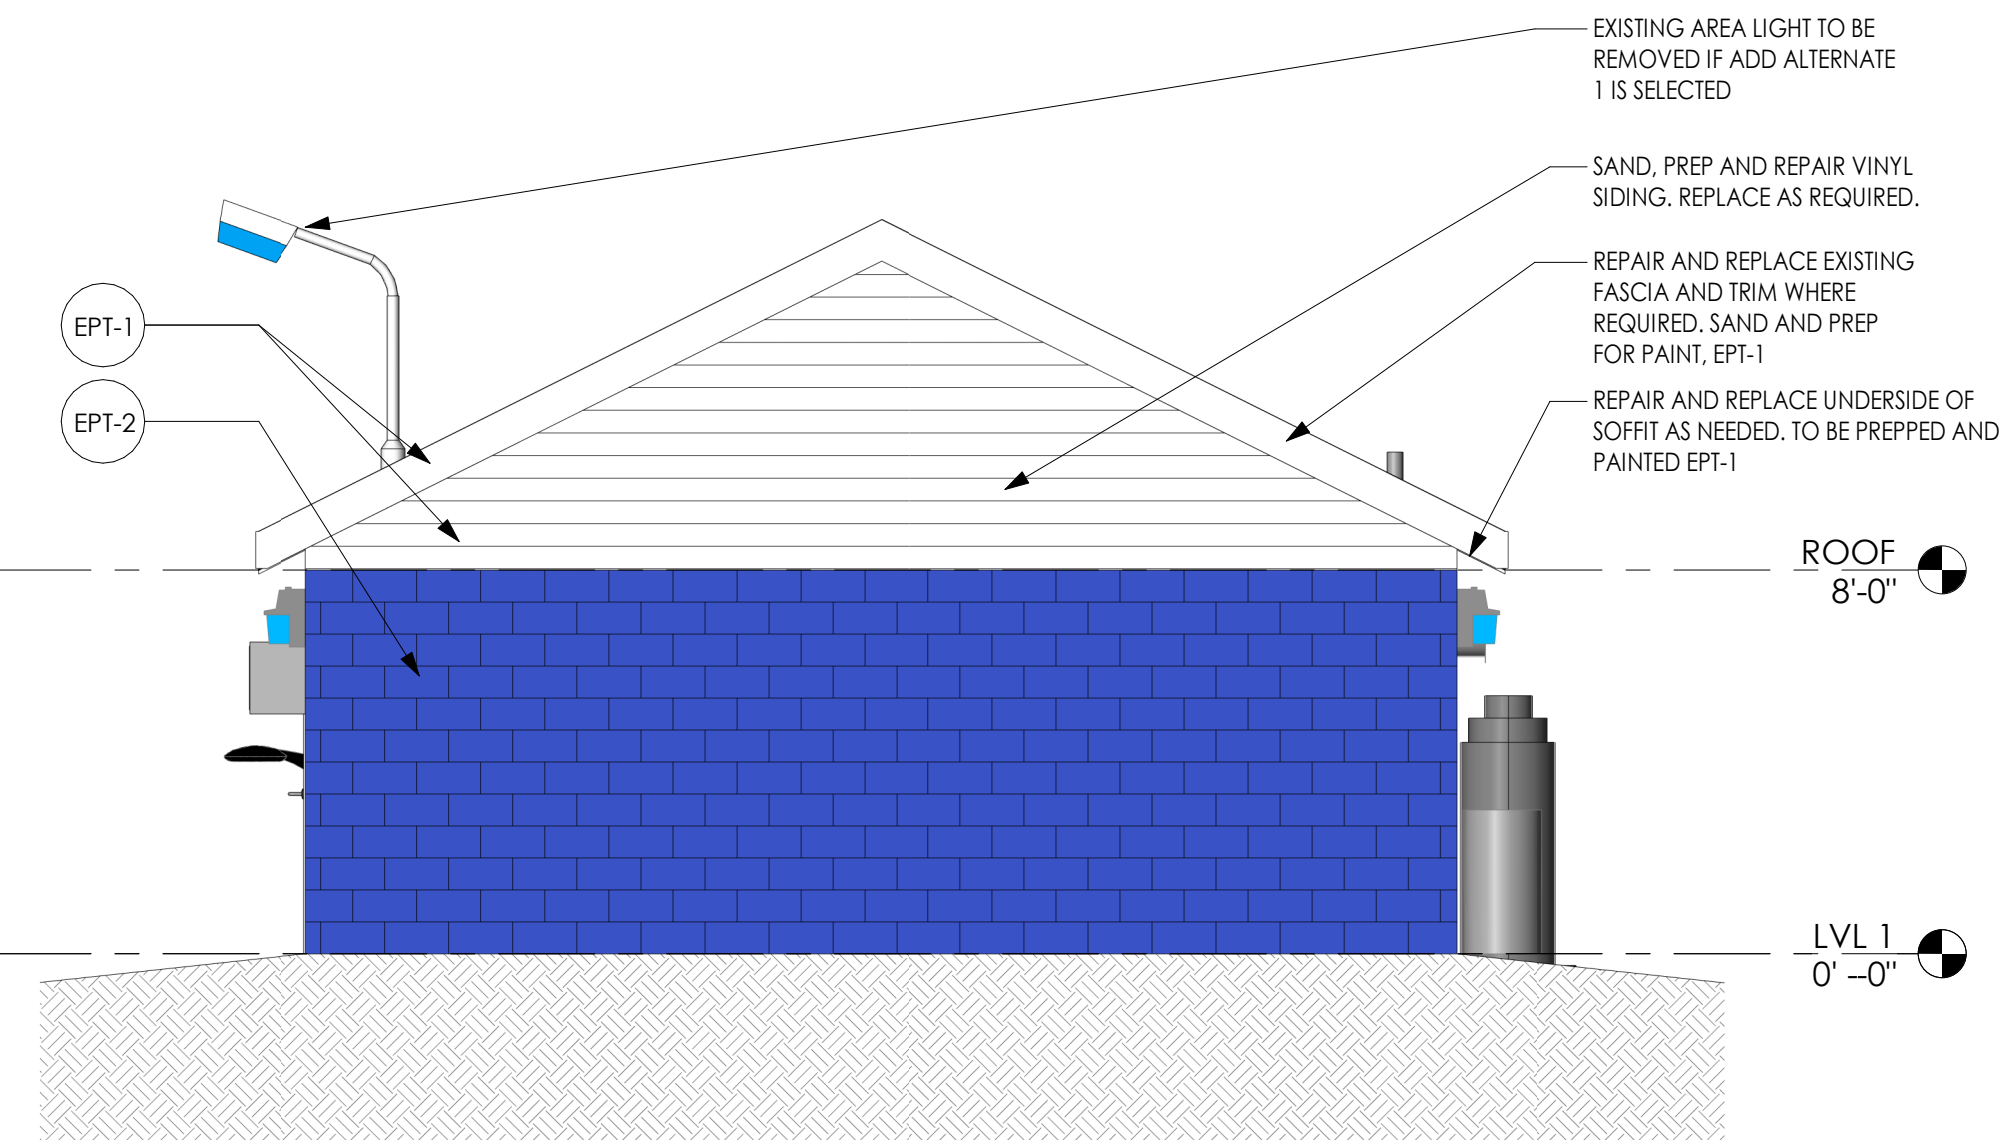

2 CONCESSIONS BUILDING ELEVATION - NORTH
A302 1/4" = 1'-0"

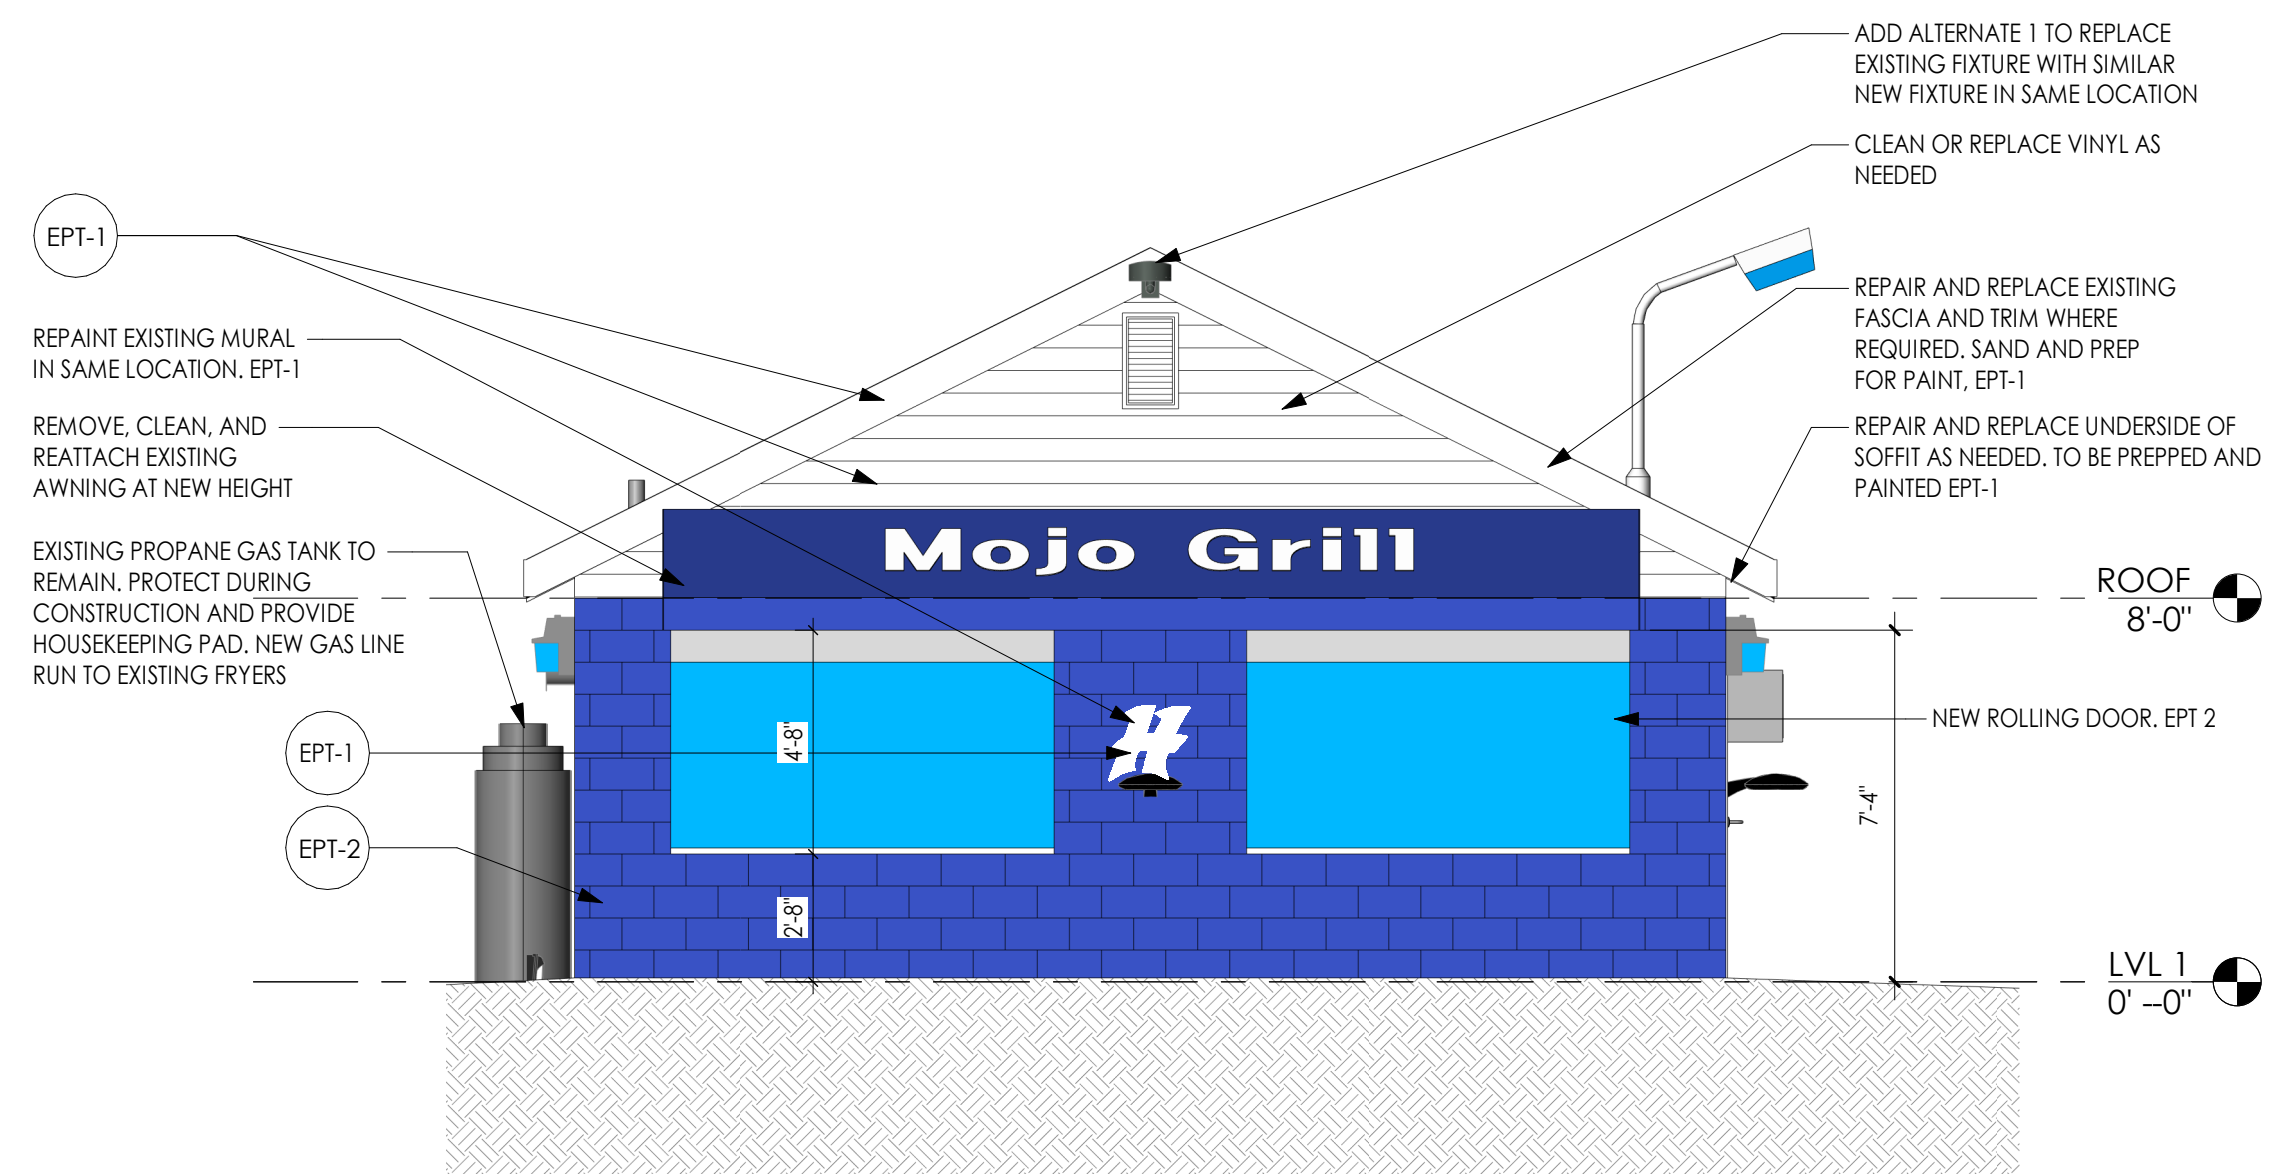

4 CONCESSIONS BUILDING ELEVATION - SOUTH
A302 1/4" = 1'-0"

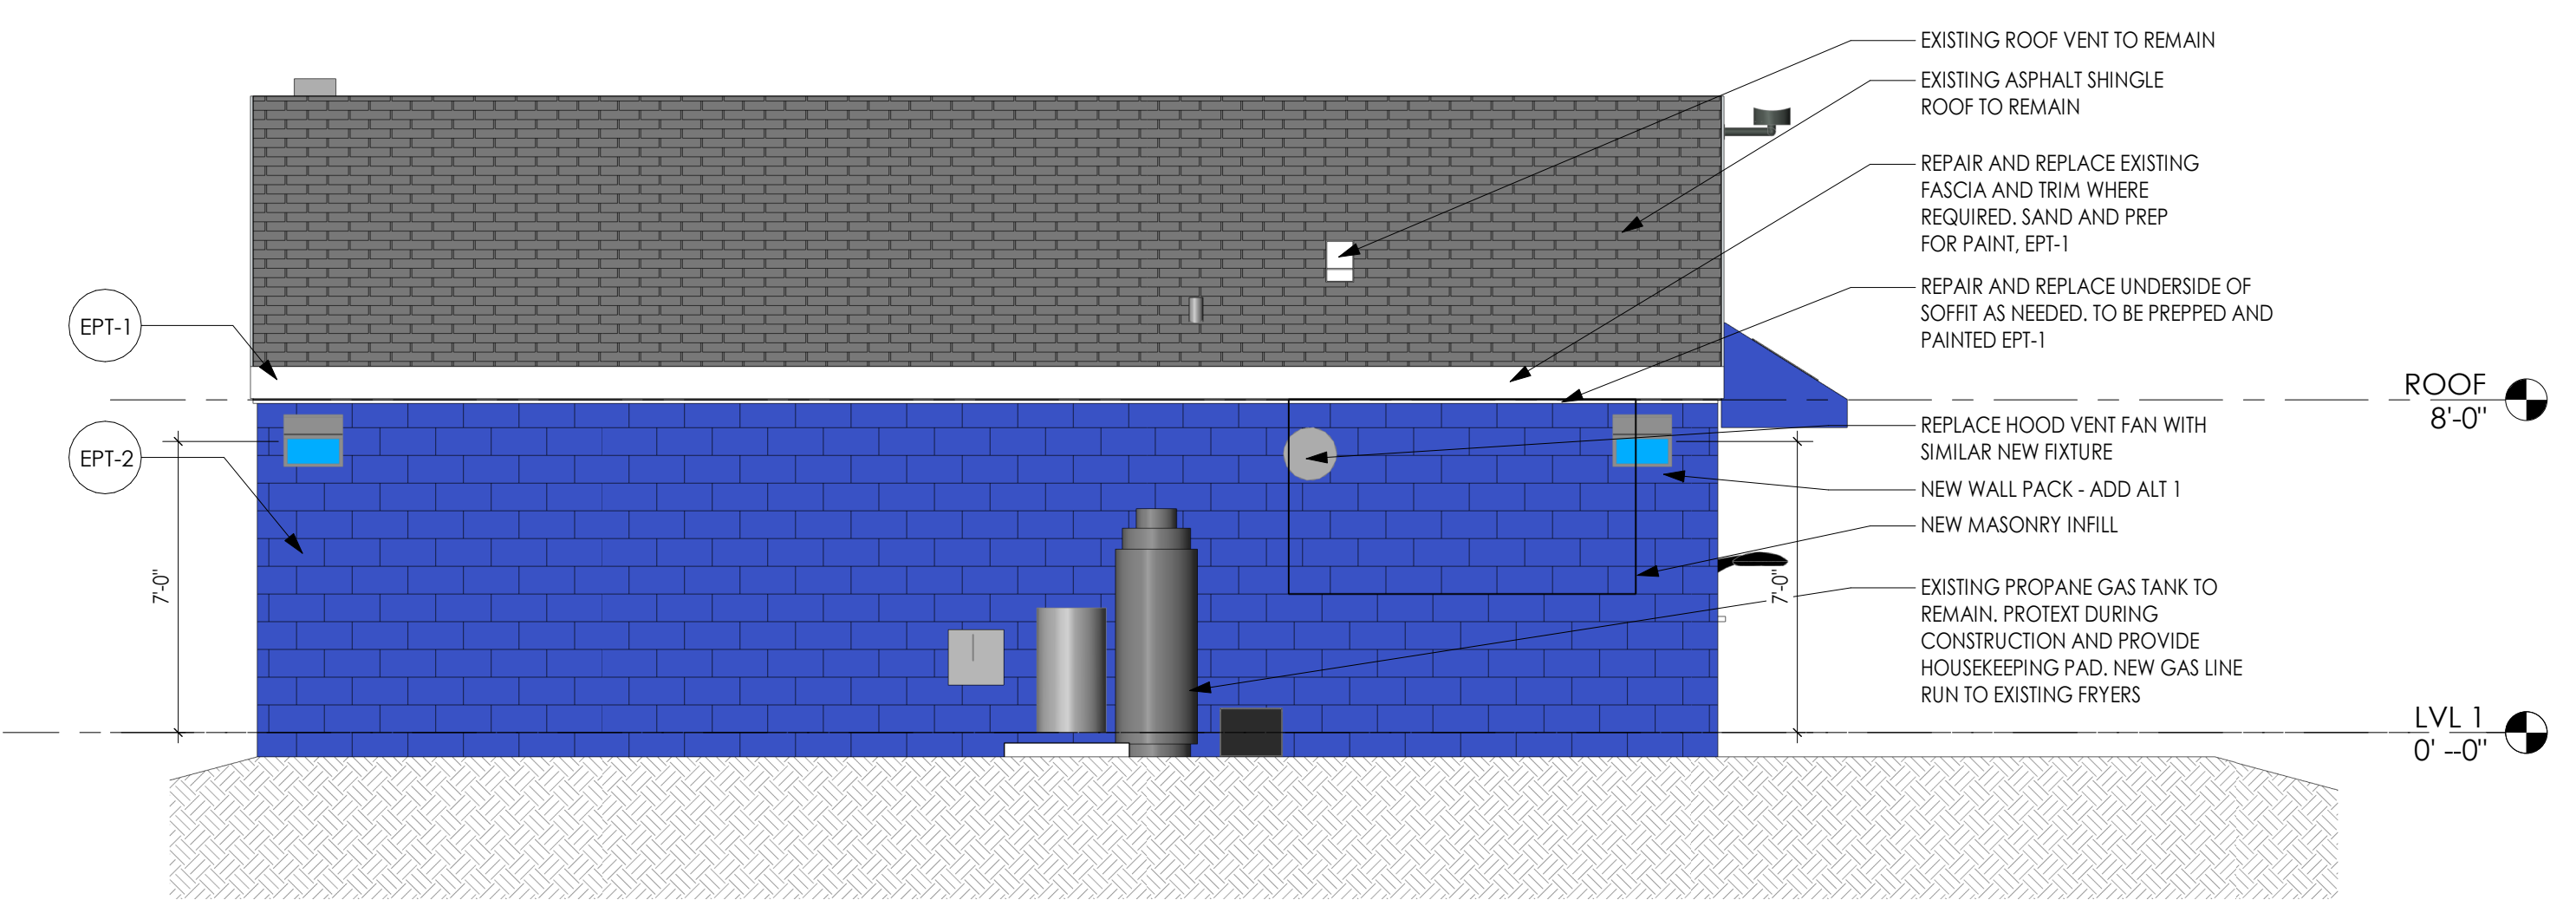


1 CONCESSIONS BUILDING ELEVATION - WEST
A302 1/4" = 1'-0"

S:\Projects\Wilson County Schools\Athletic Renovation\Design\A302\Rev\1\Ceiling.dwg 9/22/2023 9:59:35 AM


ELEVATION LEGEND	
	CAST STONE
	CMU (RUNNING)
	ASPHALT SHINGLE ROOF
	BUILDING EXPANSION JOINT (BEJ)
	EXPANSION JOINT (EJ)
PAINT COLORS	
EPT-1	WHITE
EPT-2	WARRIOR BLUE - PANTONE 288C
EPT-3	GREY - PANTONE 8C
EPT-4	BLACK
EPT-5	DARKER BLUE - PANTONE 289C

ELEVATION GENERAL NOTES	
1.	ALL DRAWINGS ARE GRAPHIC REPRESENTATIONS OF APPROXIMATE LOCATIONS OF EXISTING AND NEW MATERIALS. IT IS THE CONTRACTOR'S RESPONSIBILITY TO FIELD VERIFY ALL EXISTING CONDITIONS PRIOR TO COMMENCEMENT OF WORK.
2.	MASONRY OPENING ARE APPROXIMATE. THE CONTRACTOR SHALL BE RESPONSIBLE FOR VERIFYING ALL CONDITIONS.
3.	REFER TO A400'S DRAWINGS FOR DOOR, FRAME, AND WALL TYPES.
4.	PROVIDE ALL LOUVER OPENINGS AS REQUIRED. ARCHITECTURAL ELEVATION 0' -0" EQUALS EXISTING FLOOR LEVEL
5.	CONTROL JOINT = CJ
6.	EXPANSION JOINT = EJ

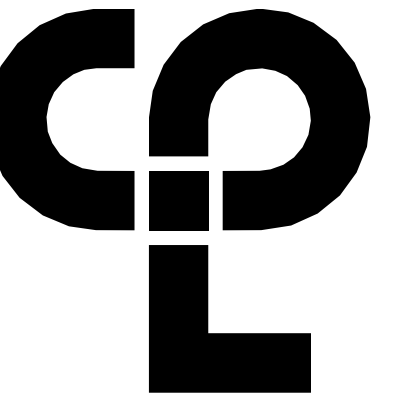


DOOR SCHEDULE- NEW


DOOR NUMBER	PANEL TYPE		DOOR PANELS							DOOR FRAME					DOOR COMMENTS	Hardware	
			SINGLE PANEL DIMENSIONS		TOTAL PANEL DIMENSIONS			PANEL FINISHES		FRAME DIMENSIONS			FRAME FINISH				
	PANEL 1	PANEL 2	WIDTH	HEIGHT	WIDTH	HEIGHT	THICKNESS	UNDERCUT	PANEL FINISH SIDE 1	PANEL FINISH SIDE 2	FRAME TYPE	JAMB WIDTH		HEAD HEIGHT			FRAME DEPTH
LVL 1																	
001	PNL-F-HM		4'-0"	7'-0"	4'-0"	7'-0"	0'-1 3/4"	0'-0"	HM/PT - EPT-2	HM/PT - EPT-2	FRM-00HM1	0'-2"	0'-4"	0'-8 1/2"	HM/PT - EPT-5	RESTROOM DOOR - HM - LOCK ON EXTERIOR	7
002	PNL-F-HM		2'-6"	7'-0"	2'-6"	7'-0"	0'-1 3/4"	0'-0"	PT P1 Warrior Blue	HM/PT - EPT-2	FRM-00HM1	0'-2"	0'-4"	0'-9 1/2"	HM/PT - EPT-5	PLUMBING CHASE DOOR - HM - LOCK ON EXTERIOR	5
003	PNL-F-HM		4'-0"	7'-0"	4'-0"	7'-0"	0'-1 3/4"	0'-0"	HM/PT - EPT-2	HM/PT - EPT-2	FRM-00HM1	0'-2"	0'-4"	0'-8 1/2"	HM/PT - EPT-5	RESTROOM DOOR - HM - LOCK ON EXTERIOR	7
004	PNL-F-WD		3'-0"	7'-0"	3'-0"	7'-0"	0'-1 3/4"	0'-0"	HM/PT - EPT-1	HM/PT - EPT-1	FRM-00HM1	0'-2"	0'-4"	0'-8 1/2"	HM/PT - EPT-5	ELEC CLOSET DOOR - HM	3
005A	PNL-F-HM	PNL-F-HM	3'-0"	7'-0"	3'-0"	7'-0"	0'-1 3/4"	0'-0"	PT P1 Warrior Blue	<By Category>	FRM-00HM1	0'-2"	0'-2"	0'-9 1/2"	HM/PT - EPT-5	TRAINING ROOM DOUBLE DOOR - HM	6
005B	PNL-F-WD		3'-0"	7'-0"	3'-0"	7'-0"	0'-1 3/4"	0'-0"	PT P1 Warrior Blue	<By Category>	FRM-00HM1	0'-2"	0'-2"	0'-8 1/2"	HM/PT - EPT-5	TRAINING ROOM SINGLE DOOR - HM	5
101	PNL-F-HM		3'-0"	7'-0"	3'-0"	7'-0"	0'-1 3/4"	0'-0"	HM/PT - EPT-2	HM/PT - EPT-2	FRM-00HM1	0'-2"	0'-4"	0'-8 1/2"	HM/PT - EPT-5	CONCESSIONS ROOM EXTERIOR DOOR - LOCK ON EXTERIOR	5
102	PNL-F-WD		2'-8"	7'-0"	2'-8"	7'-0"	0'-1 3/4"	0'-0"	HM/PT - EPT-2	HM/PT - EPT-2	FRM-00HM1	0'-2"	0'-2"	0'-5 1/8"	HM/PT - EPT-5	CONCESSIONS ROOM CLOSET DOOR	1
103A	PNL-F-WD	PNL-F-HM	2'-0"	7'-0"	Z'-0"	7'-0"	0'-2 1/4"	0'-0"	<By Category>	<By Category>	FRM-00HM1	0'-2"	0'-2"	0'-4 11/16"	HM/PT - EPT-5	STORAGE ROOM INTERIOR DOOR	4
103B	PNL-F-HM		3'-0"	7'-0"	3'-0"	7'-0"	0'-1 3/4"	0'-0"	HM/PT - EPT-2	HM/PT - EPT-2	FRM-00HM1	0'-2"	0'-4"	0'-8 1/2"	HM/PT - EPT-5	STORAGE ROOM EXTERIOR DOOR - LOCK ON EXTERIOR	5
104	PNL-F-WD		3'-0"	7'-0"	3'-0"	7'-0"	0'-1 3/4"	0'-0"	HM/PT - EPT-2	HM/PT - EPT-2	FRM-00HM1	0'-2"	0'-2"	0'-5 3/32"	HM/PT - EPT-5	RESTROOM DOOR - HM - LOCK ON INTERIOR	2

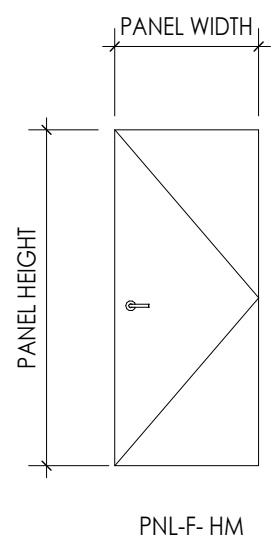


8 DOOR PANEL TYPES
A401 1/4" = 1'-0"

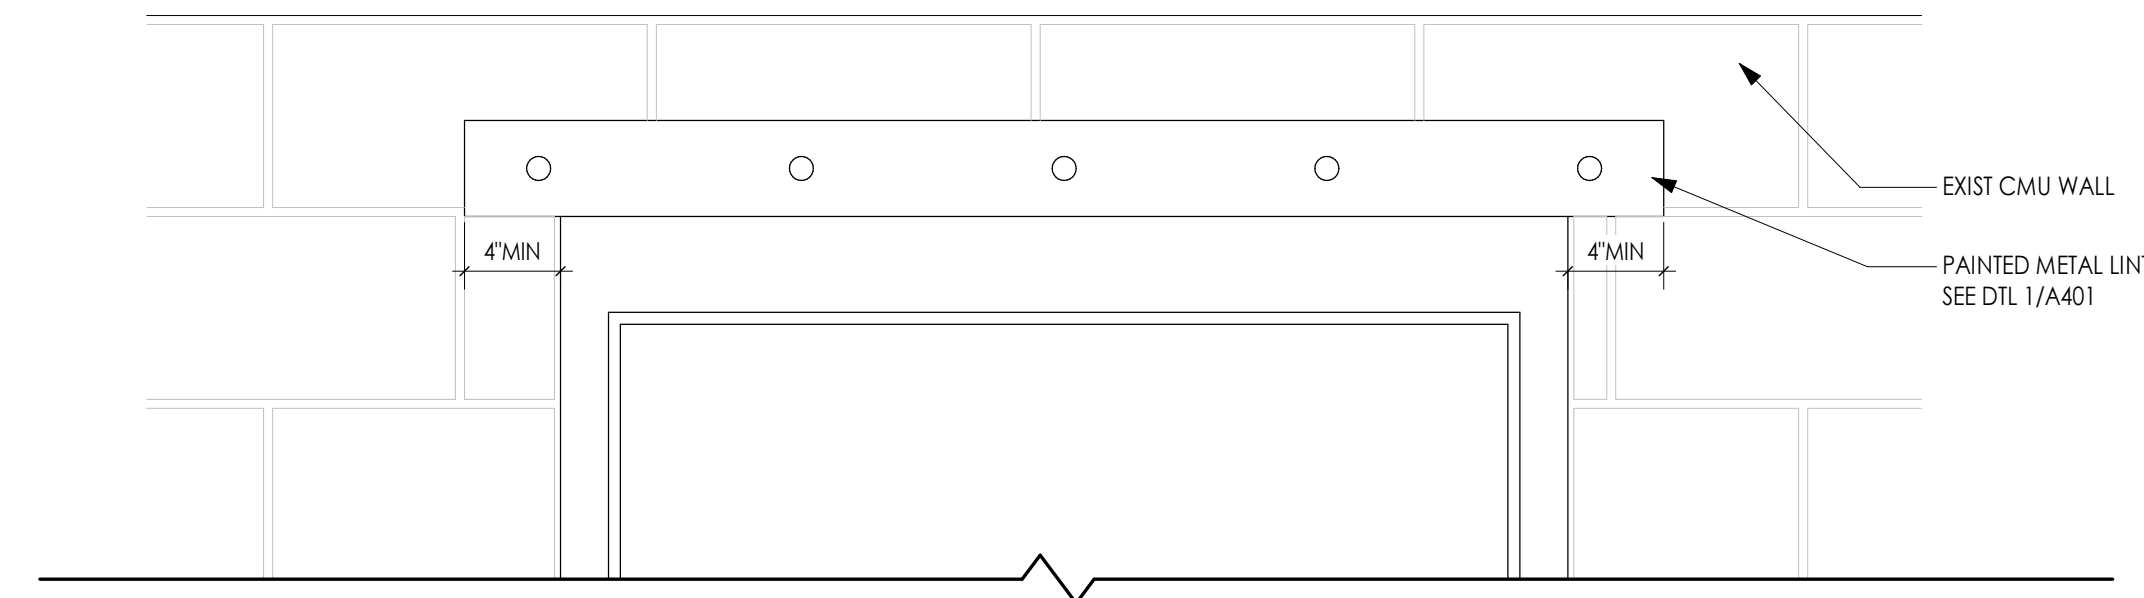


5 LINTEL ELEVATION DETAIL
A401 1/4" = 1'-0"

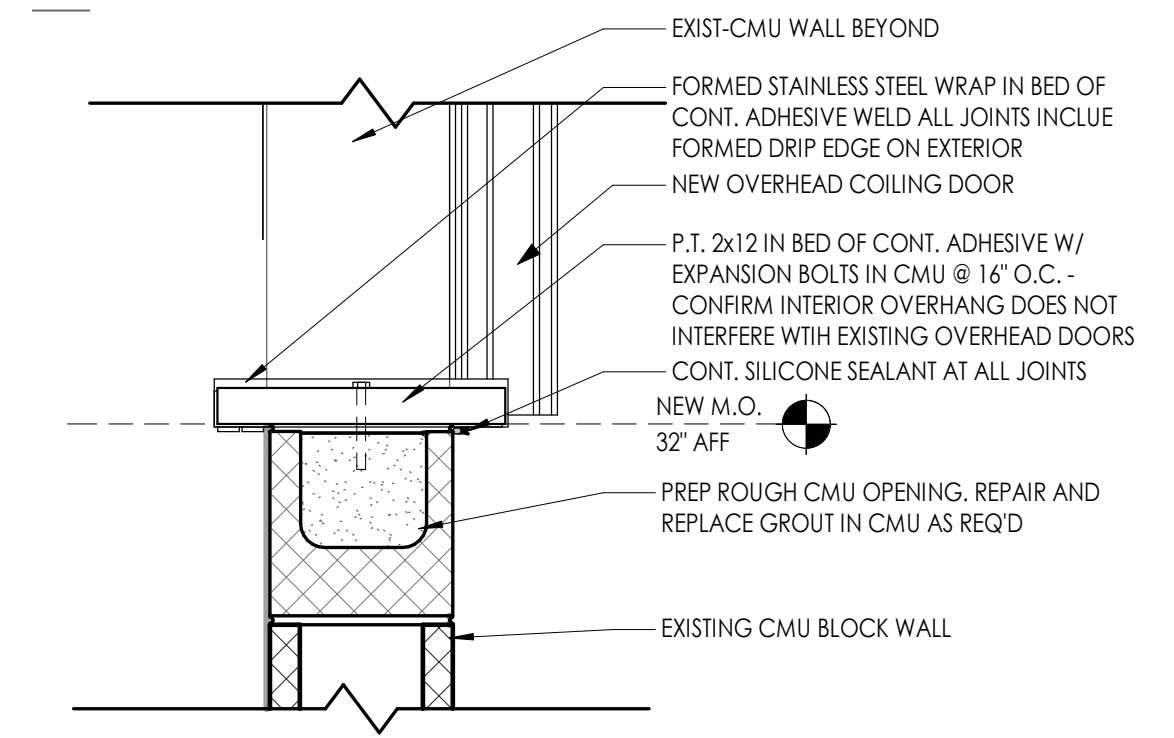


3 COUNTERTOP DETAIL
A401 1 1/2" = 1'-0"

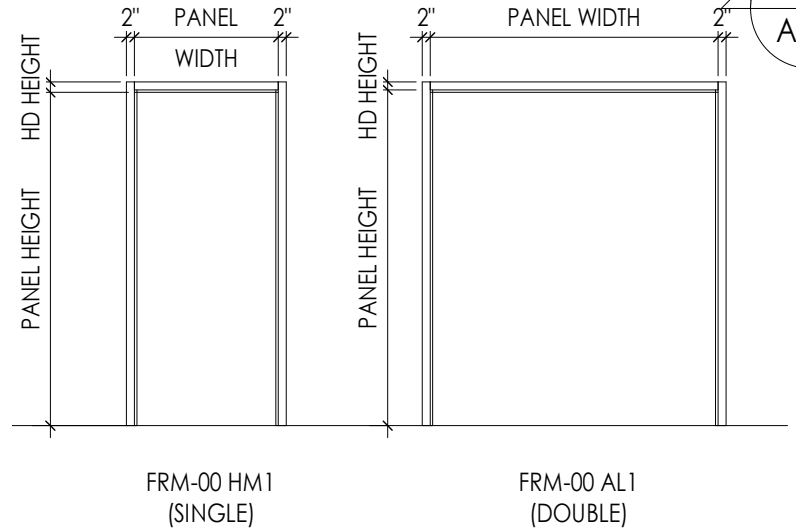


7 DOOR FRAME TYPES
A401 1/4" = 1'-0"

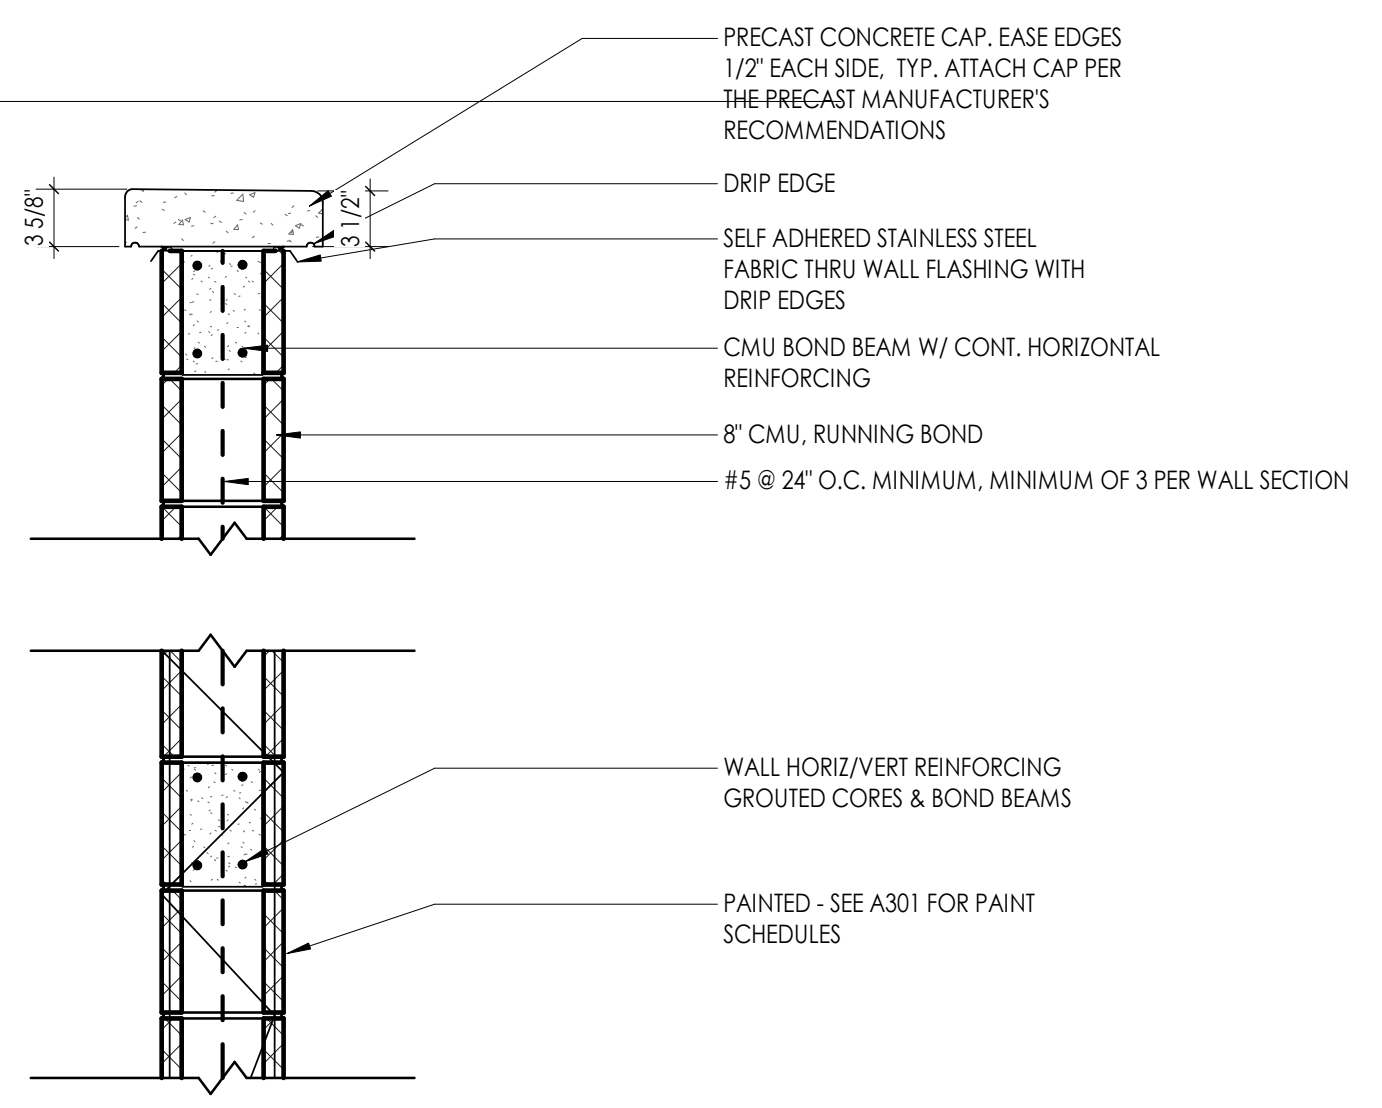

2 COUNTERTOP DETAIL - DEMO
A401 1 1/2" = 1'-0"

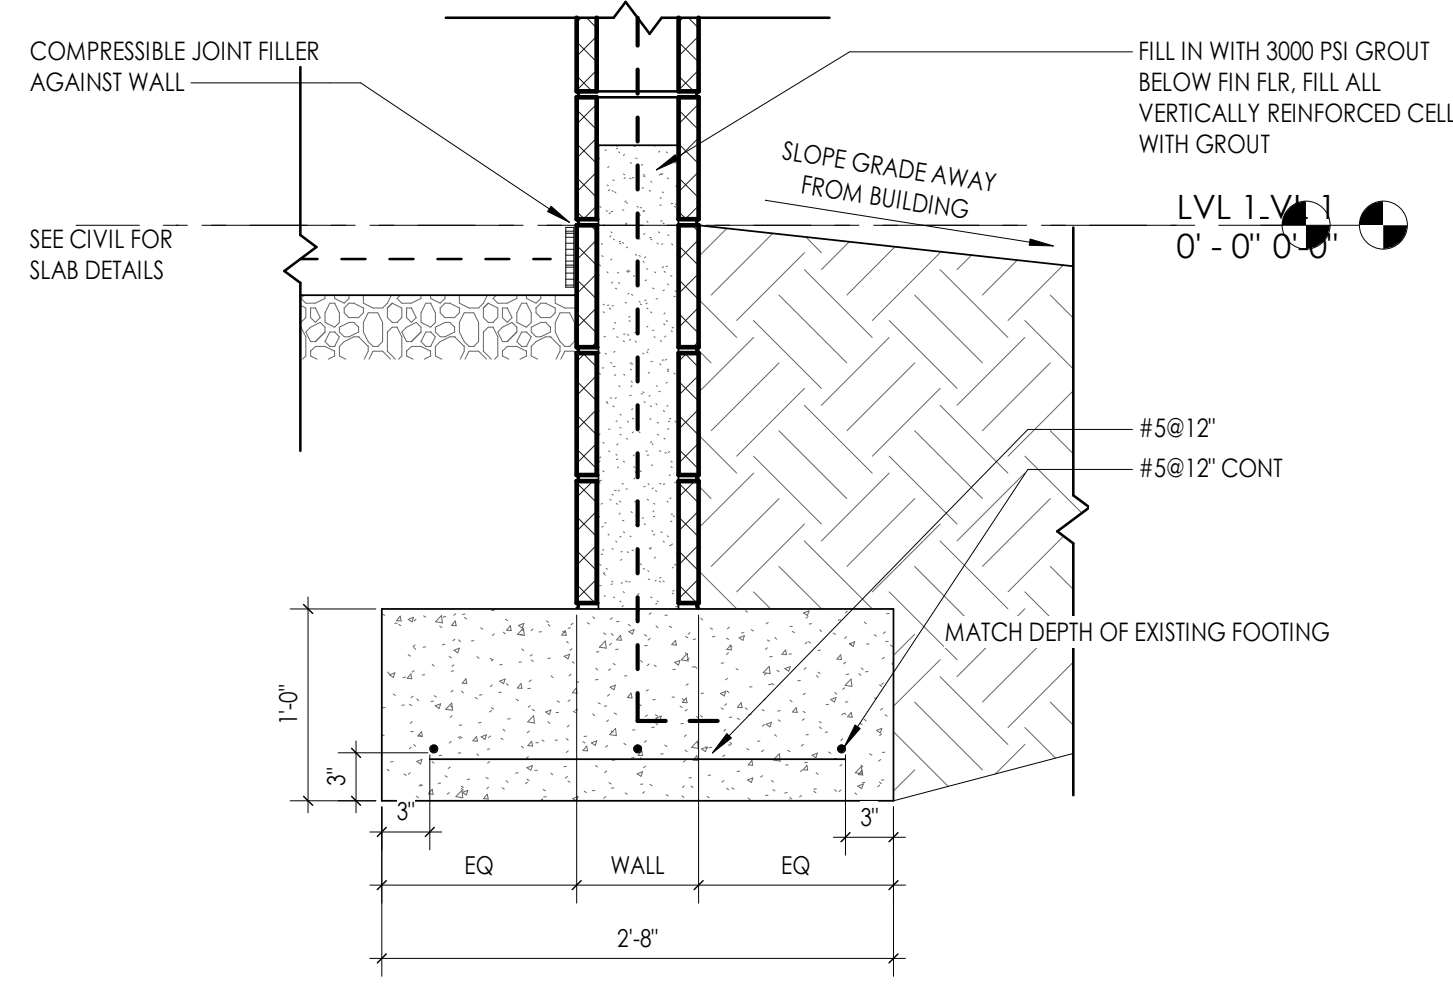

4 CONCRETE FOOTING DETAIL AT RESTROOM PRIVACY WALL - TYPE M8
A401 1" = 1'-0"

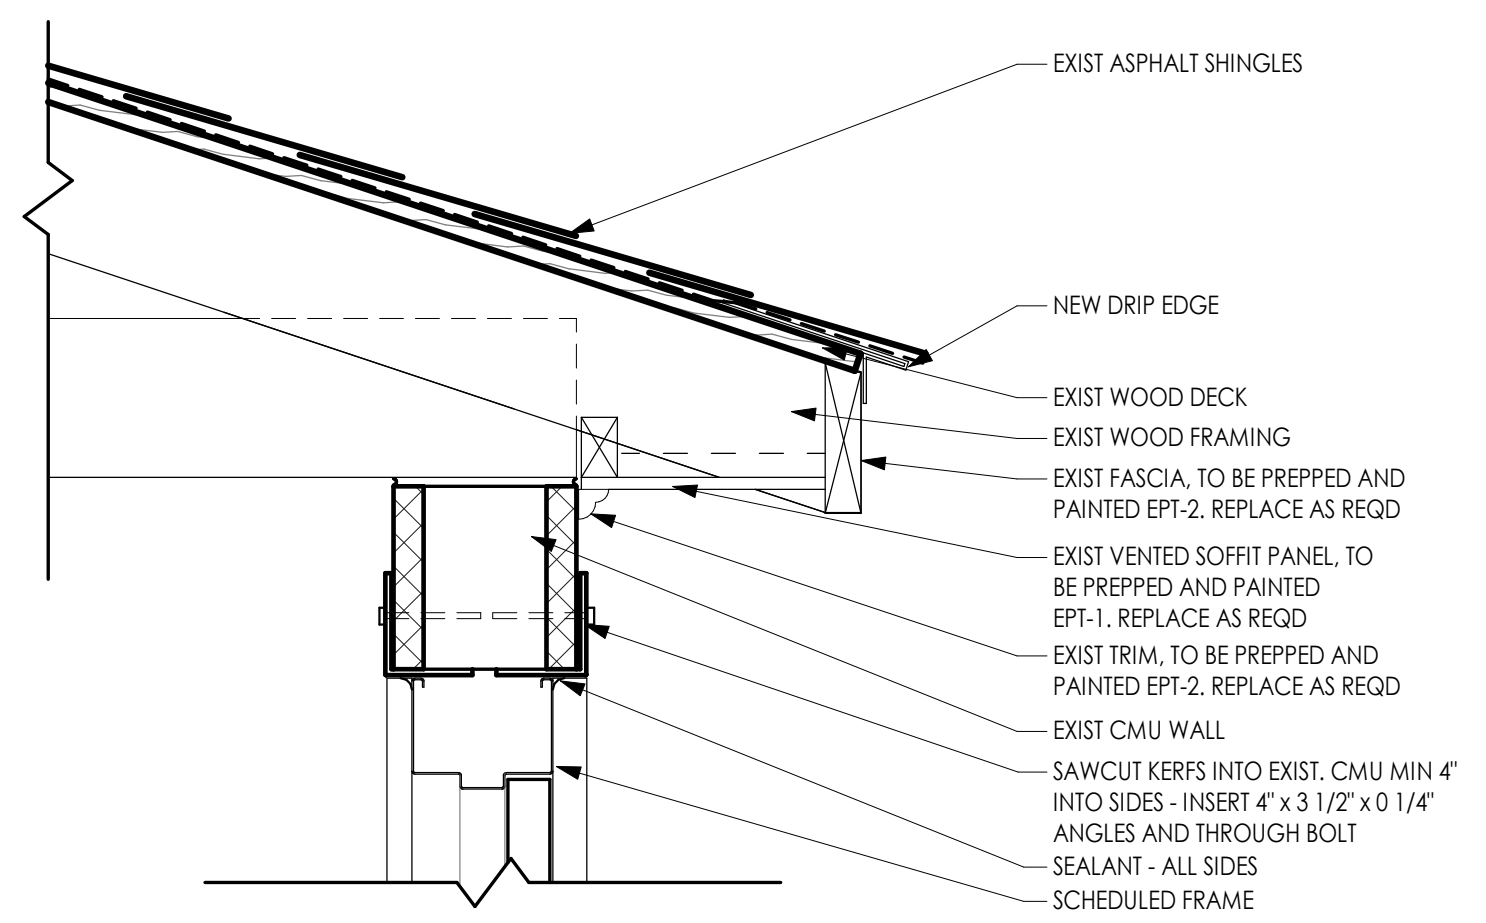

1 METAL LINTEL SECTION DETAIL
A401 1 1/2" = 1'-0"

PARTITION GENERAL NOTES

- ALL WALL TYPES MAY NOT BE USED ON THIS PROJECT.
- UNLESS NOTED OTHERWISE ALL PARTITIONS ARE FULL HEIGHT, EXTEND & SECURE TO UNDERSIDE OF CONCRETE OR METAL DECK ABOVE.
- PROVIDE UL APPROVED JOINT AT ALL TOP OF WALL AND WALL TO WALL CONDITIONS AT ALL RATED WALLS.
- REFER TO CODE/LIFE SAFETY DRAWINGS FOR RATED PARTITIONS AND UL ASSEMBLIES.
- PROVIDE MOISTURE RESISTANT GYP. BD. AT ALL TOILET ROOMS, JANITORS CLOSETS AND OTHER WET LOCATIONS WHERE TILE AND TILE BACKER BOARD ARE NOT INSTALLED.
- REFER TO SPECIFICATIONS FOR METAL STUD GAUGE REQUIREMENTS.
- COORDINATE ALL PARTITION ACCESSORIES (APPLIED FINISHES, RESILIENT CHANNEL, ADDITIONAL LAYERS OF SHEATHING, SHIELDING, ETC.) ITEMS SHOWN IN TYPICAL WALL CONSTRUCTION DETAILS MAY HAVE TO BE ARRANGED ON DIFFERENT SIDES OF WALL ASSEMBLY TO ACHIEVE FLUSH CONTINUOUS WALL SURFACES. ANY CONFLICTS SHOULD BE BROUGHT TO THE ATTENTION OF THE ARCHITECT.
- FIRESTOP/SMOKE STOP ALL REQUIRED WALL PARTITIONS, SLABS, AND PENETRATIONS THROUGH NEW AND EXISTING WALLS WITHIN THE PROJECT LIMITS IN COORDINATION WITH CODE PLAN, OR WHERE COORDINATED SYSTEMS CONNECTION POINTS ARE LOCATED OUTSIDE THE PROJECT LIMIT AREA. SEE ARCHITECTURAL, MECHANICAL, ELECTRICAL, PLUMBING DRAWINGS AND SPECIFICATION DIVISION 7.
- NOTIFY OWNER AND ARCHITECT IF EXISTING NON-COMPLIANT PENETRATIONS ARE DISCOVERED NOT FIRESTOPPED IN COORDINATION WITH CODE PLAN.
- PROVIDE CONTROL JOINT WHERE NEW PARTITIONS BUTT EXISTING CONSTRUCTION.
- PROVIDE CONTROL JOINTS A MAXIMUM OF 30'-0" APART UNLESS NOTED OTHERWISE, PER ASTM C 840-17A. LOCATE ABOVE DOOR FRAMES WHERE POSSIBLE.
- PROVIDE SUPPORT BLOCKING AND STRAPPING FOR ALL MILLWORK, CASEWORK, AND WALL MOUNTED ACCESSORIES.

DOOR AND FRAME NOTES

- ALL FRAMES ARE TO RECEIVE FULL PERIMETER SEALANT. INTERIOR AND EXTERIOR
- ALL DOOR AND WINDOW DIMENSIONS ARE TO BE VERIFIED IN FIELD PRIOR TO FABRICATION
- SEE SCHEDULE FOR DOOR & FRAME MATERIAL.
- ALL DOORS AND FRAMES TO BE EPT-5 U.N.O.

DOOR AND FRAME SCHEDULE LEGEND

NOTE: THIS LEGEND MAY CONTAIN SYMBOLS THAT ARE NOT USED IN THIS PROJECT.

DOOR OR FRAME MATERIAL		DOOR OR FRAME FINISH	
HM	HOLLOW METAL	PT	PAINT

SET 1.0
DESCRIPTION: PROVIDE EACH SGL DOOR(S) WITH THE FOLLOWING:

QTY	ITEM	DESCRIPTION	FINISH	MFR
3 EA	HINGE	5881 4.5 X 4.5	652	IVE
1 EA	PASSAGE SET	L9010 06B	626	SCH
1 EA	WALL STOP	WS406/407CVX	630	IVE
3 EA	SILENCER	SR64	GRY	IVE

SET 2.0
DESCRIPTION: PROVIDE EACH SGL DOOR(S) WITH THE FOLLOWING:

QTY	ITEM	DESCRIPTION	FINISH	MFR
3 EA	HINGE	5881 4.5 X 4.5	652	IVE
1 EA	PRIVACY LOCK	L9040 06B 09-544 L283-722	626	SCH
1 EA	WALL STOP	WS406/407CVX	630	IVE
1 EA	SINGLE HOOK	S07B	626	IVE
3 EA	SILENCER	SR64	GRY	IVE

SET 3.0
DESCRIPTION: PROVIDE EACH SGL DOOR(S) WITH THE FOLLOWING:

QTY	ITEM	DESCRIPTION	FINISH	MFR
3 EA	HINGE	5881 4.5 X 4.5 NRP	652	IVE
1 EA	STOREROOM LOCK	L9080L 06B	626	SCH
1 EA	MORTISE CYLINDER	VERIFY TYPE REQD.	626	IVE
1 EA	OH STOP	4505	630	GLY
3 EA	SILENCER	SR64	GRY	IVE

SET 4.0
DESCRIPTION: PROVIDE EACH PR DOOR(S) WITH THE FOLLOWING:

QTY	ITEM	DESCRIPTION	FINISH	MFR
6 EA	HINGE	5881 4.5 X 4.5	652	IVE
2 EA	MANUAL FLUSH BOLT	FB457 12"	626	IVE
1 EA	DUST PROOF STRIKE	DP1	626	IVE
1 EA	STOREROOM LOCK	L9080L 06B	626	SCH
1 EA	MORTISE CYLINDER	VERIFY TYPE REQD.	626	IVE
2 EA	WALL STOP	WS406/407CVX	630	IVE
1 EA	MEETING STILE	383AA	AA	ZER
2 EA	SILENCER	SR64	GRY	IVE

SET 5.0
DESCRIPTION: PROVIDE EACH SGL DOOR(S) WITH THE FOLLOWING:

QTY	ITEM	DESCRIPTION	FINISH	MFR
1 EA	CONT. HINGE	705	630	IVE
1 EA	STOREROOM LOCK	L9080L 06B	626	SCH
1 EA	MORTISE CYLINDER	VERIFY TYPE REQD.	626	IVE
1 EA	LOCK GUARD	LG1	630	IVE
1 EA	SURFACE CLOSER	4040XP SHCUSH	689	LCN
1 EA	KICK PLATE	8400 10" X 2" LDW B-CS	630	IVE
1 EA	RAIN DRIP	142AA	AA	ZER
1 SET	GASKETING	429AA-S	AA	ZER
1 EA	DOOR SWEEP	39A	A	ZER
1 EA	THRESHOLD	655A-223	A	ZER

SET 6.0
DESCRIPTION: PROVIDE EACH PR DOOR(S) WITH THE FOLLOWING:

QTY	ITEM	DESCRIPTION	FINISH	MFR
2 EA	CONT. HINGE	705	630	IVE
1 EA	CONST LATCHING BOLT	FB51P	630	IVE
1 EA	DUST PROOF STRIKE	DP1	626	IVE
1 EA	STOREROOM LOCK	L9080L 06B	626	SCH
1 EA	MORTISE CYLINDER	VERIFY TYPE REQD.	626	IVE
1 EA	COORDINATOR	COR X FL	US26D	IVE
2 EA	SURFACE CLOSER	4040XP SHCUSH WMS	689	LCN
2 SET	KICK PLATE	8400 10" X 2" LDW B-CS	630	IVE
1 EA	RAIN DRIP	142AA	AA	ZER
1 SET	GASKETING	429AA-S	AA	ZER
1 EA	MEETING STILE	383AA	AA	ZER
2 EA	DOOR SWEEP	39A	A	ZER
1 EA	THRESHOLD	655A-223	A	ZER

SET 7.0
DESCRIPTION: PROVIDE EACH SGL DOOR(S) WITH THE FOLLOWING:

QTY	ITEM	DESCRIPTION	FINISH	MFR
1 EA	CONT. HINGE	705	630	IVE
1 EA	CLASSROOM DEAD LOCK	L443L	626	SCH
1 EA	MORTISE CYLINDER	VERIFY TYPE REQD.	626	IVE
1 EA	PUSH PLATE	8200 6" X 1 1/2"	630	IVE
1 EA	PUSH PLATE	8303 10" 4" X 1 1/2"	630	IVE
1 EA	SURFACE CLOSER	4040XP REG OR PA AS REQ	689	LCN
1 EA	KICK PLATE	8400 10" X 2" LDW B-CS	630	IVE
1 EA	WALL STOP	WS406/407CVX	630	IVE
1 SET	GASKETING	429AA-S	AA	ZER
1 EA	DOOR SWEEP	39A	A	ZER
1 EA	THRESHOLD	655A	A	ZER

PROJECT INFORMATION
 Project Number
 R22.16900.00
 Client Name
WILSON COUNTY SCHOOLS

Project Name
HUNT HS - ATHLETICS RENOVATION
 HUNT HIGH SCHOOL
 Project Address
 4559 Lamm Rd, Wilson, NC 27893


PROJECT ISSUE & REVISION SCHEDULE
 No. Date Description



SHEET INFORMATION
 Issued
 09.15.2023
 Scale
 As Indicated
 Project Status
 100% CONSTRUCTION DOCUMENTS
 Drawn By
 EG
 Checked By
 GB
 Walling Title
 WALL TYPES AND SCHEDULES

Drawing Number

A401

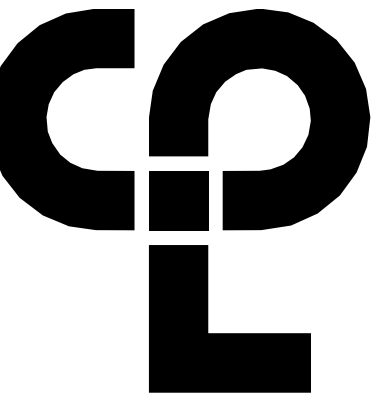

GENERAL CEILING NOTES

1. ALL DRAWINGS ARE GRAPHIC REPRESENTATION OF APPROXIMATE LOCATIONS OF NEW MATERIALS FOR CONSTRUCTION. IT IS THE CONTRACTOR'S RESPONSIBILITY TO FIELD VERIFY ALL CONDITIONS PRIOR TO COMMENCEMENT OF WORK.
2. FOR ANY DISCREPANCY BETWEEN THE REFLECTED CEILING PLAN AND THE FLOOR PLAN, THE FLOOR PLAN SHALL TAKE PRECEDENCE. ANY DISCREPANCY SHALL BE CALLED TO THE ATTENTION OF THE ARCHITECT.
3. FIRE STOP MECHANICAL, ELECTRICAL AND PLUMBING ITEMS, INCLUDING BUT NOT LIMITED TO DUCTWORK AND CONDUIT PENETRATIONS THROUGH FLOORS AND WALLS.
4. COORDINATE CEILING INSTALLATIONS WITH MECHANICAL, ELECTRICAL AND PLUMBING DRAWINGS.
5. WORK AREAS SHALL BE MAINTAINED AND ALL WORK AREAS SHALL BE LEFT BROOMED CLEAN AT THE END OF EACH DAY.
6. PROVIDE MOISTURE RESISTANT GYP. BD. AT ALL TOILET ROOM, JANITOR'S CLOSET AND OTHER WET LOCATION CEILING ASSEMBLIES.
7. ALL GYP. BD. CEILINGS AND SOFFITS SHALL BE PRIMED AND PAINTED SCHEDULED COLOR ON ALL FACES AND UNDERSIDE SURFACE.
8. VERIFY SOFFIT SIZE WITH MILLWORK SHOP DRAWINGS. PROVIDE 2" OVERHANG ON EXPOSED EDGES UNLESS NOTED OTHERWISE.
9. INSTALL CONTROL JOINTS IN GYP. CEILINGS PER ASTM C 840.

CEILING SYMBOL LEGEND

NOTE: THIS LEGEND MAY CONTAIN SYMBOLS THAT ARE NOT USED IN THE PROJECT

- EXISTING LIGHT FIXTURE TO REMAIN
- IN THE EVENT THAT ALTERNATE 1 IS SELECTED, PROVIDE LITHONIA CLXL48-7000LMSR-RDL-MVOLT-GZ10-40X-80CRI-WH OR SIMILAR AS APPROVED BY ARCHITECT
- EXISTING WALL PACK
- IN EVENT THAT ALTERNATE 1 IS SELECTED, PROVIDE REPLACEMENT WALL PACK LIGHTS OR SIMILAR AS APPROVED BY ARCHITECT
- EXISTING OVERHEAD LIGHT
- IN EVENT THAT ALTERNATE 1 IS SELECTED, PROVIDE REPLACEMENT OVERHEAD LIGHTS OR SIMILAR AS APPROVED BY ARCHITECT
- EXISTING CEILING TO REMAIN
- IN THE EVENT THAT ALTERNATE 2 IS SELECTED, REPLACE EXISTING CEILING WITH MOISTURE RESISTANT GYPSUM WALLBOARD CEILING
- ACT-1 9'-0" CEILING TYPE AND CEILING HEIGHT ABOVE FINISHED FLOOR

PROJECT INFORMATION

Project Number
R22.16900.00

Client Name

HUNT COUNTY SCHOOLS

Project Name


HUNT HS - ATHLETICS RENOVATION
HUNT HIGH SCHOOL

Project Address

4559 Lamm Rd, Wilson, NC 27893

PROJECT ISSUE & REVISION SCHEDULE

No. Date Description

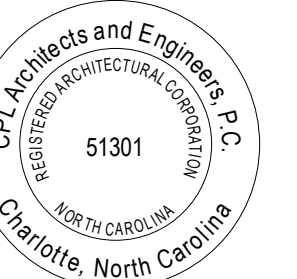

SHEET INFORMATION

Issued 09.15.2023 Scale As indicated


Project Status 100% CONSTRUCTION DOCUMENTS

Drawn By EG Checked By GB


Drawing Title REFLECTED CEILING PLANS

Drawing Number

A601

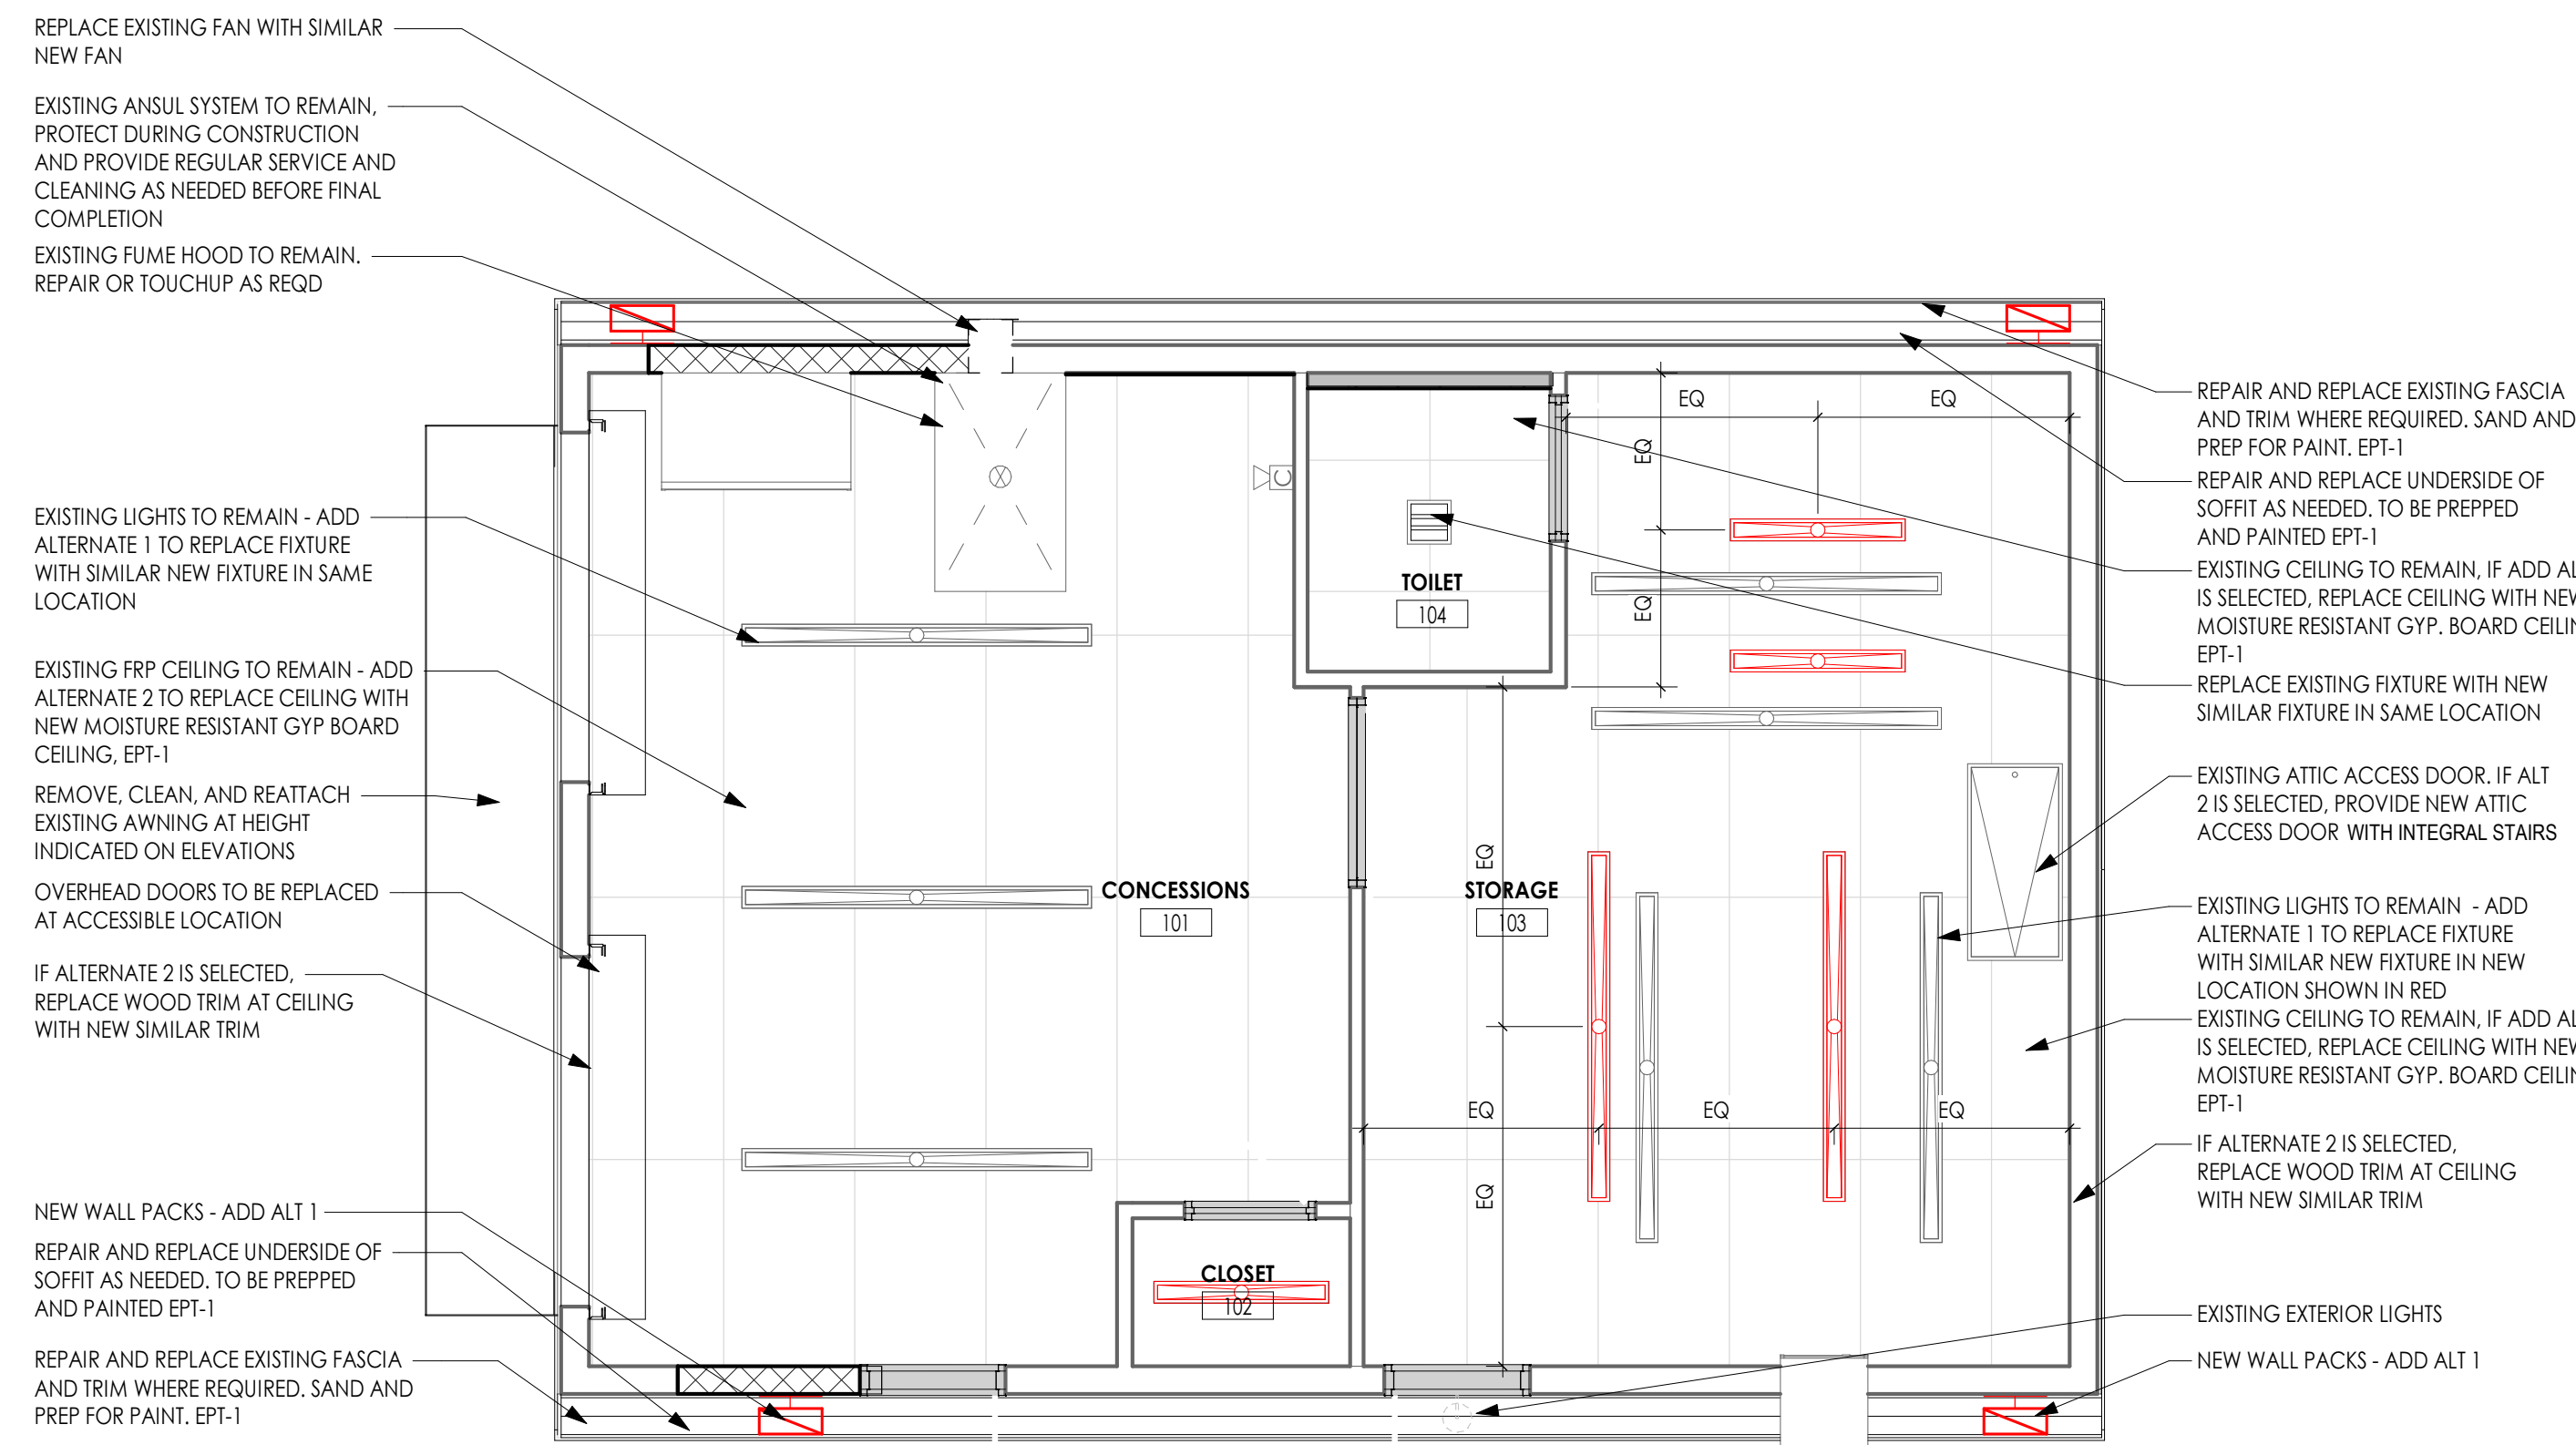


2 CONCESSIONS BUILDING REFLECTED CEILING PLAN
A601 1/4" = 1'-0"

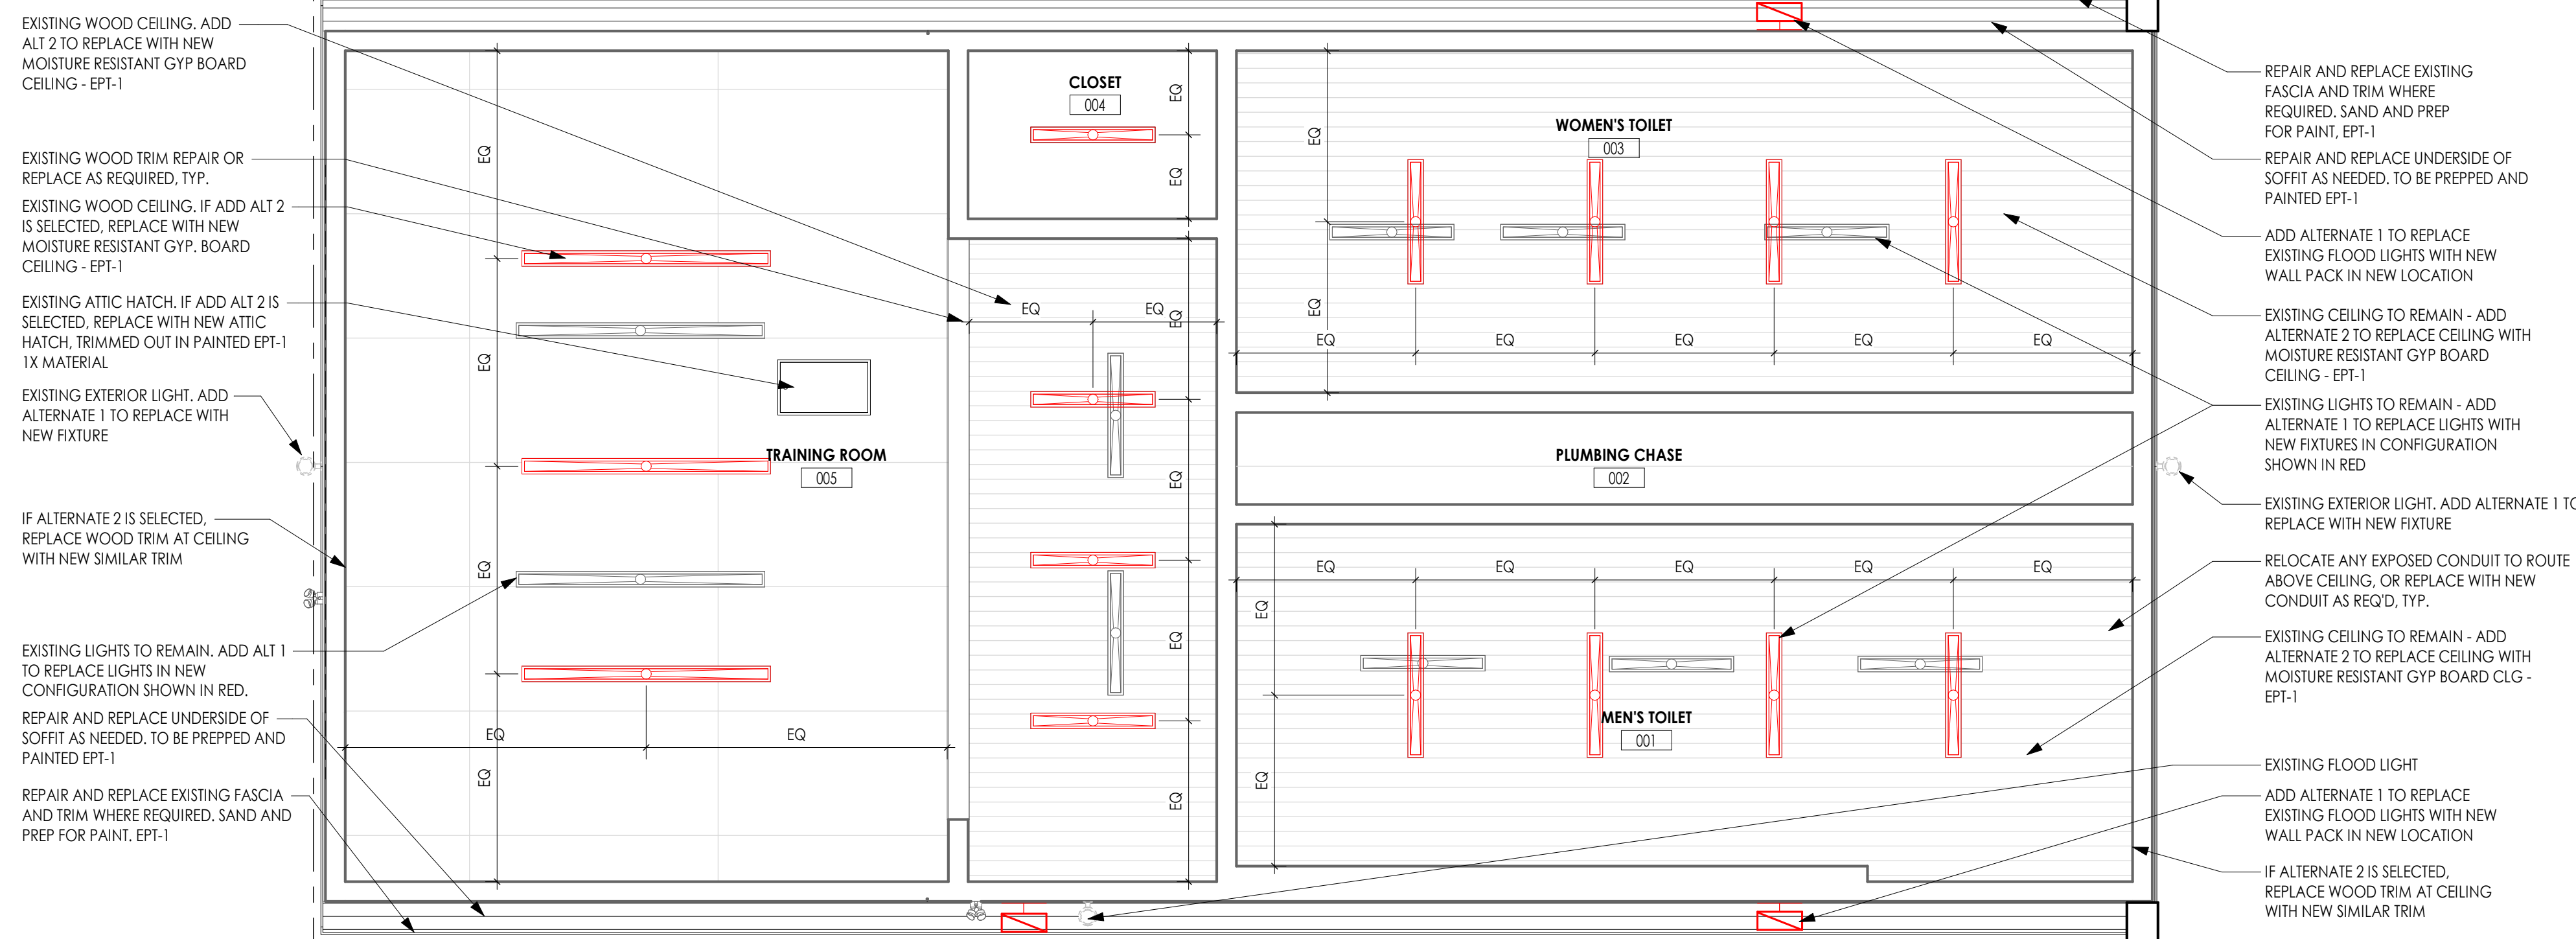


1 RESTROOM BUILDING REFLECTED CEILING PLAN
A601 1/4" = 1'-0"

TYPICAL TOILET AND SHOWER ACCESSORY LOCATIONS

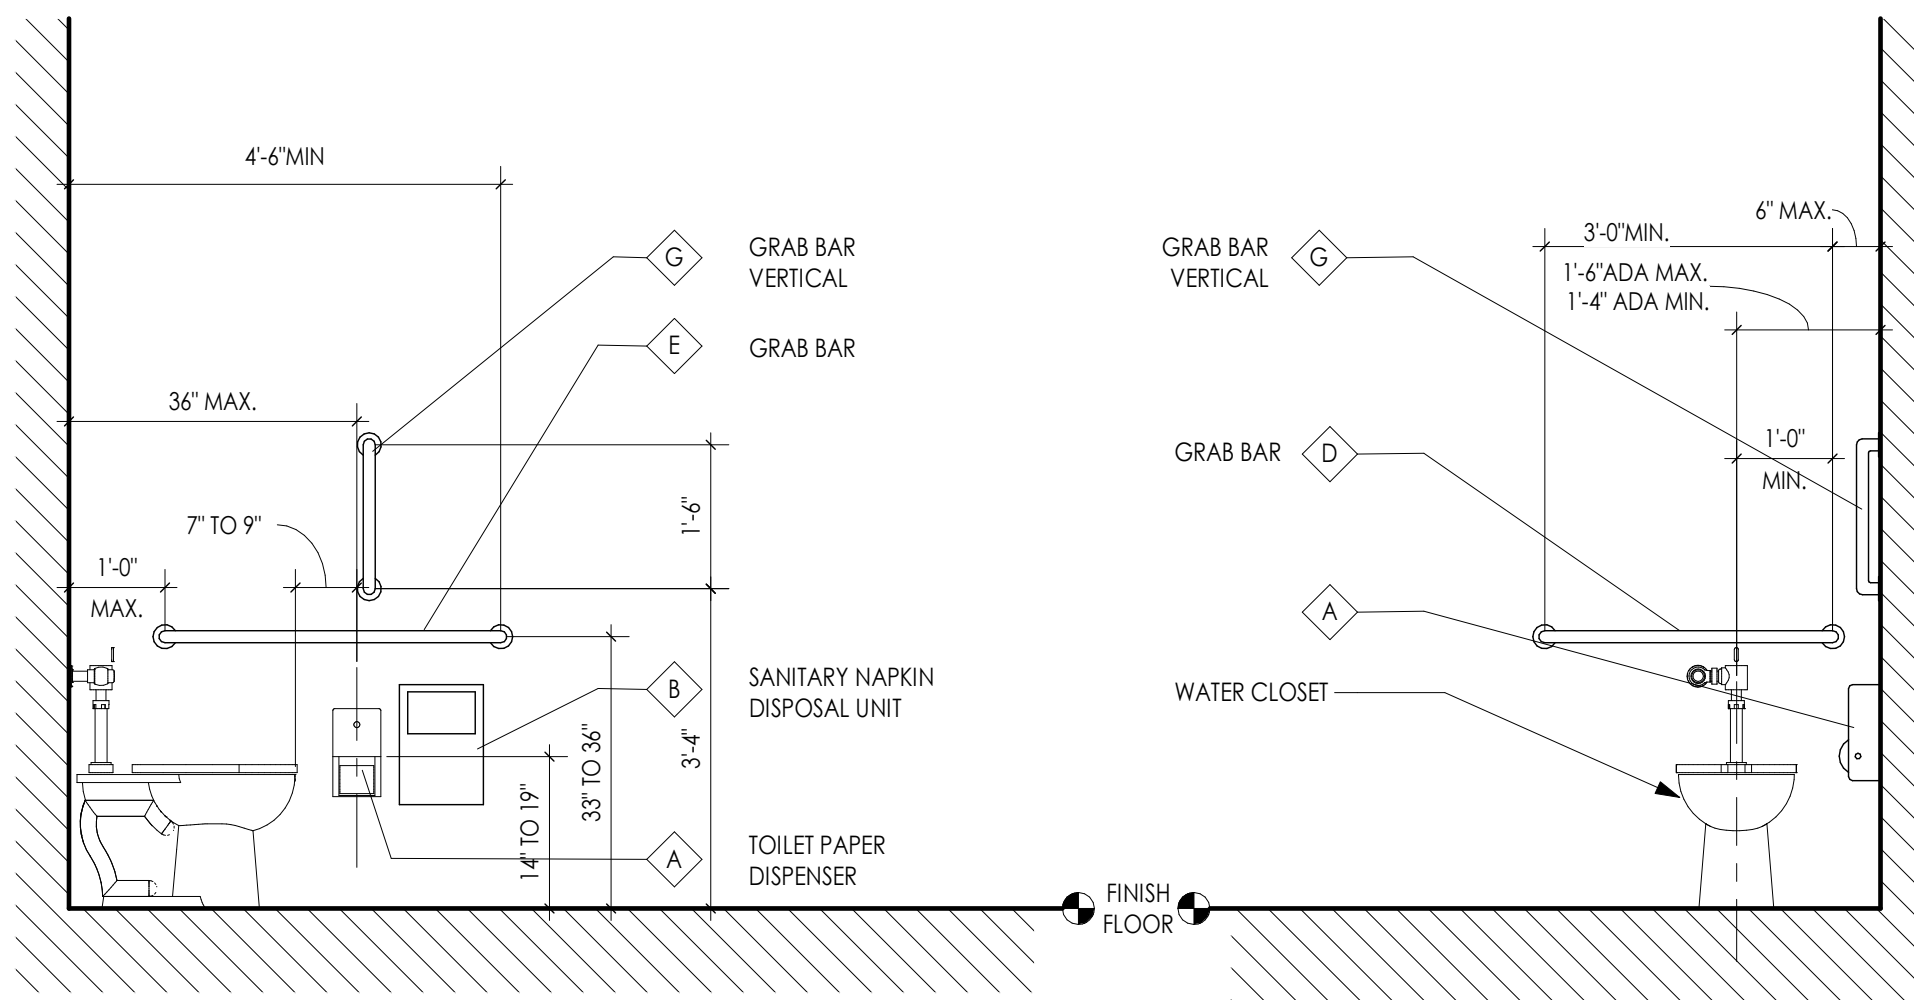


LOCATION AT TOILET

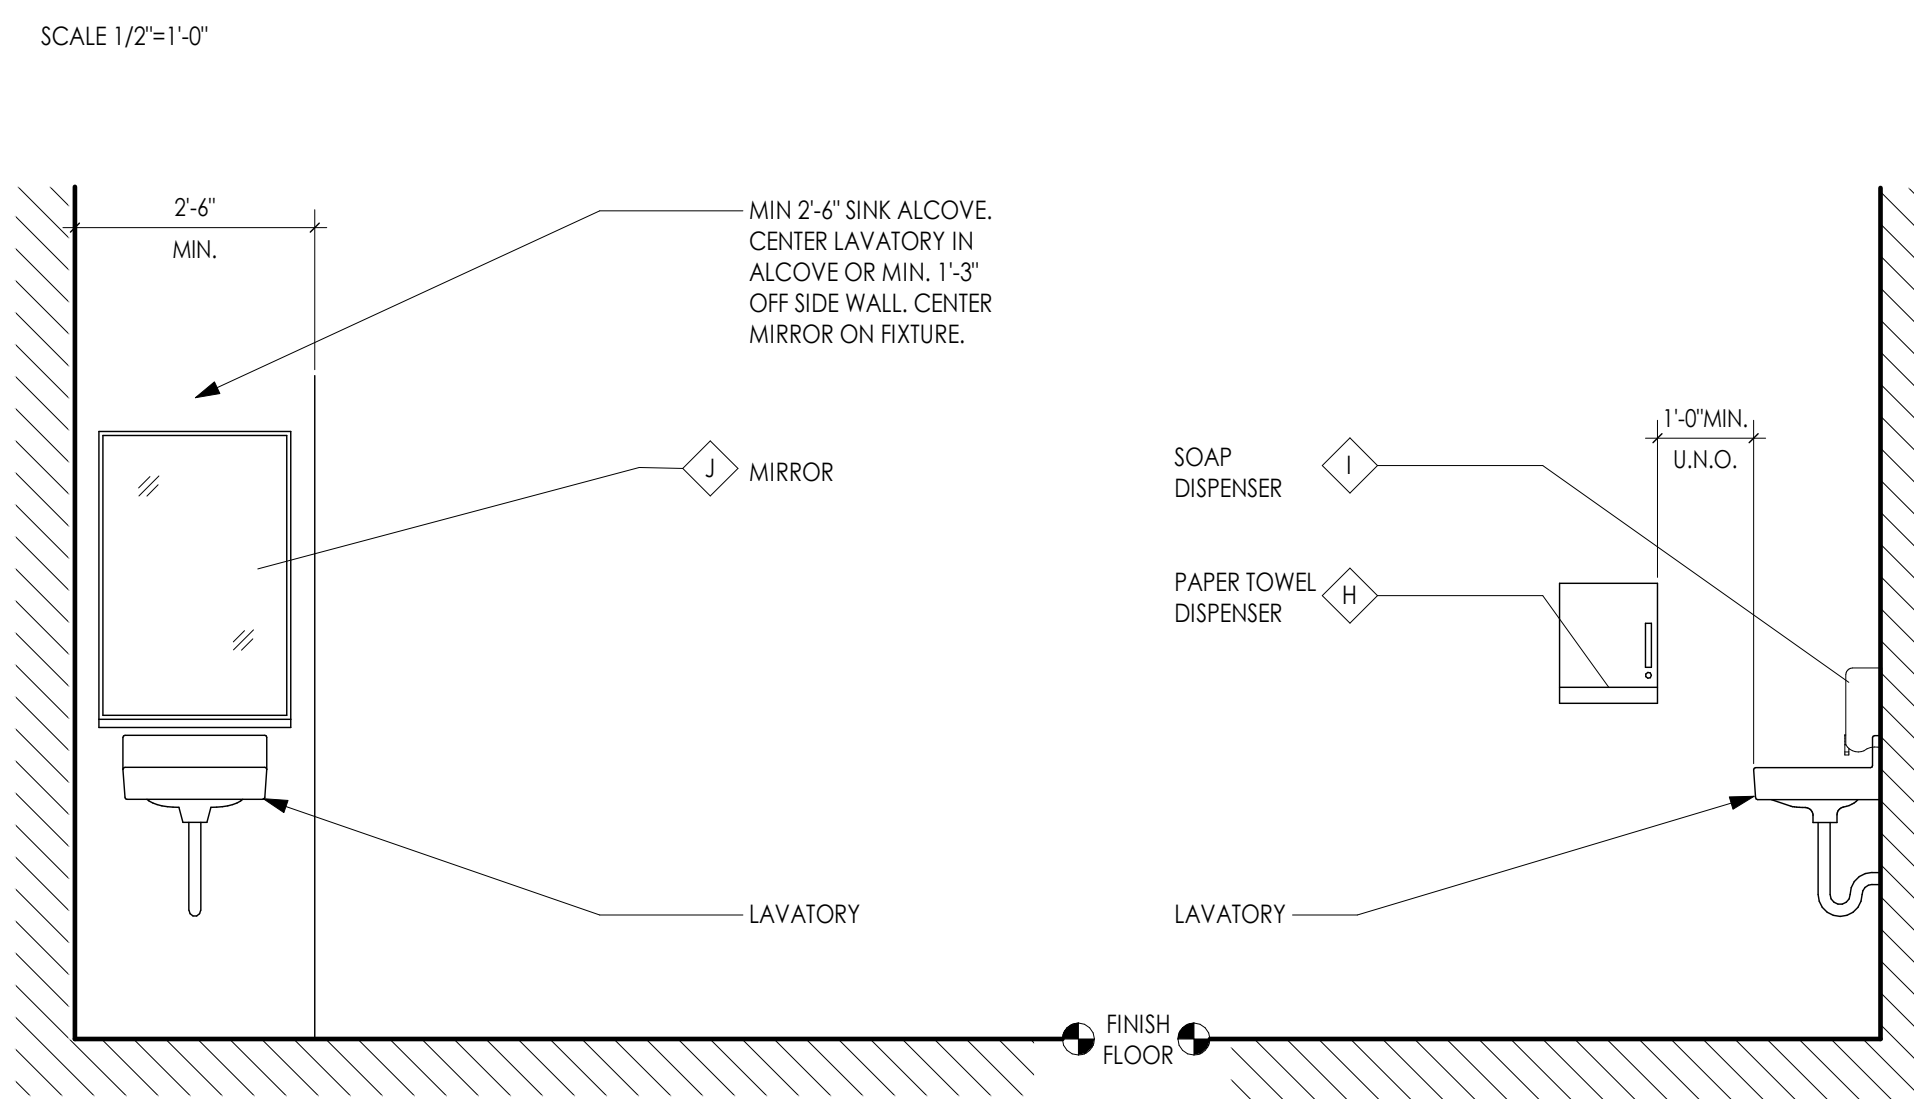

LOCATION AT SINK






DOOR SIGNAGE

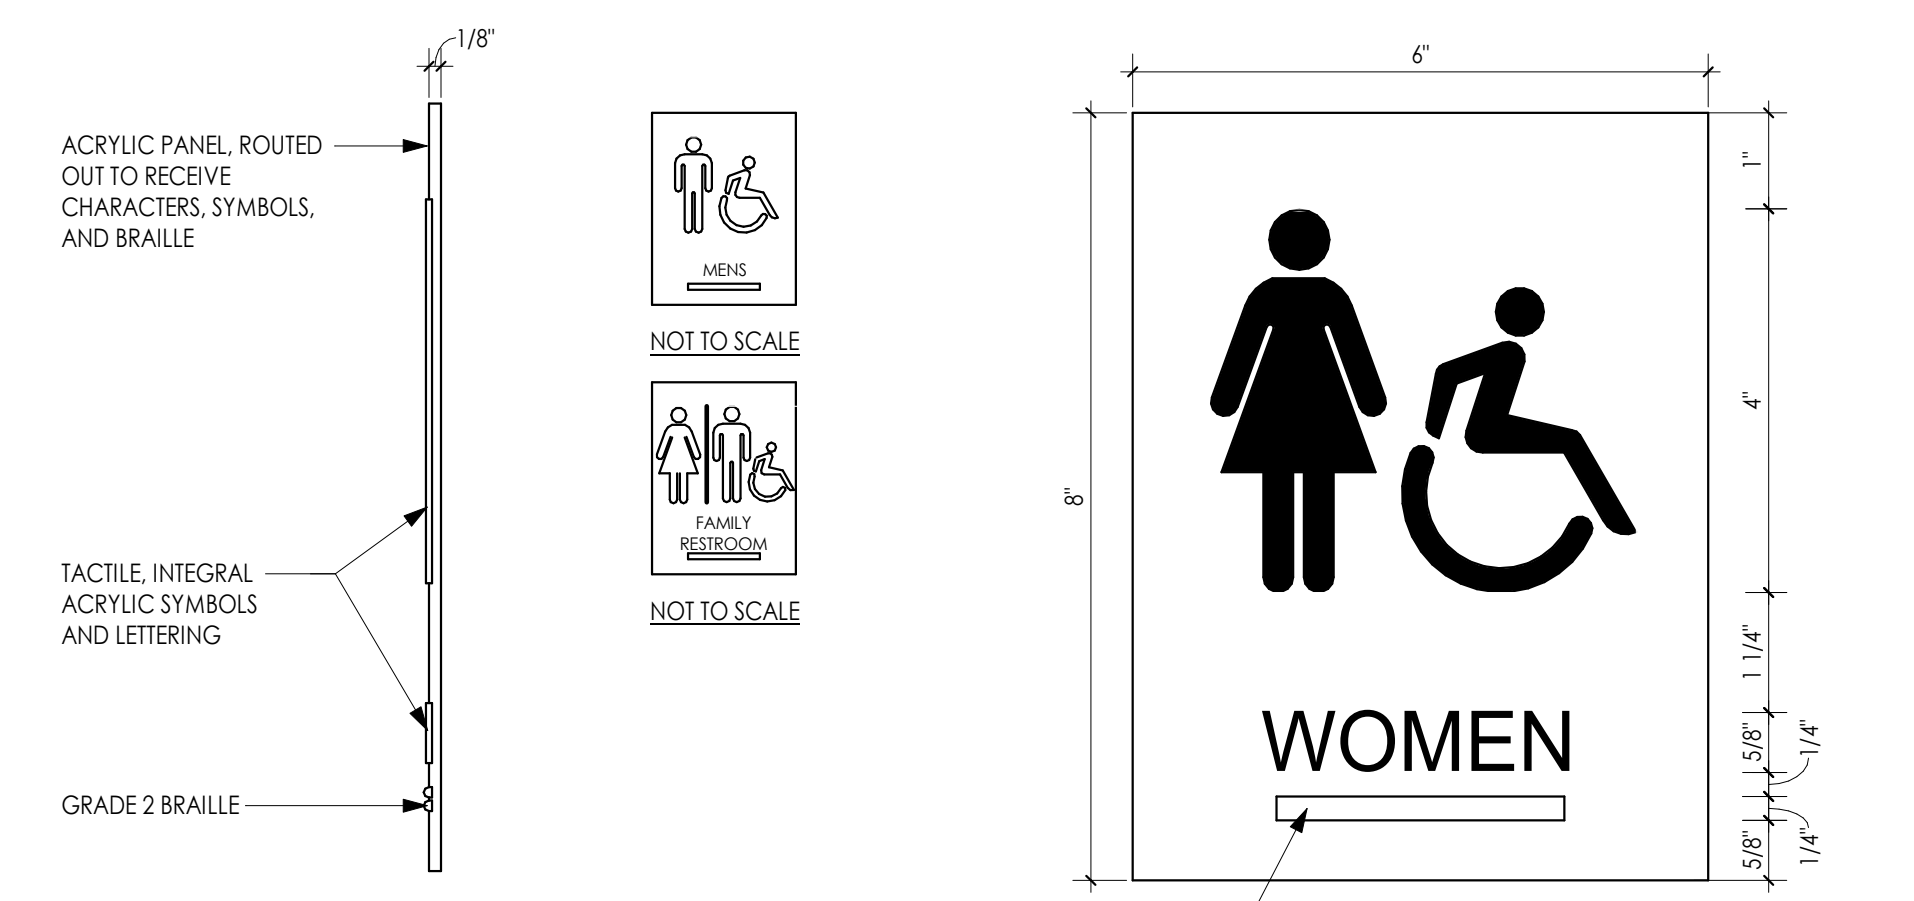


NOTES:
 TYPICAL FINISHES
 MATERIAL: 1/8" ACRYLIC WITH ADA COMPLIANT TEXT, SYMBOL AND BRAILLE.
 FINISH: BACKGROUND, TEXT AND SYMBOL COLORS TO BE SELECTED BY ARCHITECT. BRAILLE IS BACKGROUND COLOR. PROVIDE FINISH SAMPLES TO OWNER FOR VERIFICATION PRIOR TO FABRICATION.
 ALL EXTERIOR SIGNS SHALL BE EXTERIOR GRADE AND FADE RESISTANT.
 FONT: CENTURY GOTHIC
 MOUNTING: VHB TAPE WITH SILICONE FOR ALL SIGNS EXCEPT EXTERIOR. FOR EXTERIOR SIGNS, MOUNT CONCEALED WITH PLASTIC ANCHORS INTO BRICK/MORTAR. SIGNAGE COMPANY TO COORDINATE WITH ARCHITECT FOR MOUNTING OPTIONS TO CONSIDER. INSTALL AT HEIGHT IN COMPLIANCE WITH A117.1
 OTHER: ICC




PLUMBING FIXTURE LEGEND WITH MOUNTING HEIGHTS

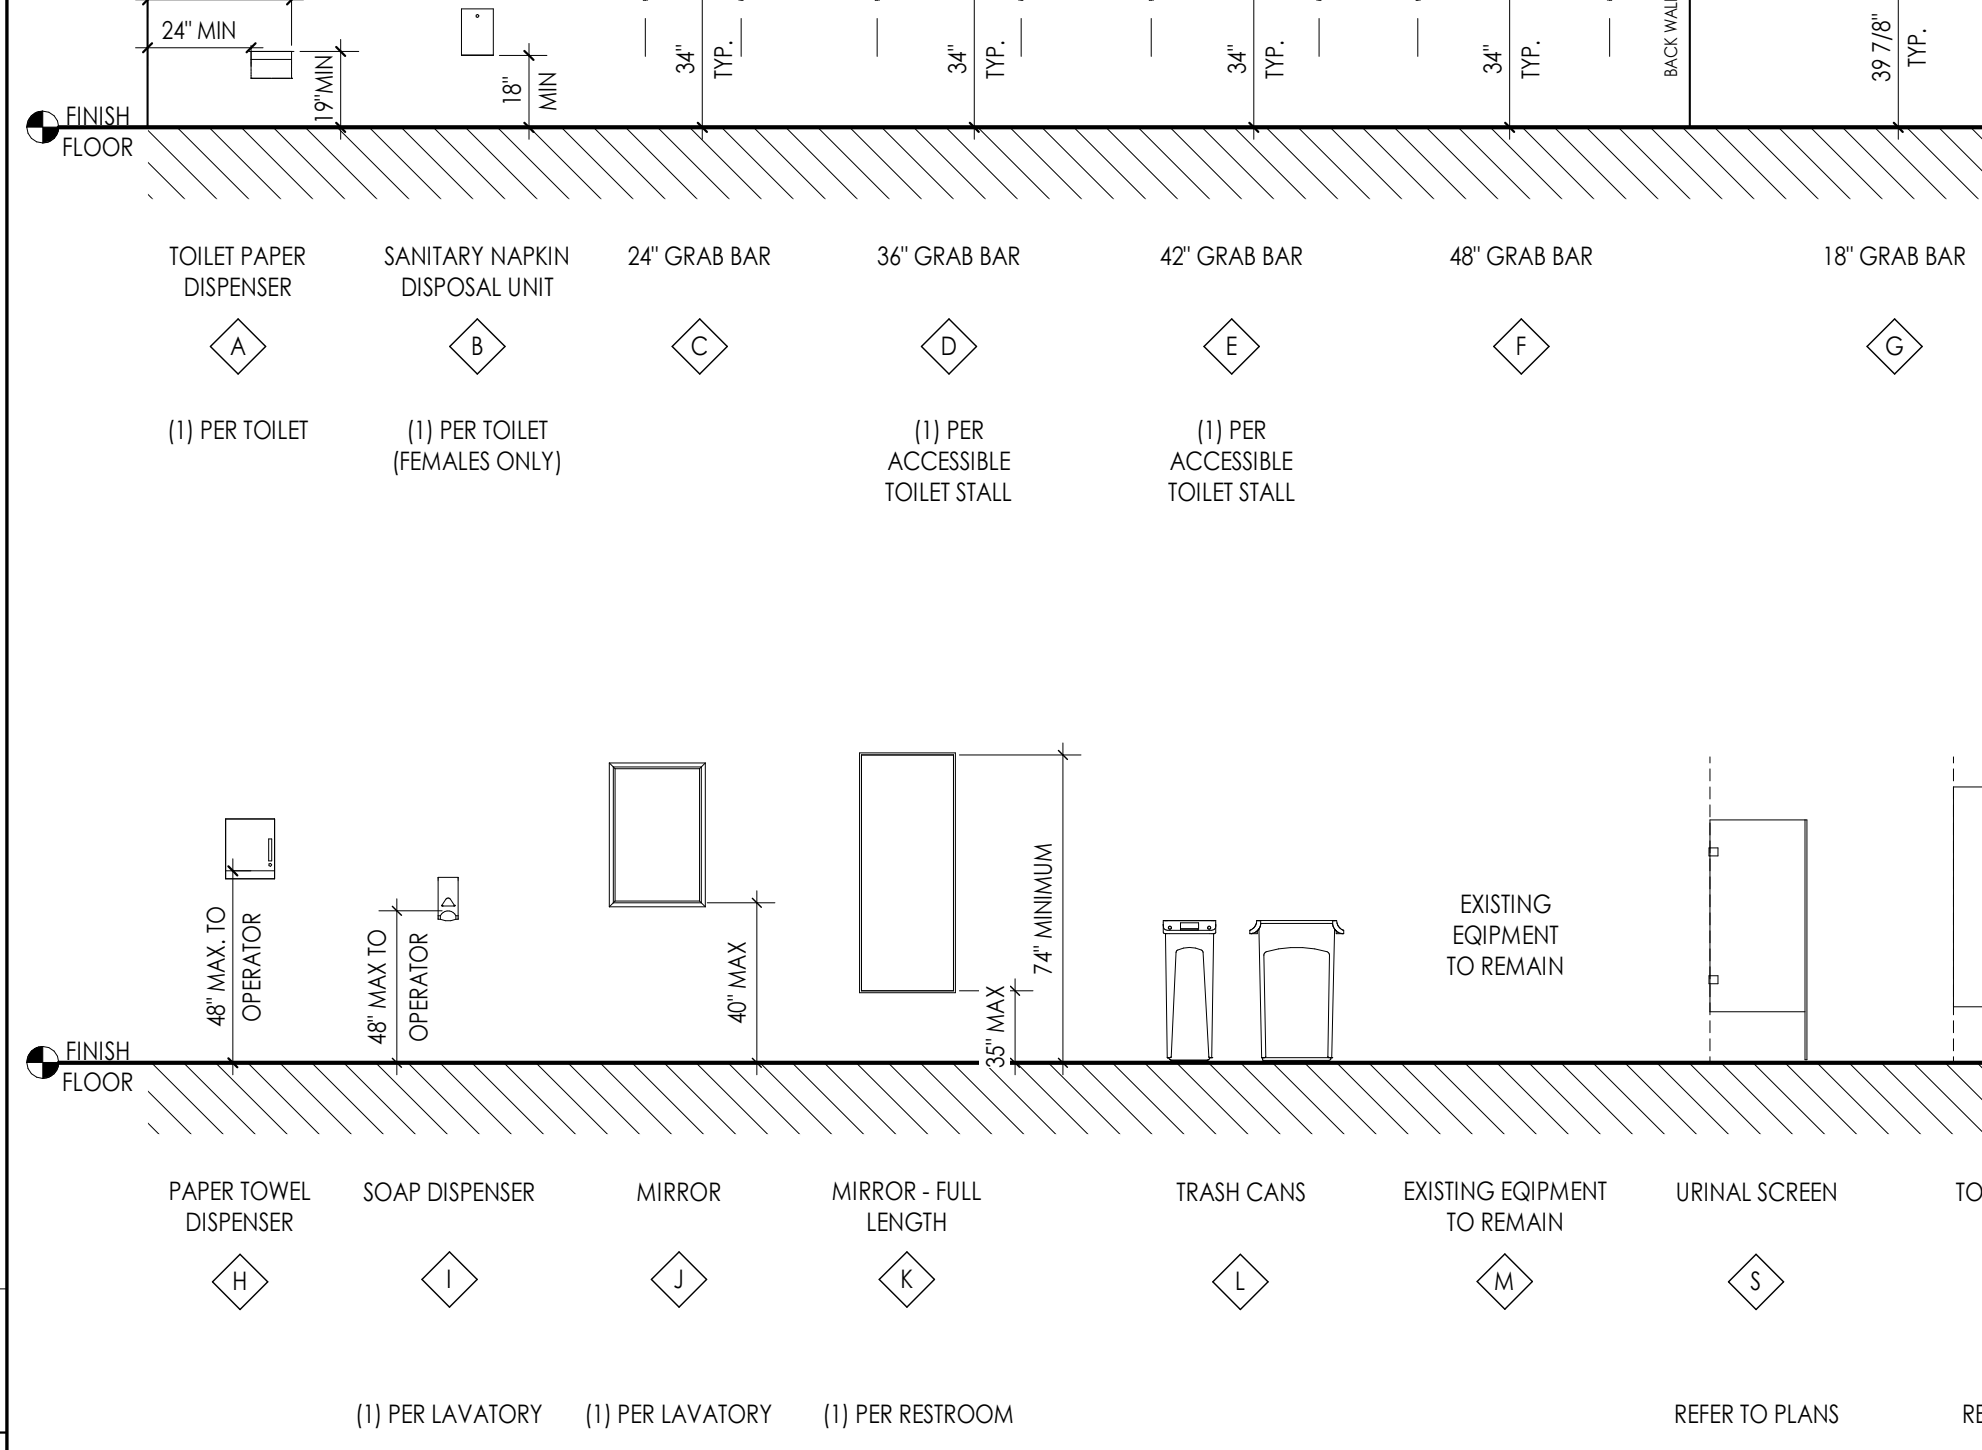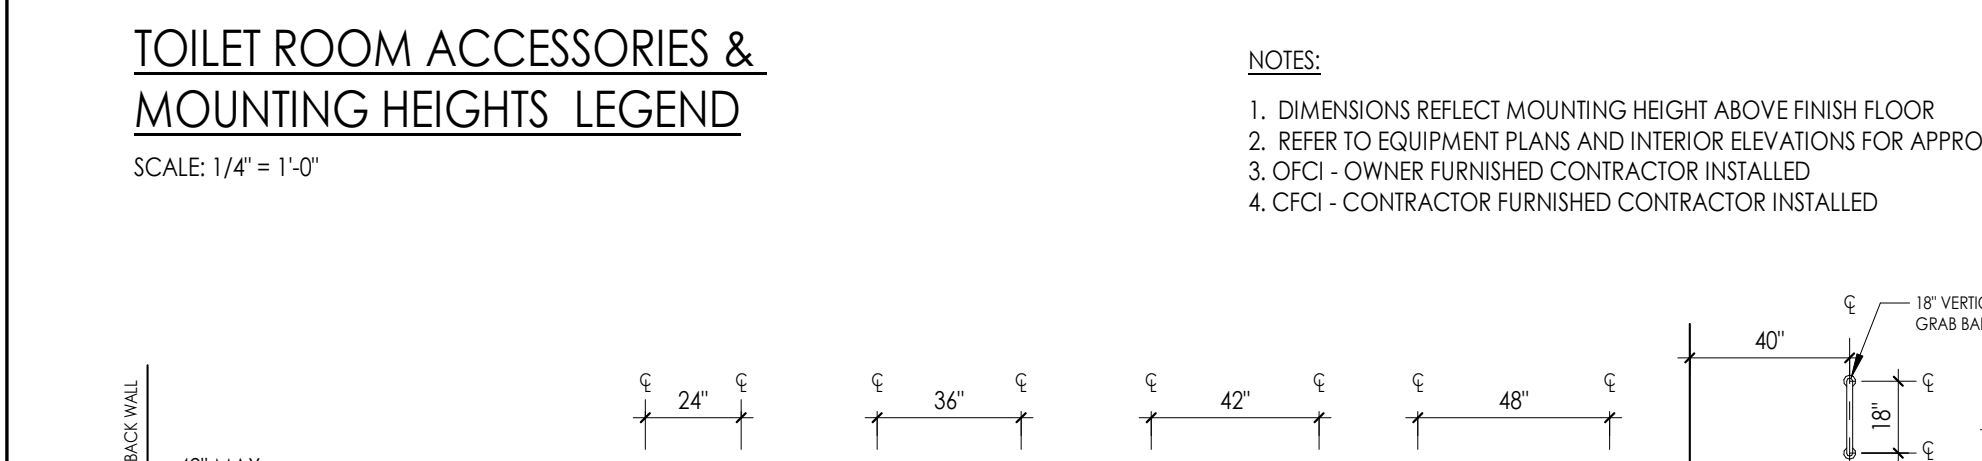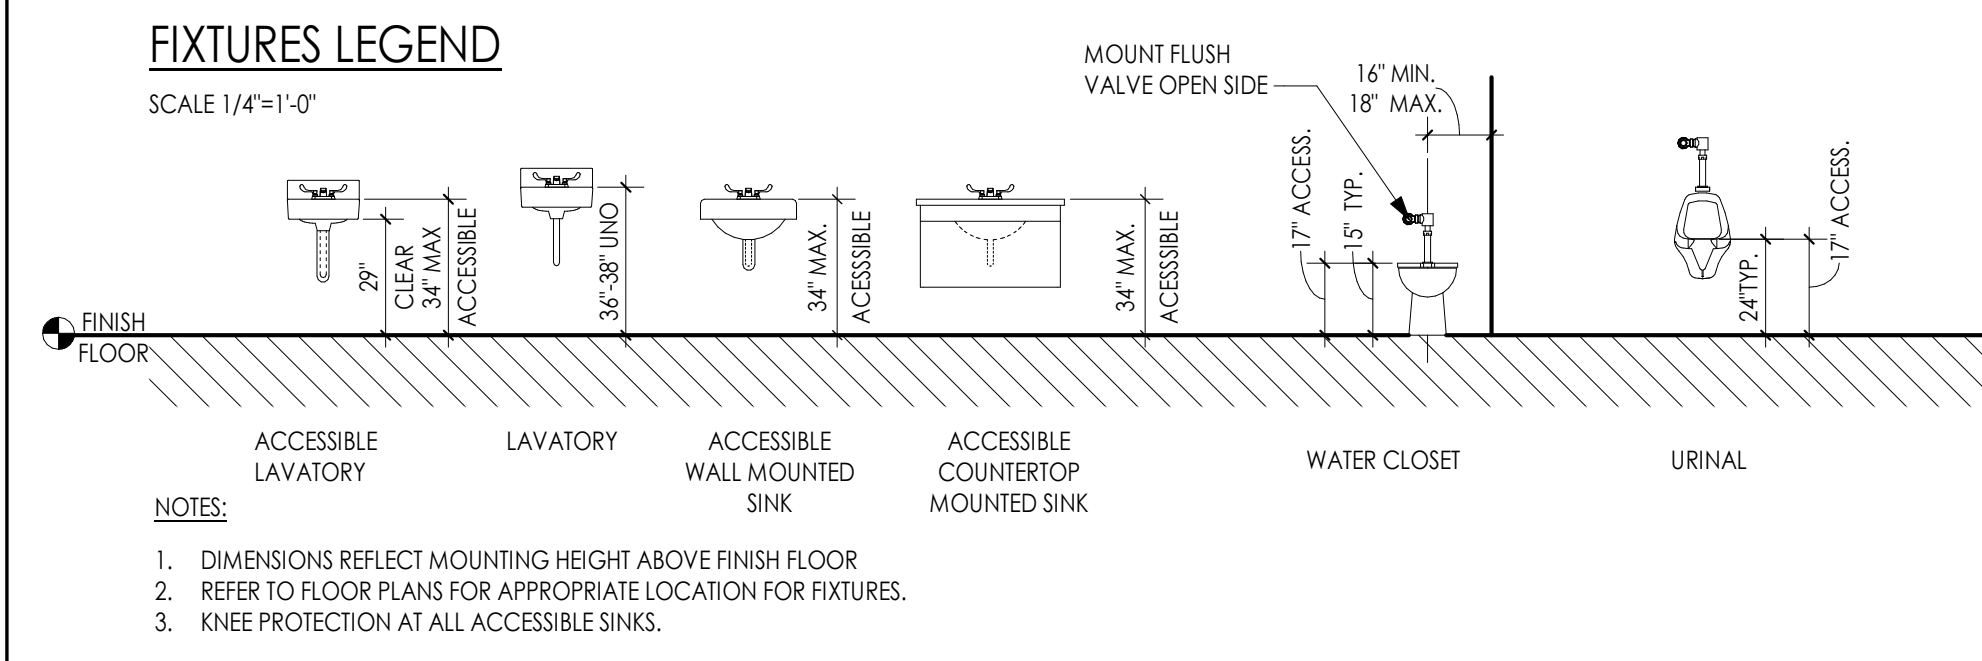

ACCESSORIES LEGEND WITH MOUNTING HEIGHTS


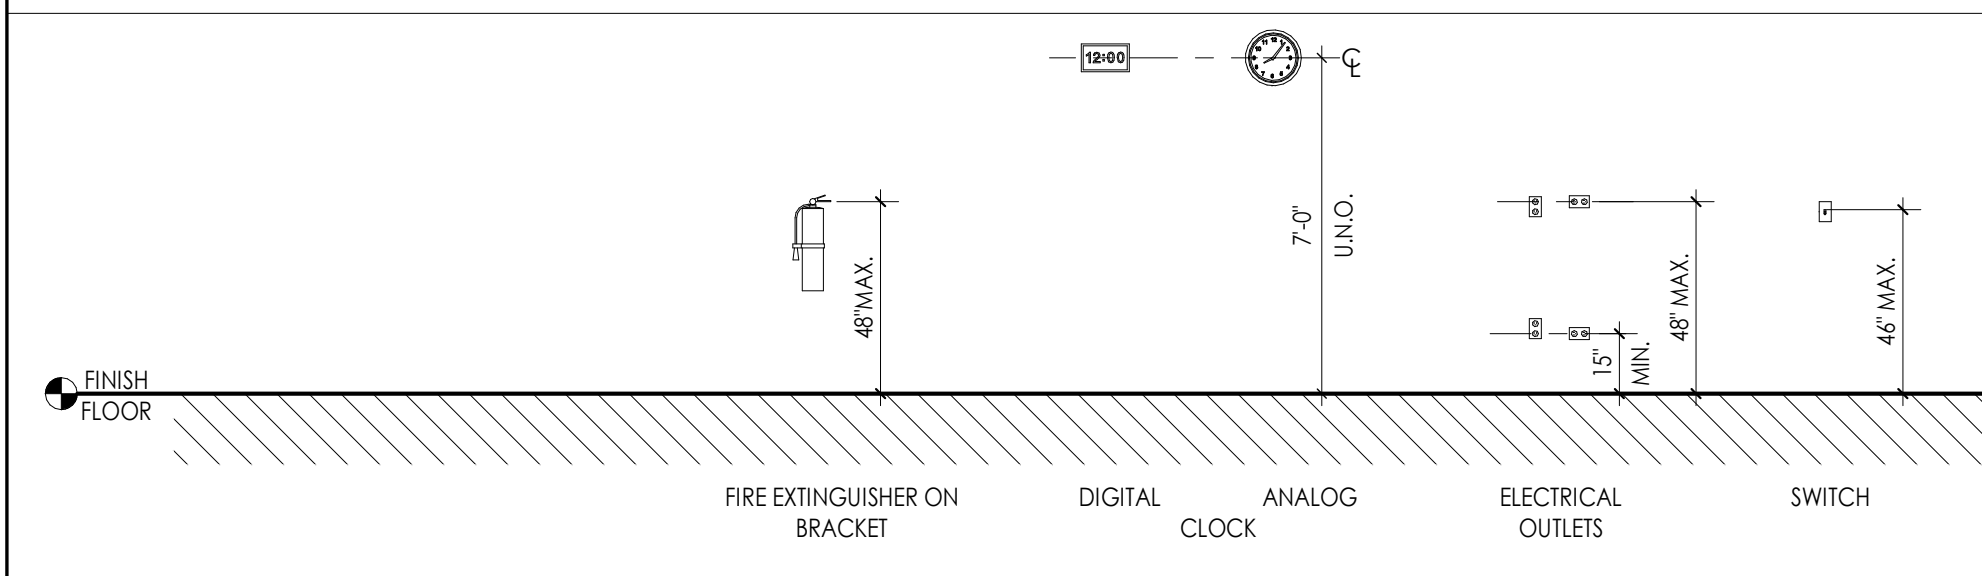


SPECIAL NOTE: THIS SHEET IS INCLUDED FOR REFERENCE PURPOSES ONLY. SOME FIXTURES AND MOUNTING HEIGHTS SHOWN MAY NOT APPLY TO THE CURRENT DOCUMENTS

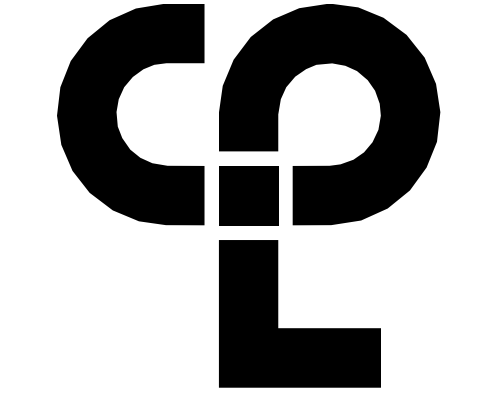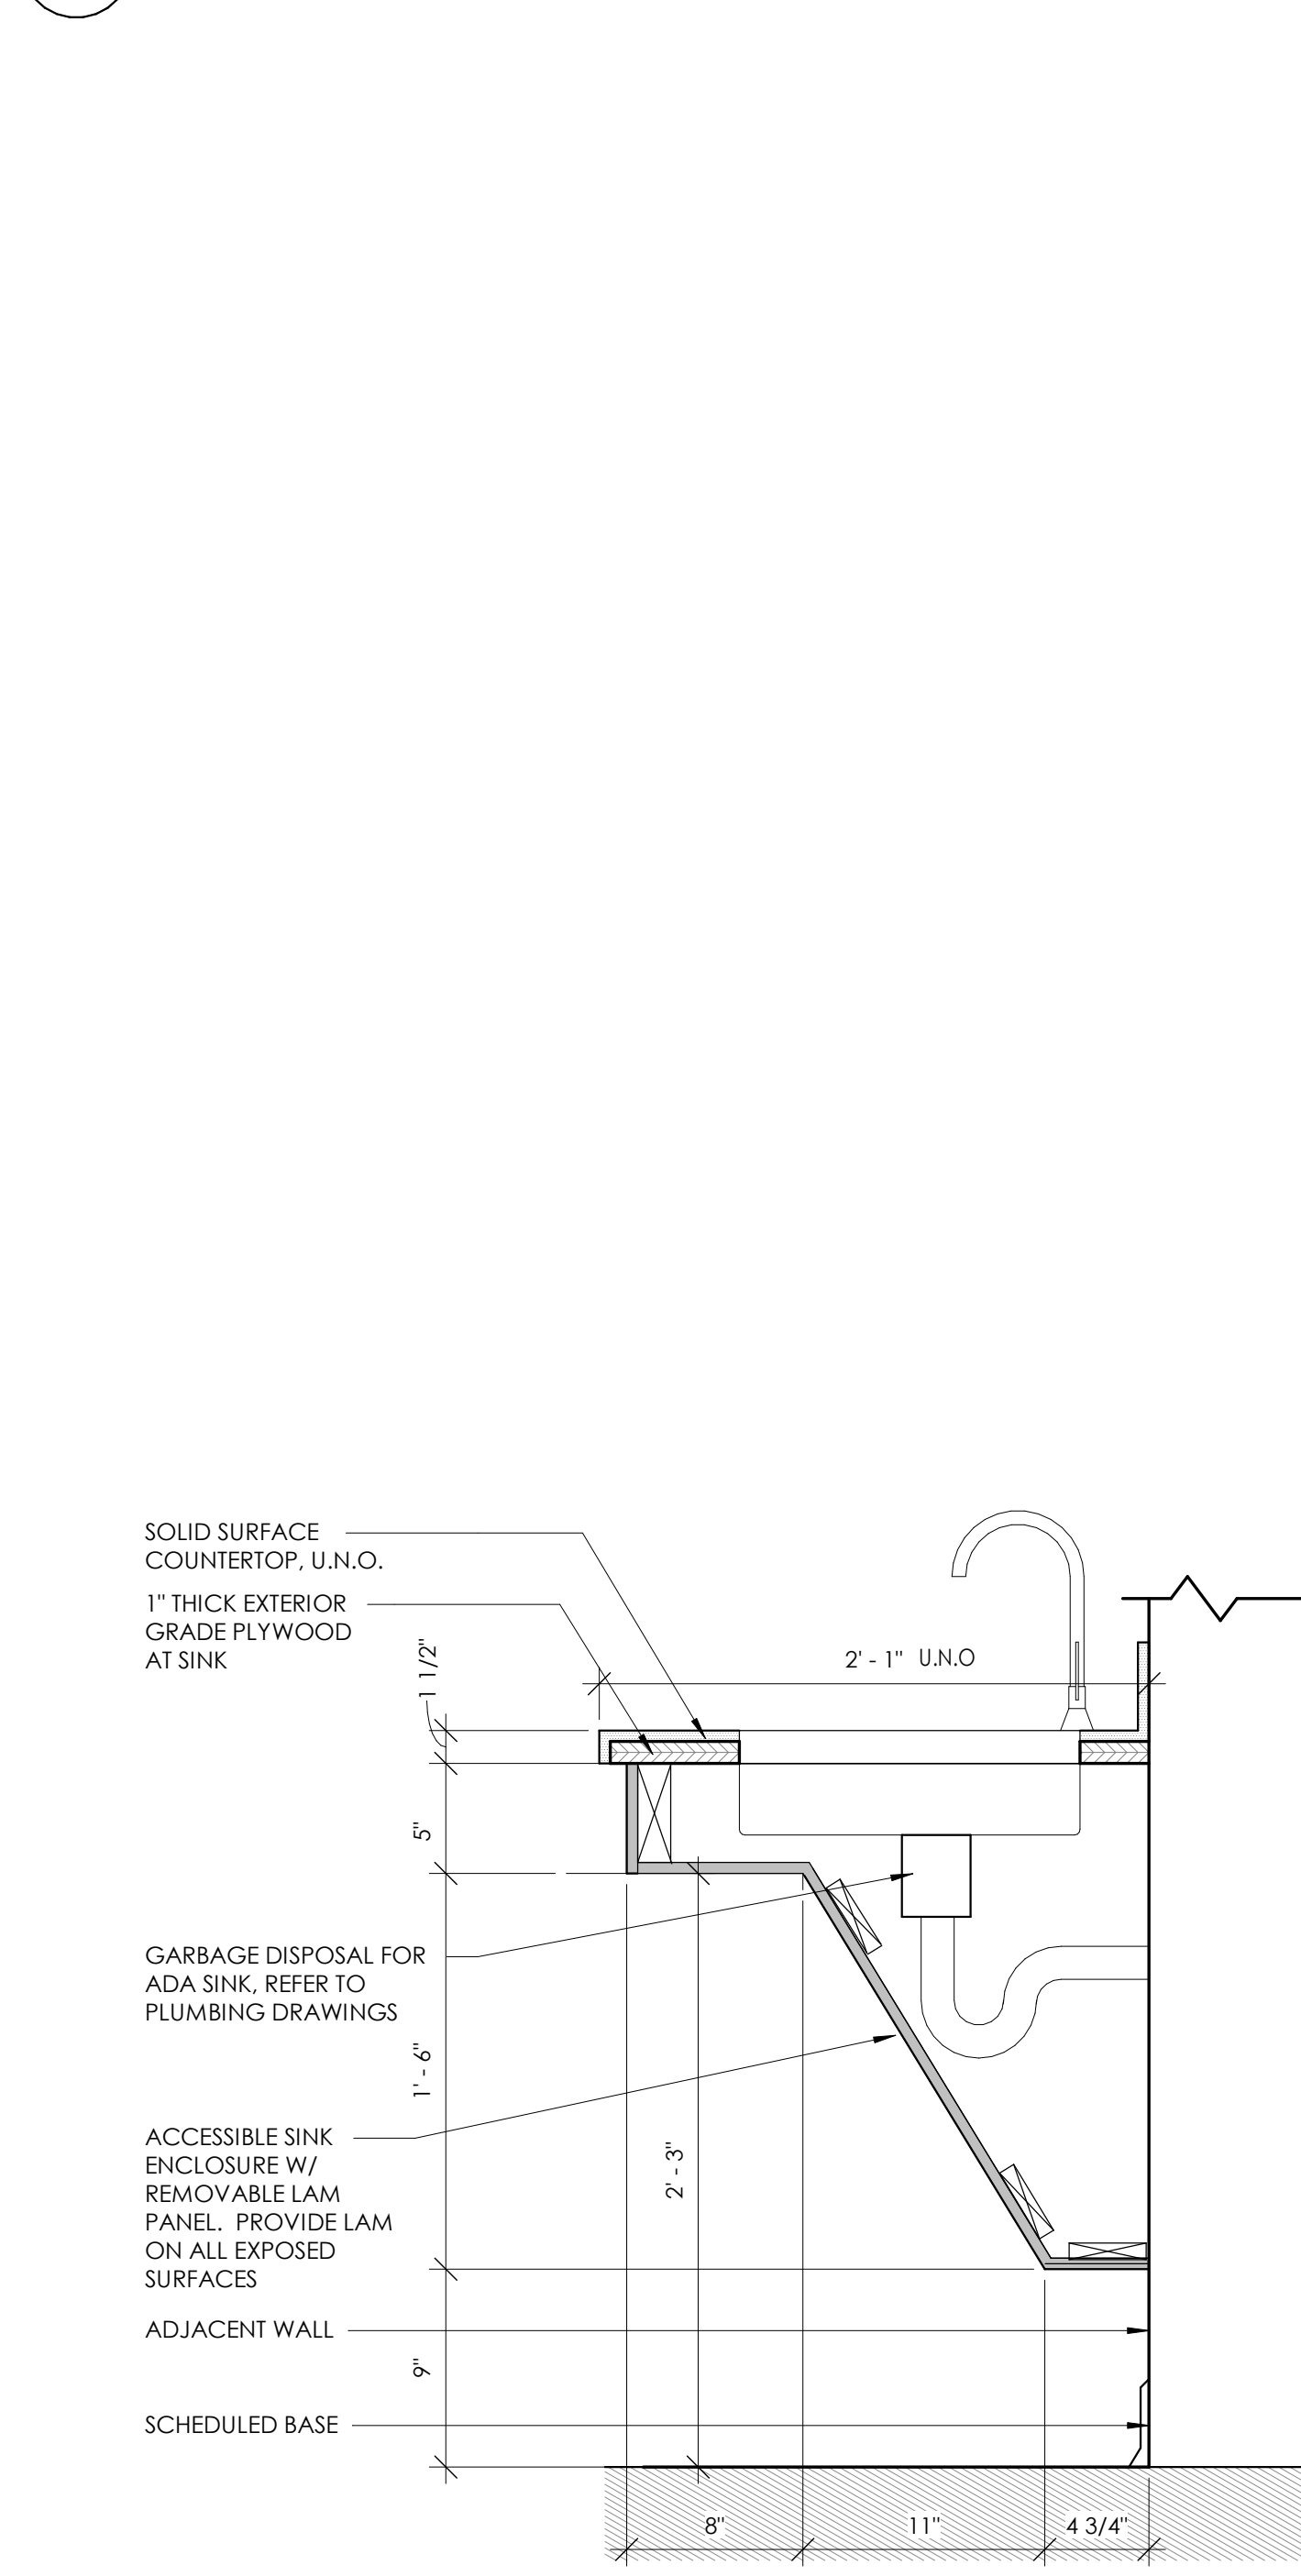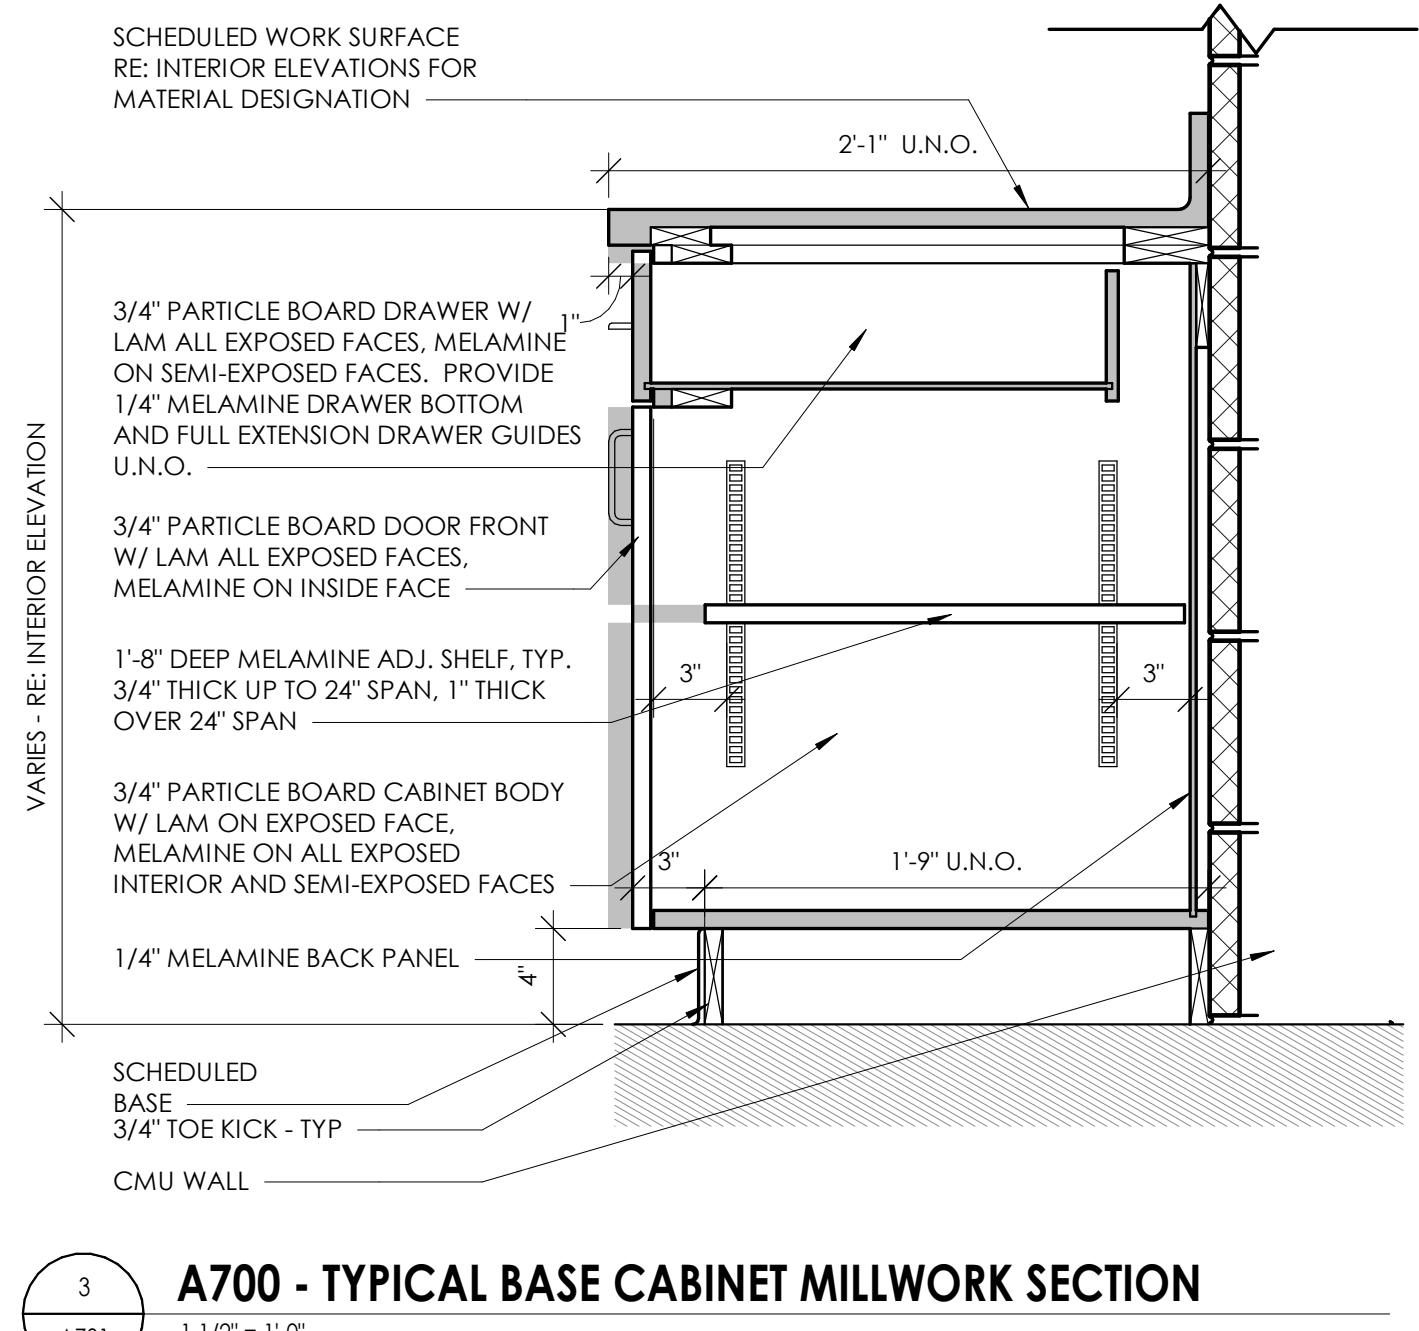

PROJECT INFORMATION
 Project Number: R22.16900.00
 Client Name: WILSON COUNTY SCHOOLS
 Project Name: HUNT HS - ATHLETICS RENOVATION HUNT HIGH SCHOOL
 Project Address: 4559 Lamm Rd, Wilson, NC 27893


PROJECT ISSUE & REVISION SCHEDULE
 No. Date Description

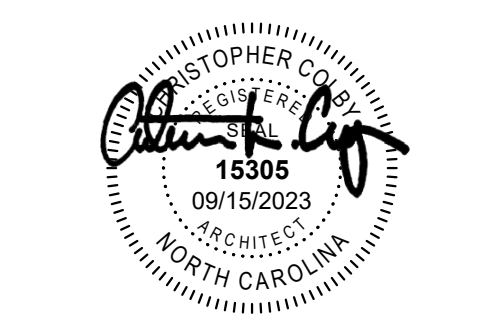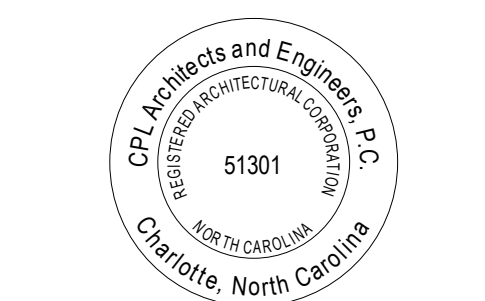

SHEET INFORMATION
 Issued: 09.15.2023 Scale: As Indicated
 Project Status: 100% CONSTRUCTION DOCUMENTS
 Drawn By: EG Checked By: GB
 Drawing Title: GENERAL TYP. FIXTURE AND ACCESS. HEIGHTS AND LEGENDS

Drawing Number

9/22/2023 9:59:38 AM S:\Projects\Wilson_County_Schools\Athletic_Renov\Design\CAD\Revit\Civil.dwg

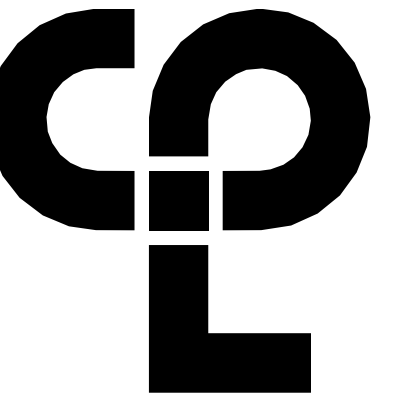

PROJECT INFORMATION
 Project Number: R22.16900.00
 Client Name: WILSON COUNTY SCHOOLS
 Project Name: HUNT HS - ATHLETICS RENOVATION
 HUNT HIGH SCHOOL
 Project Address: 4559 Lamm Rd, Wilson, NC 27893
PROJECT ISSUE & REVISION SCHEDULE
 No. Date Description



SHEET INFORMATION
 Issued: 09.15.2023 Scale: As Indicated
 Project Status: 100% CONSTRUCTION DOCUMENTS
 Drawn By: EG Checked By: GB
 Drawing Title: RESTROOM BUILDING ACCESSORY FLOOR PLAN AND INTERIOR ELEVATIONS
 Drawing Number:

A702

FINISH PLAN GENERAL NOTES

- ALL NEW AND EXISTING HOLLOW METAL DOORS, DOOR FRAMES AND WINDOW FRAMES IN PROJECT SCOPE SHALL BE PAINTED EPT-2, UNLESS NOTED OTHERWISE (U.N.O.).
- ALL COVERS, VENTS, GRILLES AND OTHER MISCELLANEOUS MECHANICAL AND ELECTRICAL DEVICES ARE TO BE PAINTED TO MATCH THE SURFACE ON WHICH THEY APPEAR, UNLESS NOTED OTHERWISE (U.N.O.).
- REFER TO A100 SERIES DRAWINGS FOR CEILING TYPES.
- ALL SOFFITS, FASCIA AND TRIM TO BE REPAIRED AND REPLACED AS NEEDED. FASCIA AND TRIM TO BE PREPPED AND PAINTED EPT-4, SOFFIT TO BE PREPPED AND PAINTED EPT-1.
- UNDERSIDE OF SOFFITS TO MATCH FACE OF SOFFIT. SEE A100 SERIES FOR PAINT ACCENT SPECIFICATIONS. PAINT CEILING FINISHES.
- REFER TO A700 SERIES INTERIOR ELEVATIONS FOR MILLWORK FINISHES.
- HIGH PRESSURE PLASTIC LAMINATE ON VERTICAL SURFACES TO RUN VERTICALLY, UNLESS NOTED OTHERWISE (U.N.O.).
- ALL GROUT TO BE SEALED A MINIMUM OF TWO TIMES PRIOR TO COMPLETION.
- WHERE KICKSPACES OCCUR AT MILLWORK, FLOOR FINISH SHOWN ON PLANS SHALL RUN UNDERNEATH KICKSPACE AS WELL.

FINISH ABBREVIATIONS

NOTE: THIS LEGEND MAY CONTAIN ABBREVIATIONS THAT ARE NOT IN THIS PROJECT

DS	DIVIDER STRIP	PTM	PATCH TO MATCH
EPT	EPOXY PAINT	RB	RESILIENT BASE
ERF	EPOXY RESIN FLOOR	SCON	SEALED CONCRETE
ETR	EXISTING TO REMAIN	SSM	SOLID SURFACE MATERIAL
EXP	EXPOSED	SV	SHEET VINYL
FILM	FILM	SWP	SHEET WALL PROTECTION
FRP	FIBER REINFORCED PANEL	TER	TERRAZZO
GRT	GROUT	TR	TRIM
HDPE	HIGH DENSITY POLY ETHYLENE	TS	TRANSITION STRIP
INT	INTEGRAL	WC	WALL COVERING
LVT	LUXURY VINYL TILE	WD	WOOD
PT	PAINT	WG	WALL GUARD


FINISH PLAN SYMBOLS LEGEND

NOTE: THIS LEGEND MAY CONTAIN SYMBOLS THAT ARE NOT IN THIS PROJECT


ROOM NUMBER	MULTIPURPOSE ROOM	ROOM NAME
WALL FINISH(ES)	ROOM AREA	ROOM AREA
	BASE FINISH (ES)	FLOOR FINISH(ES)
	MULTICATEGORY TAG	

INTERIOR FINISH SCHEDULE


FINISH CODE	MANUFACTURER	PATTERN/STYLE	COLOR	SIZE	SPECIFICATIONS	NOTES
EPOXY PAINT (EPT)						
EPT-1	SHERWIN WILLIAMS	WHITE	TO BE SELECTED BY ARCHITECT			Pantone 000C
EPT-2	SHERWIN WILLIAMS	BLUE	TO BE SELECTED BY ARCHITECT			Pantone 288C
EPT-3	SHERWIN WILLIAMS	GRAY	TO BE SELECTED BY ARCHITECT			Pantone 8C
EPT-4	SHERWIN WILLIAMS	BLACK	TO BE SELECTED BY ARCHITECT			PANTONE 6C
EPT-5	SHERWIN WILLIAMS	DARK BLUE	TO BE SELECTED BY ARCHITECT			PANTONE 289C
EPOXY RESIN FLOOR (ERF)						
ERF-1	EUCLID	DURALTEX	TO BE SELECTED BY ARCHITECT			
FRP						
FRP-1	MARLITE	S100G	WHITE			CLASS C
PLASTIC LAMINATE (LAM)						
LAM-1	FORMICA	8552-NG	BLACK BIRCHPLY			
RESILIENT BASE (RB)						
RB-1	MOHAWK GROUP	VINYL COVER BASE	CHARCOAL 958	4" H	120' COILS	COVE
SOLID SURFACE MATERIAL (SSM)						
SSM-1	DUPONT	CORIAN	NEUTRAL AGGREGATE			
STAINLESS STEEL WALL PANEL						
SSP-1	INPRO CORP	STAINLESS STEEL				
TOILET PARTITION (TP)						
TP-1	ASI	THRU-COLOR PHENOLIC	SMOKE 8450C		FLOOR ANCHORED/OVERHEAD BRACED	
URINAL SCREENS (US)						
US-1	ASI	THRU-COLOR PHENOLIC	SMOKE 8450C	48"	WALL HUNG	

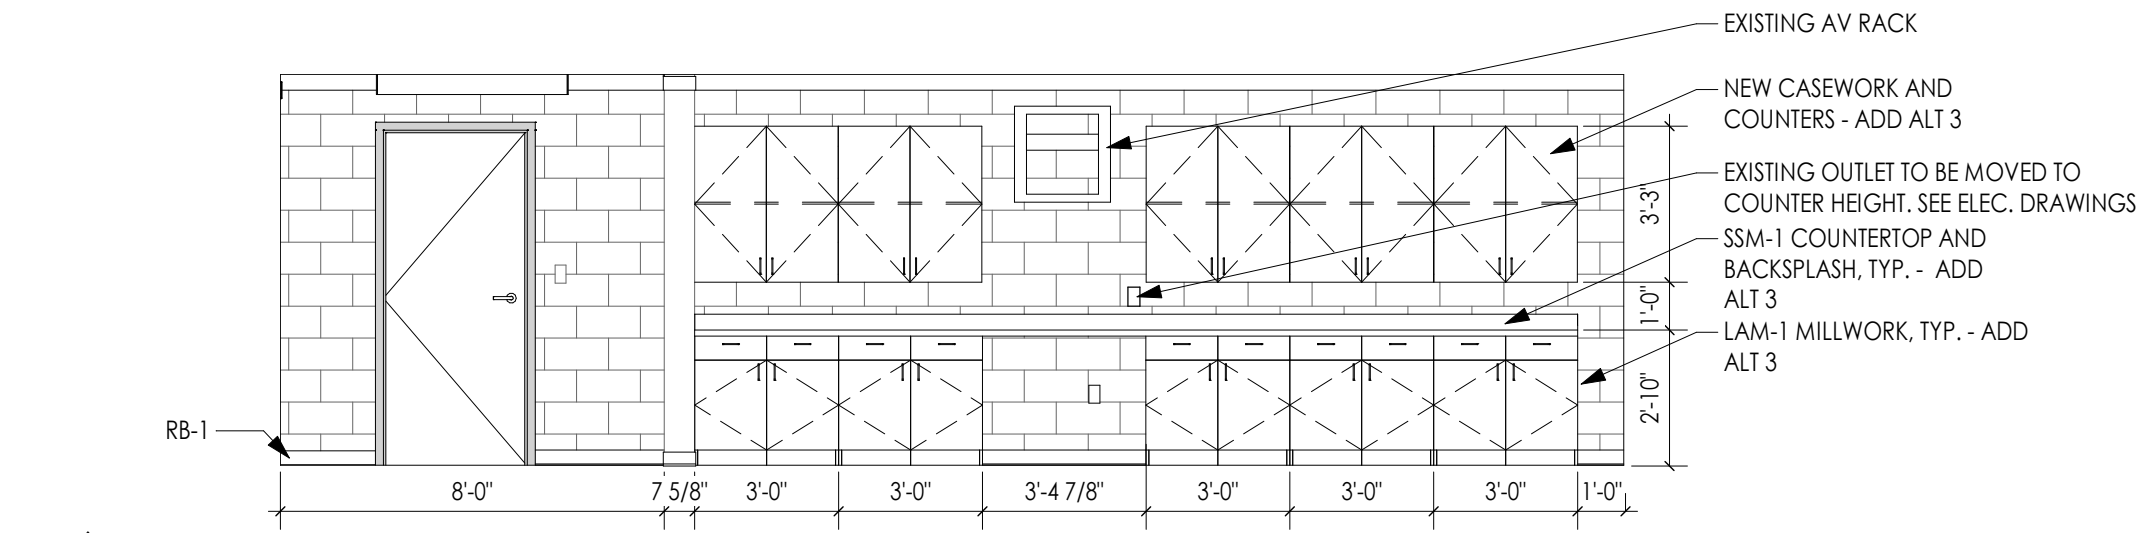


7 TRAINING ROOM - SOUTH
1/4" = 1'-0"

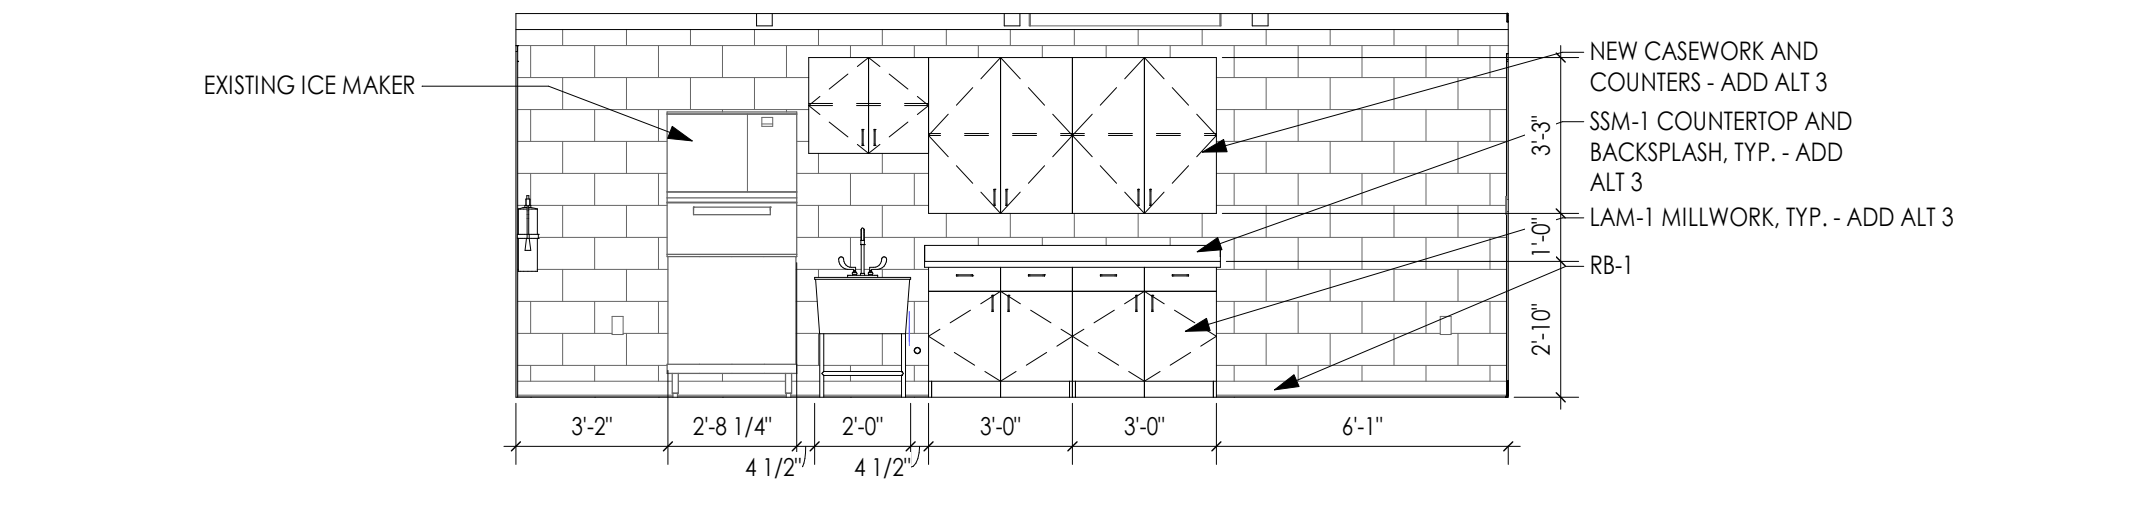


6 TRAINING ROOM - EAST
1/4" = 1'-0"

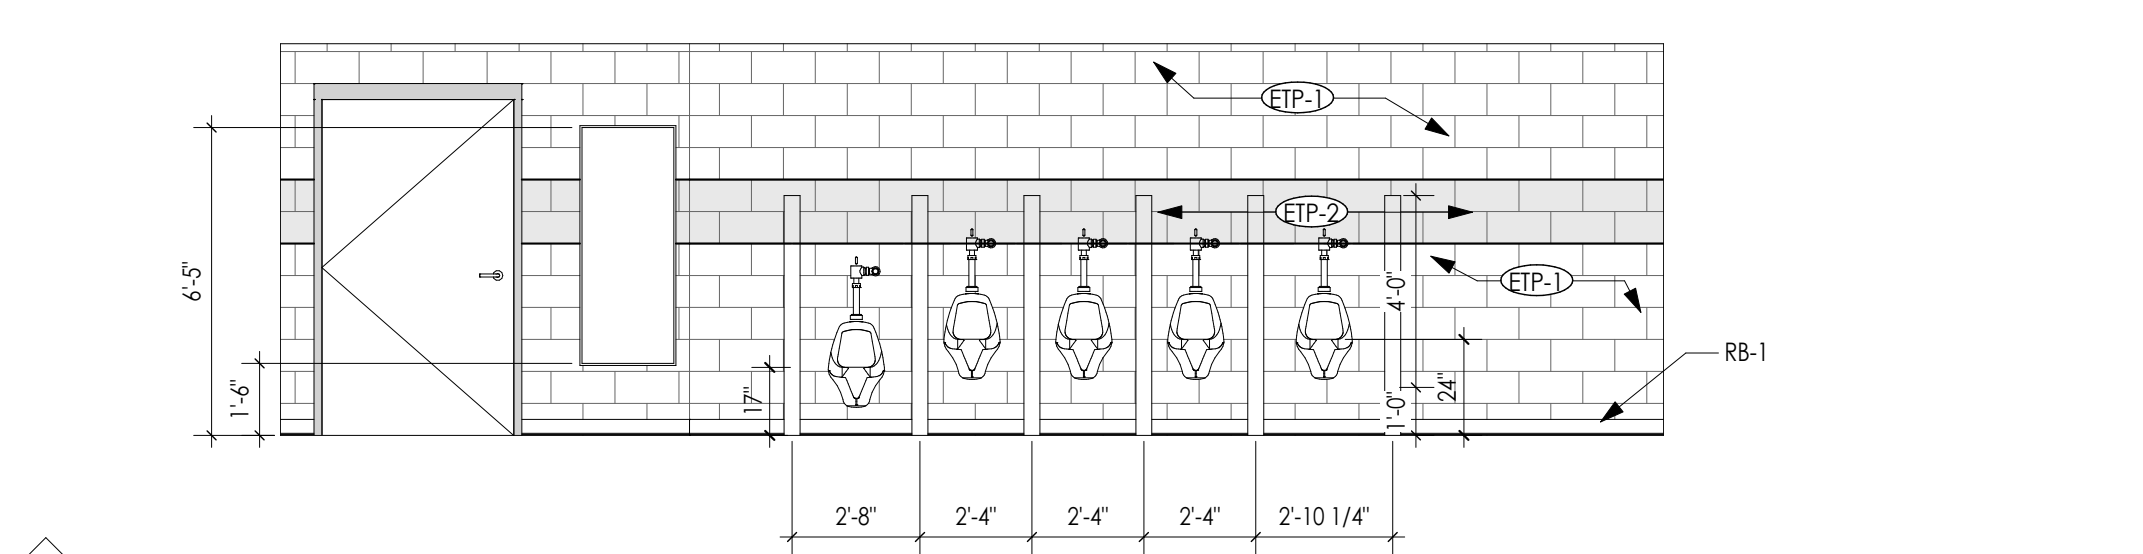


5 MEN'S RESTROOM - SOUTH FACING
1/4" = 1'-0"

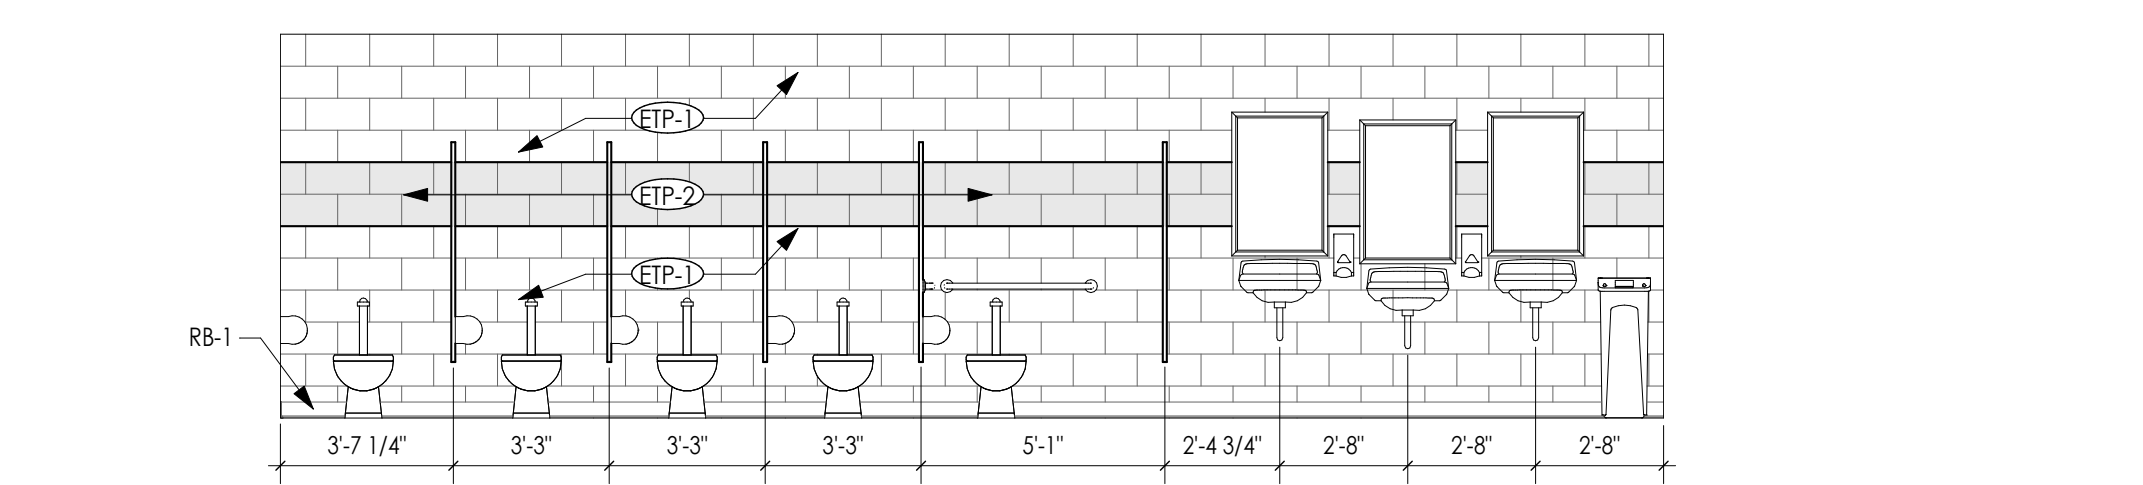


4 MEN'S RESTROOM - NORTH FACING
1/4" = 1'-0"

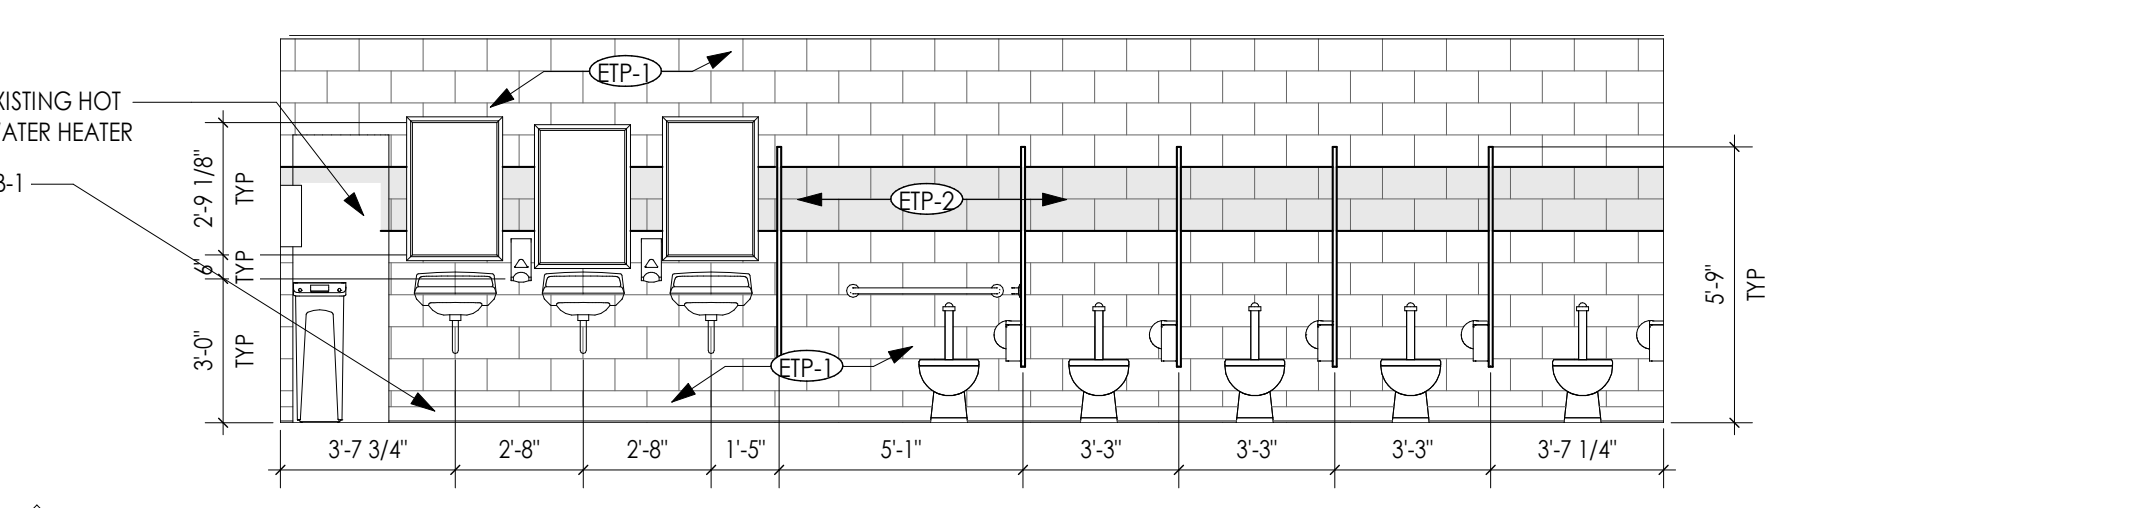

3 WOMEN'S RESTROOM - SOUTH FACING
1/4" = 1'-0"

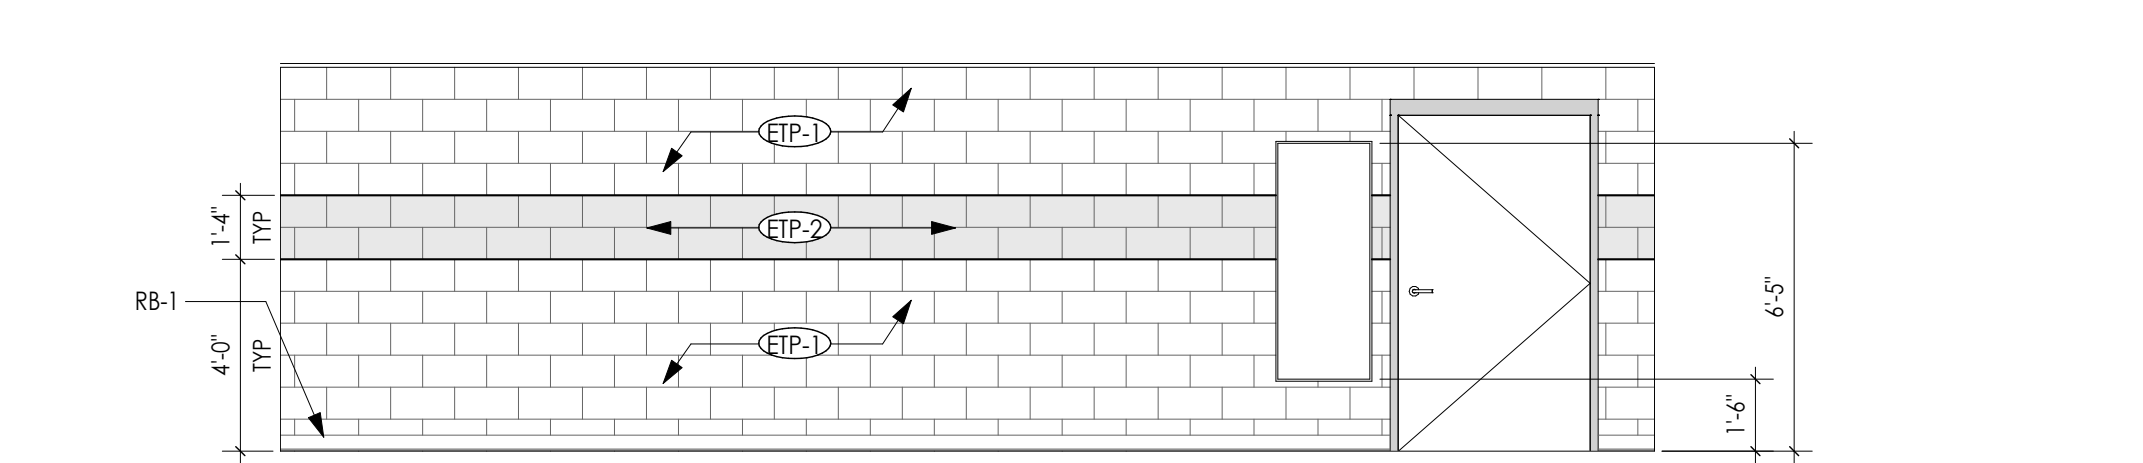


2 WOMEN'S RESTROOM - NORTH FACING
1/4" = 1'-0"

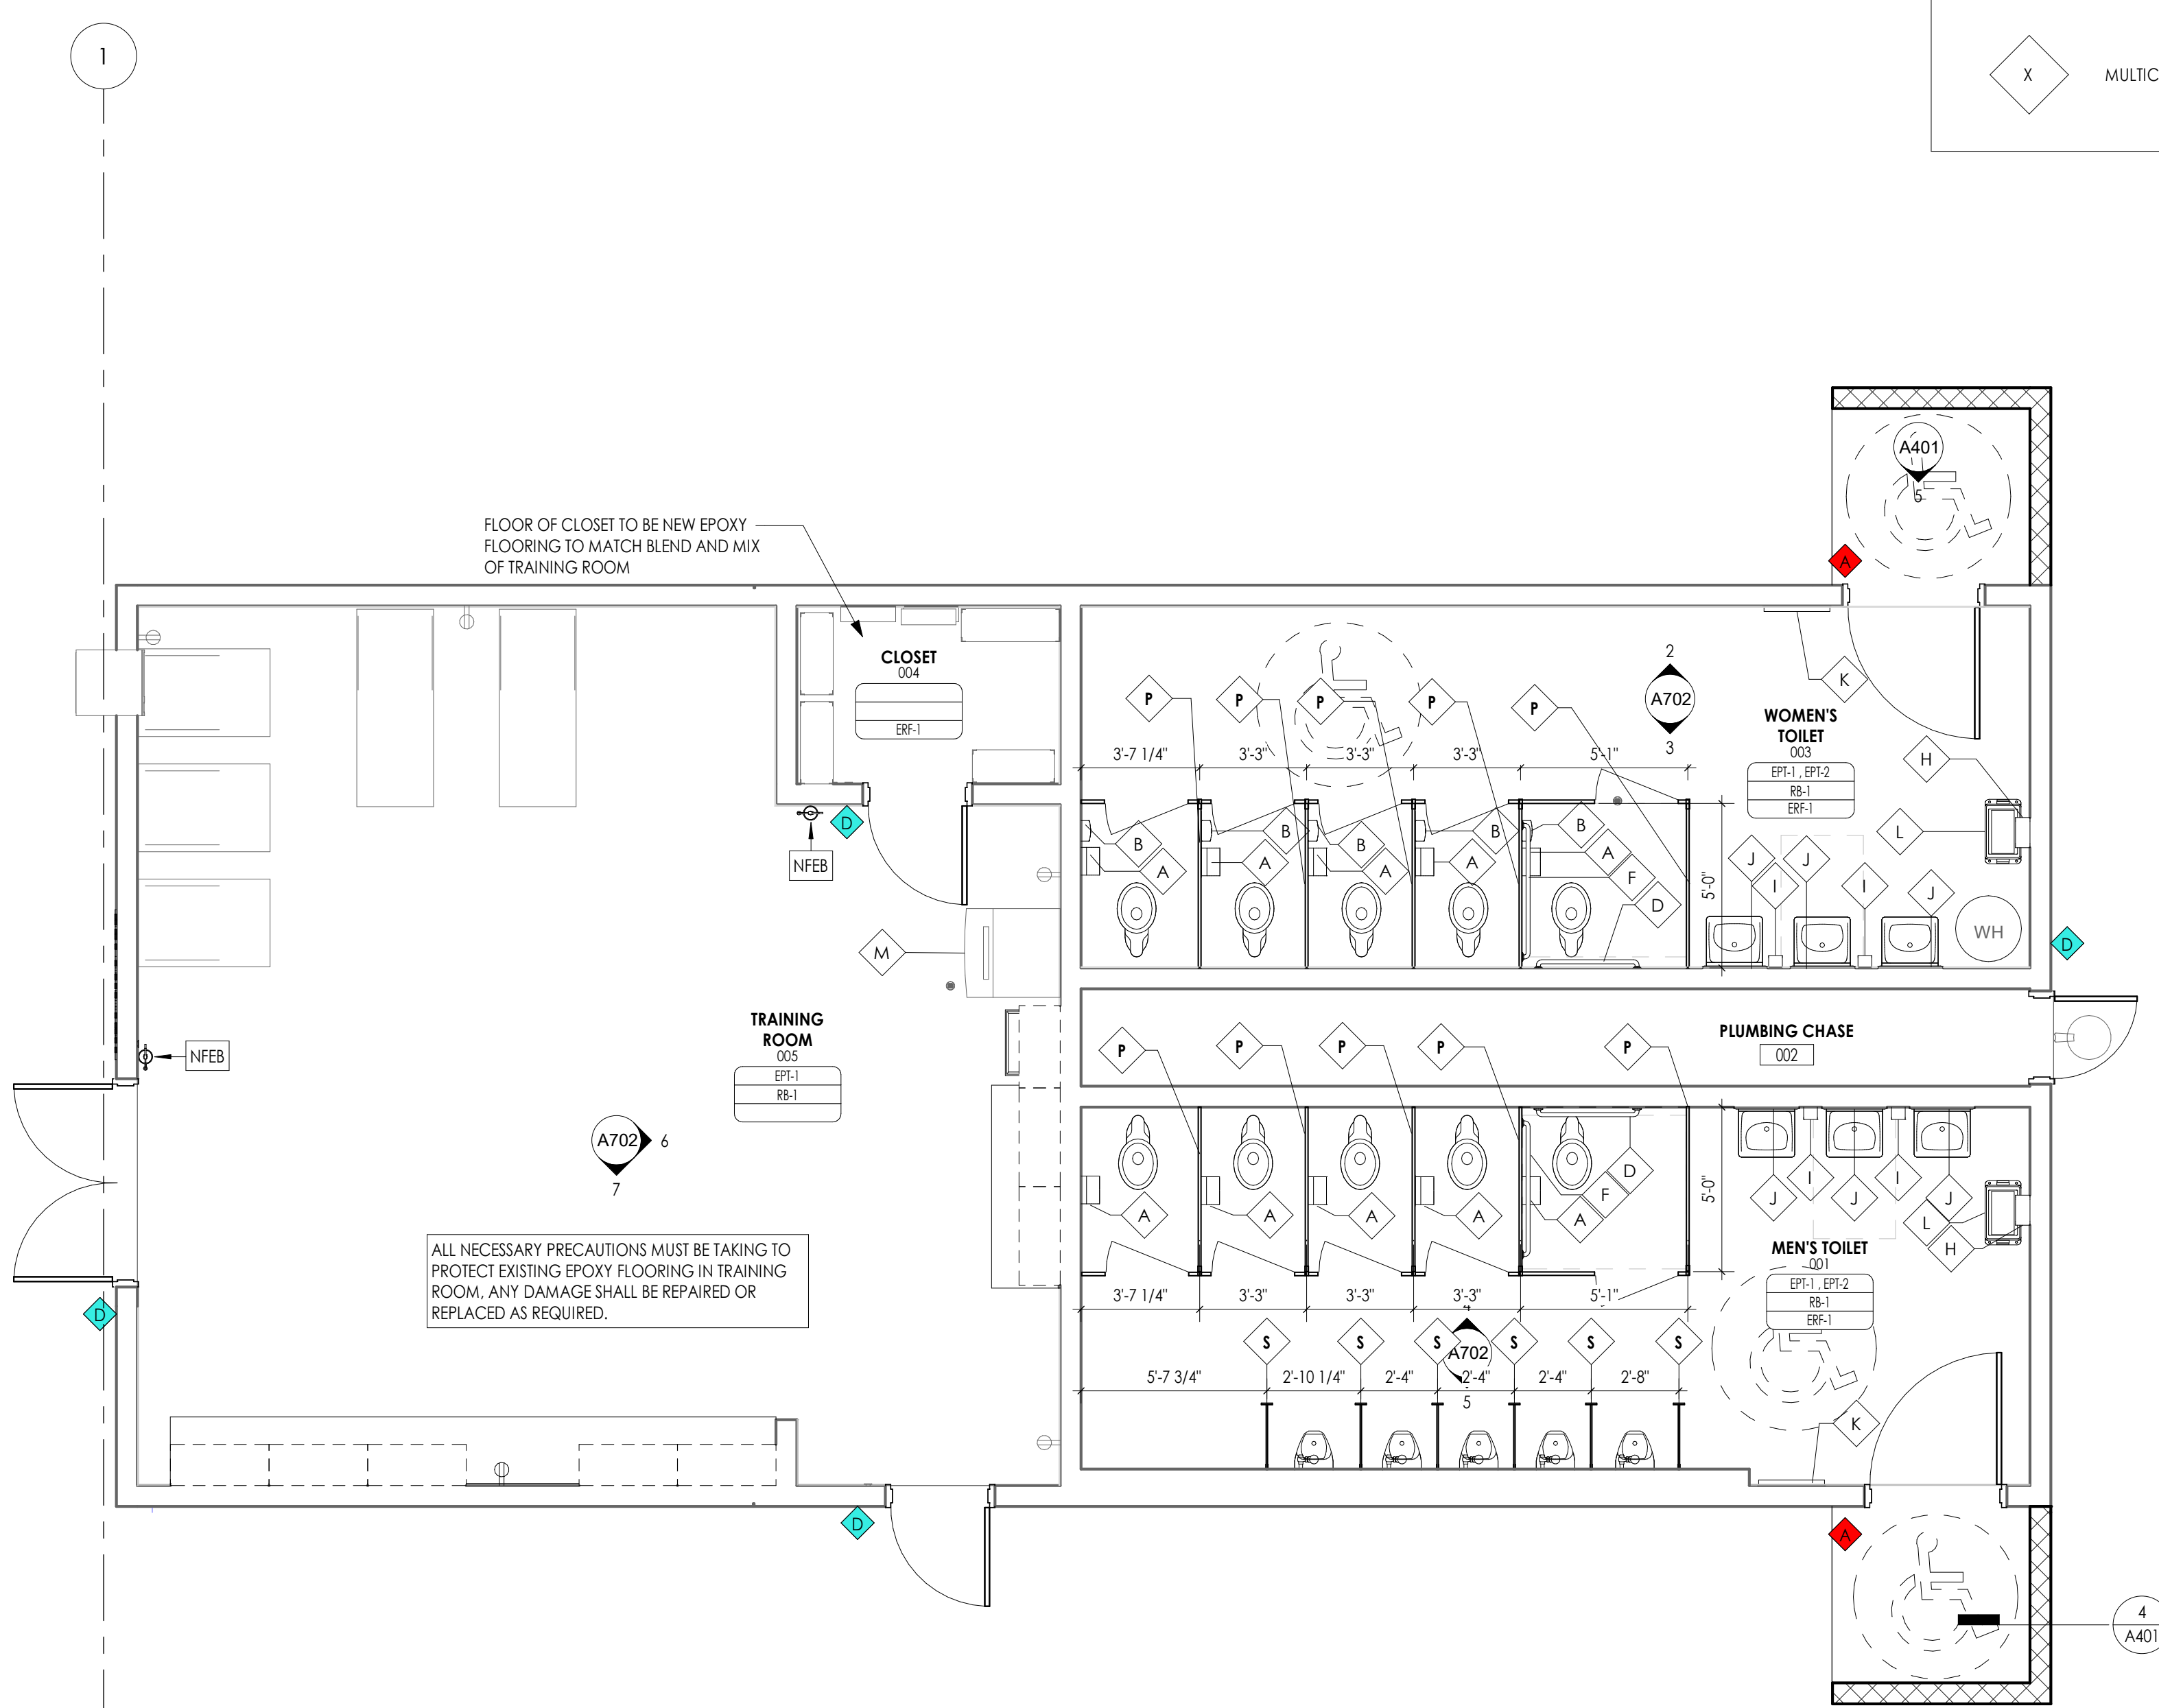

1 RESTROOM BUILDING ACCESSORY, EQUIPMENT, AND FINISH PLAN
1/4" = 1'-0"

9/22/2023 9:59:42 AM S:\Projects\Wilson\CS\Wurt\HS Athletic Renovation\Design\CAD\Revit\Civil.dwg

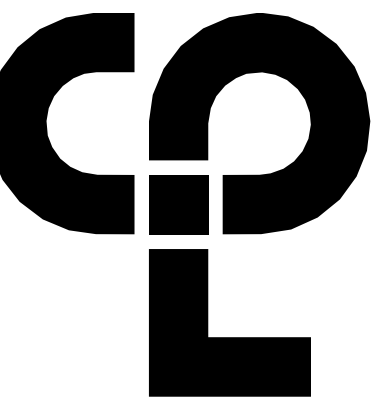

FINISH PLAN GENERAL NOTES

1. ALL NEW AND EXISTING HOLLOW METAL DOORS, DOOR FRAMES AND WINDOW FRAMES IN PROJECT SCOPE SHALL BE PAINTED EPT-2, UNLESS NOTED OTHERWISE (U.N.O.).
2. ALL COVERS, VENTS, GRILLES AND OTHER MISCELLANEOUS MECHANICAL AND ELECTRICAL DEVICES ARE TO BE PAINTED TO MATCH THE SURFACE ON WHICH THEY APPEAR, UNLESS NOTED OTHERWISE (U.N.O.).
3. REFER TO A100 SERIES DRAWINGS FOR CEILING TYPES.
4. ALL SOFFITS, FASCIA AND TRIM TO BE REPAIRED AND REPLACED AS NEEDED. FASCIA AND TRIM TO BE PREPPED AND PAINTED EPT-4, SOFFIT TO BE PREPPED AND PAINTED EPT-1.
5. UNDERSIDE OF SOFFITS TO MATCH FACE OF SOFFIT. SEE A100 SERIES FOR PAINT ACCENT SPECIFICATIONS. PAINT CEILING EPT-1.
6. REFER TO A700 SERIES INTERIOR ELEVATIONS FOR MILLWORK FINISHES.
7. HIGH PRESSURE PLASTIC LAMINATE ON VERTICAL SURFACES TO RUN VERTICALLY, UNLESS NOTED OTHERWISE (U.N.O.).
8. ALL GROUT TO BE SEALED A MINIMUM OF TWO TIMES PRIOR TO COMPLETION.
9. WHERE KICKSPACES OCCUR AT MILLWORK, FLOOR FINISH SHOWN ON PLANS SHALL RUN UNDERNEATH KICKSPACE AS WELL.


FINISH ABBREVIATIONS

NOTE: THIS LEGEND MAY CONTAIN ABBREVIATIONS THAT ARE NOT IN THIS PROJECT

DS	DIVIDER STRIP	PTM	PATCH TO MATCH
EPT	EPOXY PAINT	RB	RESILIENT BASE
ERF	EPOXY RESIN FLOOR	SCON	SEALED CONCRETE
ETR	EXISTING TO REMAIN	SSM	SOLID SURFACE MATERIAL
EXP	EXPOSED	SV	SHEET VINYL
FILM	FILM	SWP	SHEET WALL PROTECTION
FRP	FIBER REINFORCED PANEL	TER	TERRAZZO
GRT	GROUT	TR	TRIM
HDPE	HIGH DENSITY POLY ETHYLENE	TS	TRANSITION STRIP
INT	INTEGRAL	WC	WALL COVERING
LVT	LUXURY VINYL TILE	WD	WOOD
PT	PAINT	WG	WALL GUARD

FINISH PLAN SYMBOLS LEGEND

NOTE: THIS LEGEND MAY CONTAIN SYMBOLS THAT ARE NOT IN THIS PROJECT

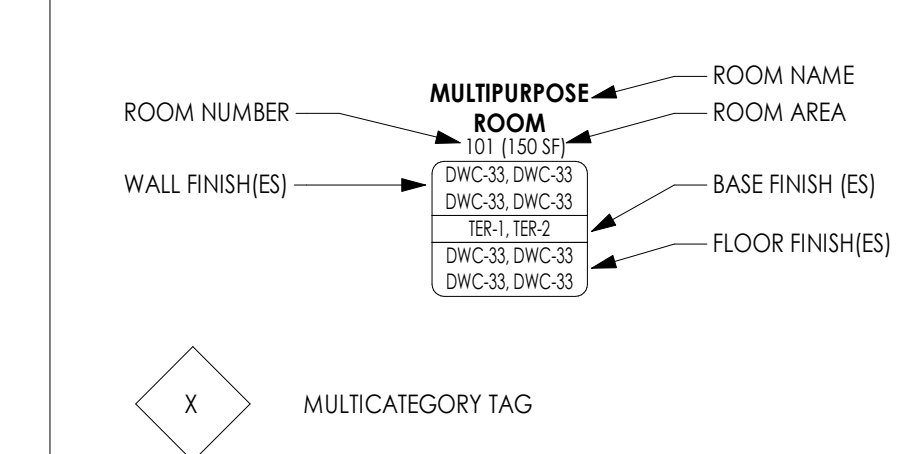

PROJECT INFORMATION

Project Number
R22.16900.00

Client Name

WILSON COUNTY SCHOOLS

Project Name

HUNT HS - ATHLETICS


RENOVATION

HUNT HIGH SCHOOL


Project Address
4559 Lamm Rd, Wilson, NC 27893

PROJECT ISSUE & REVISION SCHEDULE


No. Date Description

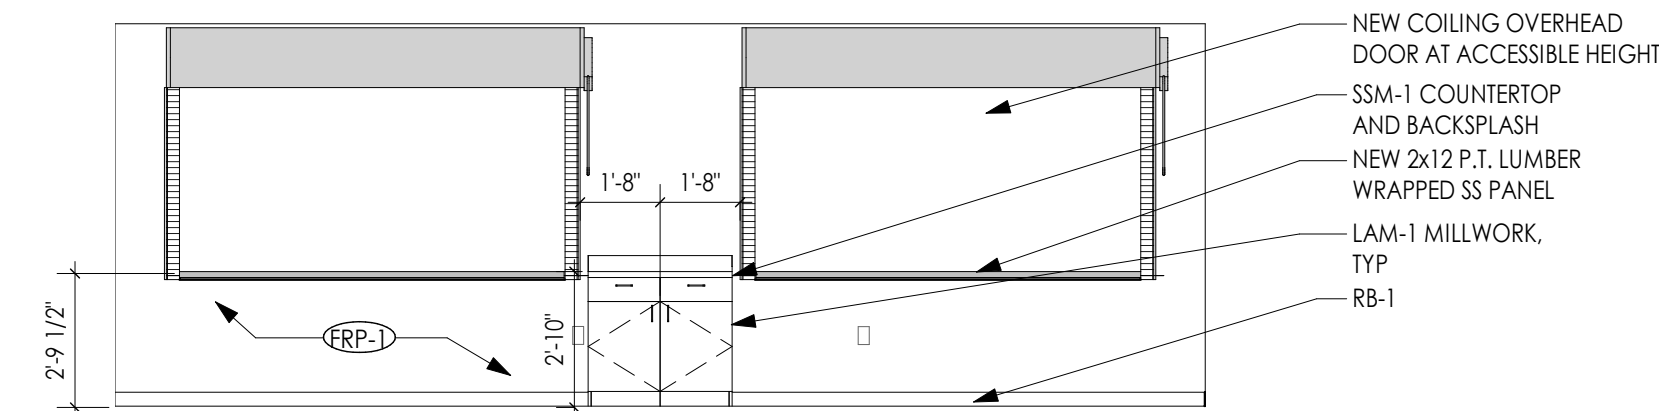


5 CONCESSIONS ROOM WEST ELEVATION
A703 1/4" = 1'-0"

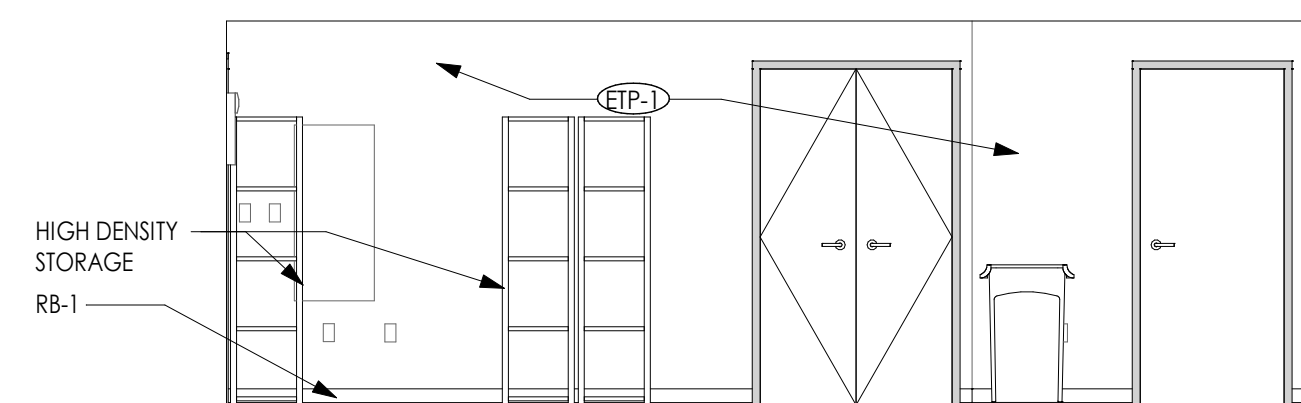


7 STORAGE ROOM WEST ELEVATION
A703 1/4" = 1'-0"

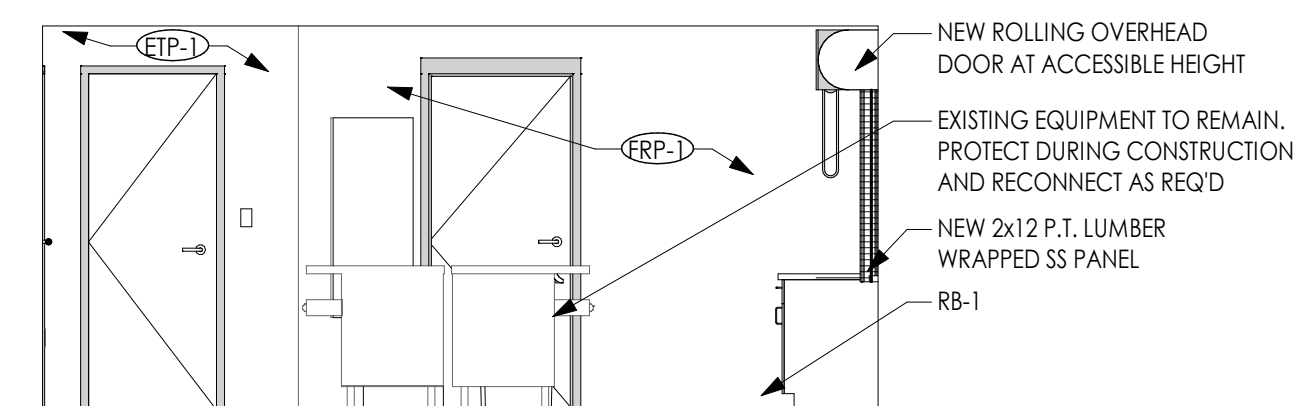


4 CONCESSIONS ROOM SOUTH ELEVATION
A703 1/4" = 1'-0"

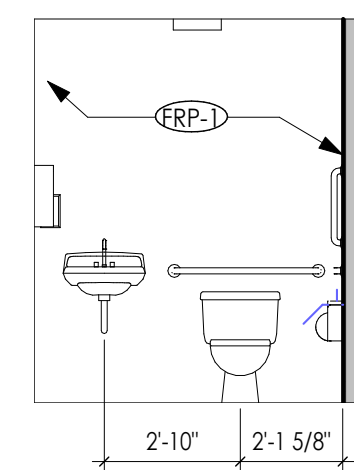


6 TOILET WEST ELEVATION
A703 1/4" = 1'-0"

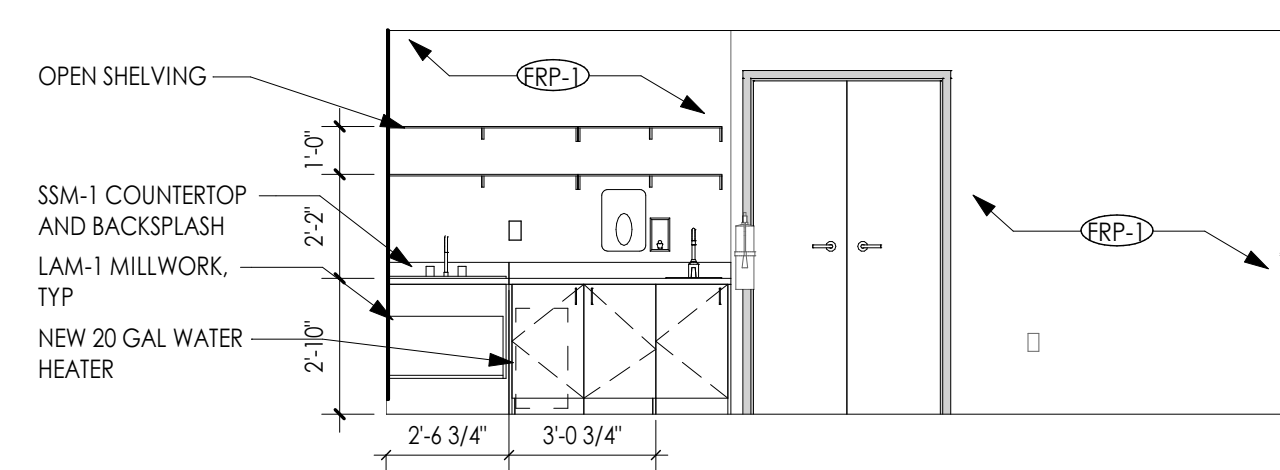


3 CONCESSIONS ROOM EAST ELEVATION
A703 1/4" = 1'-0"

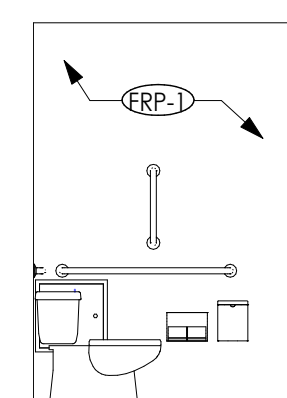


8 TOILET NORTH ELEVATION
A703 1/4" = 1'-0"

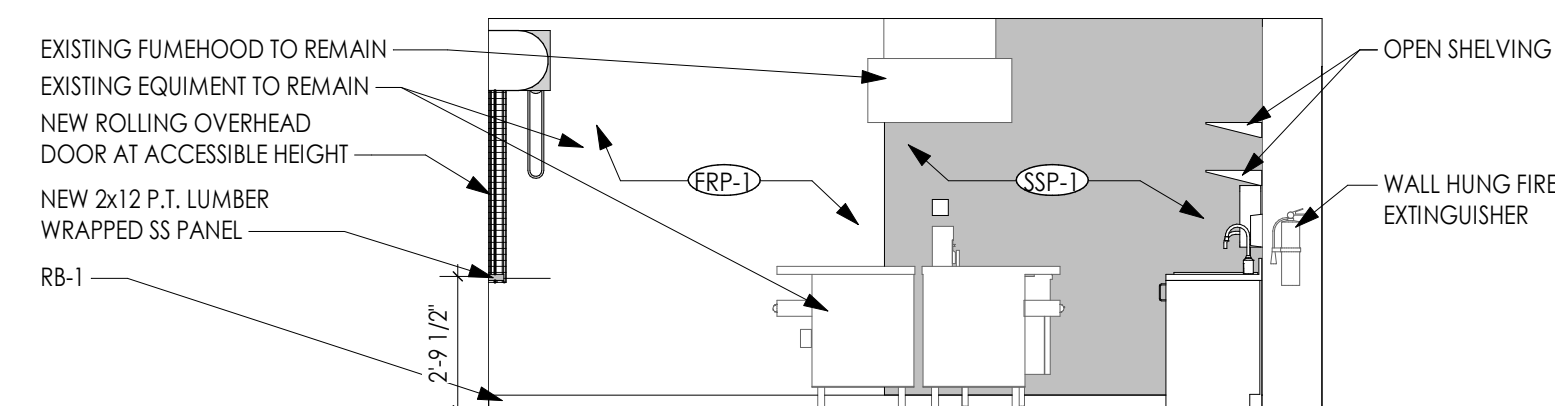

2 CONCESSIONS ROOM NORTH ELEVATION
A703 1/4" = 1'-0"

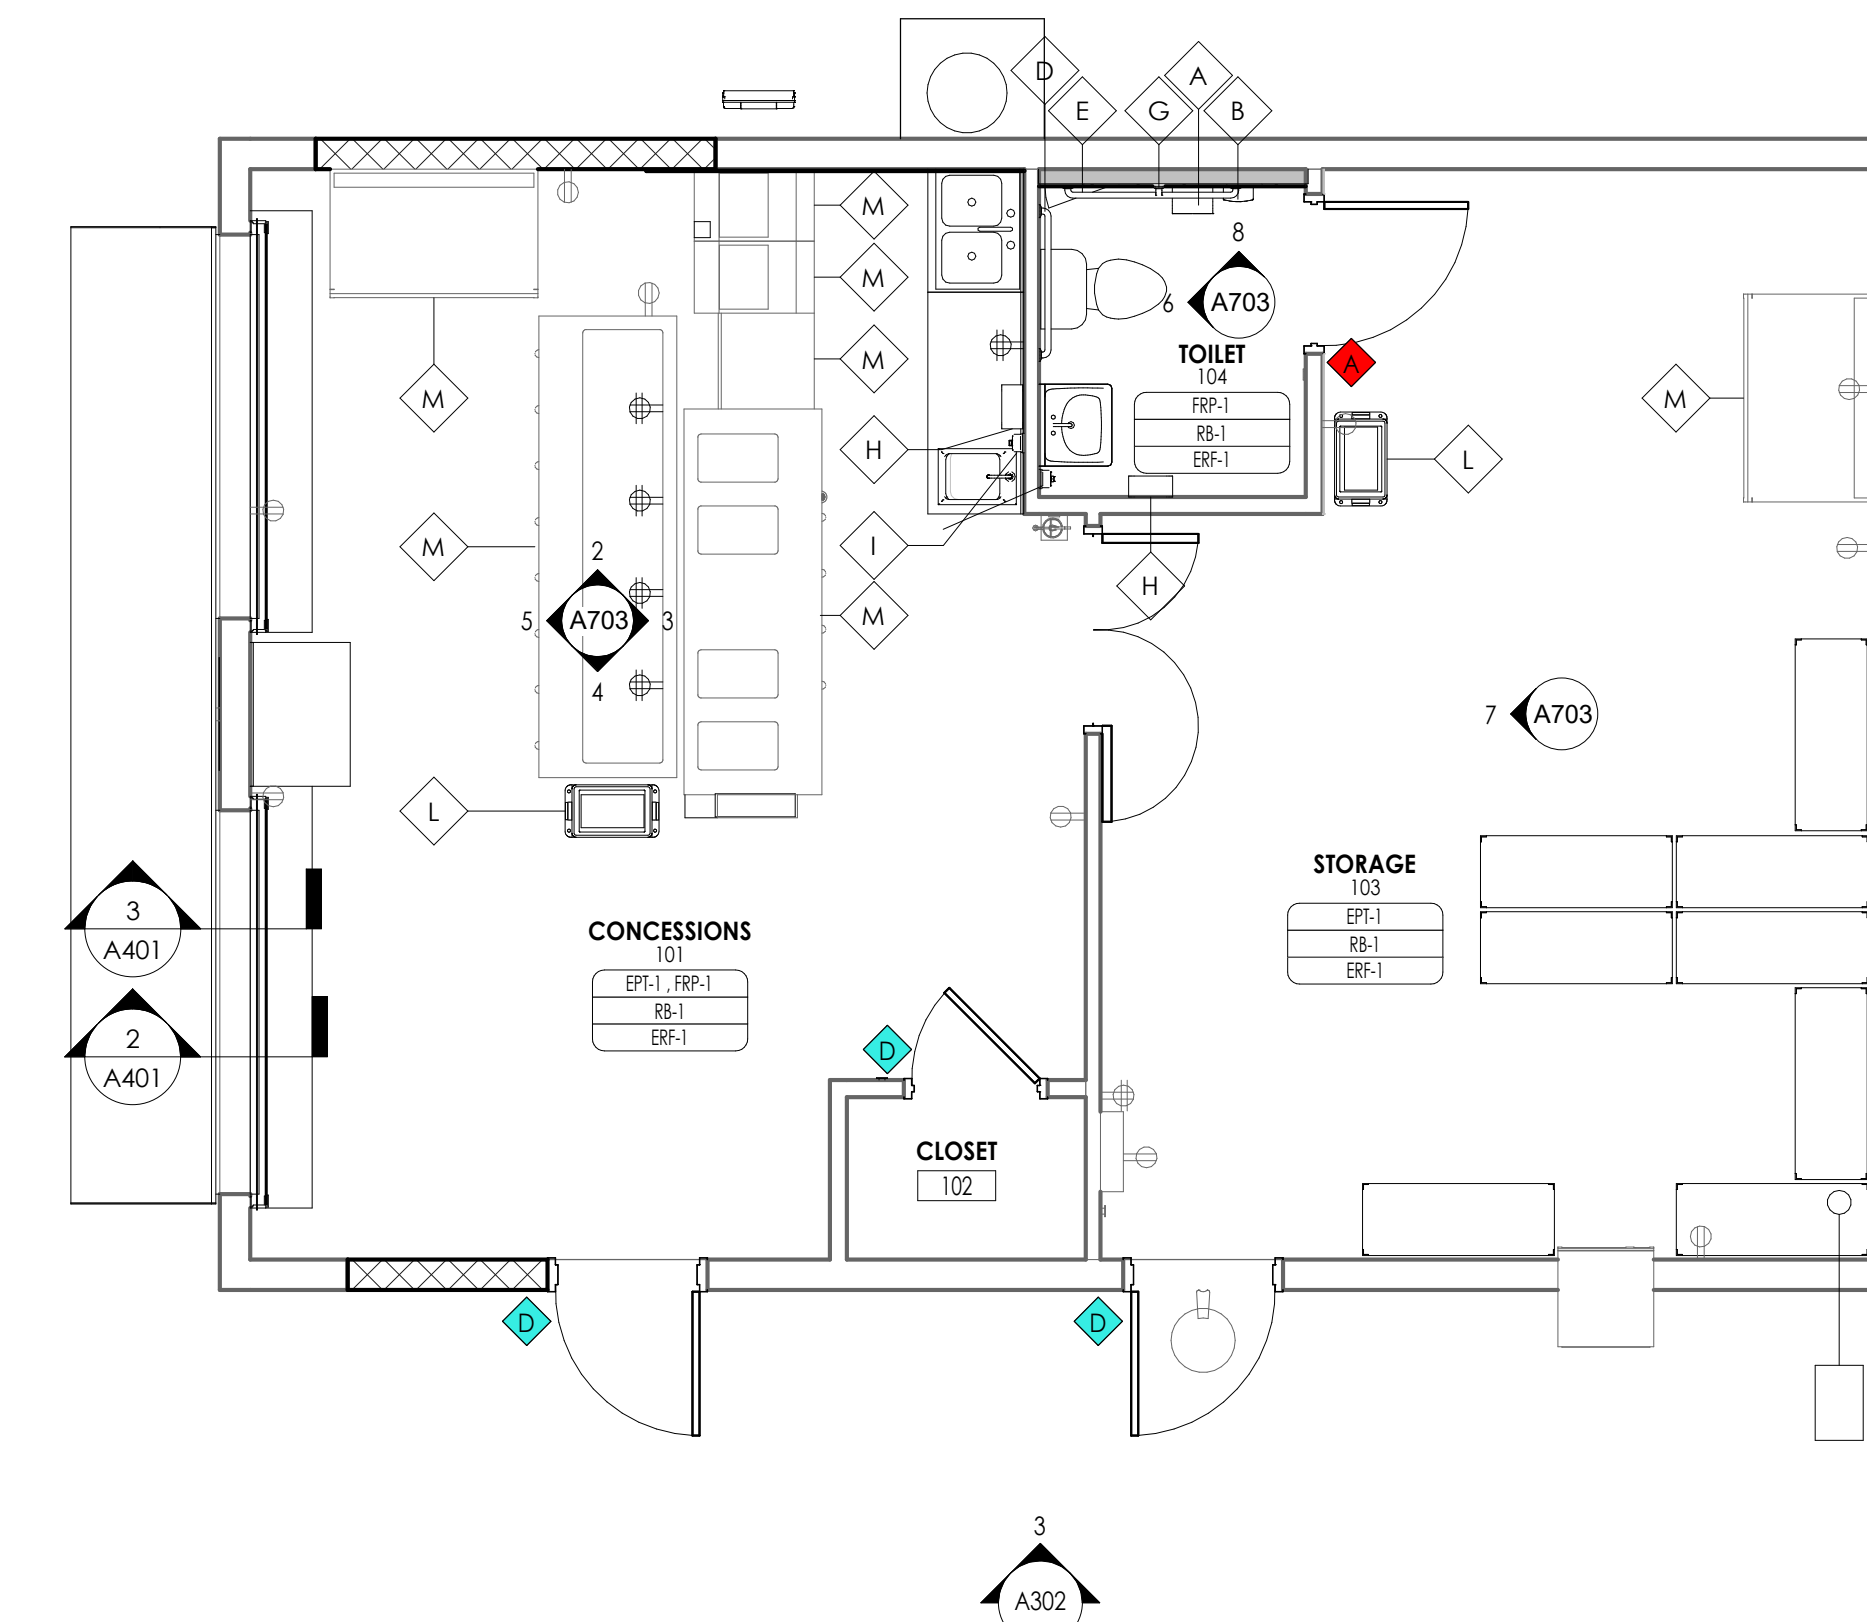

1 CONCESSIONS BUILDING ACCESSORY, EQUIPMENT, AND FINISH PLAN
A703 1/4" = 1'-0"

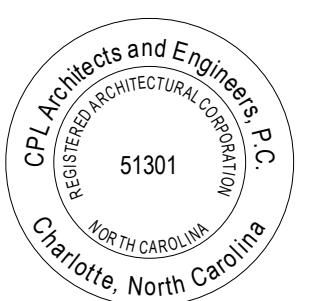

SHEET INFORMATION


Issued 09.15.2023 Scale As Indicated

Project Status 100% CONSTRUCTION DOCUMENTS

Drawn By EG Checked By GB

Drawing Title CONCESSIONS BUILDING ACCESSORY FLOOR PLAN AND INTERIOR ELEVATIONS

Drawing Number

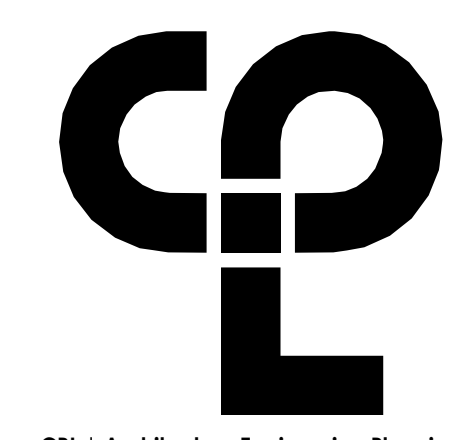

CPL | Architecture Engineering Planning
 1620 Hillsborough Street Suite A,
 Raleigh, NC 27605
 CPLteam.com

PROJECT INFORMATION
 Project Number
 R22.16900.00
 Client Name
WILSON COUNTY SCHOOLS
 Project Name
HUNT HS - ATHLETICS RENOVATION
 HUNT HIGH SCHOOL

Project Address
 4559 Lamm Rd, Wilson, NC 27893


PROJECT ISSUE & REVISION SCHEDULE

PROFESSIONAL STAMPS



SHEET INFORMATION
 Issued 09.15.2023 Scale As indicated
 Project Status CONSTRUCTION DOCUMENTS
 Drawn By JW6 Checked By RLA
 Drawing Title PLUMBING LEGEND, NOTES, & GENERAL NOTES
 Drawing Number

PLUMBING / PIPING LEGEND

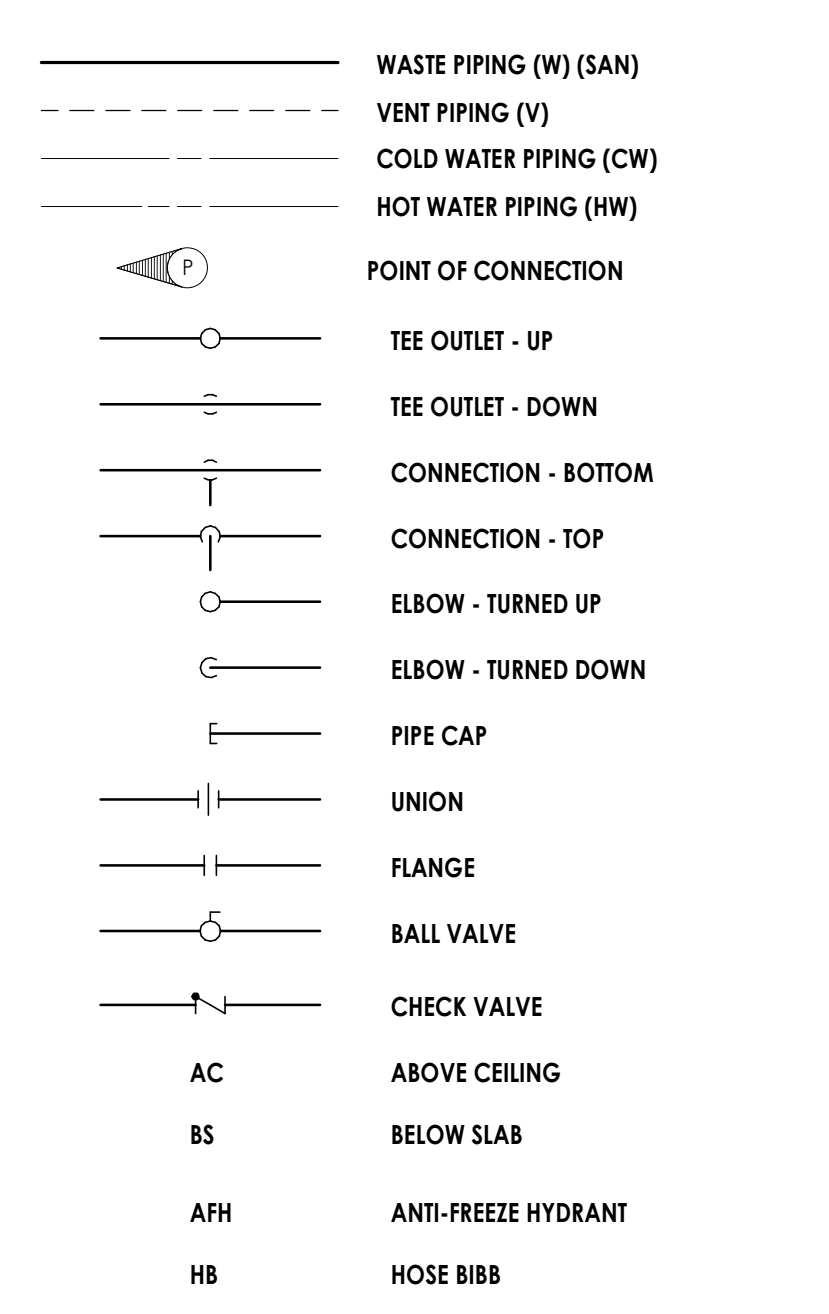

PLUMBING GENERAL NOTES

- PROVIDE ALL LABOR, MATERIAL, AND EQUIPMENT REQUIRED FOR THE COMPLETION AND OPERATION OF ALL SYSTEMS IN THIS SECTION OF WORK IN ACCORDANCE WITH THE APPROVED EDITIONS OF THE ALL APPLICABLE NORTH CAROLINA CODES, THE LOCAL AUTHORITY HAVING JURISDICTION AND APPLICABLE NFPA CODES.
- THE PLUMBING CONTRACTOR (THE CONTRACTOR) SHALL PROVIDE ALL SPECIFIED AND MISCELLANEOUS MATERIAL AND LABOR AS REQUIRED FOR A COMPLETE AND OPERATING SYSTEM AS DESCRIBED BY THE PLANS AND SPECIFICATIONS.
- ALL EQUIPMENT AND MATERIALS SHALL BE INSTALLED IN ACCORDANCE WITH ALL LOCAL, STATE, AND NATIONAL CODES AND RECOMMENDATIONS OF THE MANUFACTURERS. IF THERE IS A CONFLICT IN THE DISAGREEMENT WITH ABOVE REQUIREMENTS, THE CONTRACTOR SHALL OBTAIN CLARIFICATION FROM THE ENGINEER PRIOR TO START OF CONSTRUCTION.
- THE CONTRACTOR SHALL OBTAIN AND PAY FOR ALL PERMITS, FEES, AND INSPECTIONS NECESSARY TO COMPLETE THE WORK UNDER THIS CONTRACT.
- PRIOR TO BIDDING, THE CONTRACTOR SHALL VISIT THE SITE TO FAMILIARIZE HIMSELF WITH EXISTING CONDITIONS, RESOLVE ANY CONFLICTS BETWEEN EXISTING CONDITIONS AND THESE PLANS WITH THE ENGINEER, AND SATISFY HIMSELF REGARDING SUBSOIL CONDITIONS FOR REQUIRED EXCAVATIONS.
- ALL EQUIPMENT AND MATERIALS SHOWN ON THESE DRAWINGS IS STRICTLY DIAGRAMMATIC. LOCATIONS OF EQUIPMENT, FIXTURES, PIPES, DUCTS, ELECTRICAL RACEWAYS, ETC. SHALL BE ADJUSTED TO ACCOMMODATE INTERFERENCES ANTICIPATED AND ENCOUNTERED. LINES WHOSE ELEVATION CANNOT BE CHANGED SHALL HAVE THE RIGHT-OF-WAY. THOSE REQUIRED TO SLOPE SHALL HAVE THE RIGHT-OF-WAY OVER THOSE THAT DO NOT, AND LARGER LINES SHALL HAVE THE RIGHT-OF-WAY OVER SMALLER. IT SHALL BE THE RESPONSIBILITY OF THE CONTRACTOR TO ENSURE THAT ITEMS FURNISHED UNDER THIS CONTRACT WILL FIT IN THE SPACE AVAILABLE.
- THE CONTRACTOR SHALL MAKE NECESSARY FIELD MEASUREMENTS TO ASCERTAIN SPACE REQUIREMENTS INCLUDING THOSE FOR CONNECTIONS, AND SHALL PROVIDE SUCH SIZES AND SHAPES OF EQUIPMENT THAT ARE THE TRUE INTENT OF THESE DRAWINGS AND SPECIFICATIONS. ANY CONFLICTS SHALL BE RESOLVED WITH THE ENGINEER.
- THE CONTRACTOR SHALL PROVIDE FIRE AND SMOKE FOR ALL PENETRATIONS OF THE WORK PROVIDED UNDER THIS CONTRACT WHERE SUCH PIPING PASSED THROUGH RATED WALLS OR SMOKE PARTITIONS. FIRE STOPPING AND SMOKE SEALING SHALL BE WITH UL APPROVED MATERIALS TO MATCH THE RATINGS AND CONSTRUCTION OF THE WALL OR FLOOR, AND INSTALLED PER THE MANUFACTURER'S INSTRUCTIONS.
- DO NOT SCALE THESE DRAWINGS. REFER TO THE ARCHITECTURAL PLANS FOR DIMENSIONS.
- ALL EQUIPMENT SHALL BE LOCATED AND INSTALLED TO PROVIDE MAXIMUM SPACE FOR MAINTENANCE AND SERVICE.
- ALL MATERIALS USED SHALL BE NEW AND FREE OF DEFECTS, WHERE TRADES NAMES ARE MENTIONED, THEY ARE GIVEN AS A REFERENCE TO THE QUALITY OF THE APPARATUS REQUIRED, ALL MATERIALS AND EQUIPMENT SHALL BEAR THE UL LABEL OR EQUIVALENT WHERE APPLICABLE. OTHER MARKS MAY BE USED IF APPROVED IN WRITING BY THE ENGINEER. THE CONTRACTOR SHALL SUBMIT A COMPLETE LIST OF MATERIALS AND EQUIPMENT PROPOSED FOR USE IN THIS CONTRACT TO THE ENGINEER WITH TEN DAYS FOLLOWING THE AWARD OF CONTRACT. IF SUCH LIST IS NOT SUBMITTED, THE CONTRACTOR SHALL SUPPLY THE MATERIALS AND EQUIPMENT SPECIFIED OR AS DIRECTED BY THE ENGINEER.
- WORKMANSHIP SHALL BE FIRST-CLASS AND PERFORMED BY EXPERIENCED AND SKILLED CRAFTSMEN.
- PIPING SHALL BE CONCEALED IN FURNISHED AREAS, EITHER IN PIPE SPACE PROVIDED OR IN WALLS. PIPING TO FIT SNUGLY TO WALLS OR CEILINGS. OPEN ENDS OF PIPING SHALL BE CLOSED AND PROTECTED UNTIL FINAL CONNECTIONS ARE MADE. SUCH CLOSINGS SHALL BE MADE WITH FITTINGS WHICH CANNOT BE EASILY REMOVED. CAPS OR PLUGS SHALL BE REQUIRED AT ALL TIMES DURING CONSTRUCTION SO THE NO PIPES ARE LEFT OPEN AT THE END OF ANY DAY'S WORK, EVEN THOUGH CONTINUATION IS EXPECTED THE NEXT DAY.
- ALL FIXTURES SHALL BE ACCURATELY ROUGHED-IN ACCORDING TO THE MANUFACTURER'S INSTALLATION DIMENSIONS SO THAT NO OFFSET ADAPTERS, FLEXIBLE CONNECTORS OR OTHER IMPROVISATIONS ARE NECESSARY. ALL INCORRECT WORK SHALL BE TORN OUT AND CORRECTED, AND WALLS AND FLOORS PATCHED.
- ALL PLUMBING WORK SHALL BE COORDINATED WITH THE BUILDING CONTRACT SO ALL WITH FINISH TOGETHER. THE ENTIRE SYSTEM SHALL BE ACCEPTED AS A UNIT. THERE WILL BE NO PARTIAL ACCEPTANCE.
- THE CONTRACTOR SHALL VERIFY ALL ELECTRIC CONNECTION LOCATIONS AND SIZES WITH THE ELECTRICAL CONTRACTOR PRIOR TO ORDERING EQUIPMENT. ANY DISCREPANCIES SHALL BE CLARIFIED BY THE ENGINEER.
- THE CONTRACTOR SHALL, AT THE COMPLETION OF THE WORK, CLEAN POLISH, AND/OR WASH ALL EXPOSED ITEMS OF MATERIALS, EQUIPMENT, AND FIXTURES IN HIS CONTRACT TO LEAVE SUCH ITEMS BRIGHT AND CLEAN. THE CONTRACTOR SHALL KEEP THE PREMISES CLEAR OF DEBRIS FROM HIS WORK DURING CONSTRUCTION AND LEAVE THE AREA AND BUILDING CLEAN AT COMPLETION OF THE CONTRACT.
- THE CONTRACTOR SHALL INVESTIGATE ALL DRAINAGE PIPING ABOVE GROUND BY VISUAL INVESTIGATION FOR (IE. DAMAGE, IMPROPER SUPPORT, LEAKAGE, & MISSING INSULATION), INCLUDING PROVIDING A VIDEO INSPECTION OF ALL UNDERGROUND PIPING TO CONFIRM ANY EXISTING PIPING TO BE RE-USED IS IN RE-USABLE CONDITION. PROVIDE AN ASSESSMENT OF EXISTING CONDITIONS REPORT PRIOR TO BEGINNING WORK.
- THE CONTRACTOR SHALL PROVIDE A COMPLETE 1-YEAR WARRANTY ON ALL LABOR AND MATERIALS UNDER THIS CONTRACT.

PLUMBING FIXTURE SCHEDULE

MARK	FIXTURE TYPE	MANUFACTURER	CATALOG NO.	CONNECTION SIZES			BRASS	TRAP AND SUPPLIES	ACCESSORIES	MOUNTING	REMARKS
				WASTE	C.W.	H.W.					
W1	FLOOR MOUNTED FLUSH VALVE WATER CLOSET, ELONGATED VITREOUS CHINA BOWL, 1.28 GPF MODERNA - 15" RIM HEIGHT	AMERICAN STANDARD	3451.001	3"	1"	--	SLOAN MODEL 111 - 1.28 GPF	AMERICAN STANDARD 5905.110 ELONGATED WHITE EXTRA HEAVY DUTY OPEN FRONT SEAT WITH EVERCLEAN	FLOOR MOUNTED STANDARD HEIGHT FIXTURE	GENERAL USE	
W1A	FLOOR MOUNTED FLUSH VALVE WATER CLOSET, ELONGATED VITREOUS CHINA BOWL, 1.28 GPF MODERNA - 16-1/2" RIM HEIGHT	AMERICAN STANDARD	3461.001	3"	1"	--	SLOAN MODEL 111 - 1.28 GPF	AMERICAN STANDARD 5905.110 ELONGATED WHITE EXTRA HEAVY DUTY OPEN FRONT SEAT WITH EVERCLEAN	FLOOR MOUNTED A.D.A. HEIGHT FIXTURE	FOR HANDICAP AND GENERAL USE	
W2	FLOOR MOUNTED TANK TYPE WATER CLOSET, ELONGATED VITREOUS CHINA BOWL, 1.28 GPF CADET - 16-1/2" RIM HEIGHT	AMERICAN STANDARD	215AA.104	3"	1/2"	--	ZURN Z8800-XL-LR 1/2" SUPPLY STOPS WITH BRAIDED STAINLESS STEEL FLEXIBLE HOSE	AMERICAN STANDARD 5905.110 ELONGATED WHITE EXTRA HEAVY DUTY OPEN FRONT SEAT WITH EVERCLEAN	FLOOR MOUNTED A.D.A. HEIGHT FIXTURE	FOR HANDICAP AND GENERAL USE	
U1	URINAL - WALL HUNG (0.125 GPF)	MANSFIELD	410UHE CASCADE	2"	3/4"	--	SLOAN MODEL 186 - 0.125 GPF	PROVIDE EXPOSED 1-1/2" ZURN Z8702 CHROME BRASS BODY P-TRAP WITH WALL BEND.	WALL MOUNTED 24" FLOOR TO LIP	FOR GENERAL USE	
U1A	URINAL - WALL HUNG (0.125 GPF)	MANSFIELD	410UHE CASCADE	2"	3/4"	--	SLOAN MODEL 186 - 0.125 GPF	PROVIDE EXPOSED 1-1/2" ZURN Z8702 CHROME BRASS BODY P-TRAP WITH WALL BEND.	WALL MOUNTED 17" FLOOR TO LIP	FOR GENERAL AND HANDICAP USE	
L1	LAVATORY - WALL MOUNTED (CAST IRON)	AMERICAN STANDARD	4869.001 ONE HOLE FAUCET	1-1/2"	1/2"	1/2"	DELTA 8710S (0.5 GPM) HEAVY DUTY CAST BRASS SINGLE HOLE FAUCET, POLISHED CHROME PLATED FINISH, VANDAL-RESISTANT ADA LEVER HANDLE, DELTA METERING SLOW CLOSE CARTRIDGE, VANDAL RESISTANT NON-AERATING SPRAY.	ZURN Z8743-PC GRID STRAINER ZURN Z8700 P-TRAP ZURN Z8800 STOP WITH FLEXIBLE SUPPLIES	WALL MOUNTED A.D.A. HEIGHT FIXTURE	FOR GENERAL USE	
L1A	SAME AS (L1) EXCEPT ADA MOUNTING	AMERICAN STANDARD	4869.001 ONE HOLE FAUCET	1-1/2"	1/2"	1/2"	SAME AS (L1)	SAME AS (L1)	WALL MOUNTED A.D.A. HEIGHT FIXTURE	FOR GENERAL AND HANDICAP USE	
S1	LAUNDRY SINK	FIAT PRODUCTS	IAT1 LAUNDRY TUB	1-1/2"	1/2"	1/2"	WITH TWO HANDLE 4" DECK MOUNTED FAUCET WITH 4" WRIST BLADE HANDLES	INCLUDES INTEGRAL DRAIN WITH PLUG, P-TRAP AND SUPPLY LINE, PROVIDE 1-1/2" DRAIN TO WALL	FLOOR MOUNTED A.D.A. HEIGHT FIXTURE	FOR GENERAL AND HANDICAP USE	
S2	DOUBLE BOWL SINK ADA COMPLIANT	JUST MFG.	DI-ADA-2025-A-GR ONE HOLE CENTERED 5-1/2" DEEP CENTER	1-1/2"	1/2"	1/2"	DELTA 8478I-DST SINGLE HANDLE PULL-DOWN FAUCET, CHROME PLATED, SINGLE HOLE DECK MOUNT, 1.8 GPM, DUAL SUPPLY, DIAMOND COATED CERAMIC CARTRIDGE.	JUST J-35 GRID STRAINER ZURN Z8702 1-1/2" P-TRAP ZURN Z8800-XL-LR 1/2" SUPPLY STOPS WITH BRAIDED STAINLESS STEEL FLEXIBLE HOSE	CABINET MOUNTED ADA FIXTURE HEIGHT	FOR GENERAL AND HANDICAP USE	
S3	SINGLE BOWL SINK ADA COMPLIANT	JUST MFG.	SLADA1613A6S-J ONE HOLE FAUCET	1-1/2"	1/2"	1/2"	DELTA 25C3847- SINGLE SHANK MIXING FAUCET, CERTEK 1/4 TURN ADA COMPLIANT LEVER HANDLES, GOOSE NECK SPOUT WITH 1.5 GPM AERATOR.	JUST J-35 GRID STRAINER ZURN Z8702 1-1/2" P-TRAP ZURN Z8800-XL-LR 1/2" SUPPLY STOPS WITH BRAIDED STAINLESS STEEL FLEXIBLE HOSE	CABINET MOUNTED ADA FIXTURE HEIGHT	FOR GENERAL AND HANDICAP USE	


WATER HEATER & ASSOCIATED EQUIPMENT SCHEDULE

SYMBOLS	DESCRIPTION	MANUFACTURER	MODEL	GAL CAP	KW	VOLT/PH/HZ	RECOVERY	BAS	GEN	MANUFACTURER & MODEL NUMBER	NOTES
WH-1	WATER HEATER	BRADFORD WHITE	RE34056	36	4500/4500 WATT	208/1/60	19 GPH @ 100 F RISE	NO	NO	BRADFORD WHITE RESIDENTIAL UPRIGHT ELECTRIC WATER HEATER, INSTALL WATER HEATER ON 28" X 28" X 4" PRECAST EQUIPMENT PAD.	SEE NOTE 1 & 2
WH-2	WATER HEATER	BRADFORD WHITE	RE120L6	19	4500/4500 WATT	208/1/60	19 GPH @ 100 F RISE	NO	NO	BRADFORD WHITE RESIDENTIAL LOWBOY ELECTRIC WATER HEATER, WATER HEATER TO BE INSTALLED WITHIN CABINET.	SEE NOTE 1
ET-1	EXPANSION TANK	AMTROL	ST-5	2.0	--	--	MAX ACCEPTANCE FACTOR = .45	NO	NO	THER-X-TROL THERMAL EXPANSION TANK, FULL ACCEPTANCE BLADDER ST SERIES - NON ASME 150 PSIG WORKING PRESSURE.	SEE NOTE 1
ET-2	EXPANSION TANK	AMTROL	ST-5	2.0	--	--	MAX ACCEPTANCE FACTOR = .45	NO	NO	THER-X-TROL THERMAL EXPANSION TANK, FULL ACCEPTANCE BLADDER ST SERIES - NON ASME 150 PSIG WORKING PRESSURE.	SEE NOTE 1
MX-1	LAVATORY / SINK MIXING VALVE ASSE 1070	WATTS	LFUG-B-M2	N/A	N/A	N/A	N/A	N/A	N/A	LEAD FREE MIXING VALVE, DOUBLE THROTTLING DESIGN CONTROLS HOT & COLD WATER TO THE MIXED OUTLET. LEAD FREE BRASS (ROUGH BRASS FINISH) BODY, COMPRESSION FITTINGS, COPPER THERMOSTAT, CHECK VALVES, AND INTEGRAL STRAINER WITH 40 MESH STAINLESS STEEL SCREENS, AND TAMPER RESISTANT LOCKING CAP, ASSE 1070 LISTED AND CSA CERTIFIED	SEE NOTE 1


- NOTES:**
 1.) SEE PLANS FOR REQUIRED PIPE SIZES.
 2.) PROVIDE PRECAST CONCRETE PAD 28" X 28 X 4" TALL.

PLUMBING DRAINAGE SCHEDULE


SYMBOLS	DESCRIPTION	LOCATION	MANUFACTURER & MODEL NUMBER	NOTES
HB-1	HOSE BIBB	INTERIOR OF BUILDING	MIFAB SERIES MHY-9200-NPB EXPOSED TYPE, LOW-LEAD, ANTI-CONTAMINATION POLISHED CHROME PLATED FINISH WALL FAUCET WITH 3/4" (19) MALE HOSE CONNECTION AND ANTI-SIPHON VACUUM BREAKER, OPERATING HANDLE TO BE OPERATING KEY, AND INLET CONNECTION TO BE 1/2" (13) F.P.T. VACUUM BREAKER TO BE CERTIFIED TO THE A.S.S.E. STANDARD 1011 AND LISTED BY I.A.M.P.O.	TYPICALLY INSTALLED AT 12" AFF
SA-X	SHOCK ARESSOR	INTERIOR OF BUILDING	MIFAB CL SERIES PISTON OPERATED WATER HAMMER ARRESTOR WITH HARD DRAWN SEAMLESS "C" COPPER BODY, RYTON FPS PISTON WITH DOUBLE O-RINGS (PARCO # 5778-80) AND CDA 360 BRASS MPT CONNECTIONS, CERTIFIED TO THE ASSE 1010-1196 AND ANSI A 112.26.1 STANDARDS.	INSTALL PER MFG. REQUIREMENTS

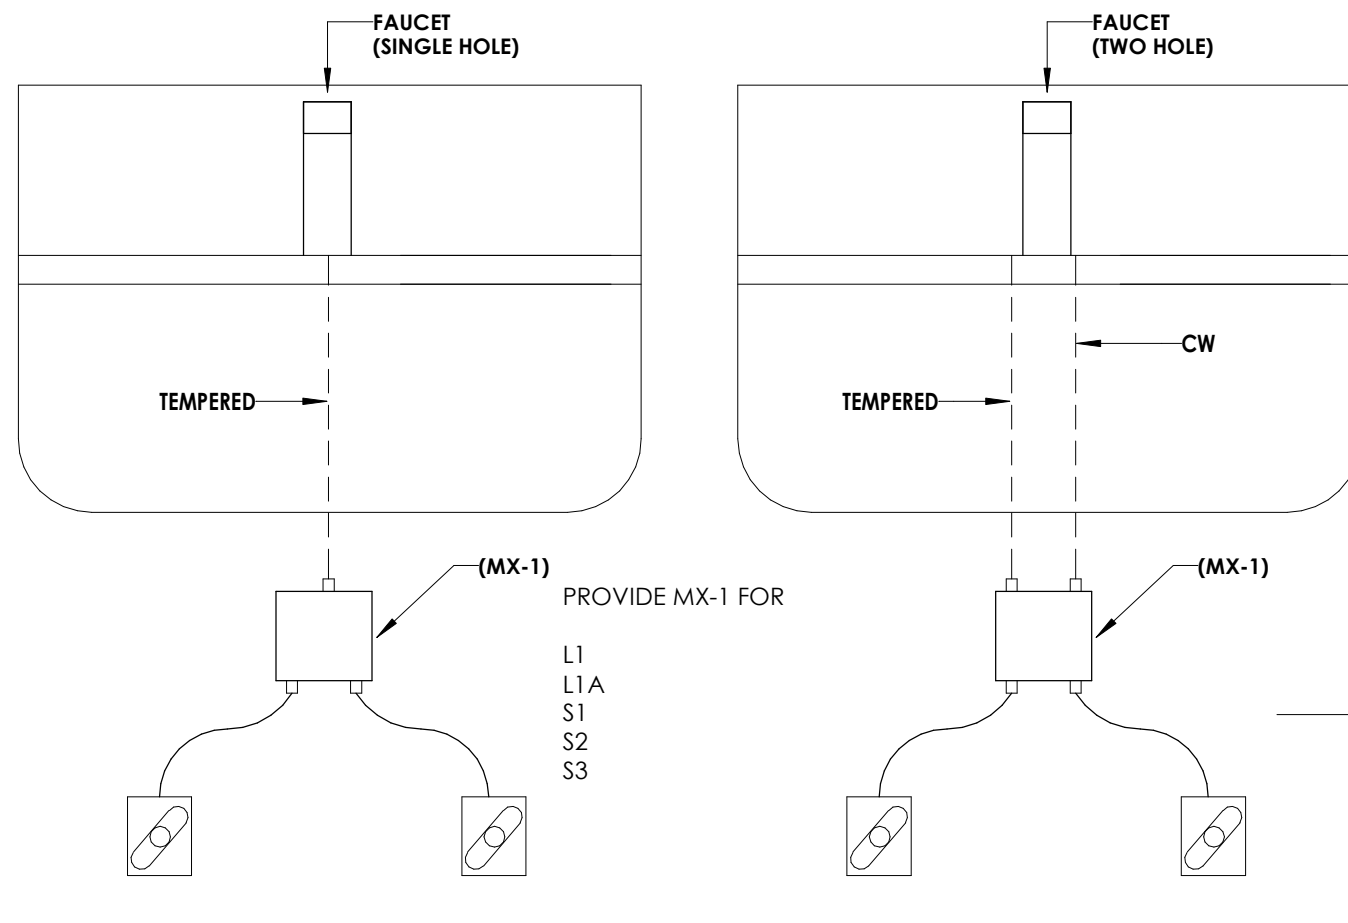


1 FAUCETS WITH MIXING VALVE
 P000 NO SCALE

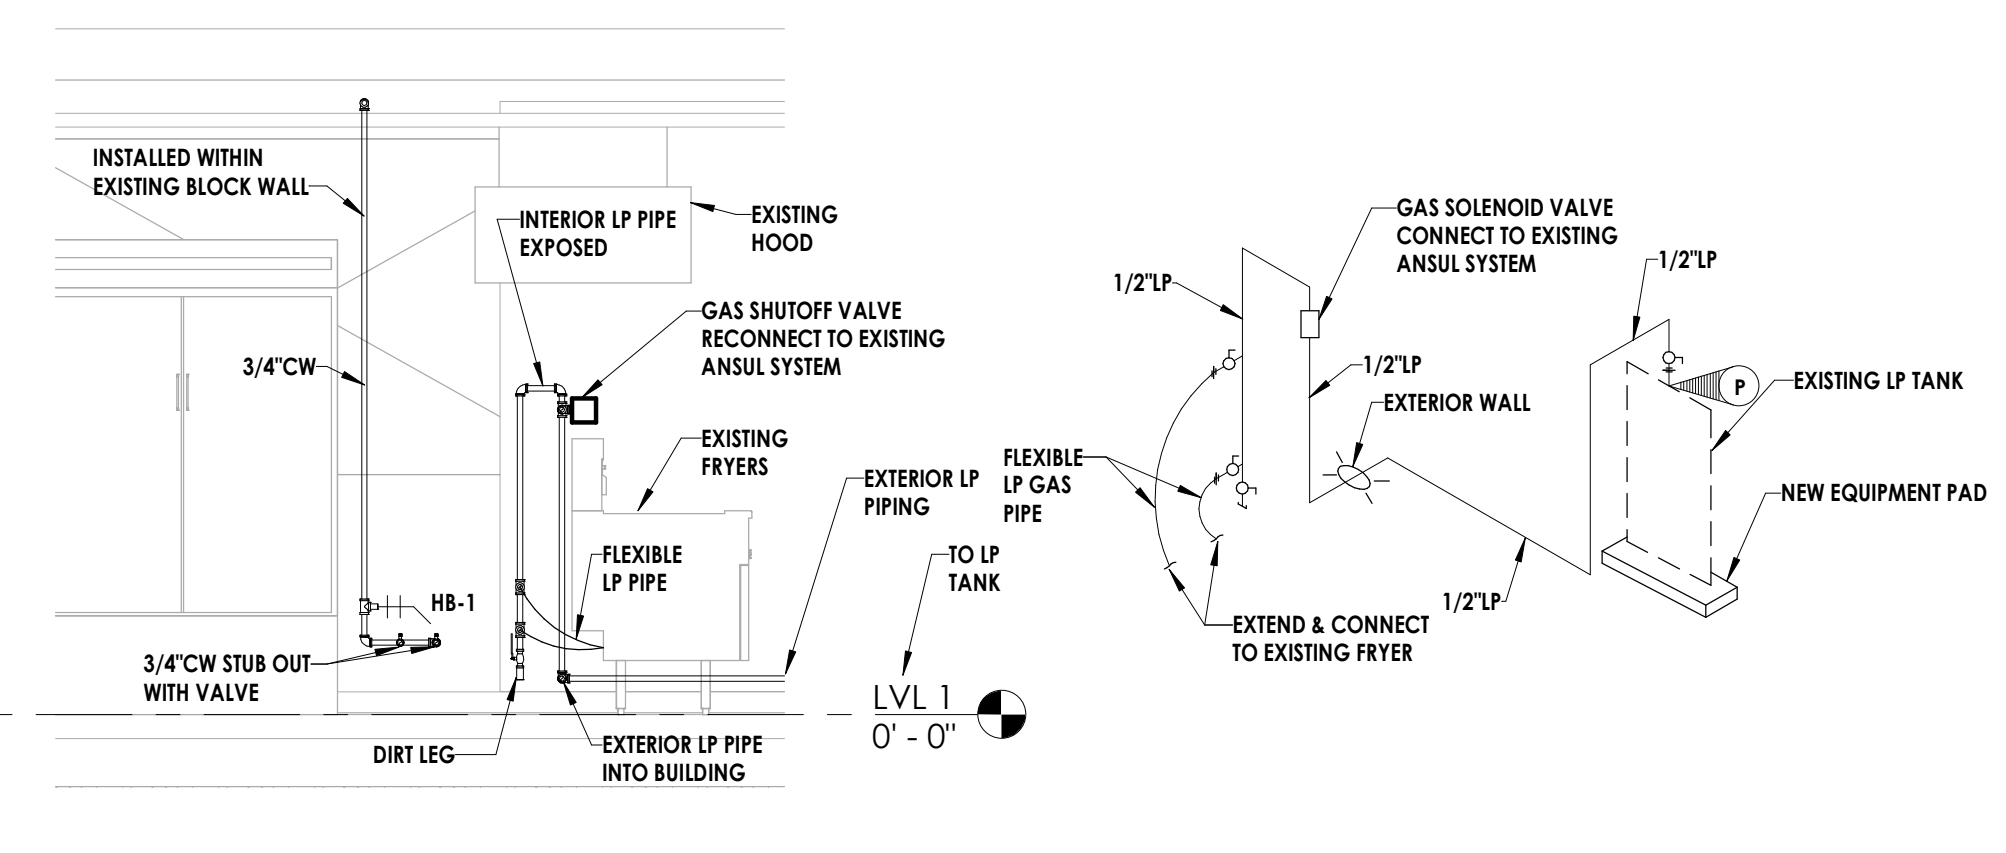


2 GAS PIPING SECTION AT FRYERS
 P000 NO SCALE

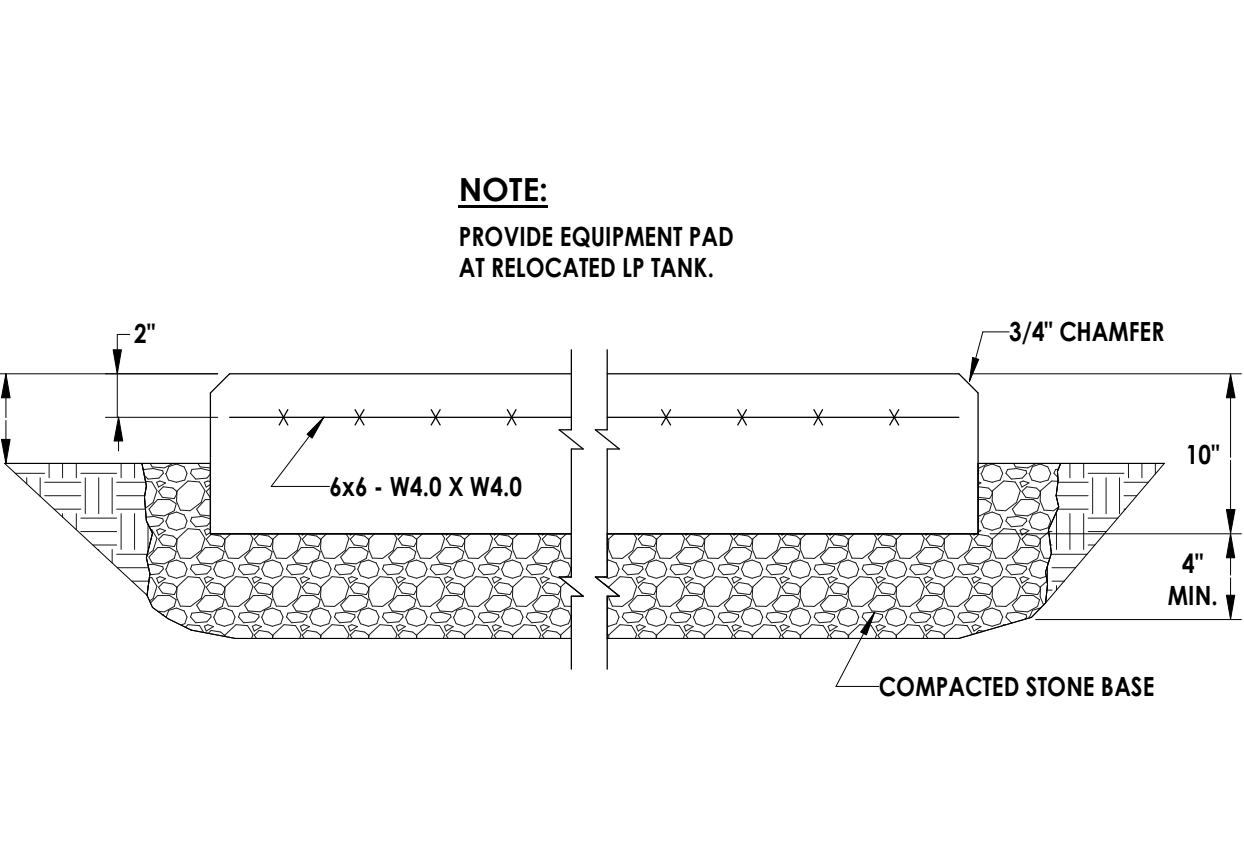

3 INDIRECT WASTE DETAIL
 P000 NO SCALE

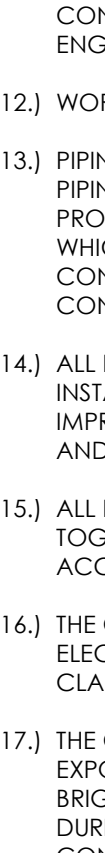

4 P-EQUIPMENT CONCRETE PAD DETAIL
 P000 12" = 1'-0"

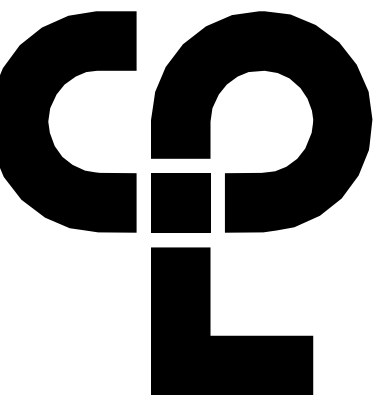

CPL | Architecture Engineering Planning
 1620 Hillsborough Street Suite A,
 Raleigh, NC 27605
 CPLearn.com

PROJECT INFORMATION

Project Number
 R22.16900.00
 Client Name

WILSON COUNTY SCHOOLS


Project Name
**HUNT HS - ATHLETICS
 RENOVATION**
 HUNT HIGH SCHOOL

Project Address
 4559 Lamm Rd, Wilson, NC 27893

PROJECT ISSUE & REVISION SCHEDULE

Issue No.	Date	Description

PROFESSIONAL STAMPS

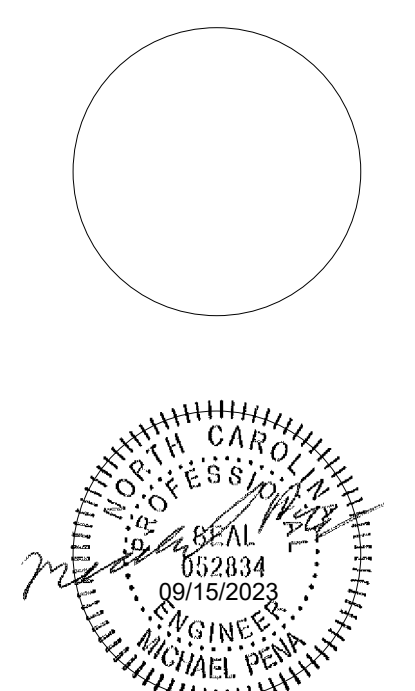

SHEET INFORMATION


Issued
 09.15.2023
 Project Status
CONSTRUCTION DOCUMENTS
 Drawn By
 JWB
 Checked By
 RLA
 Drawing Title
FIRST FLOOR DEMOLITION & NEW WORK

Drawing Number


P201

KEY NOTES


- 1 REMOVE EXISTING PLUMBING FIXTURE AND REPLACE WITH NEW PLUMBING FIXTURE. REMOVE ALL EXPOSED PLUMBING RELATED PIPING & ACCESSORIES. PROVIDE ALL NECESSARY NEW PLUMBING PIPING & ACCESSORIES REQUIRED FOR A COMPLETE INSTALLATION.
- 2 EXISTING FLOOR DRAIN TO REMAIN.
- 3 REMOVE EXISTING PLUMBING FIXTURE AND CAP EXISTING PIPING WITHIN WALL.
- 4 EXISTING WATER HEATER TO BE REMOVED.
- 5 EXISTING ICE BATH TO REMAIN.
- 6 EXTEND NEW 2" VENT PIPING AS REQUIRED & CONNECT TO EXISTING.
- 7 INSTALL THE NEW 3/4" CW PIPING WITHIN BLOCK WALL AS REQUIRED & CONNECT TO NEW FIXTURES.
- 8 EXTEND NEW 2" WASTE AS REQUIRED & CONNECT TO THE EXISTING. (TYP.)
- 9 CONTRACTOR TO MODIFY EXISTING PIPING/ INCLUDING NEW PIPING WITHIN EXISTING WALL AS REQUIRED TO CONNECT TO NEW FIXTURES.
- 10 EXISTING SHUT-OFF VALVE AND HOSE BIBB TO BE BEHIND NEW WALL WITH ACCESS PANEL. ADJUST EXISTING PIPING & VALVES AS REQUIRED.
- 11 PROVIDE NEW 1/2" LP GAS PIPING TO EXISTING KITCHEN EQUIPMENT WITH INDIVIDUAL SHUT-OFF VALVE.
- 12 PROVIDE NEW 1/2" LP GAS PIPING & CONNECT TO EXISTING LP TANK.

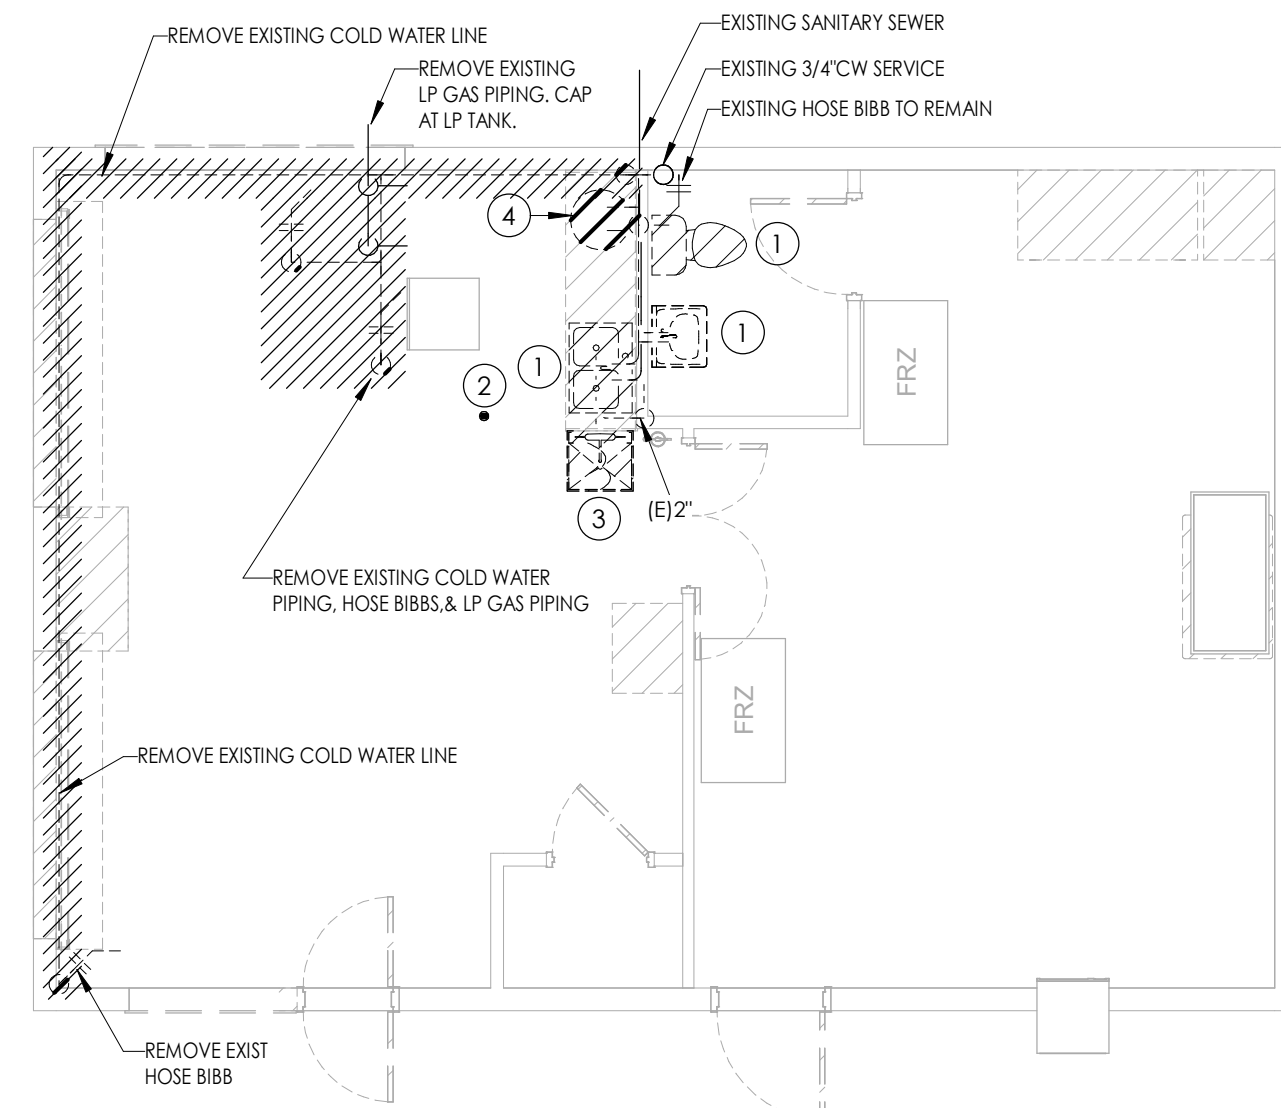


1 CONCESSIONS STAND PLUMBING PLAN - DEMOLITION
 P201 3/16" = 1'-0"

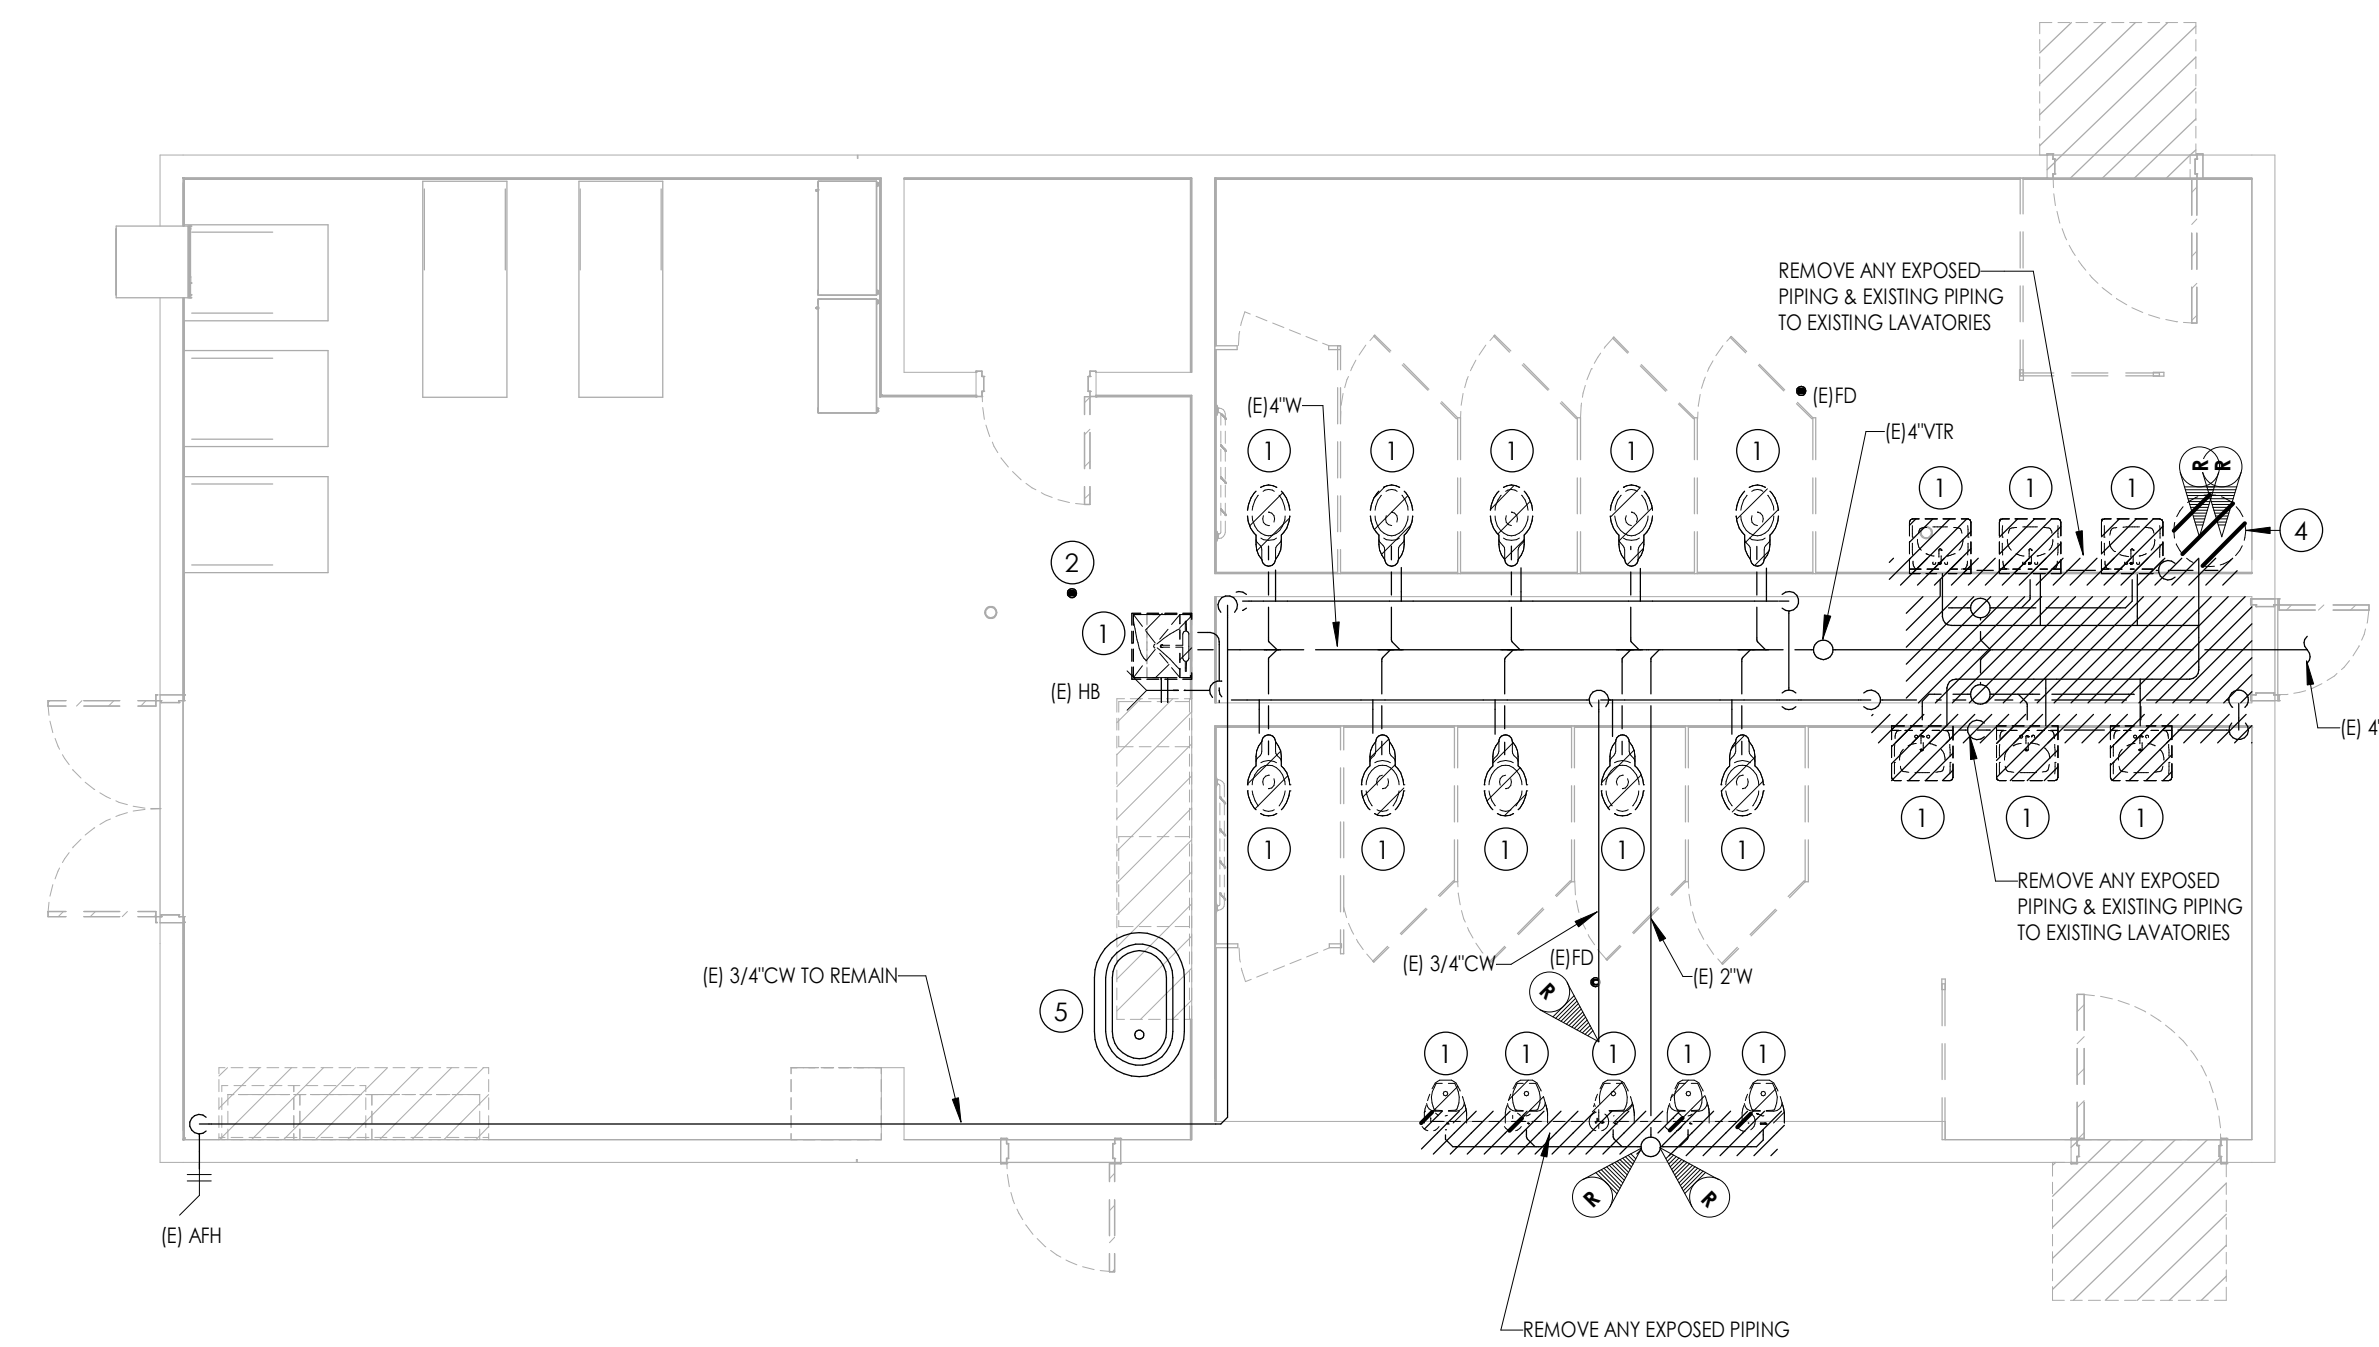

2 RESTROOM/TRAINING ROOM PLUMBING PLAN - DEMOLITION
 P201 3/16" = 1'-0"

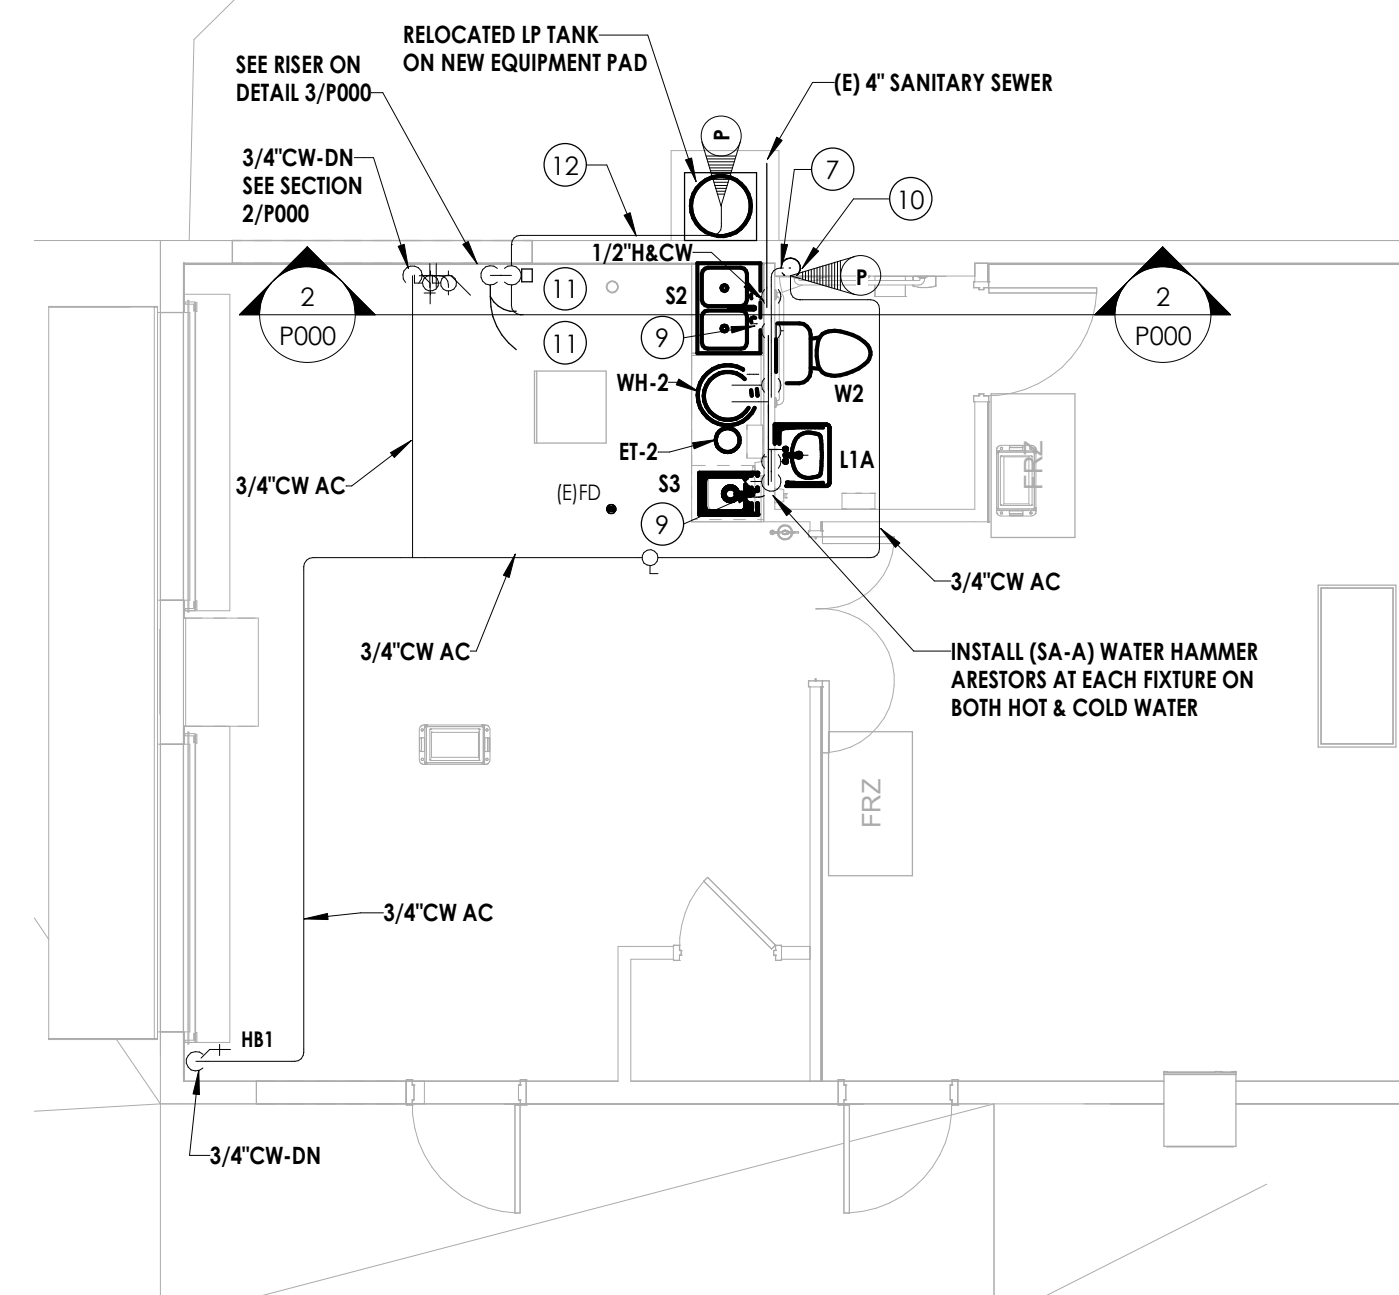

3 CONCESSIONS STAND PLUMBING PLAN - NEW
 P201 3/16" = 1'-0"

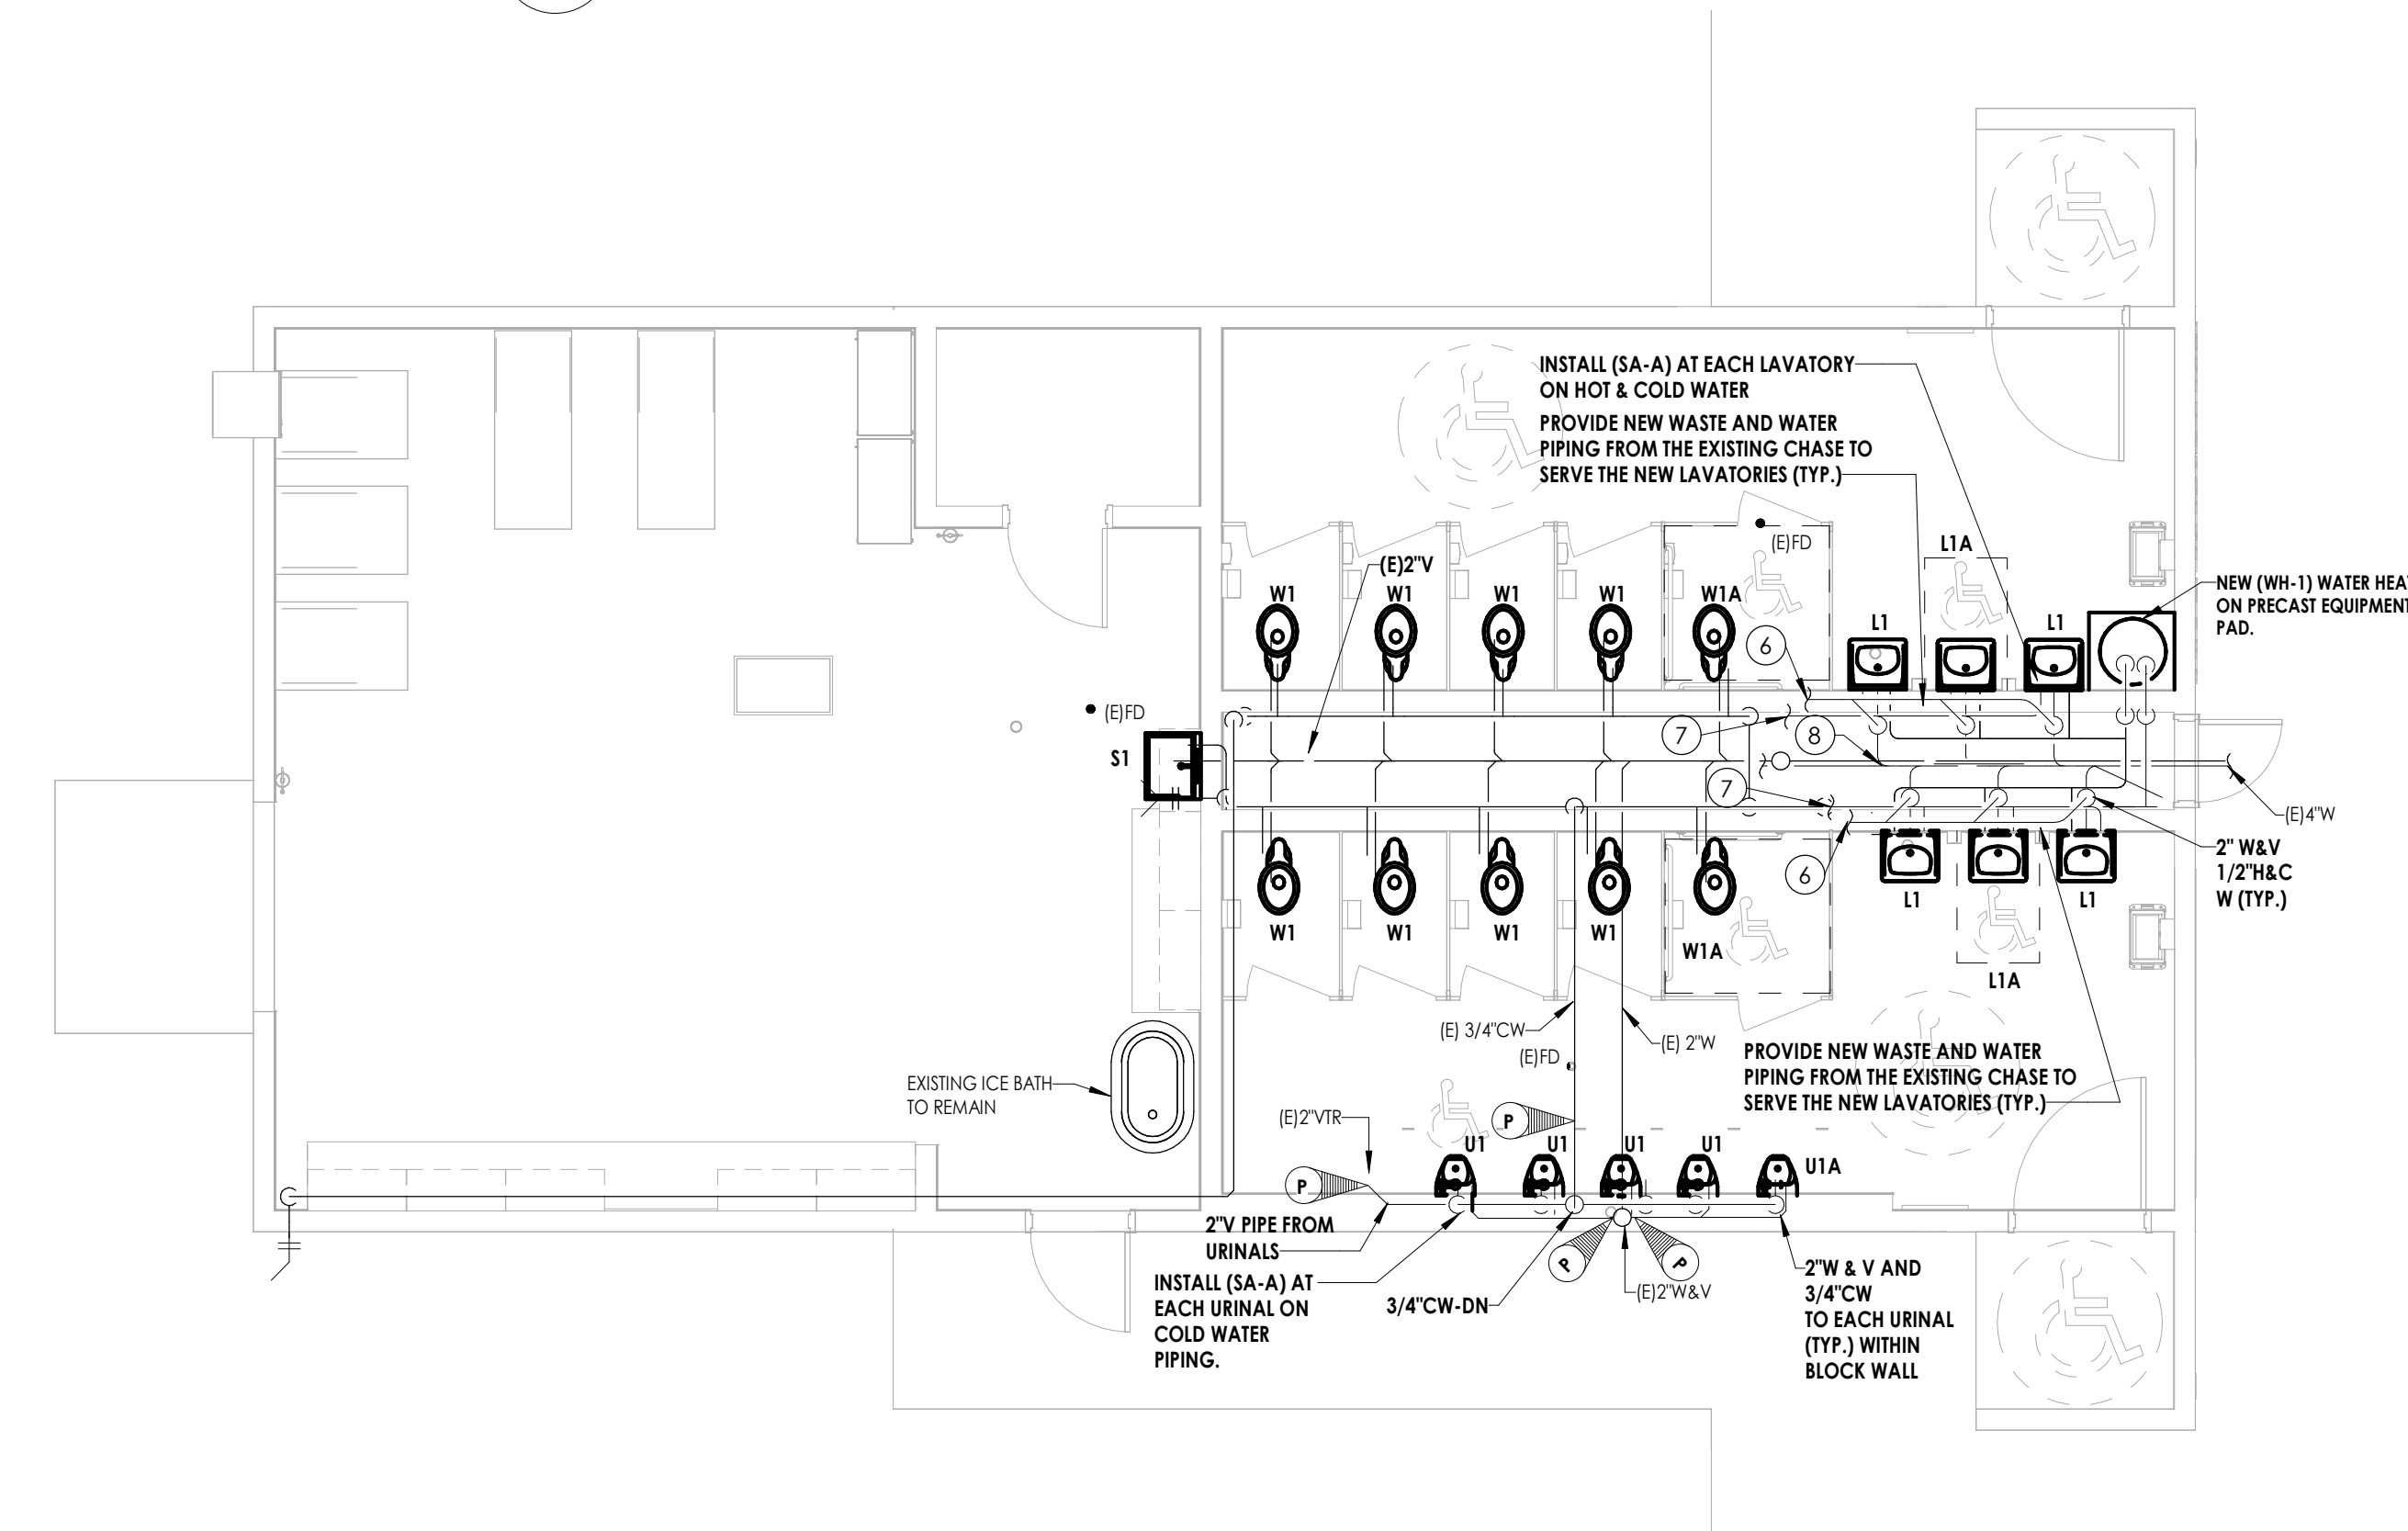

4 RESTROOM/TRAINING ROOM PLUMBING PLAN - NEW
 P201 3/16" = 1'-0"

DRAWINGS DEPICT EXISTING CONDITIONS TO THE BEST KNOWLEDGE OF THE ENGINEERS.

WIRING LEGEND:

- S_I SWITCH
- (NONE) SINGLE POLE TOGGLE SWITCH
- 2 TWO POLE TOGGLE SWITCH
- 3 THREE WAY TOGGLE SWITCH
- 4 FOUR WAY TOGGLE SWITCH
- WP SINGLE POLE WEATHER PROOF SWITCH
- K SINGLE POLE KEYPAD SWITCH
- P SINGLE POLE SWITCH WITH PILOT LIGHT
- TM SINGLE POLE SWITCH WITH ONE HOUR TIMER
- T THERMAL SWITCH
- TP THERMAL SWITCH WITH PILOT LIGHT
- M MOMENTARY CONTACT SWITCH
- LV LOW VOLTAGE SWITCH
- D DIMMER SWITCH
- O OCCUPANCY SENSOR SWITCH
- V VACANCY SENSOR SWITCH

- S_{II} ROMAN NUMERAL DESIGNATES NUMBER OF SWITCHES
- S_O LOWER CASE LETTER DESIGNATES SWITCH LEG
- (circle with vertical line) SINGLE RECEPTACLE
- (circle with horizontal line) PLUG-MOLD
- (circle with two vertical lines) DUPLEX RECEPTACLE
- (circle with four vertical lines) QUADRUPLEX RECEPTACLE
- (circle with triangle) SPECIAL RECEPTACLE

- GF_I GROUND FAULT CIRCUIT INTERRUPTER
- WP WEATHER PROOF IN-USE COVER
- SS SURGE SUPPRESSION
- C COUNTER HEIGHT
- TR TAMPER RESISTANT, UL LISTED
- IG ISOLATED GROUND
- RT RAIN TITE
- E EMERGENCY
- X TYPE X (SEE RECEPTACLE SCHEDULE)

- (circle with square) POWER POLE
- (circle with square and vertical line) RECESSED FLOOR MOUNTED DUPLEX RECEPTACLE
- (circle with square and horizontal line) SURFACE MOUNTED FLOOR RECEPTACLE
- (circle with square and diagonal line) CEILING MOUNTED DUPLEX RECEPTACLE
- C CONDUIT

GENERAL ELECTRICAL NOTES:

- 1) HATCHED AREAS///// DESIGNATE EXISTING EQUIPMENT TO BE REMOVED, UNLESS OTHERWISE NOTED.
- 2) ALL WORK TO BE DONE IN ACCORDANCE WITH THE LATEST ADOPTED EDITION OF THE NATIONAL ELECTRIC CODE (NFPA 70).
- 3) CONTRACTOR SHALL FIELD VERIFY ALL CONDITIONS AND COORDINATE WITH EXISTING EQUIPMENT PRIOR TO BIDDING.

BUILDING:

- 4) INSTALL DATA JACKS FOR CEILING MOUNTED WIRELESS TRANSMITTERS ABOVE CEILING IN ALL AREAS WHERE THERE IS AN ACCESSIBLE CEILING, UNLESS OTHERWISE NOTED. PROVIDE FLUSH MOUNTED JACKS IN ALL HARD CEILINGS.
- 5) ALL CONDUIT AND WIRING TO BE CONCEALED IN WALLS, FLOOR, OR ABOVE CEILINGS UNLESS OTHERWISE NOTED OR APPROVED BY THE ARCHITECT/ENGINEER. ALL DEVICE OUTLET BOXES SHALL BE RECESSED UNLESS OTHERWISE NOTED OR APPROVED BY THE ARCHITECT/ENGINEER. WHERE APPROVED OR NOTED, SURFACE METAL RACEWAY AND DEVICE BOXES SHALL BE USED IN-LIEU OF CONDUIT AND CONCEALED BOXES AT NO EXTRA COST TO THE OWNER.
- 6) ALL CONDUIT ROUTES SHOWN ARE APPROXIMATE ONLY. CONTRACTOR SHALL FIELD VERIFY FINAL ROUTE.
- 7) CONDUIT RUNS SHOWN ARE SCHEMATICAL AND DO NOT INDICATE THE NECESSARY FITTINGS AND JUNCTION BOXES THAT ARE INCLUDED IN THE SCOPE OF THE WORK.

GROUNDING:

- 8) ALL METAL RACEWAYS, INCLUDING CONDUIT, WIRE TROUGHS, WIREMOLD, ETC., SHALL BE GROUNDED. ALL CONNECTIONS IN METAL RACEWAYS SHALL BE COMPLETED IN SUCH A MANNER AS TO MAINTAIN A CONTINUOUS PATH TO GROUND THROUGHOUT THE ENTIRE LENGTH OF THE RACEWAY.

WIRING:

- 9) UNLESS NOTED OTHERWISE ON THE DRAWINGS OR ON THE EQUIPMENT WIRING SCHEDULE, EACH BRANCH CIRCUIT SHALL BE THREE (3) #12 AWG THHN/THWN (1 HOT, 1 NEUTRAL & 1 EQUIPMENT GROUND) IN 3/4" EMT CONDUIT. PROTECT EACH CIRCUIT WITH A 20 AMPERE, 1-POLE OVERCURRENT DEVICE UNLESS OTHERWISE NOTED. PROVIDE #10 AWG FOR 120V BRANCH CIRCUITS LONGER THAN 100 FEET. COMBINED NEUTRALS ARE NOT PERMITTED.

INSTALLATION HEIGHTS:


- HEIGHT TO CENTER OF EQUIPMENT ABOVE FINISHED FLOOR UNLESS OTHERWISE NOTED TO BE THE FOLLOWING:
- RECEPTACLE = 18"
- SWITCH = 44"
- MODULAR JACK FOR WALL MOUNTED TELEPHONE = 52"
- MODULAR TELEPHONE JACK = 18"
- AUDIO/VISUAL FIRE ALARM INDICATORS = 88"
- FIRE ALARM PULL STATIONS = 48"
- TELEVISION OUTLET = 7'-0"
- COMPUTER OUTLET = 18"
- CALL SWITCH = 44"
- REMOTE TEST STATION FOR DUCT DETECTOR = 52"

C = ABOVE COUNTER BACKSPASH, COORDINATE WITH ARCHITECTURAL ELEVATIONS.

LIGHT FIXTURE LEGEND:

- (square with X) LIGHTING FIXTURE (SEE LIGHTING FIXTURE SCHEDULE FOR LETTER DESIGNATION AND DESCRIPTION OF FIXTURES)
- (square with diagonal line) EMERGENCY AND/OR NIGHT LIGHT LIGHTING FIXTURE
- (square with T) EXIT LIGHTING FIXTURE UNIVERSAL MOUNT, SINGLE/DOUBLE FACE (WHERE USED, ARROW INDICATES CHEVRON DIRECTION)
- (square with battery symbol) BATTERY POWERED EMERGENCY LIGHT
- (square with arrow) EMERGENCY LIGHT REMOTE HEAD
- (square with A) TRACK LIGHTING
- (square with circle) POLE MOUNTED LIGHTING (QUANTITY AND ORIENTATION OF HEADS AS SHOWN)
- (circle with OS) OCCUPANCY SENSOR - CEILING MOUNTED
- (circle with OSW) OCCUPANCY SENSOR - WALL MOUNTED
- (square with LC) LIGHTING CONTACTOR
- (square with PC) PHOTOCELL

NOTE:
SYMBOLS SHOWN ON THIS ELECTRICAL SYMBOLS LIST ARE FOR REFERENCE PURPOSES ONLY. ALL OF THESE SYMBOLS MAY NOT BE USED FOR THIS PROJECT.

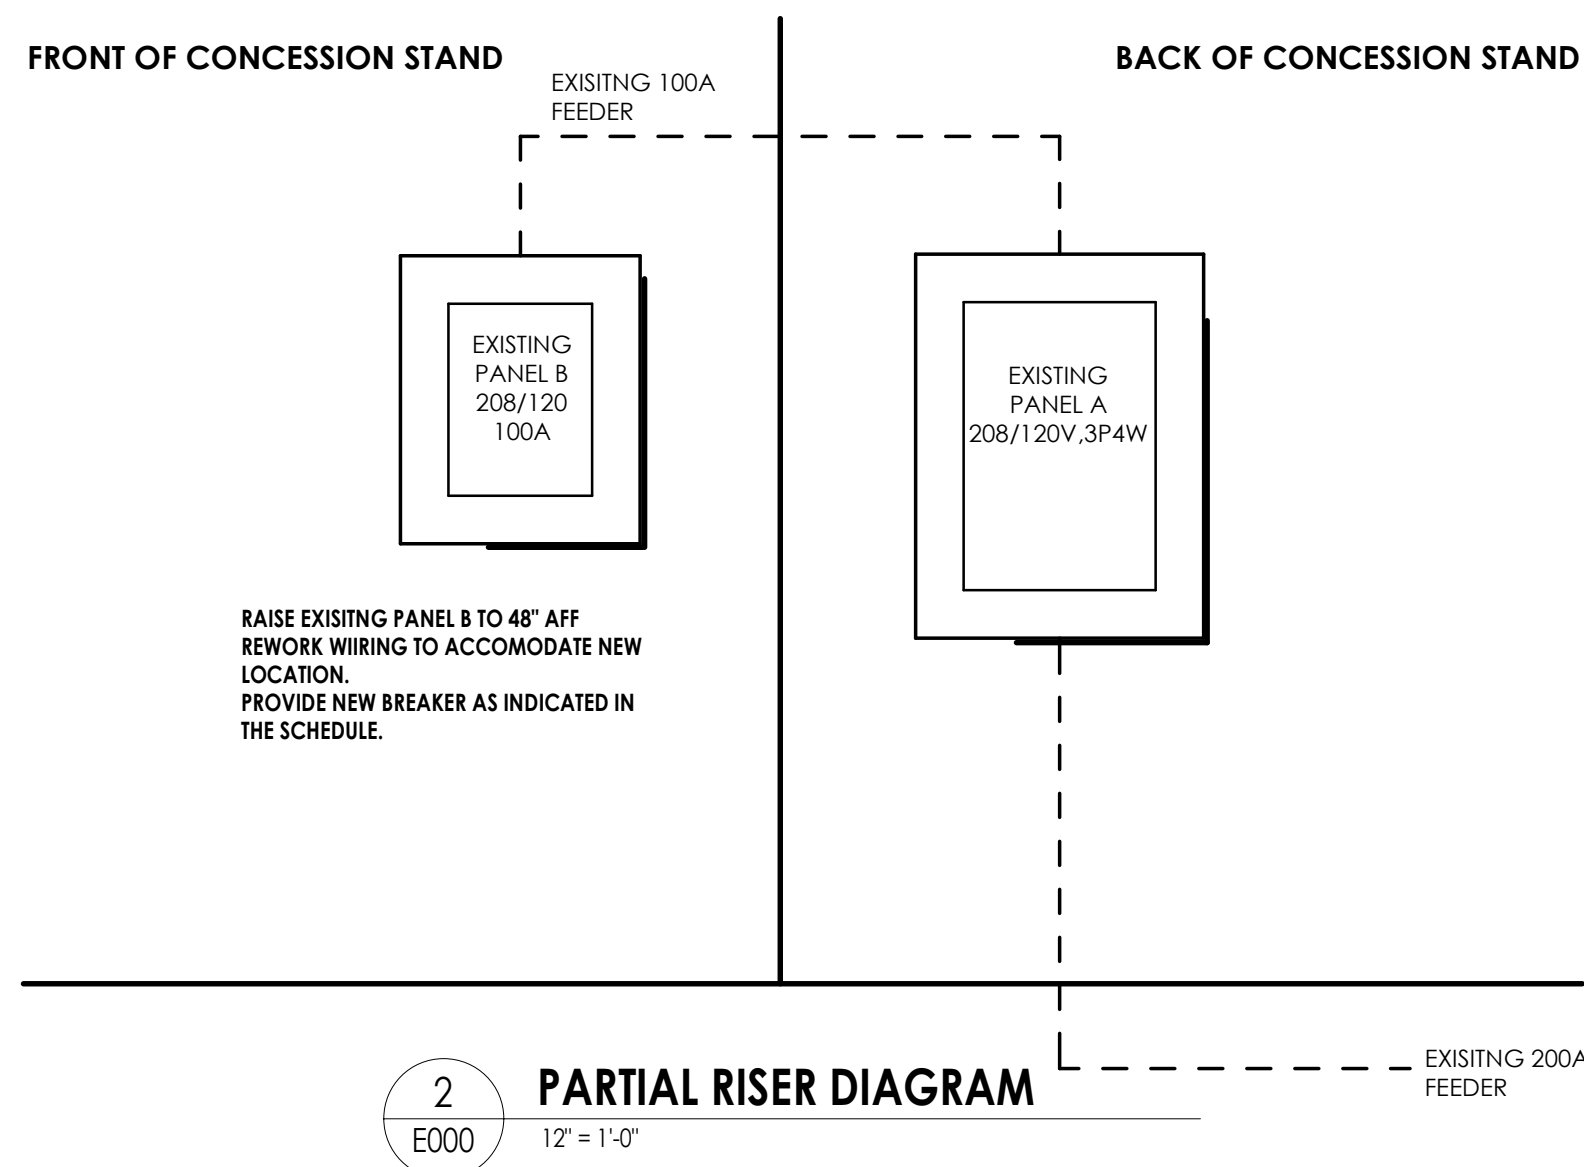

EXISTING PANEL A		VOLTAGE:	208/120 3 PH 4W			AIC RATING: 10K	REMARKS:			
		FEEDER AMP:	200	MAINS:	200 MLO	MOUNTING: SURFACE	N- NEW CIRCUIT			
		LUGS:			FEED:	ENCLOSURE: NEMA 1	E- EXISTING CIRCUIT			
BKR	NOTE	LOAD DESCRIPTION	VA	CKT	PHASE	CKT	VA	LOAD DESCRIPTION	NOTE	BKR
	E	OUTDOORLIGHTS/ DRINK MACHINE	0	1	A	2	0	MAIN	E	10/3
	E	RCPT NEAR BATHROOM DOOR	0	3	B	4	0	---	E	-
30/2	N	WATER HEATER	0	5	C	6	0	---	E	-
-	-	---	0	7	A	8	0	RCPT-ICE MAKER	E	20/1
-	E	SPARE	0	9	B	10	0	LIGHTS	E	20/1
	E	ATTIC FAN	0	11	C	12	0	RCPT-POPCORN MACHINE	E	20/1
	E	AC/ HEAT	0	13	A	14	0	COFFEE MACHINE	E	10/3
-	-	---	0	15	B	16	0	---	E	-
	E	HOOD FAN	0	17	C	18	0	---	E	-
-	-	---	0	19	A	20	0	FREEZER	E	20/1
-	-	---	0	21	B	22	0	MICROWAVE	E	25/1
	E	RCPT - BELOW PANEL	0	23	C	24	0	RCPT	E	20/1
-	-	SPARE	0	25	A	26	0	SPACE	-	-
-	-	SPARE	0	27	B	28	0	SPACE	-	-
-	-	SPARE	0	29	C	30	0	SPACE	-	-
	SUB		0		A					
			0		B					SUB
			0		C					
Connected Load Per Phase			PH A:	0	PH B:	0	PH C:	0		
		Lighting	HVAC	Motors	Recept.	Refrig	Kitchen	Misc	Total VA	Amps
Connected VA	0	0	0	0	0	0	0	0	0	0.0
Demand Factor	1.25	1.00	1.00	NEC	1.00	1.00	1.00			
Demand VA	0	0	0	0	0	0	0		0	0.0

EXISTING PANEL B		VOLTAGE:	208/120 3 PH 4W			AIC RATING: 10K	REMARKS:			
		FEEDER AMP:	100	MAINS:	100 MLO	MOUNTING: SURFACE	G- PROVIDE GFI BREAKER			
		LUGS:			FEED: TOP	ENCLOSURE: NEMA 1				
BKR	NOTE	LOAD DESCRIPTION	VA	CKT	PHASE	CKT	VA	LOAD DESCRIPTION	NOTE	BKR
30/2	G	CONCESSION EQUIPMENT	1800	1	A	2	1000	CONCESSION EQUIPMENT	G	20/1
-	-	---	1800	3	B	4	1000	CONCESSION EQUIPMENT	G	20/1
40/2	G	CONCESSION EQUIPMENT	1500	5	A	6	1000	CONCESSION EQUIPMENT	G	20/1
-	-	---	1500	7	B	8	0	CONCESSION EQUIPMENT	G	-
	SUB		0		A					SUB
			0		B					
			0		C					
Connected Load Per Phase			PH A:	5300	PH B:	4300				
		Lighting	HVAC	Motors	Recept.	Refrig	Kitchen	Misc	Total VA	Amps
Connected VA	0	0	0	0	0	0	9600	0	9600	46.2
Demand Factor	1.25	1.00	1.00	NEC	1.00	1.00	1.00			
Demand VA	0	0	0	0	0	9600	0		9600	46.2



PROJECT INFORMATION
 Project Number: R22.16900.00
 Client Name: WILSON COUNTY SCHOOLS
 Project Name: HUNT HS - ATHLETICS RENOVATION
 HUNT HIGH SCHOOL
 Project Address: 4559 Lamm Rd, Wilson, NC 27893

PROJECT ISSUE & REVISION SCHEDULE


PROFESSIONAL STAMPS



SHEET INFORMATION

Issued: 09/15/2023 Scale: 12" = 1'-0"
 Project Status: CONSTRUCTION DOCUMENTS
 Drawn By: KSF Checked By: MSR
 Drawing Title: ELECTRICAL SYMBOLS LEGEND, NOTES & SYSTEM DIAGRAMS

Drawing Number: E000

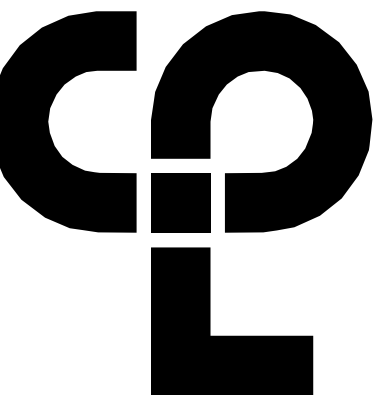

CPL | Architecture Engineering Planning
1620 Hillsborough Street Suite A,
Raleigh, NC 27605
CPLteam.com



PROJECT INFORMATION

Project Number
R22.16900.00

Client Name
WILSON COUNTY SCHOOLS


Project Name
**HUNT HS - ATHLETICS
RENOVATION**
HUNT HIGH SCHOOL

Project Address
4559 Lamm Rd, Wilson, NC 27893

PROJECT ISSUE & REVISION SCHEDULE

Issue Description

PROFESSIONAL STAMPS

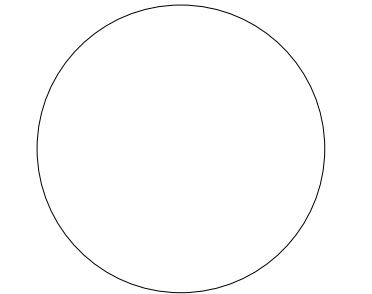

SHEET INFORMATION

Issued 09/15/2023 Scale As indicated

Project Status CONSTRUCTION DOCUMENTS

Drawn By KSF Checked By MSR

Drawing Title DEMOLITION PLAN

Drawing Number


E101

GENERAL NOTES


- A. ALL ITEMS SHOWN ARE TO BE REMOVED UNLESS LABELED AS (E) EXISTING. REMOVAL OF DEVICE INCLUDES ITS ASSOCIATED CABLING/BRANCH CIRCUIT WIRING, AND RACEWAY.
- B. ANY EXISTING DEVICE TO REMAIN, LABELED AS (E) SHALL REMAIN IN PLACE AS WELL AS ITS ASSOCIATED CIRCUITING AND CONDUIT, UNLESS OTHERWISE NOTED.
- C. THE CONTRACTOR SHALL REMOVE THE EXISTING ELECTRIC IN AREAS OF NEW RENOVATIONS TO ACCOMMODATE NEW CONSTRUCTION. REROUTING OF EXISTING MAY BE REQUIRED AT NEW OPENINGS IN EXISTING CONSTRUCTION OR INTERFERENCE WITH OTHER NEW WORK.
- D. DRAWINGS INDICATE SPECIFIC ITEMS TO BE REMOVED AND/OR RELOCATED IN ORDER TO INDICATE GENERAL SCOPE. ADDITIONAL ITEMS NOT INDICATED, BUT NECESSARY FOR PROJECT RENOVATIONS, SHALL BE REMOVED, RELOCATED AND/OR REROUTED. THE CONTRACTOR SHALL ASSUME WITHIN THE BASE BID A NOMINAL AMOUNT OF BRANCH CIRCUITS, FIXTURES, DEVICES, AND SYSTEMS WIRING WITHIN WALLS OR OPENINGS BEING REMOVED OR RELOCATED AS REQUIRED TO ACCOMMODATE THE NEW CONSTRUCTION.
- E. WHERE DEVICES, FIXTURES, ETC. ARE INDICATED TO BE REMOVED, THEY AND THEIR RELATED WIRING/CONDUIT SHALL BE REMOVED BACK TO THE SOURCE PANELBOARD UNLESS OTHERWISE NOTED. ON CIRCUITS WHERE OTHER DEVICES, FIXTURES, ETC. ARE FOUND THAT MUST REMAIN, MAINTAIN CIRCUIT CONTINUITY BY PROVIDING ADDITIONAL WIRING TO FEED THROUGH TO THESE REMAINING ITEMS. RELOCATE ANY CIRCUITS THAT REMAIN TO AVOID CONFLICT WITH NEW CONSTRUCTION AS REQUIRED. PROPERLY TERMINATE ALL WIRING.
- F. COORDINATE DEMOLITION OF EQUIPMENT, DEVICES, ETC. WITH OTHER DISCIPLINES AS APPLICABLE. REFER TO ARCHITECTURAL DEMOLITION DRAWINGS AND NOTES FOR COORDINATION.
- G. DRAWINGS ARE GRAPHICAL REPRESENTATIONS OF APPROXIMATE EQUIPMENT AND DEVICE LOCATIONS. CONTRACTOR SHALL VISIT THE SITE TO DETERMINE THE EXACT EXTENT OF ELECTRICAL WORK REQUIRED TO COMPLETE THE PROJECT. EXISTING CONDITIONS ARE TAKEN FROM FIELD OBSERVATION AND EXISTING BUILDING DOCUMENTS. OTHER ELECTRICAL ITEMS MAY EXIST FOR WHICH THE CONTRACTOR IS RESPONSIBLE.
- H. CONTRACTOR SHALL PROPERLY DISPOSE OF ALL ITEMS, EQUIPMENT, PANELS, LIGHT FIXTURES, ETC. BEING REMOVED AS PART OF THIS PROJECT. THE OWNER SHALL HAVE THE RIGHT OF RETAINING ANY ITEMS BEING REMOVED.
- I. CONTRACTOR SHALL PROVIDE NEW COVERPLATES ON ALL BOXES OF UNUSED AND/OR REMOVED FLUSH MOUNT DEVICES UPON COMPLETION OF PROJECT.
- J. FIREPROOFING AND/OR FIRE STOP MATERIALS REMOVED FROM FIRE RATED WALLS AND CEILING AS A RESULT OF DEMOLITION SHALL BE RE-INSTALLED USING AN APPROVED METHOD AS DESCRIBED IN ASSOCIATED PROJECT SPECIFICATIONS.

KEY NOTES


- 1 DISCONNECT AND REMOVE WIRING TO WATER HEATER.
- 2 DISCONNECT AND REMOVE WIRING TO HOOD FAN.
- 3 DISCONNECT AND RELOCATE PANEL TO 48" EXTEND WIRING AS REQUIRED.
- 4 DISCONNECT AND REMOVE LIGHT FIXTURE AND WIRING TO ACCOMMODATE CEILING DEMOLITION. LIGHTING CIRCUIT MAY BE REUSED FOR NEW LIGHTS.
- 5 DISCONNECT EXISTING DEVICE AND WIRING TO ACCOMMODATE DEMOLITION.
- 6 DISCONNECT WATER HEATER TO ACCOMMODATE DEMOLITION. CIRCUIT MAY BE REUSED FOR REPLACEMENT WATER HEATER.
- 7 ALTERNATE 1 - REPLACE EXISTING FIXTURE WITH NEW. REFER TO SHEET E301.
- 8 ALTERNATE 1 - DISCONNECT AND REMOVE EXISTING FIXTURE AND WIRING.

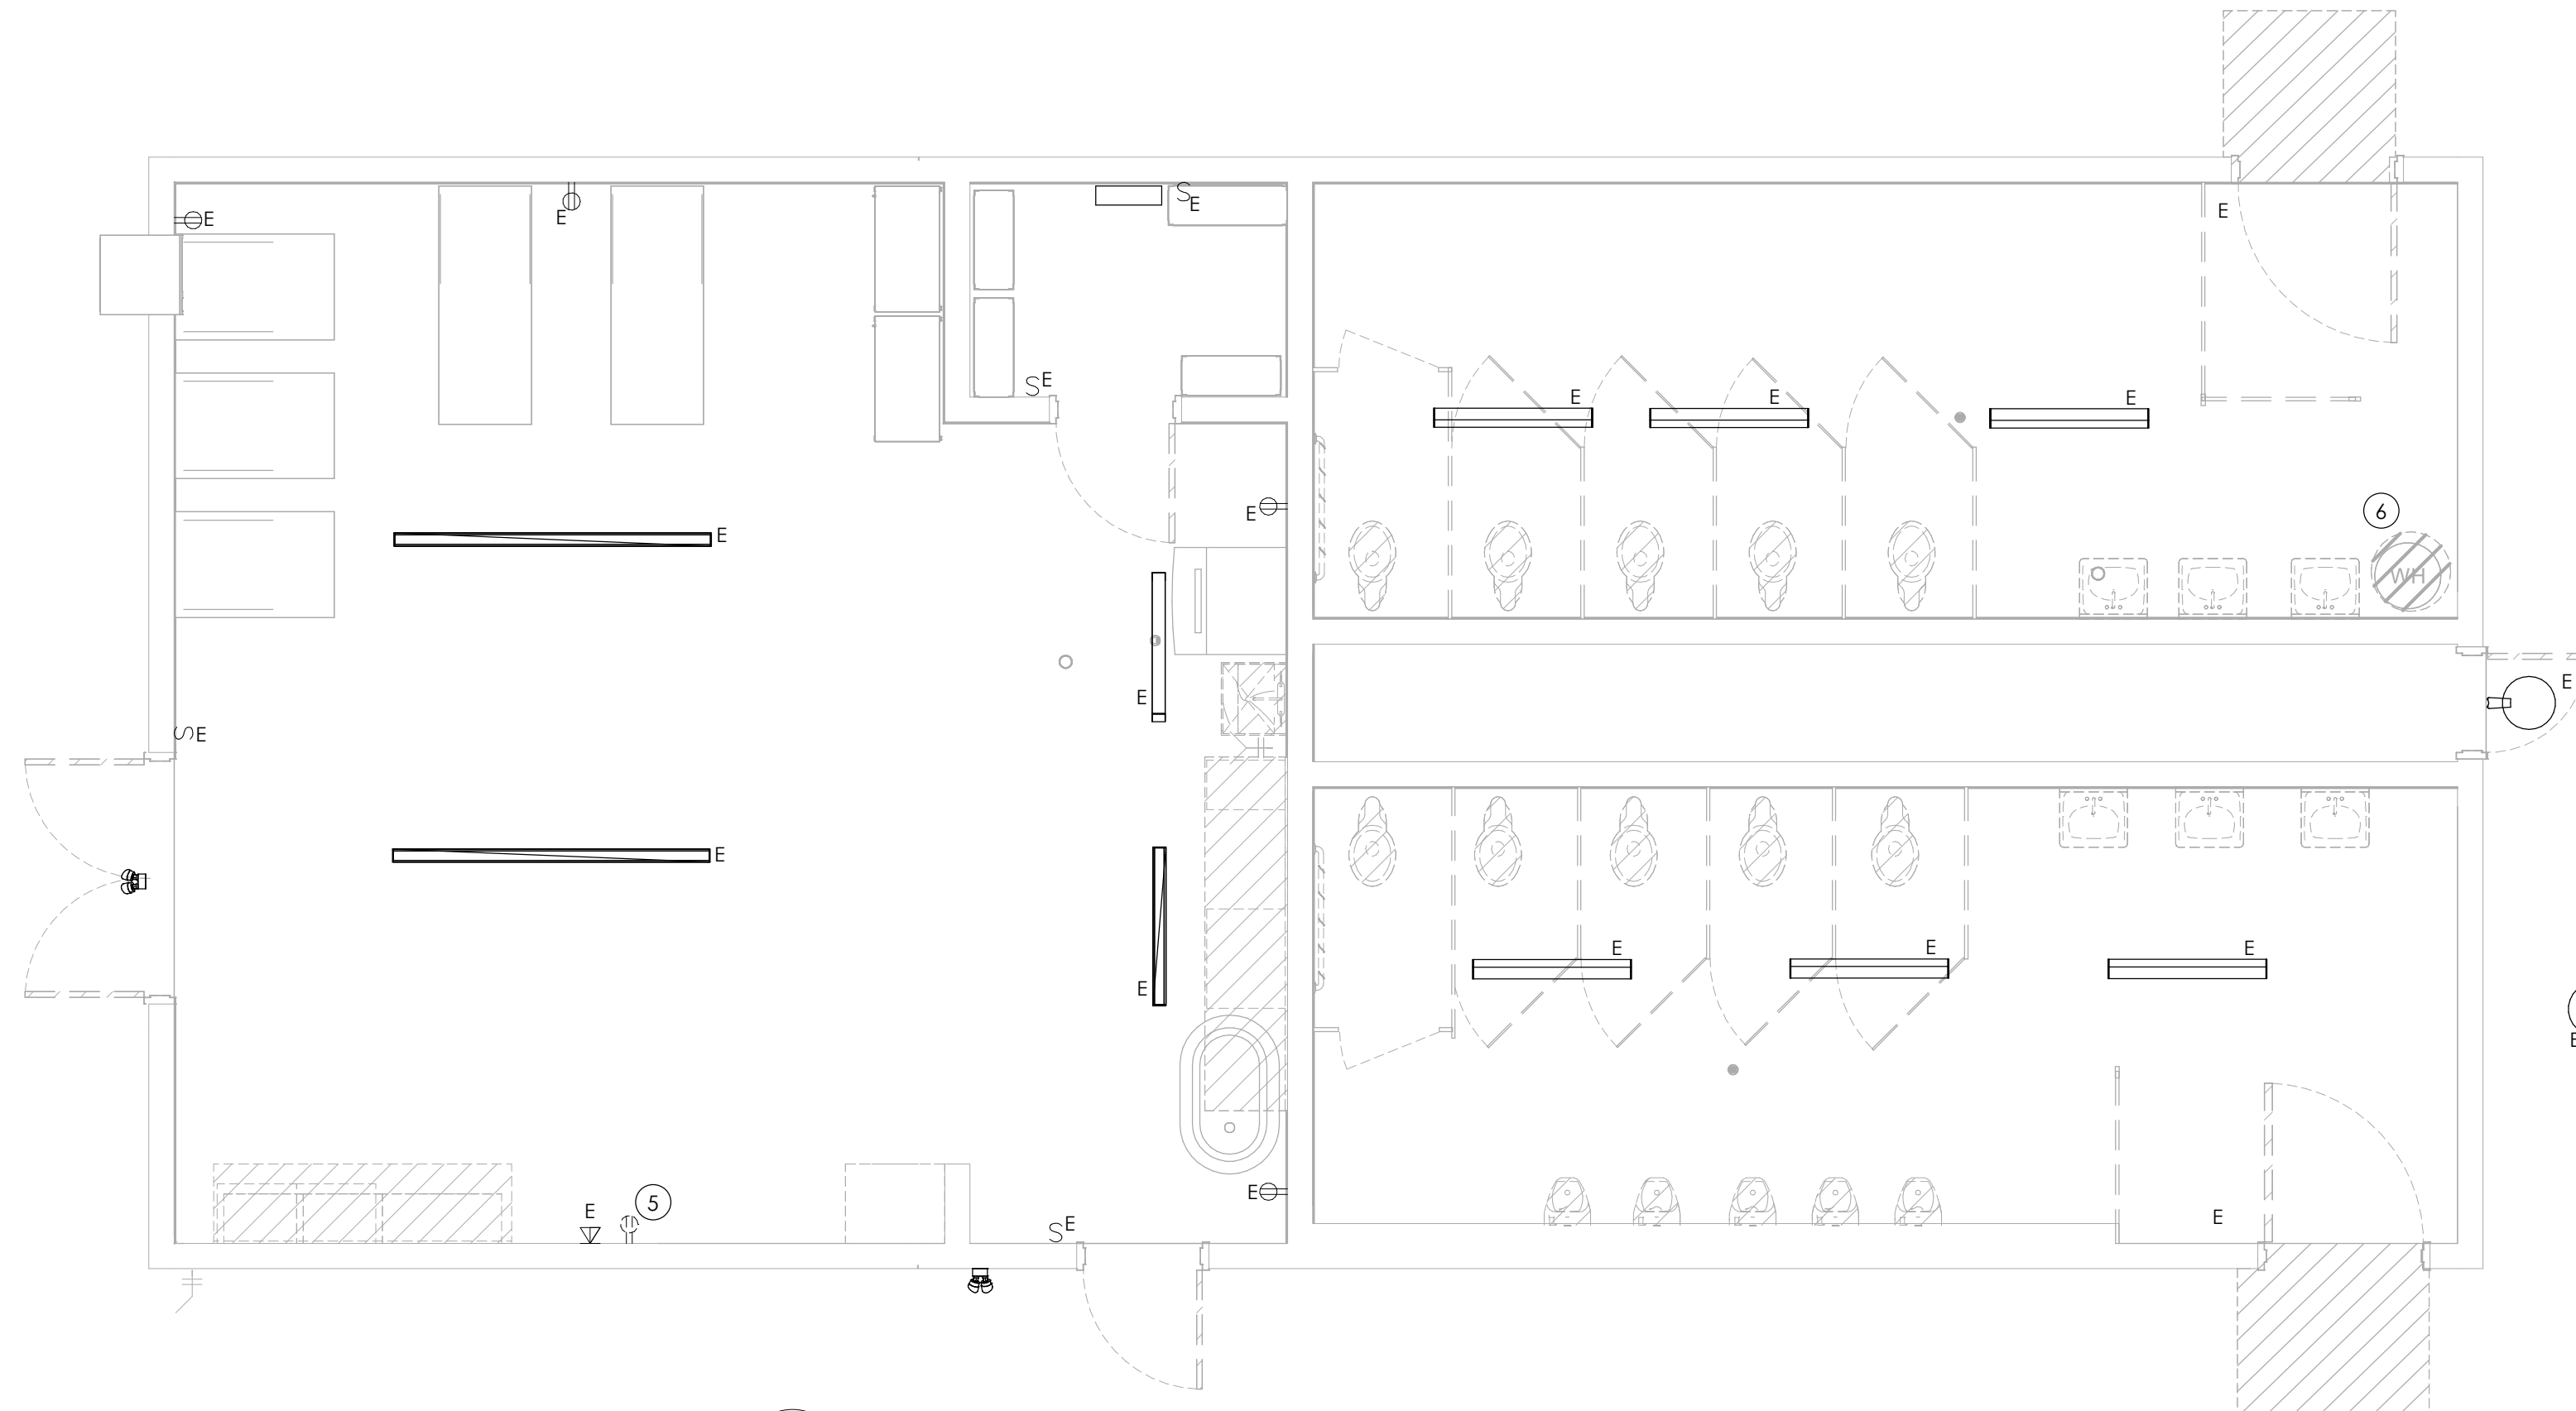


3 BATHROOM/TRAINING ROOM ELECTRICAL DEMO PLAN
E101 1/4" = 1'-0"

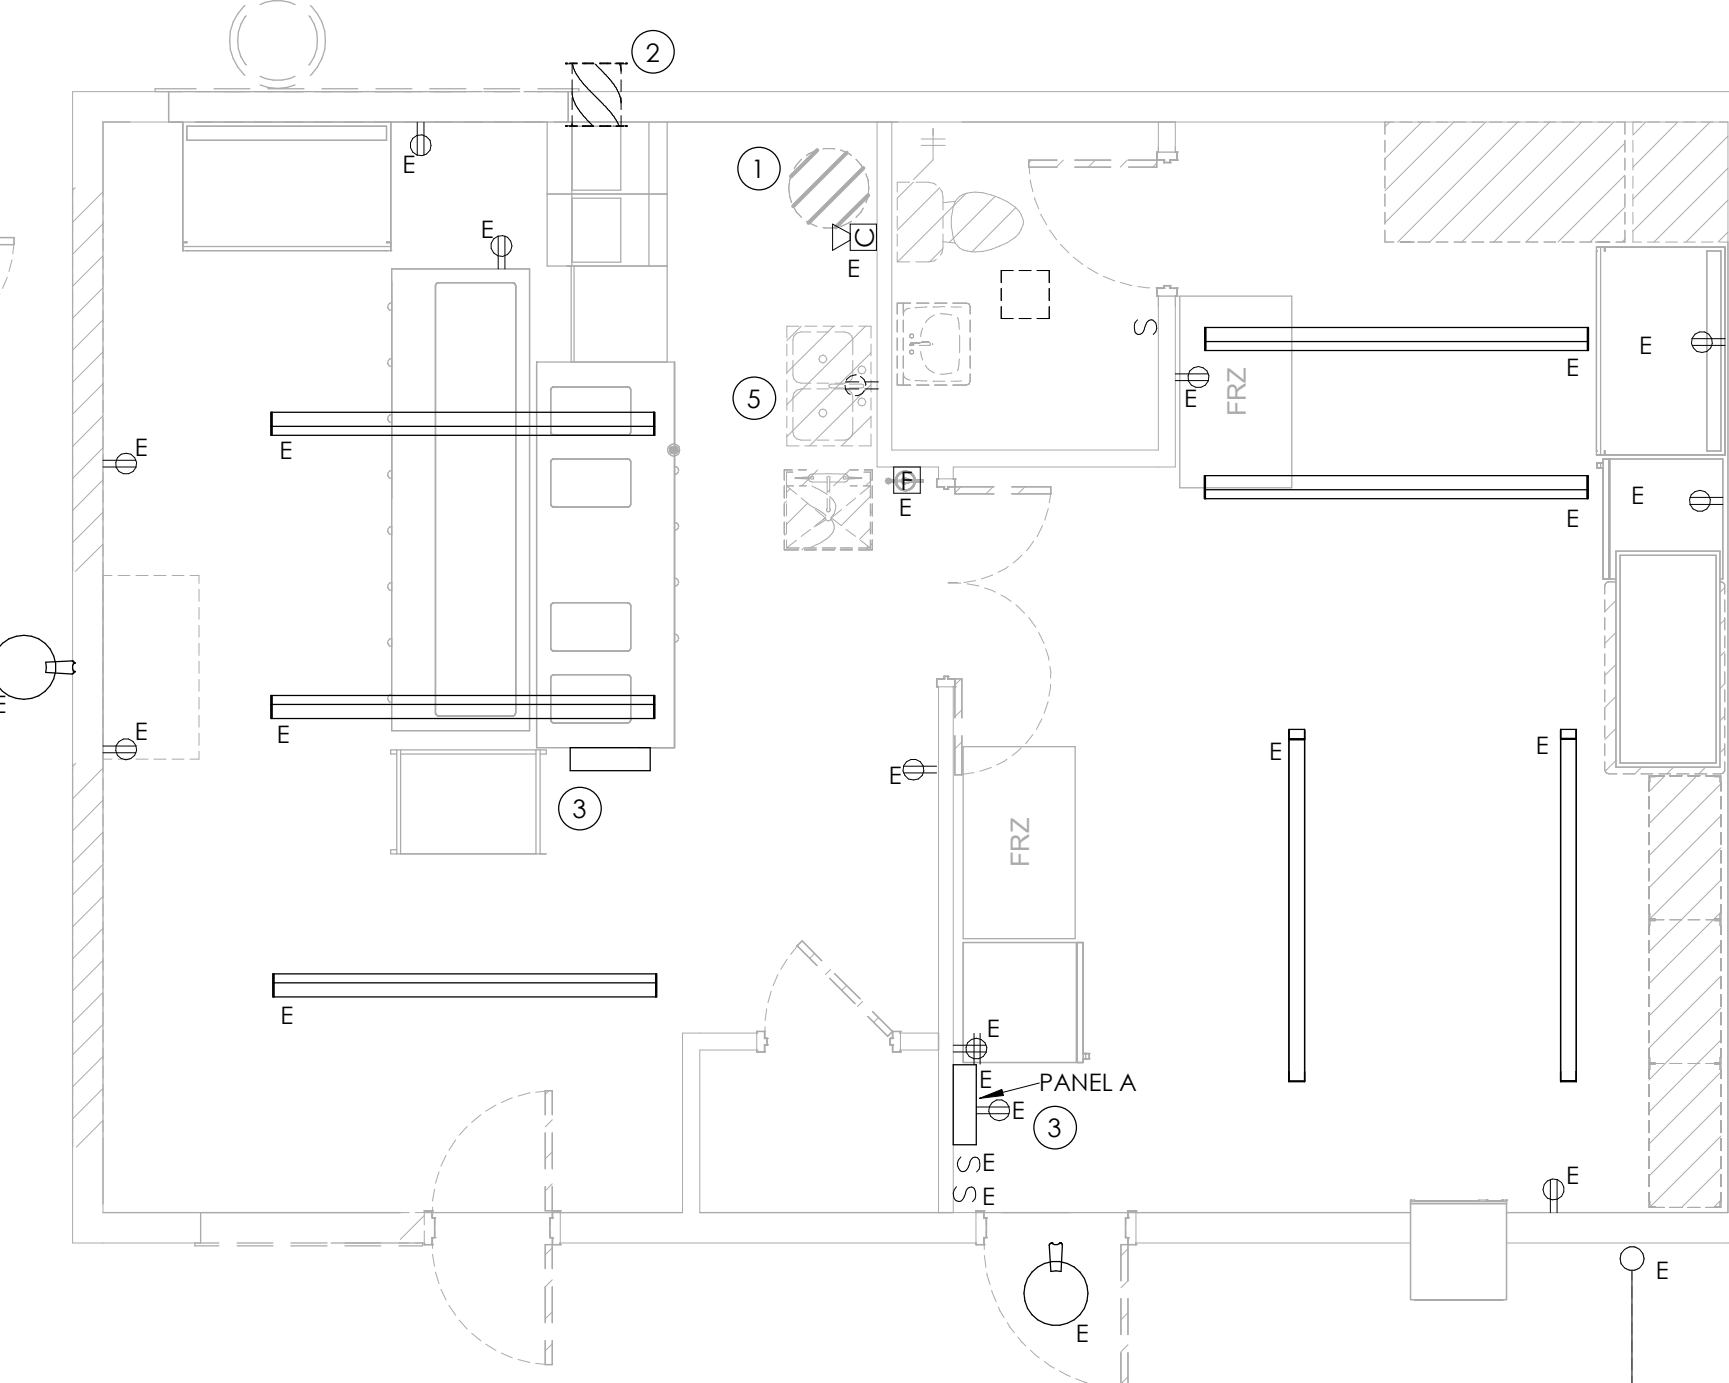

4 CONCESSION ELECTRICAL DEMO PLAN
E101 1/4" = 1'-0"

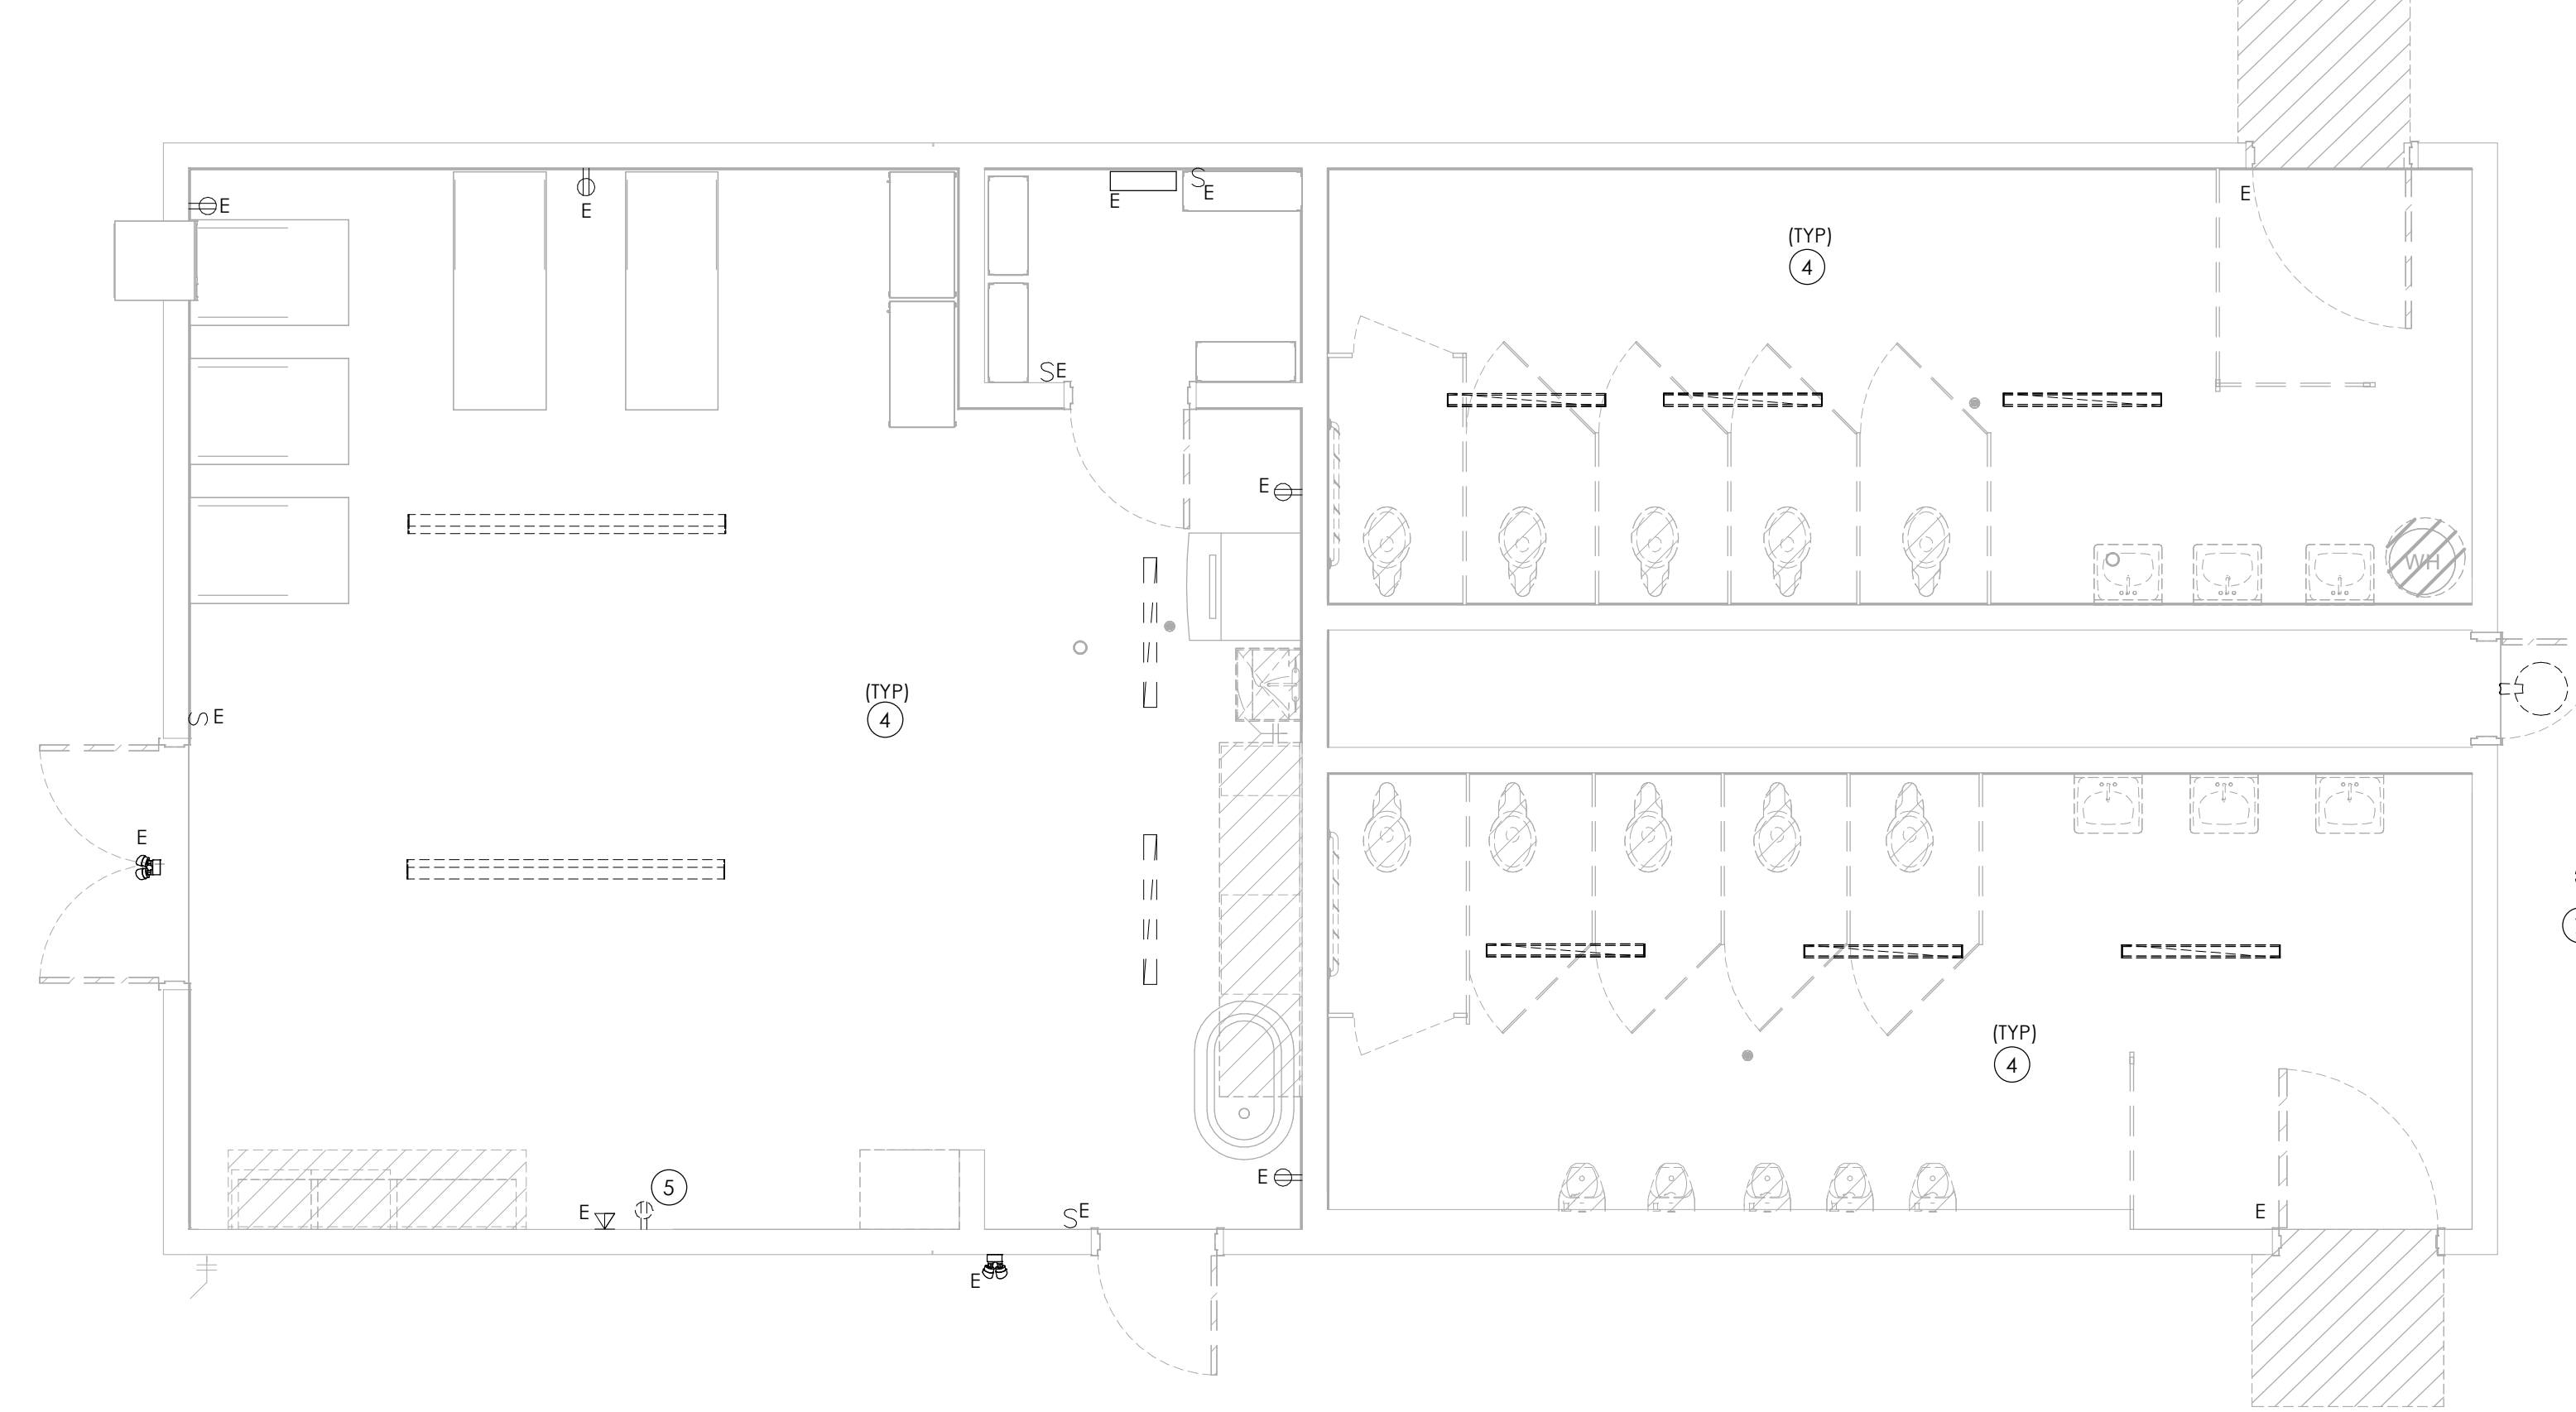


1 ALTERNATE BID BATHROOM/TRAINING ROOM ELECTRICAL DEMO PLAN
E101 1/4" = 1'-0"

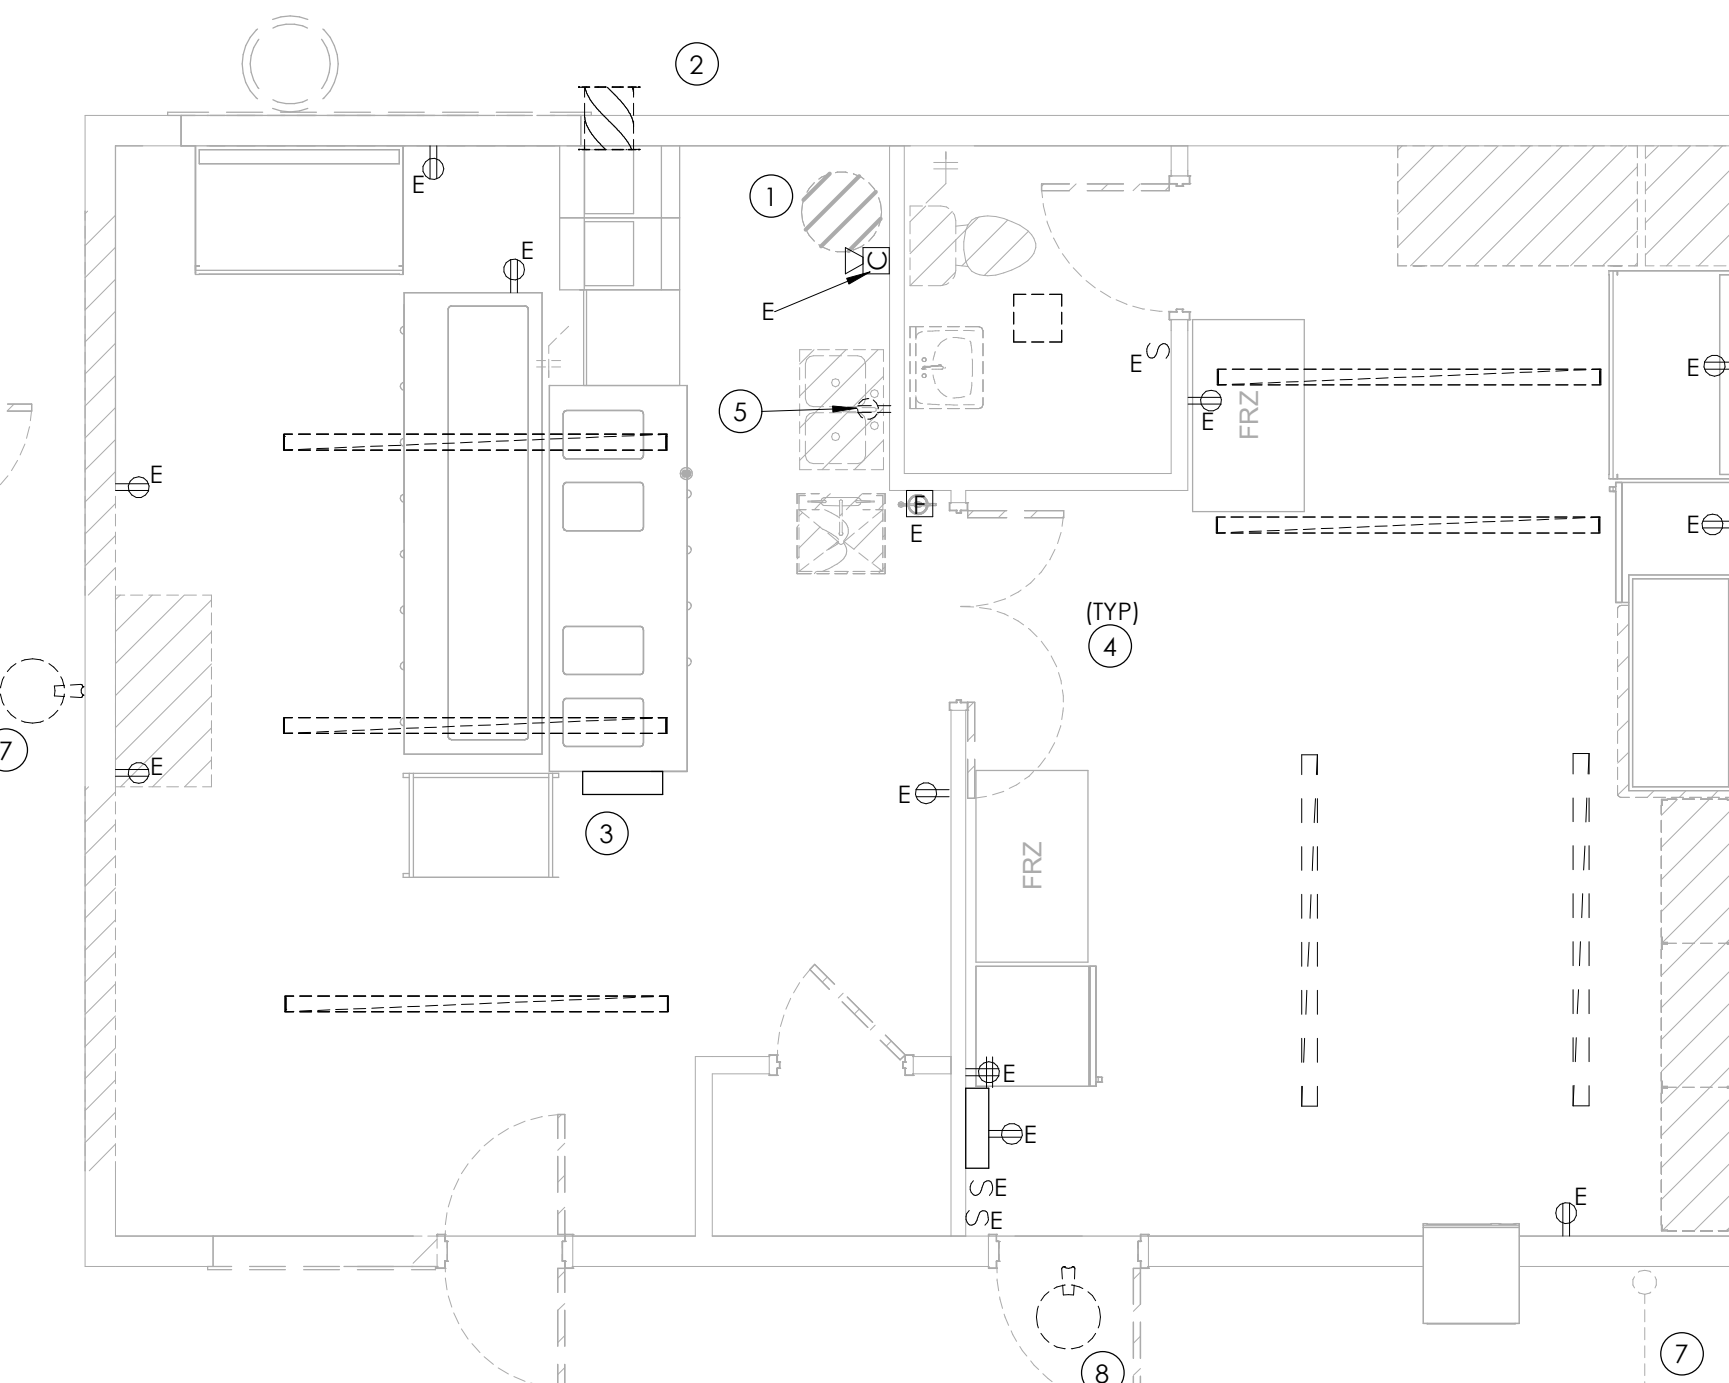


2 ALTERNATE BID CONCESSION ELECTRICAL DEMO PLAN
E101 1/4" = 1'-0"

9/22/2023 2:33:36 PM <project location>D Design & Project Files on BIM_360

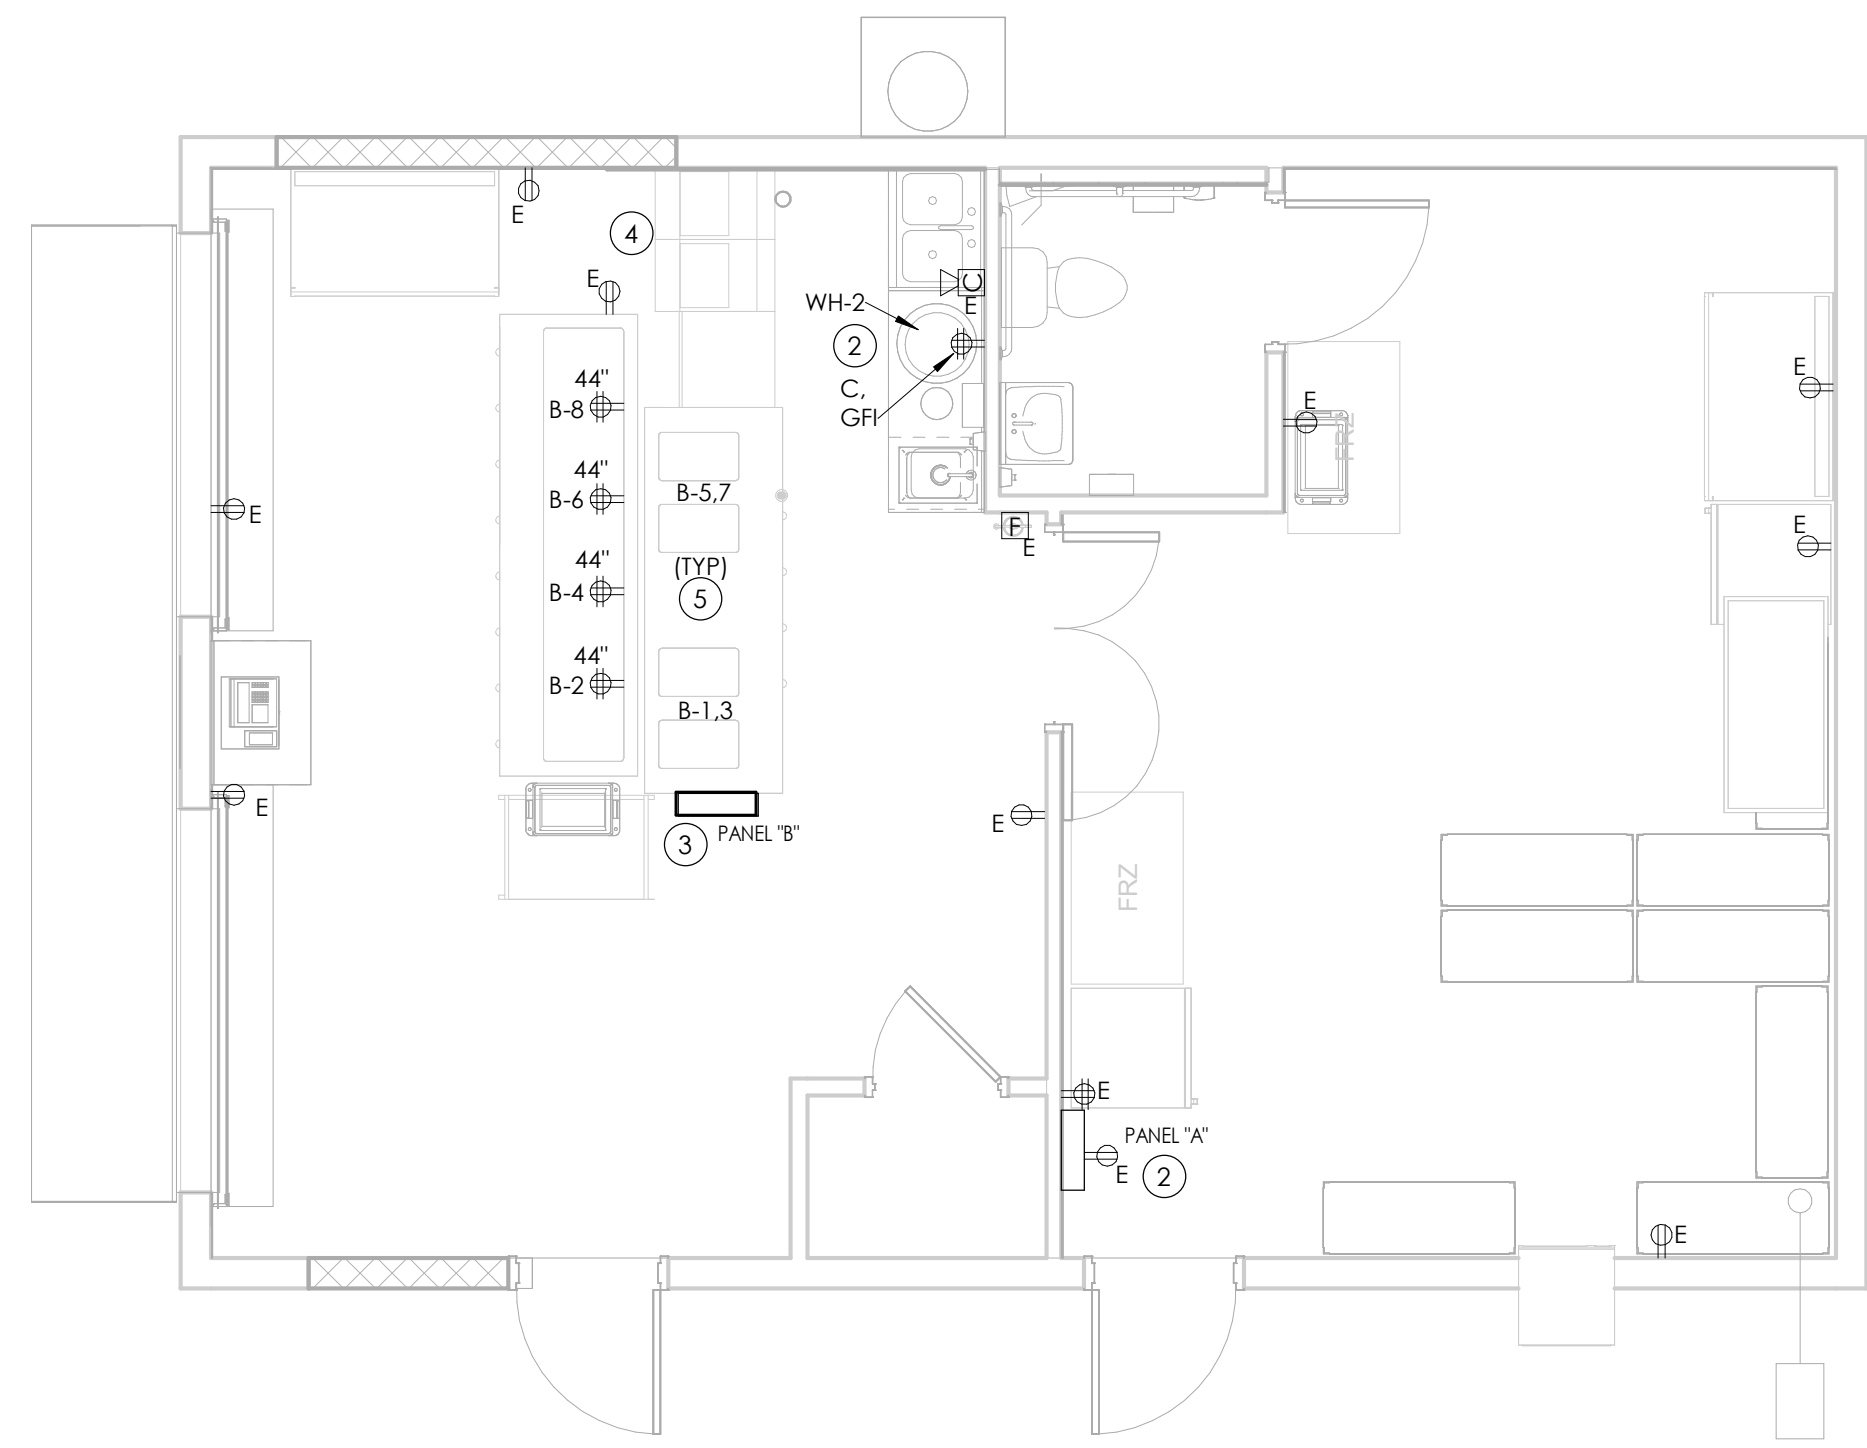

2 CONCESSION STAND POWER PLAN
E201 1/4" = 1'-0"

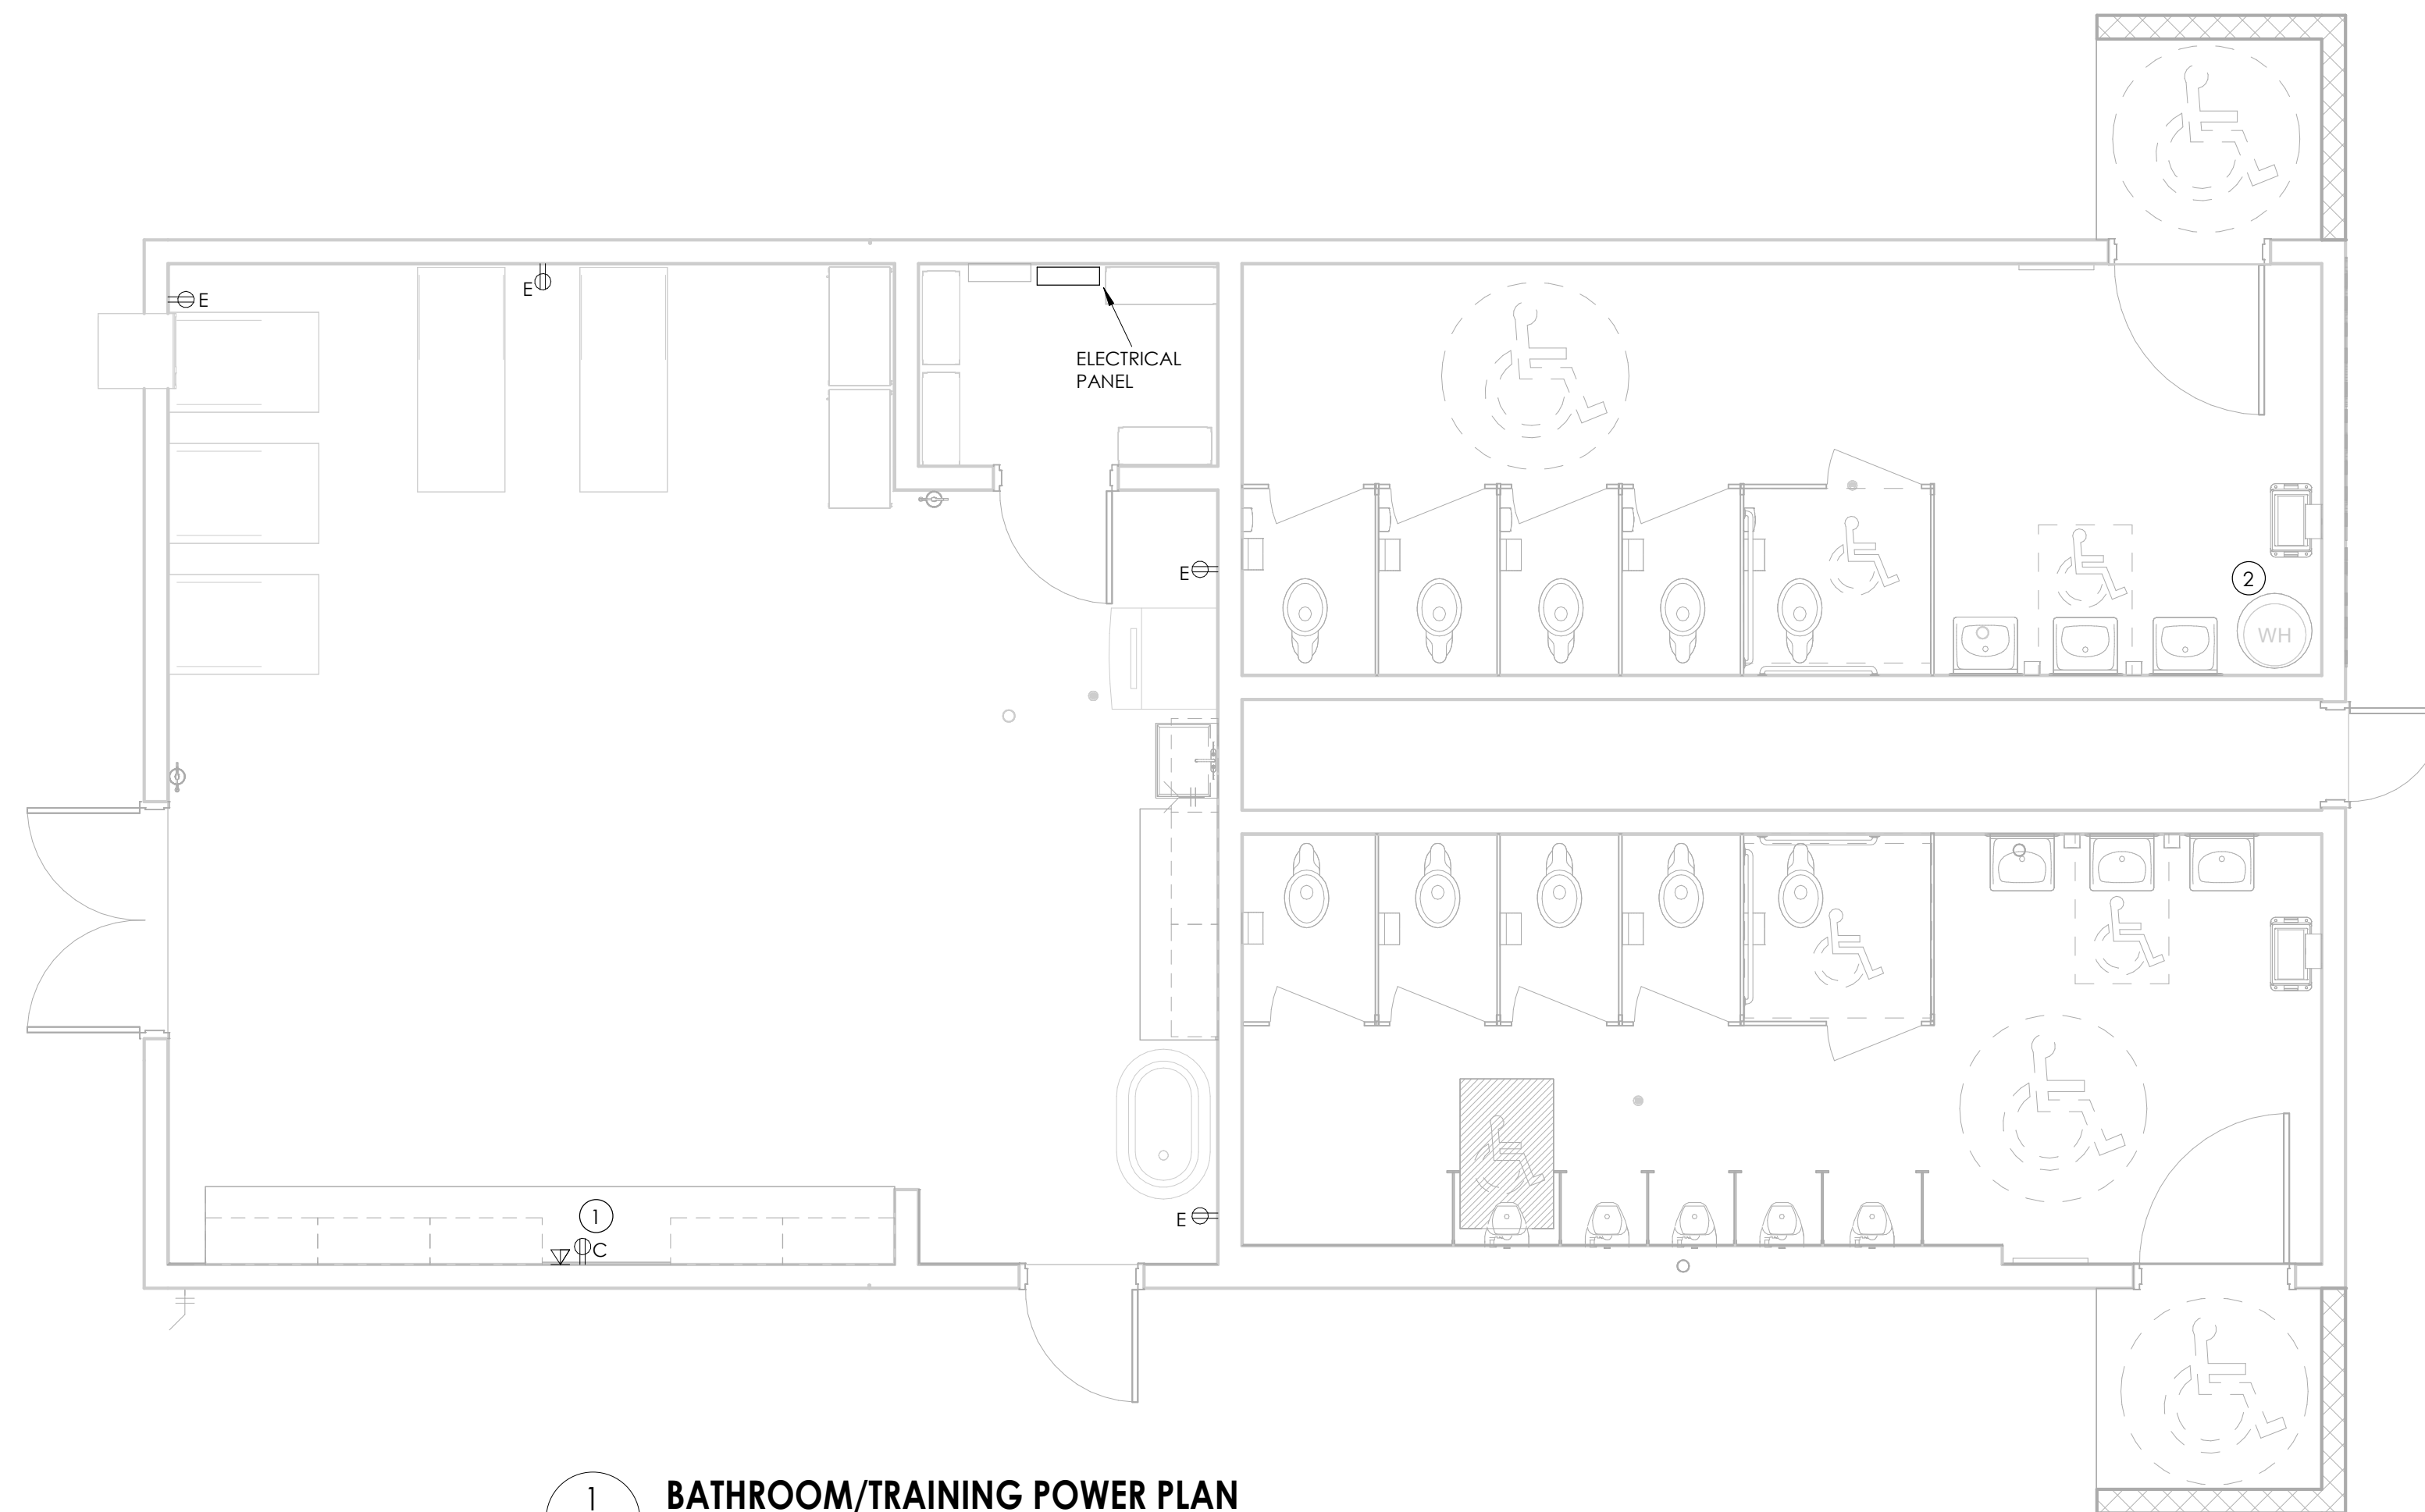


1 BATHROOM/TRAINING POWER PLAN
E201 1/4" = 1'-0"

GENERAL NOTES

A. VERIFY ALL ELECTRICAL EQUIPMENT REQUIREMENTS BEFORE DISCONNECTING AND RECONNECTING TO PANEL.

KEY NOTES

- 1 PROVIDE RECEPTACLE COUNTER HEIGHT AND ALIGN TO DATA VERTICALLY.
- 2 DISCONNECT AND REMOVE CIRCUIT BREAKER A-5 AND A-7 FROM PANEL A. PROVIDE A 30/2 BREAKER TO FEED NEW WH-2.
- 3 RELOCATE 100A PANEL B 4' AFF. RECONNECT ALL CONCESSION EQUIPMENT TO PANEL B. VERIFY ALL CONCESSION EQUIPMENT POWER REQUIREMENTS BEFORE ROUGH IN. EXTEND WIRING AS REQUIRED.
- 4 CONNECT NEW HOOD FAN TO EXISTING FAN CIRCUIT. VERIFY POWER REQUIREMENTS PRIOR TO ROUGH IN.
- 5 PROVIDE NEW WIRING TO EXISTING CONCESSION EQUIPMENT FROM RAISED PANEL B. PROVIDE WIRING AND CONNECTION TO 40/2 AND 30/2 EQUIPMENT (VERIFY WITH EQUIPMENT). PROVIDE QUAD RECEPTACLES FOR EACH OF THE OTHER (4) CIRCUITS. LOCATE QUADS AT 44" AFF AND ATTACHED ALONG THE BACK OF THE BACKSPLASH OF THE "HOT WELL" CABINET, SPACED EQUIDISTANTLY ALONG THE BACK OF THE BACKSPLASH.

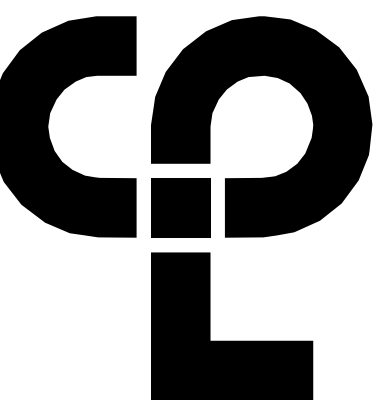

CPL | Architecture Engineering Planning
1620 Hillsborough Street Suite A,
Raleigh, NC 27605
CPLearn.com



PROJECT INFORMATION

Project Number
R22.16900.00
Client Name

WILSON COUNTY SCHOOLS



Project Name
HUNT HS - ATHLETICS RENOVATION
HUNT HIGH SCHOOL

Project Address
4559 Lamm Rd, Wilson, NC 27893

PROJECT ISSUE & REVISION SCHEDULE

W Date Description

PROFESSIONAL STAMPS

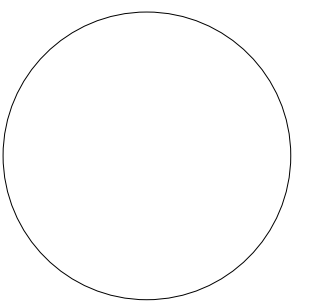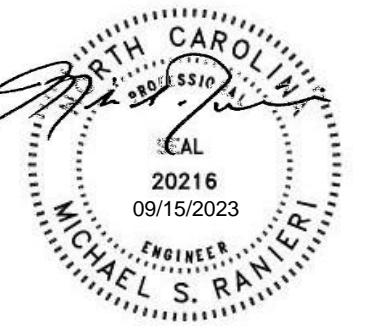


SHEET INFORMATION

Issued 09/15/2023 Scale As indicated
Project Status CONSTRUCTION DOCUMENTS
Drawn By KSF Checked By MSR
Drawing Title POWER DISTRIBUTION PLAN

Drawing Number

E201

KEY NOTES
 ① PROVIDE LIGHT FIXTURE. CONNECT TO EXISTING LIGHTING CIRCUIT.

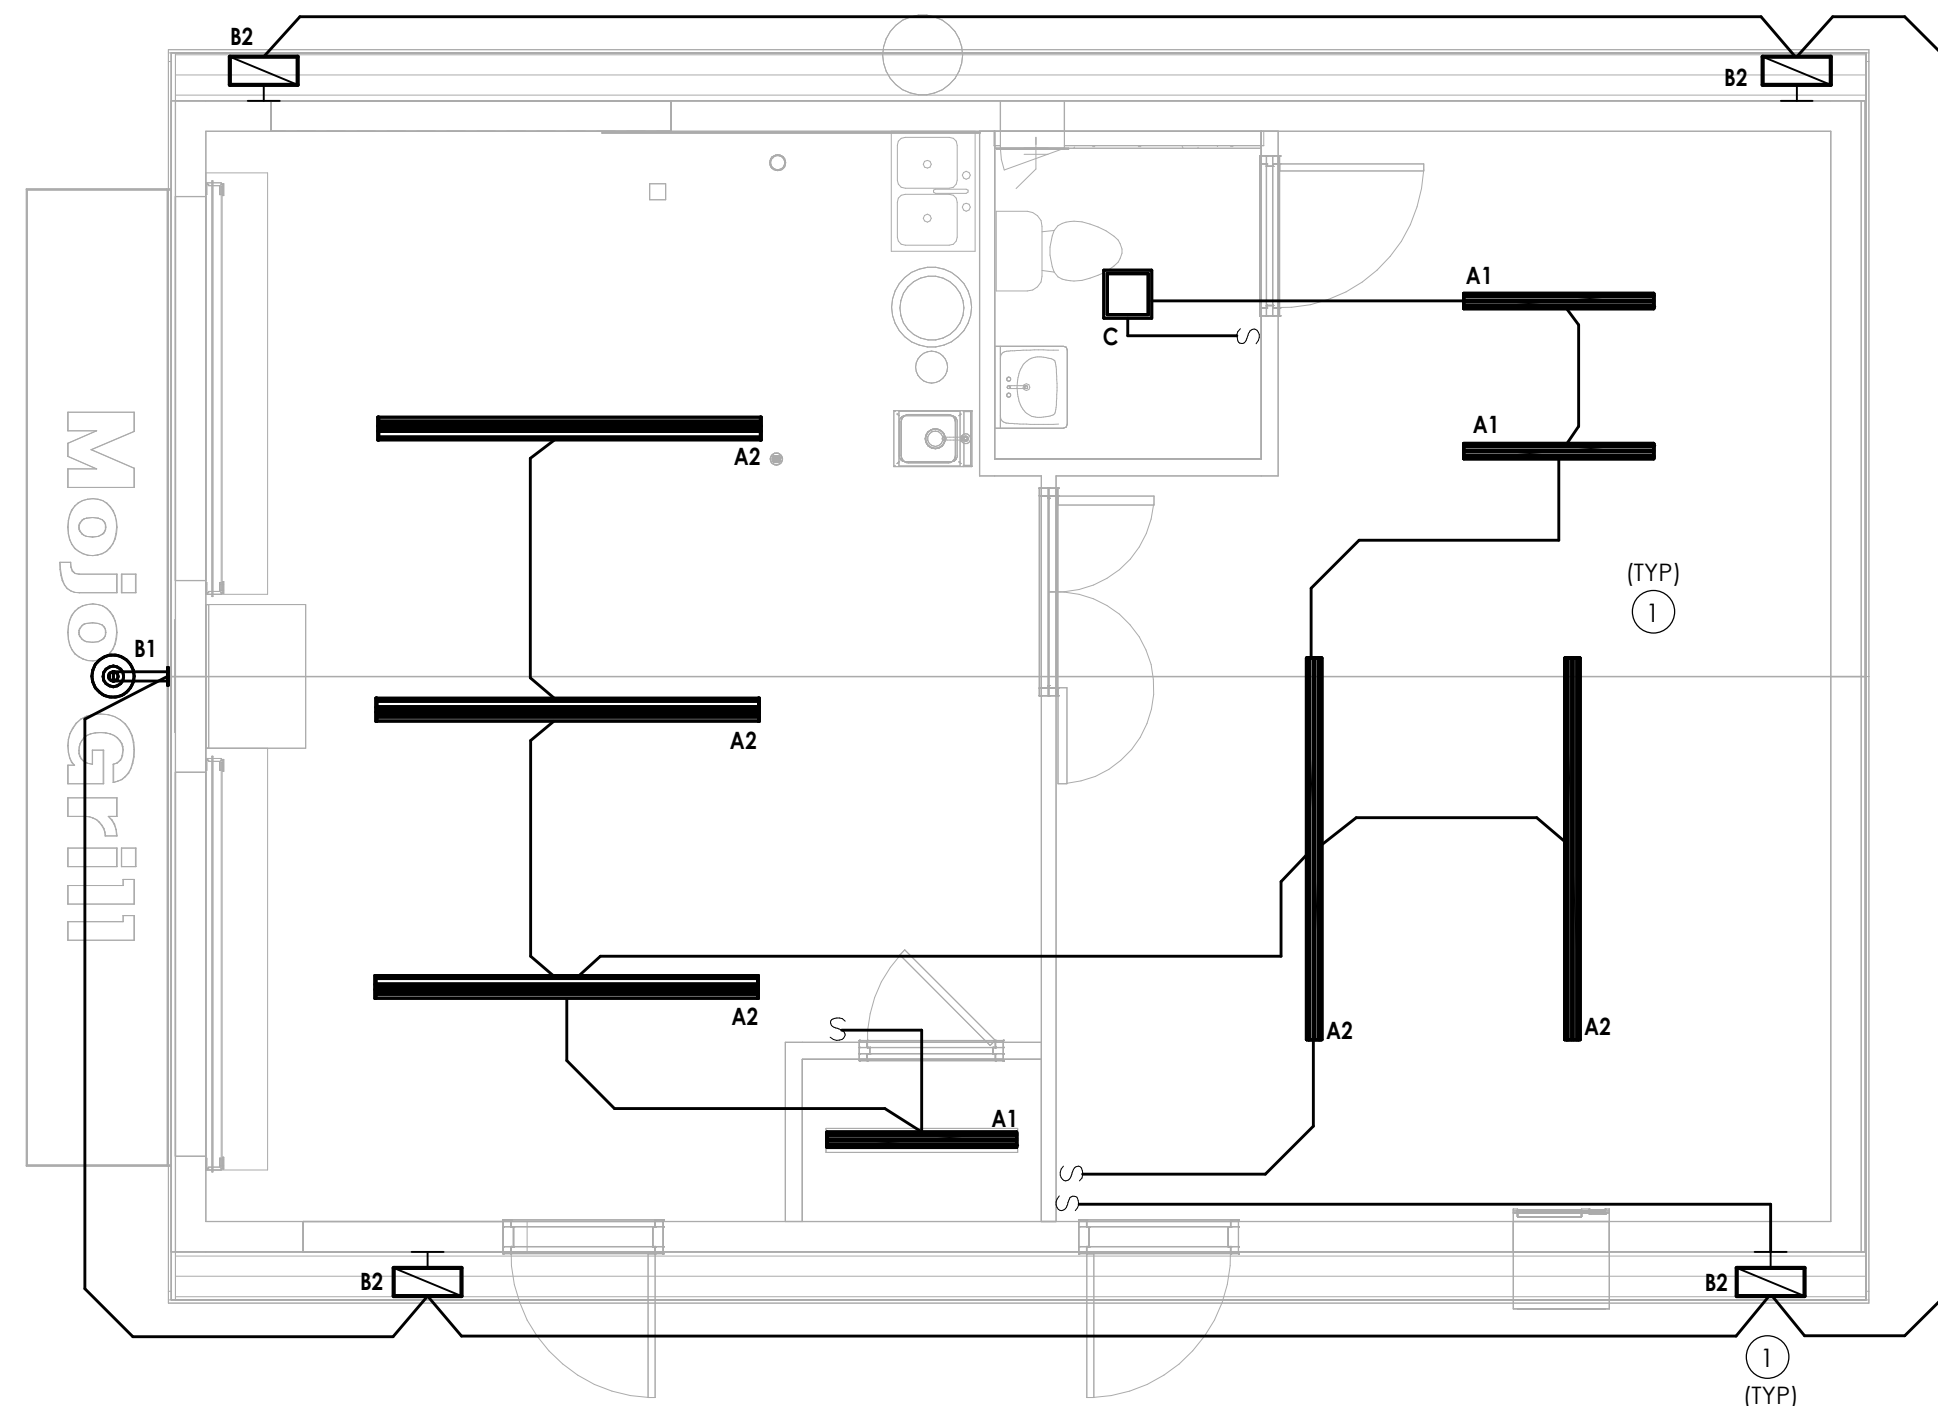


2 ALTERNATE BID CONCESSION STAND LIGHTING PLAN
 E301 1/4" = 1'-0"

TYPE	MANUFACTURER AND CATALOG NUMBER	LAMP		DRIVER		INPUT WATTS	INPUT VOLTS	MOUNTING	DESCRIPTION
		TYPE	LUMENS	NO.	TYPE				
A1	LCL-4'-35-HL-ED-U 4-OC1-LED-3000L-DIM10-MVOLT-35K-85 ZL1D-L48-3000LM-FST-MVOLT-35K-80CRI	LED 3500K	3000	1	0-10V DIMMING DRIVER	30	MVOLT	SURFACE	4' LONG LED STRIP LIGHT, WHITE FINISH.
A2	LCL-8'-35-HL-ED-U 6-OC1-LED-6000L-DIM10-MVOLT-35K-85 ZL1D-L48-3000LM-FST-MVOLT-35K-80CRI	LED 3500K	6000	1	0-10V DIMMING DRIVER	45	MVOLT	SURFACE	8' LONG LED STRIP LIGHT, WHITE FINISH.
B1	LITHONIA - BGR-ALO-SWW-MVOLT-PER-DNA-OMA COOPER - ALB-4A-40-GY EXO - SGD-60-LSCS-GR-ARM-DD24	LED 4000K	6000	1	0-10V DIMMING DRIVER	60	MVOLT	ARM MOUNT	ARM MOUNTED AREA LIGHT, ADJUSTABLE OUTPUT, PHOTOCELL CONTROL.
B2	Lithonia - TWX2-LED-ALO-40K-MVOLT-DDBTXD EXO - PVL5-180L-60-4K7-BLT-8F ORACLE - OWP-NC-201-LED-6000L-MVOLT-40K-BZ-WPPHC	LED 4000K	6000	1	0-10V DIMMING DRIVER	54	MVOLT	WALL MOUNT 8'-0"	WALL MOUNTED AREA LIGHT, BRONZE FINISH, PHOTOCELL CONTROL.
C	LIGHTWAY - CSLC-11-LED-F10-3-W2-WSA ELITE - ECH-CL-LED-1011 LITHONIA - FMLSL 11 148	LED 3500K	2000	1	0-10V DIMMING DRIVER	13	MVOLT	SURFACE	11" BY 11" SQUARE LED LIGHT, WHITE FINISH.

LUMINAIRE SCHEDULE NOTES:
 1. VERIFY LUMINAIRE FINISH COLOR WITH ARCHITECT AND OWNER.
 2. COORDINATE MOUNTING WITH CEILING TYPE.
 3. INTERIOR LEDs SHALL BE CRI 80, MINIMUM, AND L70 MINIMUM. EXTERIOR LEDs CRI 70 MINIMUM.
 4. DRIVERS TO BE STANDARD 0-10V DIMMING UNLESS NOTED OTHERWISE.
 5. PROVIDE ALL NECESSARY SUPPORT HARDWARE AND ADAPTERS FOR EACH LUMINAIRE.
 6. POST-PAINT ALL LUMINAIRES AT FACTORY.

ABBREVIATIONS:
 DIM = DIMMING DRIVER
 CRI = COLOR RENDERING INDEX
 LED = LIGHT EMITTING DIODE
 CCT = COLOR CORRELATION TEMPERATURE

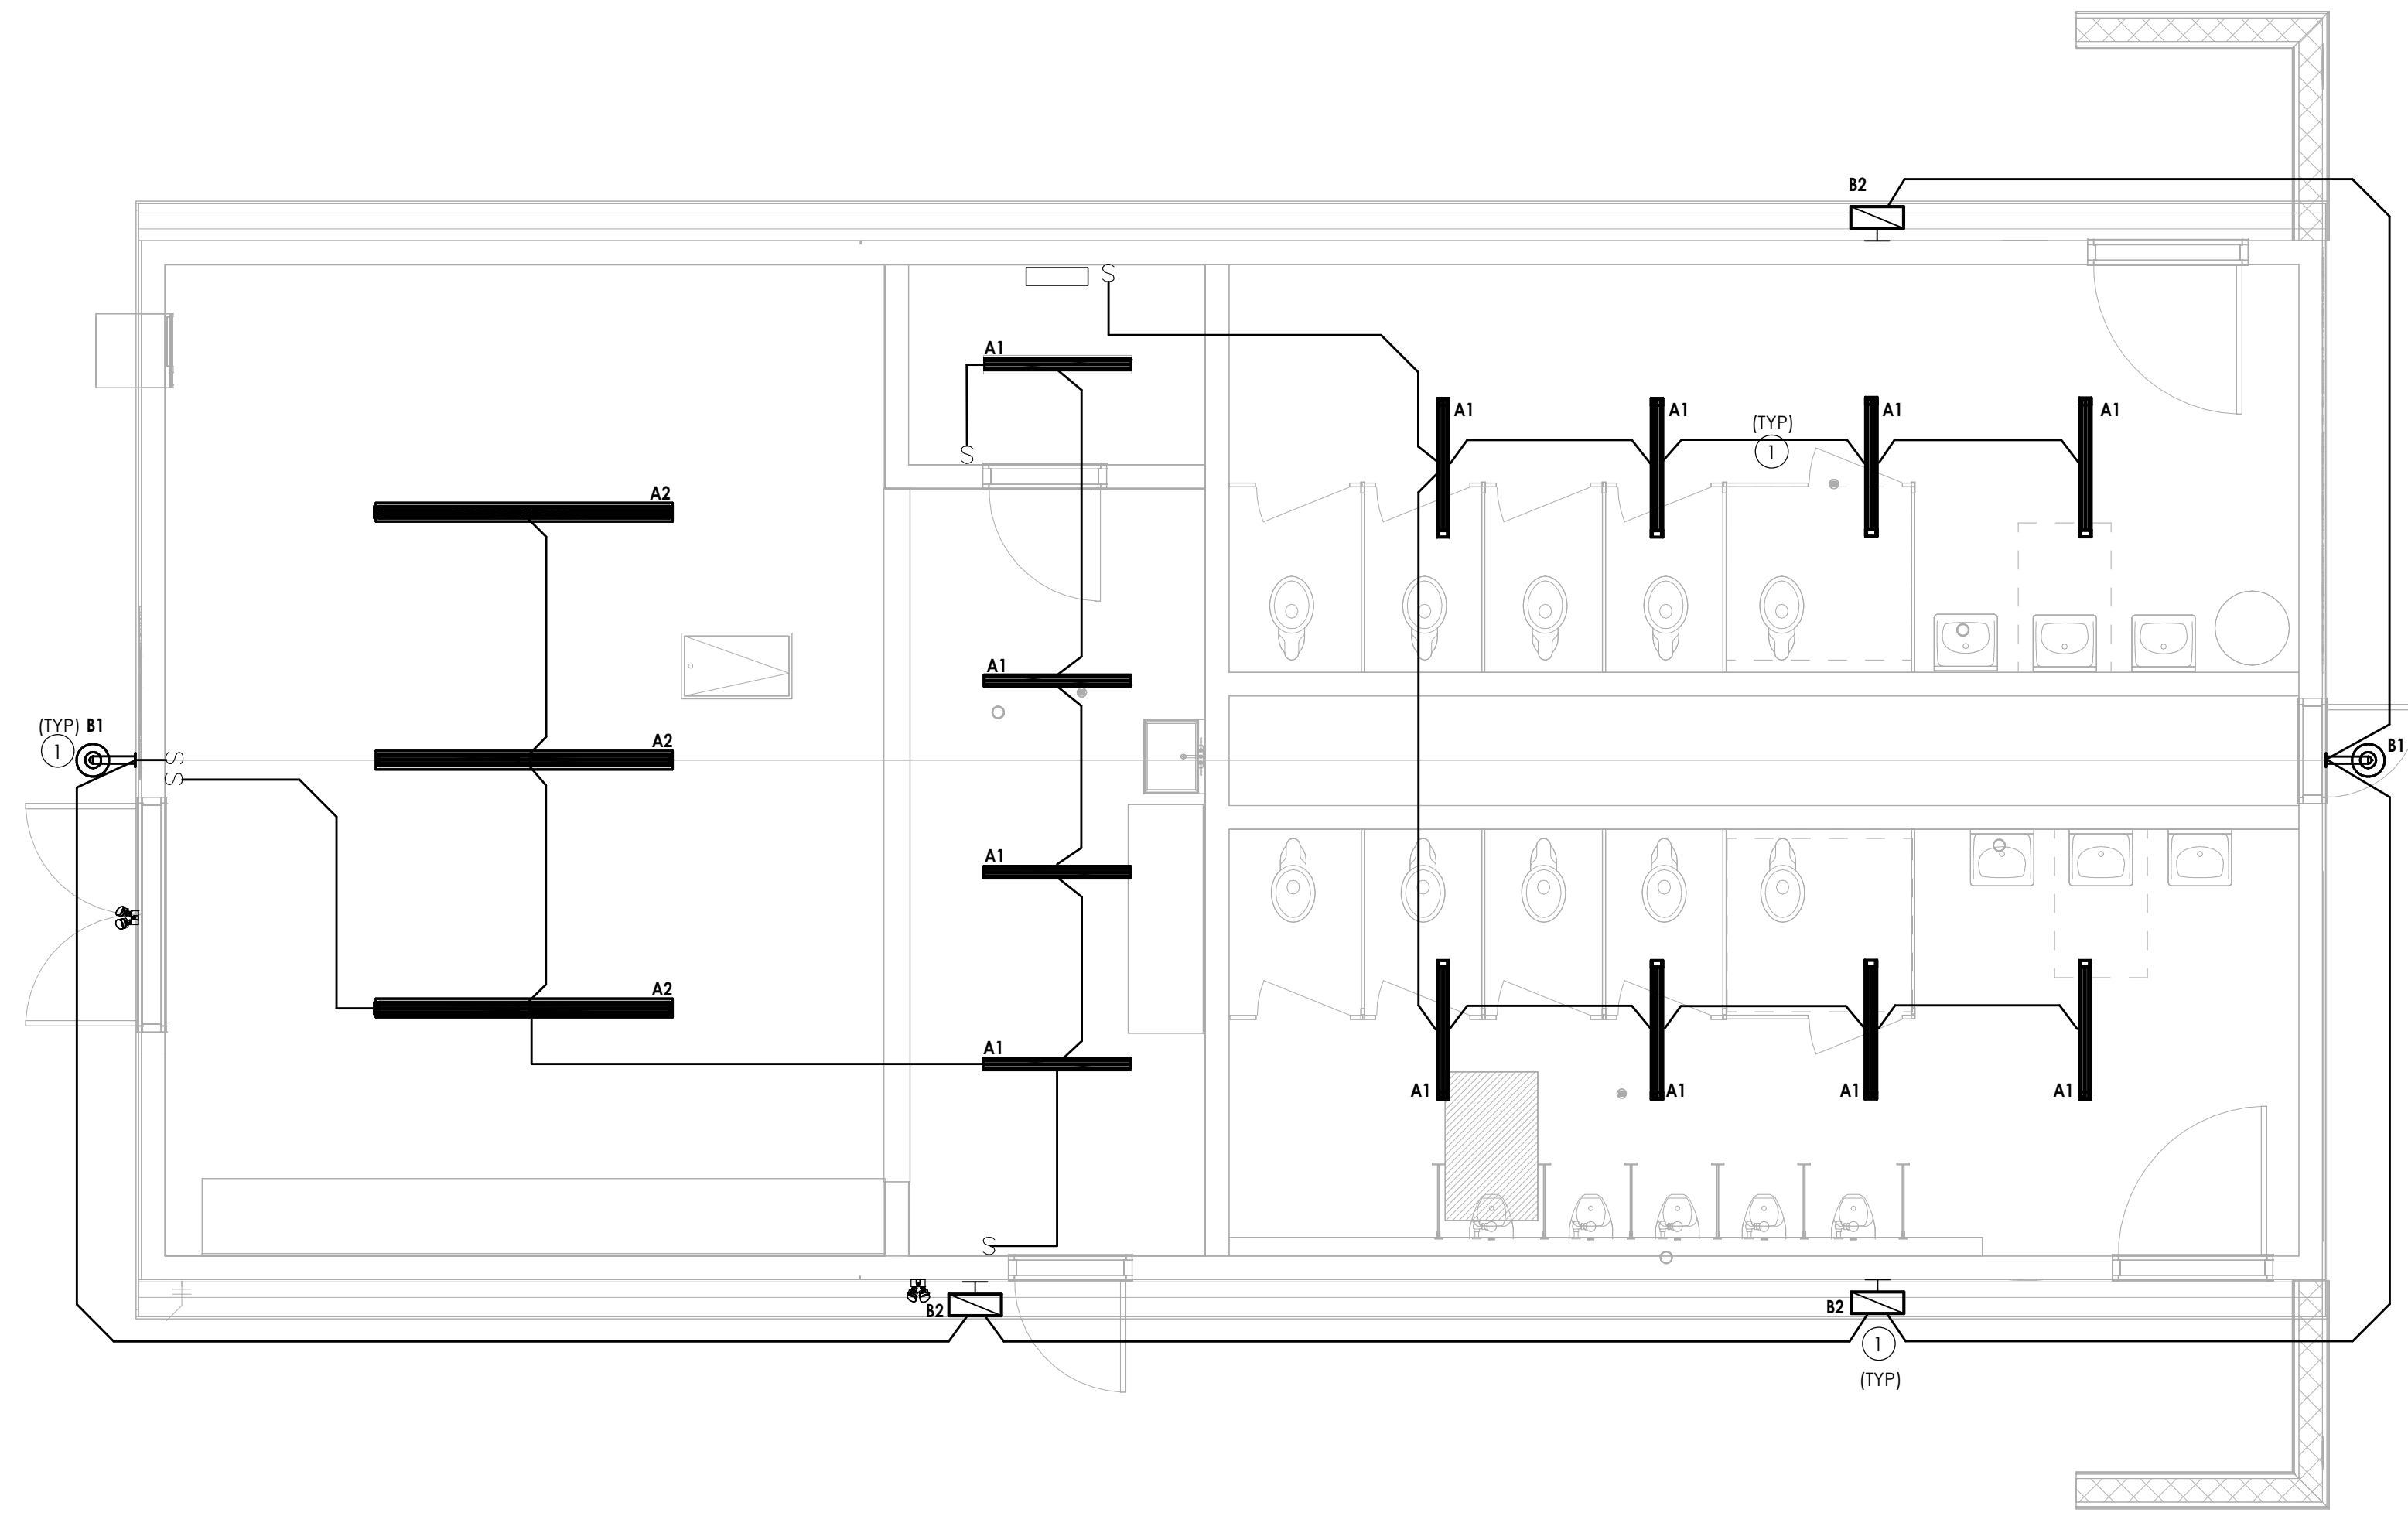

1 ALTERNATE BID BATHROOM LIGHTING PLAN
 E301 1/4" = 1'-0"



PROJECT INFORMATION
 Project Number: R22.16900.00
 Client Name: WILSON COUNTY SCHOOLS
 Project Name: HUNT HS - ATHLETICS RENOVATION
 HUNT HIGH SCHOOL
 Project Address: 4559 Lamm Rd, Wilson, NC 27893

PROJECT ISSUE & REVISION SCHEDULE
 No. Date Description

PROFESSIONAL STAMPS



SHEET INFORMATION
 Issued: 09/15/2023 Scale: As indicated
 Project Status: CONSTRUCTION DOCUMENTS
 Drawn By: KSF Checked By: MSR
 Drawing Title: LIGHTING PLAN

Drawing Number