



COVER

6041-B\ CLO .AEC

COMM. NO. **6041-B** DRAWN BY WBP CHECKED BY AWS

DATE **APRIL 2, 2024** SHEET NO. C1.0

HOUSING AUTHORITY of the CITY OF GOLDSBORO RENOVATIONS — FAIRVIEW APARTMENTS NC 15-1 FAIRVIEW CIRCLE & NC 15-3 EDGERTON ST. NORTH CAROLINA GOLDSBORO,

1			4
		PROJECT INFORMATION	
	INDEX OF	DRAWINGS	SCOPE OF WORK
	DWG NO DRAWING TITLE	DWG NO DRAWING TITLE	THE WORK SHALL CONSIST OF THE FOLLOWING ITEMS AND ALL OTHER WORK AS SHOWN ON THE PLANS AND IN THE PROJECT MANUAL.
A	C1.0 COVER C1.1 PROJECT INFORMATION, SCOPE OF WORK, INDEX OF DRAWINGS, LEGEND S1.0 SITE PLAN — FAIRVIEW CIRCLE; NC 15—1 S1.0A ENLARGED SITE PLAN — FAIRVIEW CIRCLE; NC 15—1 S1.0B ENLARGED SITE PLAN — FAIRVIEW CIRCLE; NC 15—1 S1.0C ENLARGED SITE PLAN — FAIRVIEW CIRCLE; NC 15—1	A10.0 BLDG. "C-A" & "C", KEY PLAN - ROOF PLAN, WINDOW LOCATIONS; NC 15-3  A11.0 DEMOLITION FLOOR PLAN, ONE BEDROOM UNIT - BUILDING TYPE "A"; NC 15-3  A11.1 RENOVATION FLOOR PLAN, ONE BEDROOM UNIT - BUILDING TYPE "A"; NC 15-3  A11.2 BASIC FRONT ELEVATION, ONE BEDROOM UNIT - BUILDING TYPE "A"; NC 15-3  A11.3 REVISED PORCH/ROOF PLAN, FRONT ELEVATION, ONE BEDROOM UNIT - BUILDING TYPE "A"; NC 15-3	<ol> <li>PROVIDE ALL LABOR, MATERIALS AND EQUIPMENT REQUIRED TO RENOVATE EXISTING APARTMENT UNITS.</li> <li>PROVIDE ALL LABOR, MATERIALS AND EQUIPMENT REQUIRED TO PROVIDE ALL SITE WORK AS SHOWN ON THE PLANS.</li> <li>PROVIDE ALL OTHER WORK AS SHOWN ON PLANS, IN THE PROJECT MANUAL AND AS REQUIRED BY CODES.</li> </ol>
	S1.0D ENLARGED SITE PLAN — FAIRVIEW CIRCLE; NC 15—1 S1.0E ENLARGED SITE PLAN — FAIRVIEW CIRCLE; NC 15—1 S1.1 SITE PLAN — FAIRVIEW CIRCLE; NC 15—3 S1.1A ENLARGED SITE PLAN — FAIRVIEW CIRCLE; NC 15—3 S2.0 ENLARGED SITE PLAN — FAIRVIEW CIRCLE; NC 15—1 & NC 15—3 S2.1 ENLARGED SITE PLAN — FAIRVIEW CIRCLE; NC 15—1 S2.2 SITE DETAILS — FAIRVIEW CIRCLE; NC 15—1	A12.0 DEMOLITION FLOOR PLAN, THREE BEDROOM UNIT — BUILDING TYPE "C"; NC 15—3 A12.1 RENOVATION FLOOR PLAN, THREE BEDROOM UNIT — BUILDING TYPE "C"; NC 15—3 A12.2 DEMOLITION/RENOVATION FLOOR PLAN, THREE BEDROOM HANDICAP UNIT — BUILDING TYPE "C"; NC 15—3 A12.3 BASIC FRONT ELEVATION, THREE BEDROOM UNIT — BUILDING TYPE "C"; NC 15—3 A12.4 ALTERNATE #1 FRONT ELEVATION, THREE BEDROOM UNIT — BUILDING TYPE "C"; NC 15—3 A12.5 REVISED PORCH/ROOF PLAN, FRONT ELEVATION, THREE BEDROOM UNIT — BUILDING TYPE "C"; NC 15—3 A14.0 BATHROOM ELEVATIONS, ONE BEDROOM UNIT; NC 15—3 A14.1 BATHROOM ELEVATIONS, THREE BEDROOM UNIT; NC 15—3 A14.2 BATHROOM ELEVATIONS, THREE BEDROOM HANDICAP UNIT; NC 15—3 A15.0 CABINET ELEVATIONS, ONE BEDROOM UNIT; NC 15—3	DRAWING NUMBER  A201  DETAIL/PLAN NUMBER (01 IN THIS CASE)  SHEET NUMBER (A2 IN THIS CASE)
	A1.0 BLDG. #1, KEY PLAN — ROOF PLAN, WINDOW LOCATIONS; NC 15—1 A1.1 BLDG. #2 & #3, KEY PLAN — ROOF PLAN, WINDOW LOCATIONS; NC 15—1 A1.2 BLDG. #4 & #5, KEY PLAN — ROOF PLAN, WINDOW LOCATIONS; NC 15—1	A15.1 CABINET ELEVATIONS, THREE BEDROOM UNIT & THREE BEDROOM HANDICAP UNIT; NC 15–3  PLUMBING  ELECTRICAL	KEYNOTE 5———
B S S S S S S S S S S S S S S S S S S S	A1.3 BLDG. #6 & #7, KEY PLAN — ROOF PLAN, WINDOW LOCATIONS; NC 15—1 A1.4 BLDG. #8 & #9, KEY PLAN — ROOF PLAN, WINDOW LOCATIONS; NC 15—1 A1.5 BLDG. #14, KEY PLAN — ROOF PLAN, WINDOW LOCATIONS; NC 15—1 A1.6 BLDG. #15, KEY PLAN — ROOF PLAN, WINDOW LOCATIONS; NC 15—1 A1.7 ROOF DETAILS  A2.0 DEMOLITION FLOOR PLAN, TWO BEDROOM UNIT — BUILDING TYPE "C"; NC 15—1 A2.1 RENOVATION FLOOR PLAN, TWO BEDROOM UNIT — BUILDING TYPE "C"; NC 15—1 A2.2 DEMOLITION FLOOR PLAN, TWO BEDROOM HANDICAP UNIT — BUILDING TYPE "C"; NC 15—1	PO.O PLUMBING NOTES, LEGEND AND SCHEDULE P1.0 PLUMBING BUILDING 1 PLANS NC 15–1 P1.1 PLUMBING BUILDING 2 & 3 PLANS NC 15–1 P1.2 PLUMBING BUILDING 4 & 5 PLANS NC 15–1 P1.3 PLUMBING BUILDING 6 & 7 PLANS NC 15–1 P1.4 PLUMBING BUILDING 8 & 9 PLANS NC 15–1 P1.5 PLUMBING BUILDING 14 PLANS NC 15–1 P1.5 PLUMBING BUILDING 14 PLANS NC 15–1 P1.6 PLUMBING BUILDING 14 PLANS NC 15–1 E1.0 ELECTRICAL BUILDING 1 PLANS NC 15–1 E1.1 ELECTRICAL BUILDING 2 & 3 PLANS NC 15–1 E1.2 ELECTRICAL BUILDING 4 & 5 PLANS NC 15–1 E1.3 ELECTRICAL BUILDING 6 & 7 PLANS NC 15–1 E1.4 ELECTRICAL BUILDING 8 & 9 PLANS NC 15–1	N.I.C. NOT IN CONTRACT  GENERAL NOTES
	A2.3 RENOVATION FLOOR PLAN, TWO BEDROOM HANDICAP UNIT — BUILDING TYPE "C"; NC 15—1 A2.4 BASIC FRONT ELEVATION, TWO BEDROOM UNIT — BUILDING TYPE "C"; NC 15—1 A2.5 ALTERNATE #1 FRONT ELEVATION, TWO BEDROOM UNIT — BUILDING TYPE "C"; NC 15—1 A2.6 ALTERNATE #2 FRONT ELEVATION, TWO BEDROOM UNIT — BUILDING TYPE "C"; NC 15—1 A2.7 REAR ELEVATION, TWO BEDROOM HANDICAP UNIT — BUILDING TYPE "C"; NC 15—1 A2.8 REVISED PORCH/ROOF PLAN, FRONT ELEVATION, TWO BEDROOM UNIT — BUILDING TYPE "C"; NC 15—1	P1.6 PLUMBING BUILDING 15 PLANS NC 15–1 P2.0 PLUMBING UNIT PLANS NC 15–1 P2.1 PLUMBING UNIT PLANS NC 15–1 P3.0 PLUMBING UNIT PLANS NC 15–1 P3.1 PLUMBING UNIT PLANS NC 15–1 P4.0 PLUMBING UNIT PLANS NC 15–1 P4.0 PLUMBING UNIT PLANS NC 15–1 P5.1 E1.5 ELECTRICAL BUILDING 14 PLANS NC 15–1 E2.0 ELECTRICAL UNIT PLANS NC 15–1 E2.1 ELECTRICAL UNIT PLANS NC 15–1 E3.0 ELECTRICAL UNIT PLANS NC 15–1 E3.1 ELECTRICAL UNIT PLANS NC 15–1	GENERAL CONTRACTOR TO FIELD VERIFY ALL CONDITIONS AND DIMENSIONS PRIOR TO ORDERING MATERIALS OR BEGINNING WORK. NOTIFY ARCHITECT OF ANY INCONSISTENCIES.
	A3.0 DEMOLITION FLOOR PLAN, THREE BEDROOM UNIT — BUILDING TYPE "E"; NC 15—1 A3.1 RENOVATION FLOOR PLAN, THREE BEDROOM UNIT — BUILDING TYPE "E"; NC 15—1 A3.2 DEMOLITION/RENOVATION FLOOR PLAN, THREE BEDROOM UNIT — BUILDING TYPE "E"; NC 15—1 A3.3 BASIC FRONT ELEVATION, THREE BEDROOM UNIT — BUILDING TYPE "E"; NC 15—1 A3.4 ALTERNATE #1 FRONT ELEVATION, THREE BEDROOM UNIT — BUILDING TYPE "E"; NC 15—1 A3.5 REVISED PORCH/ROOF PLAN, FRONT ELEVATION, THREE BEDROOM UNIT — BUILDING TYPE "E"; NC 15—1	P4.1 PLUMBING UNIT PLANS NC 15–1 P10.0 PLUMBING BUILDING C & C-A PLANS NC 15–3 P11.0 PLUMBING UNIT PLANS NC 15–3 P12.0 PLUMBING UNIT PLANS NC 15–3 P12.1 PLUMBING UNIT PLANS NC 15–3 P12.1 PLUMBING UNIT PLANS NC 15–3 E4.0 ELECTRICAL UNIT PLANS NC 15–1 E4.1 ELECTRICAL UNIT PLANS NC 15–1 E10.0 ELECTRICAL UNIT PLANS NC 15–3 E11.0 ELECTRICAL UNIT PLANS NC 15–3 E12.0 ELECTRICAL UNIT PLANS NC 15–3	DRAWINGS ARE TO BE PRINTED AT 22 x 34 SIZE, ADJUST SCALE FOR HALF SIZE PRINTS
c	A4.0 DEMOLITION FLOOR PLAN, FOUR BEDROOM UNIT — BUILDING TYPE "F"; NC 15—1  A4.1 RENOVATION FLOOR PLAN, FOUR BEDROOM UNIT — BUILDING TYPE "F"; NC 15—1  A4.2 DEMOLITION/RENOVATION FLOOR PLAN, FOUR BEDROOM UNIT — BUILDING TYPE "F"; NC 15—1  A4.3 BASIC FRONT ELEVATION, FOUR BEDROOM UNIT — BUILDING TYPE "F"; NC 15—1  A4.4 ALTERNATE #1 FRONT ELEVATION, FOUR BEDROOM UNIT — BUILDING TYPE "F"; NC 15—1  A4.5 REVISED PORCH/ROOF PLAN, FRONT ELEVATION, FOUR BEDROOM UNIT — BUILDING TYPE "F"; NC 15—1  A5.0 PORCH ROOF DETAILS — BUILDING TYPE "C"; NC 15—3  A5.1 PORCH ROOF DETAILS — BUILDING TYPE "F"; NC 15—1  A5.2 PORCH ROOF DETAILS — BUILDING TYPE "F"; NC 15—1  A5.3 EXISTING/DEMO SECTION AT TYP. WINDOW; NC 15—1 & NC 15—3  A5.4 NEW/RENO SECTION AT TYP. WINDOW; NC 15—1 & NC 15—3  A5.4A EXISTING/DEMO SECTION AT WINDOW; NC 15—1 & NC 15—3  A5.4B NEW/RENO SECTION AT WINDOW; NC 15—1 & NC 15—3  A5.4C WINDOW DOOR ELEVATIONS, LEGEND & NOTES: NC 15—1 & NC 15—3	MECHANICAL  MO.0 MECHANICAL NOTES, SCHEDULE & LEGEND MO.1 MECHANICAL DETAILS M1.0 MECHANICAL BUILDING 1 PLANS NC 15–1 M1.1 MECHANICAL BUILDING 2 & 3 PLANS NC 15–1 M1.2 MECHANICAL BUILDING 6 & 7 PLANS NC 15–1 M1.3 MECHANICAL BUILDING 6 & 7 PLANS NC 15–1 M1.4 MECHANICAL BUILDING 8 & 9 PLANS NC 15–1 M1.5 MECHANICAL BUILDING 14 PLANS NC 15–1 M1.6 MECHANICAL BUILDING 15 PLANS NC 15–1 M2.0 MECHANICAL BUILDING 15 PLANS NC 15–1 M2.1 MECHANICAL UNIT PLANS NC 15–1 M3.0 MECHANICAL UNIT PLANS NC 15–1	E14.0 ELECTRICAL BUILDING RISER DIAGRAMS E14.1 ELECTRICAL BUILDING RISER DIAGRAMS E14.2 ELECTRICAL BUILDING RISER DIAGRAMS
	A5.5 TYPICAL EXTERIOR WALL SECTION; NC 15-1 & NC 15-3 A5.6 EXISTING/DEMO SECTION AT DOOR; NC 15-1 & NC 15-3 A5.6A NEW/RENO SECTION AT DOOR; NC 15-1 & NC 15-3 A5.7 MISCELLANEOUS DETAILS	M3.1 MECHANICAL UNIT PLANS NC 15–1  M4.0 MECHANICAL UNIT PLANS NC 15–1  M4.1 MECHANICAL UNIT PLANS NC 15–1	


MECHANICAL UNIT PLANS NC 15-3

MECHANICAL UNIT PLANS NC 15-3

MECHANICAL UNIT PLANS NC 15-3

MECHANICAL BUILDING C & C-A PLANS NC 15-3



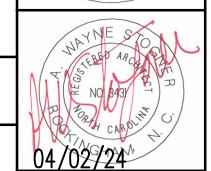

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Architecture,

Authority of of of of Goldsboro

- FAIRVIEW APARTMENTS

W CIRCLE & NC 15-3 EDGERTON S
NORTH CAROLINA

Housing

PROJECT INFORMATION, SCOPE OF WORK, INDEX OF DRAWINGS,

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C1.1


BATHROOM KEYNOTES, BATHROOM DETAILS; NC 15-1


CABINET DETAILS; NC 15-1 & NC 15-3
HANDICAP CABINET DETAILS; NC 15-1 & NC 15-3

BATHROOM ELEVATIONS, TWO BEDROOM UNIT; NC 15-1 BATHROOM ELEVATIONS, TWO BEDROOM HANDICAP UNIT; NC 15-1

BATHROOM ELEVATIONS, THREE BEDROOM UNIT & FOUR BEDROOM UNIT; NC 15-1 BATHROOM ELEVATIONS, FOUR BEDROOM UNIT; NC 15-1


CABINET KEYNOTES, CABINET ELEVATIONS, TWO BEDROOM UNIT & TWO BEDROOM HANDICAP UNIT; NC 15-1 CABINET ELEVATIONS, THREE BEDROOM UNIT & FOUR BEDROOM UNIT; NC 15-1

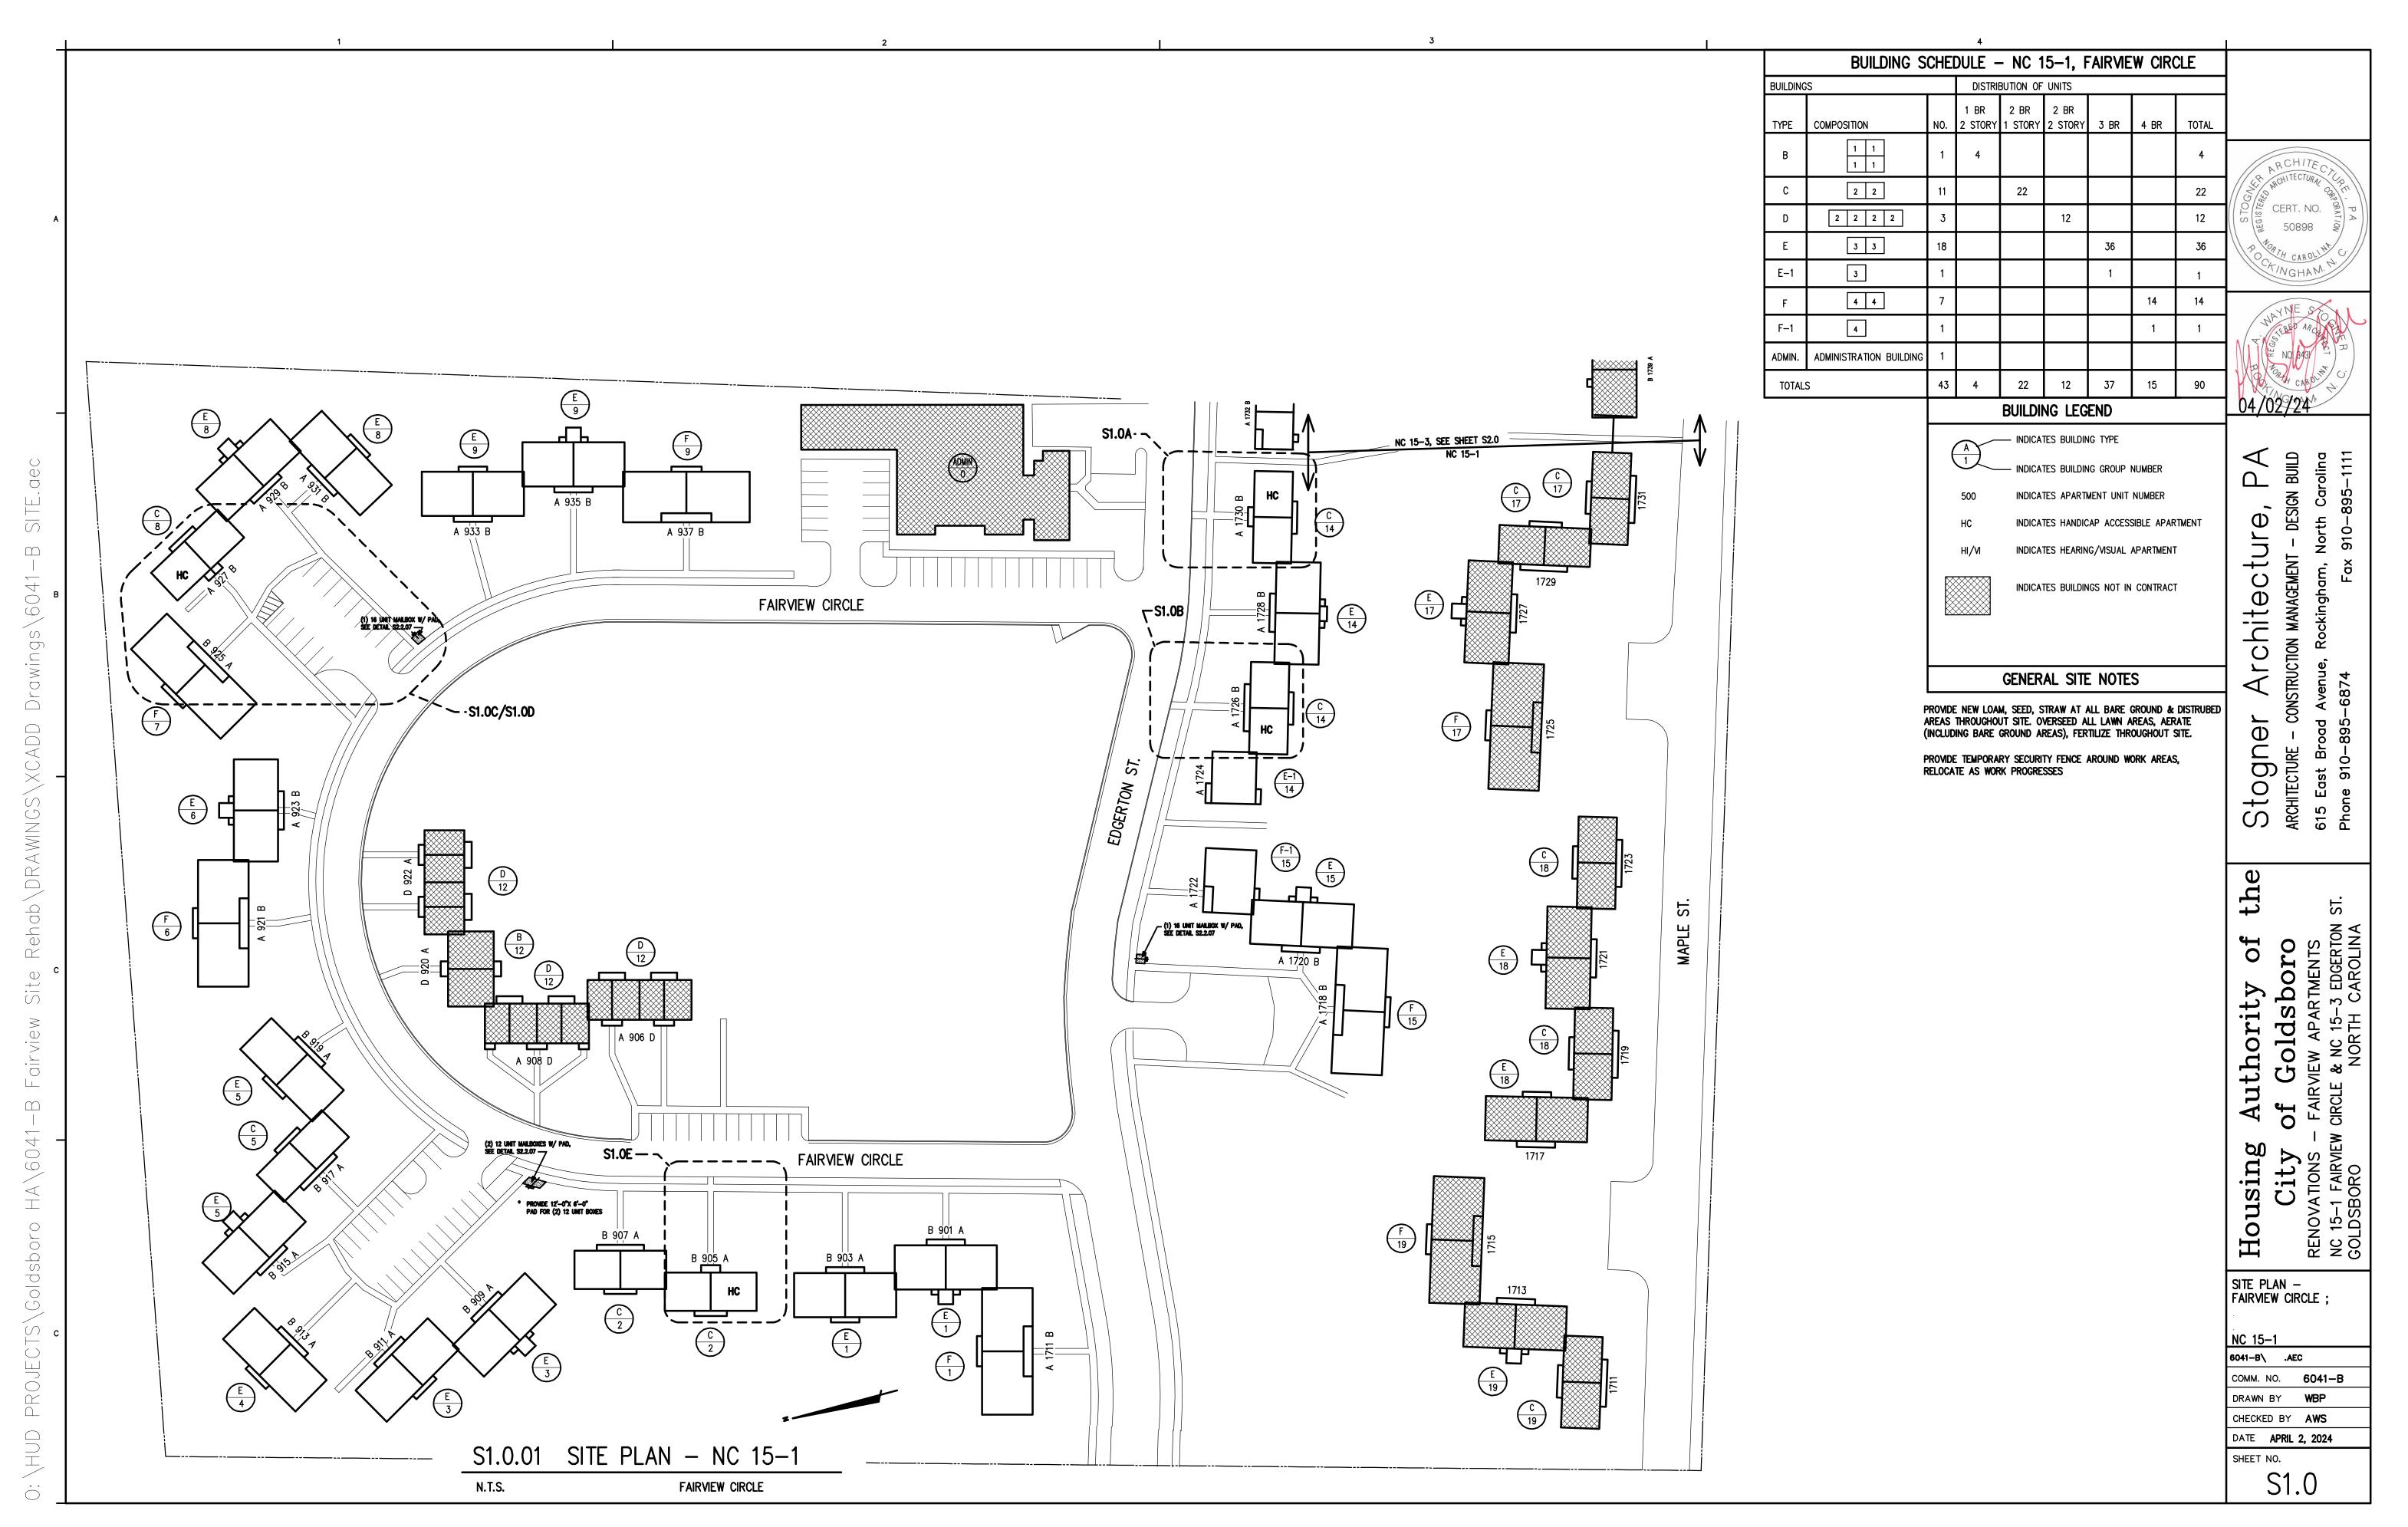

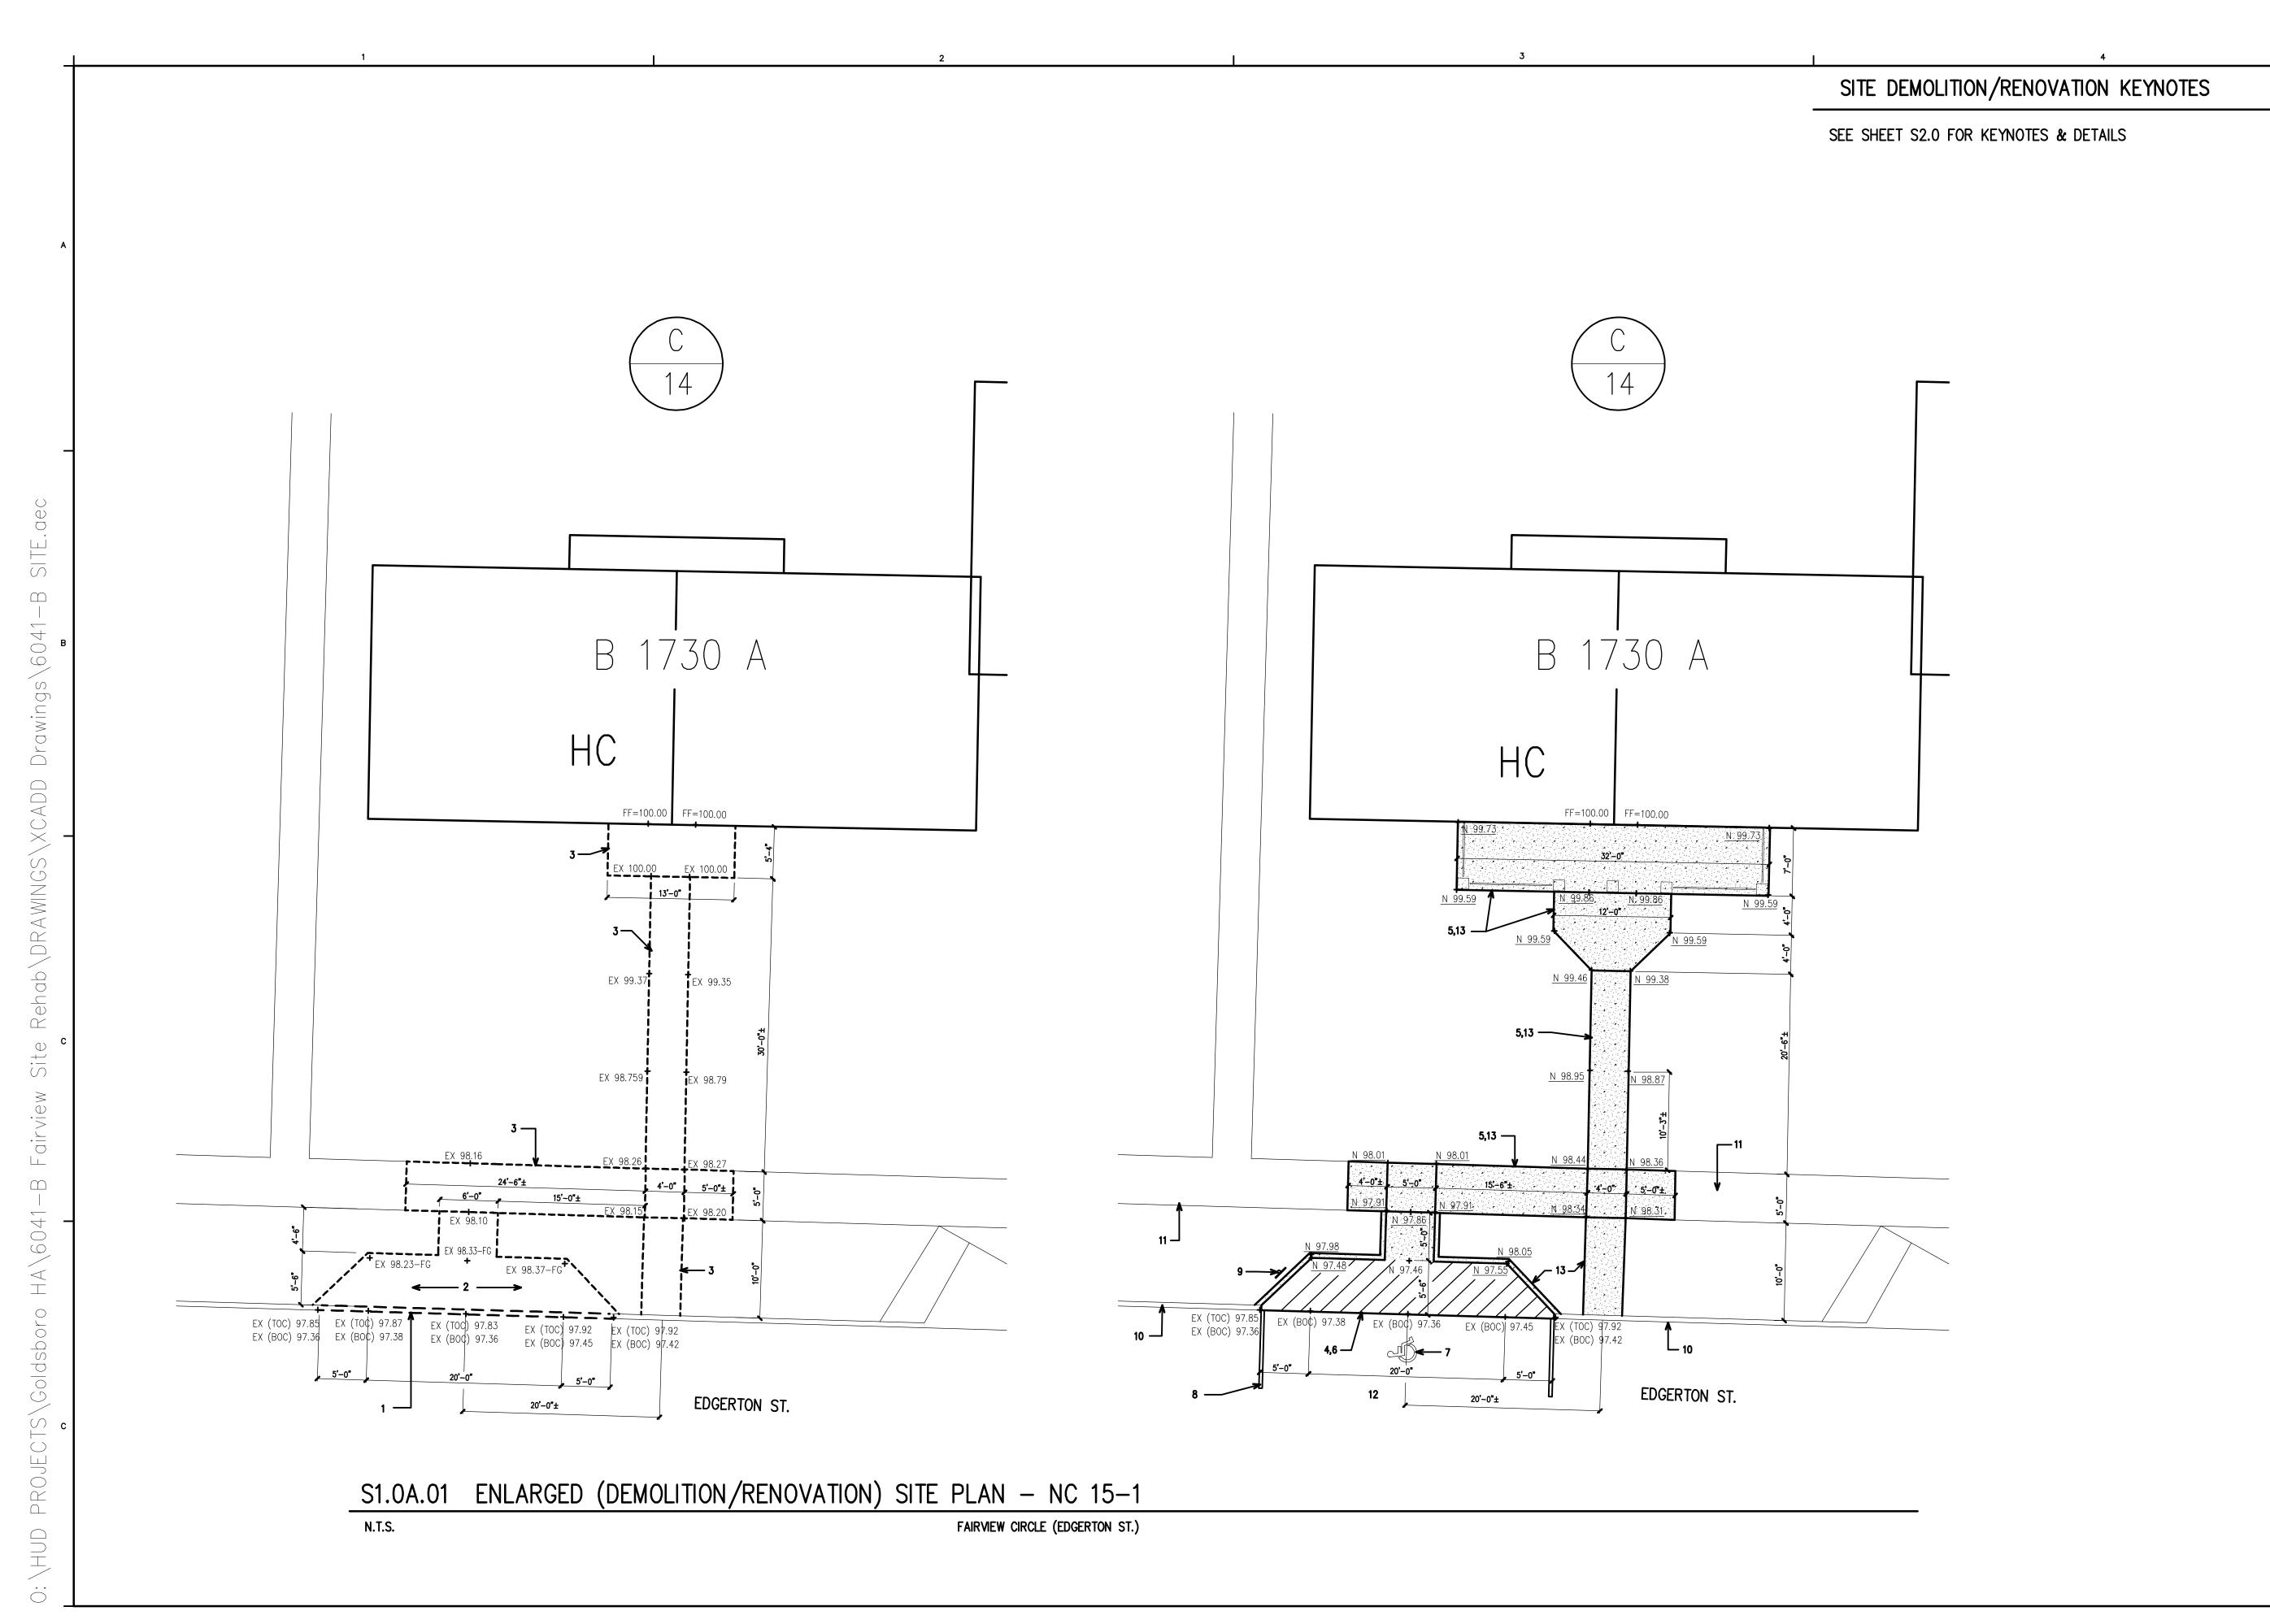





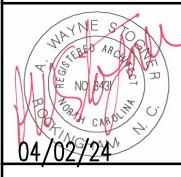



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615 East Broad A
Phone 910-895-


ENLARGED SITE PLAN -FAIRVIEW CIRCLE ;

NC 15-1 6041-B\ .AEC COMM. NO. **6041-B** DRAWN BY WBP CHECKED BY AWS DATE APRIL 2, 2024 SHEET NO.


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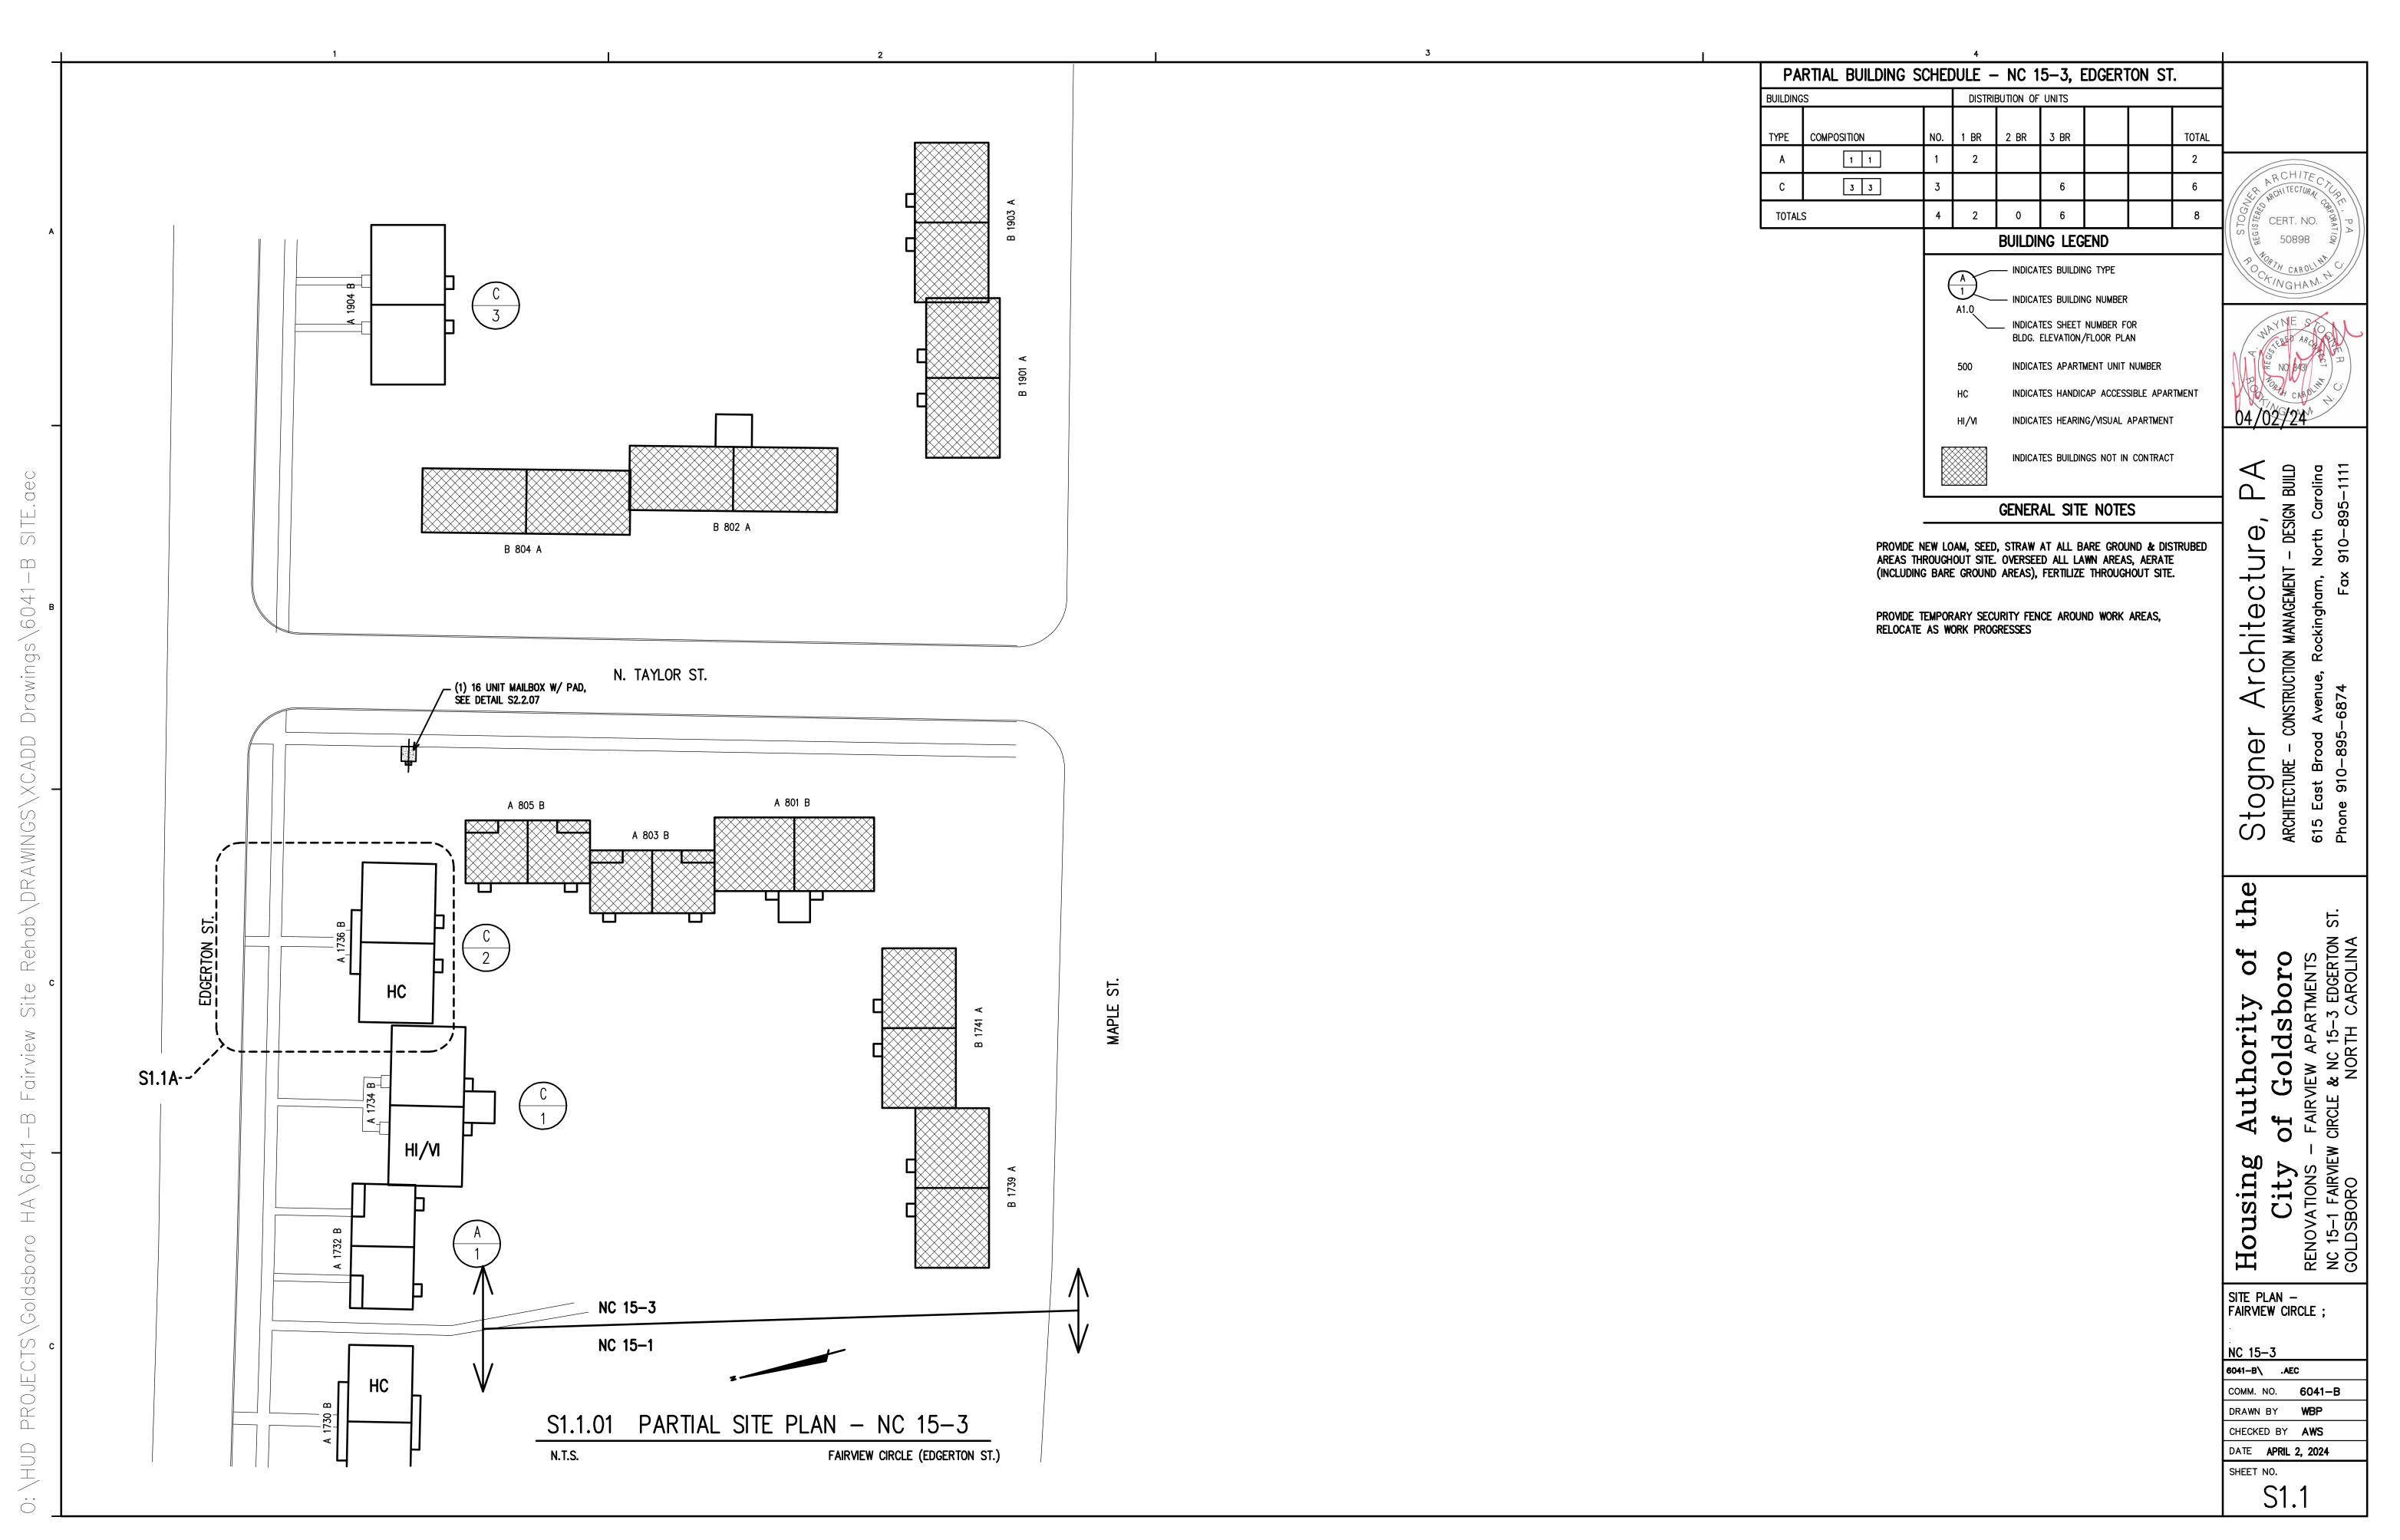
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Phone 910-895-

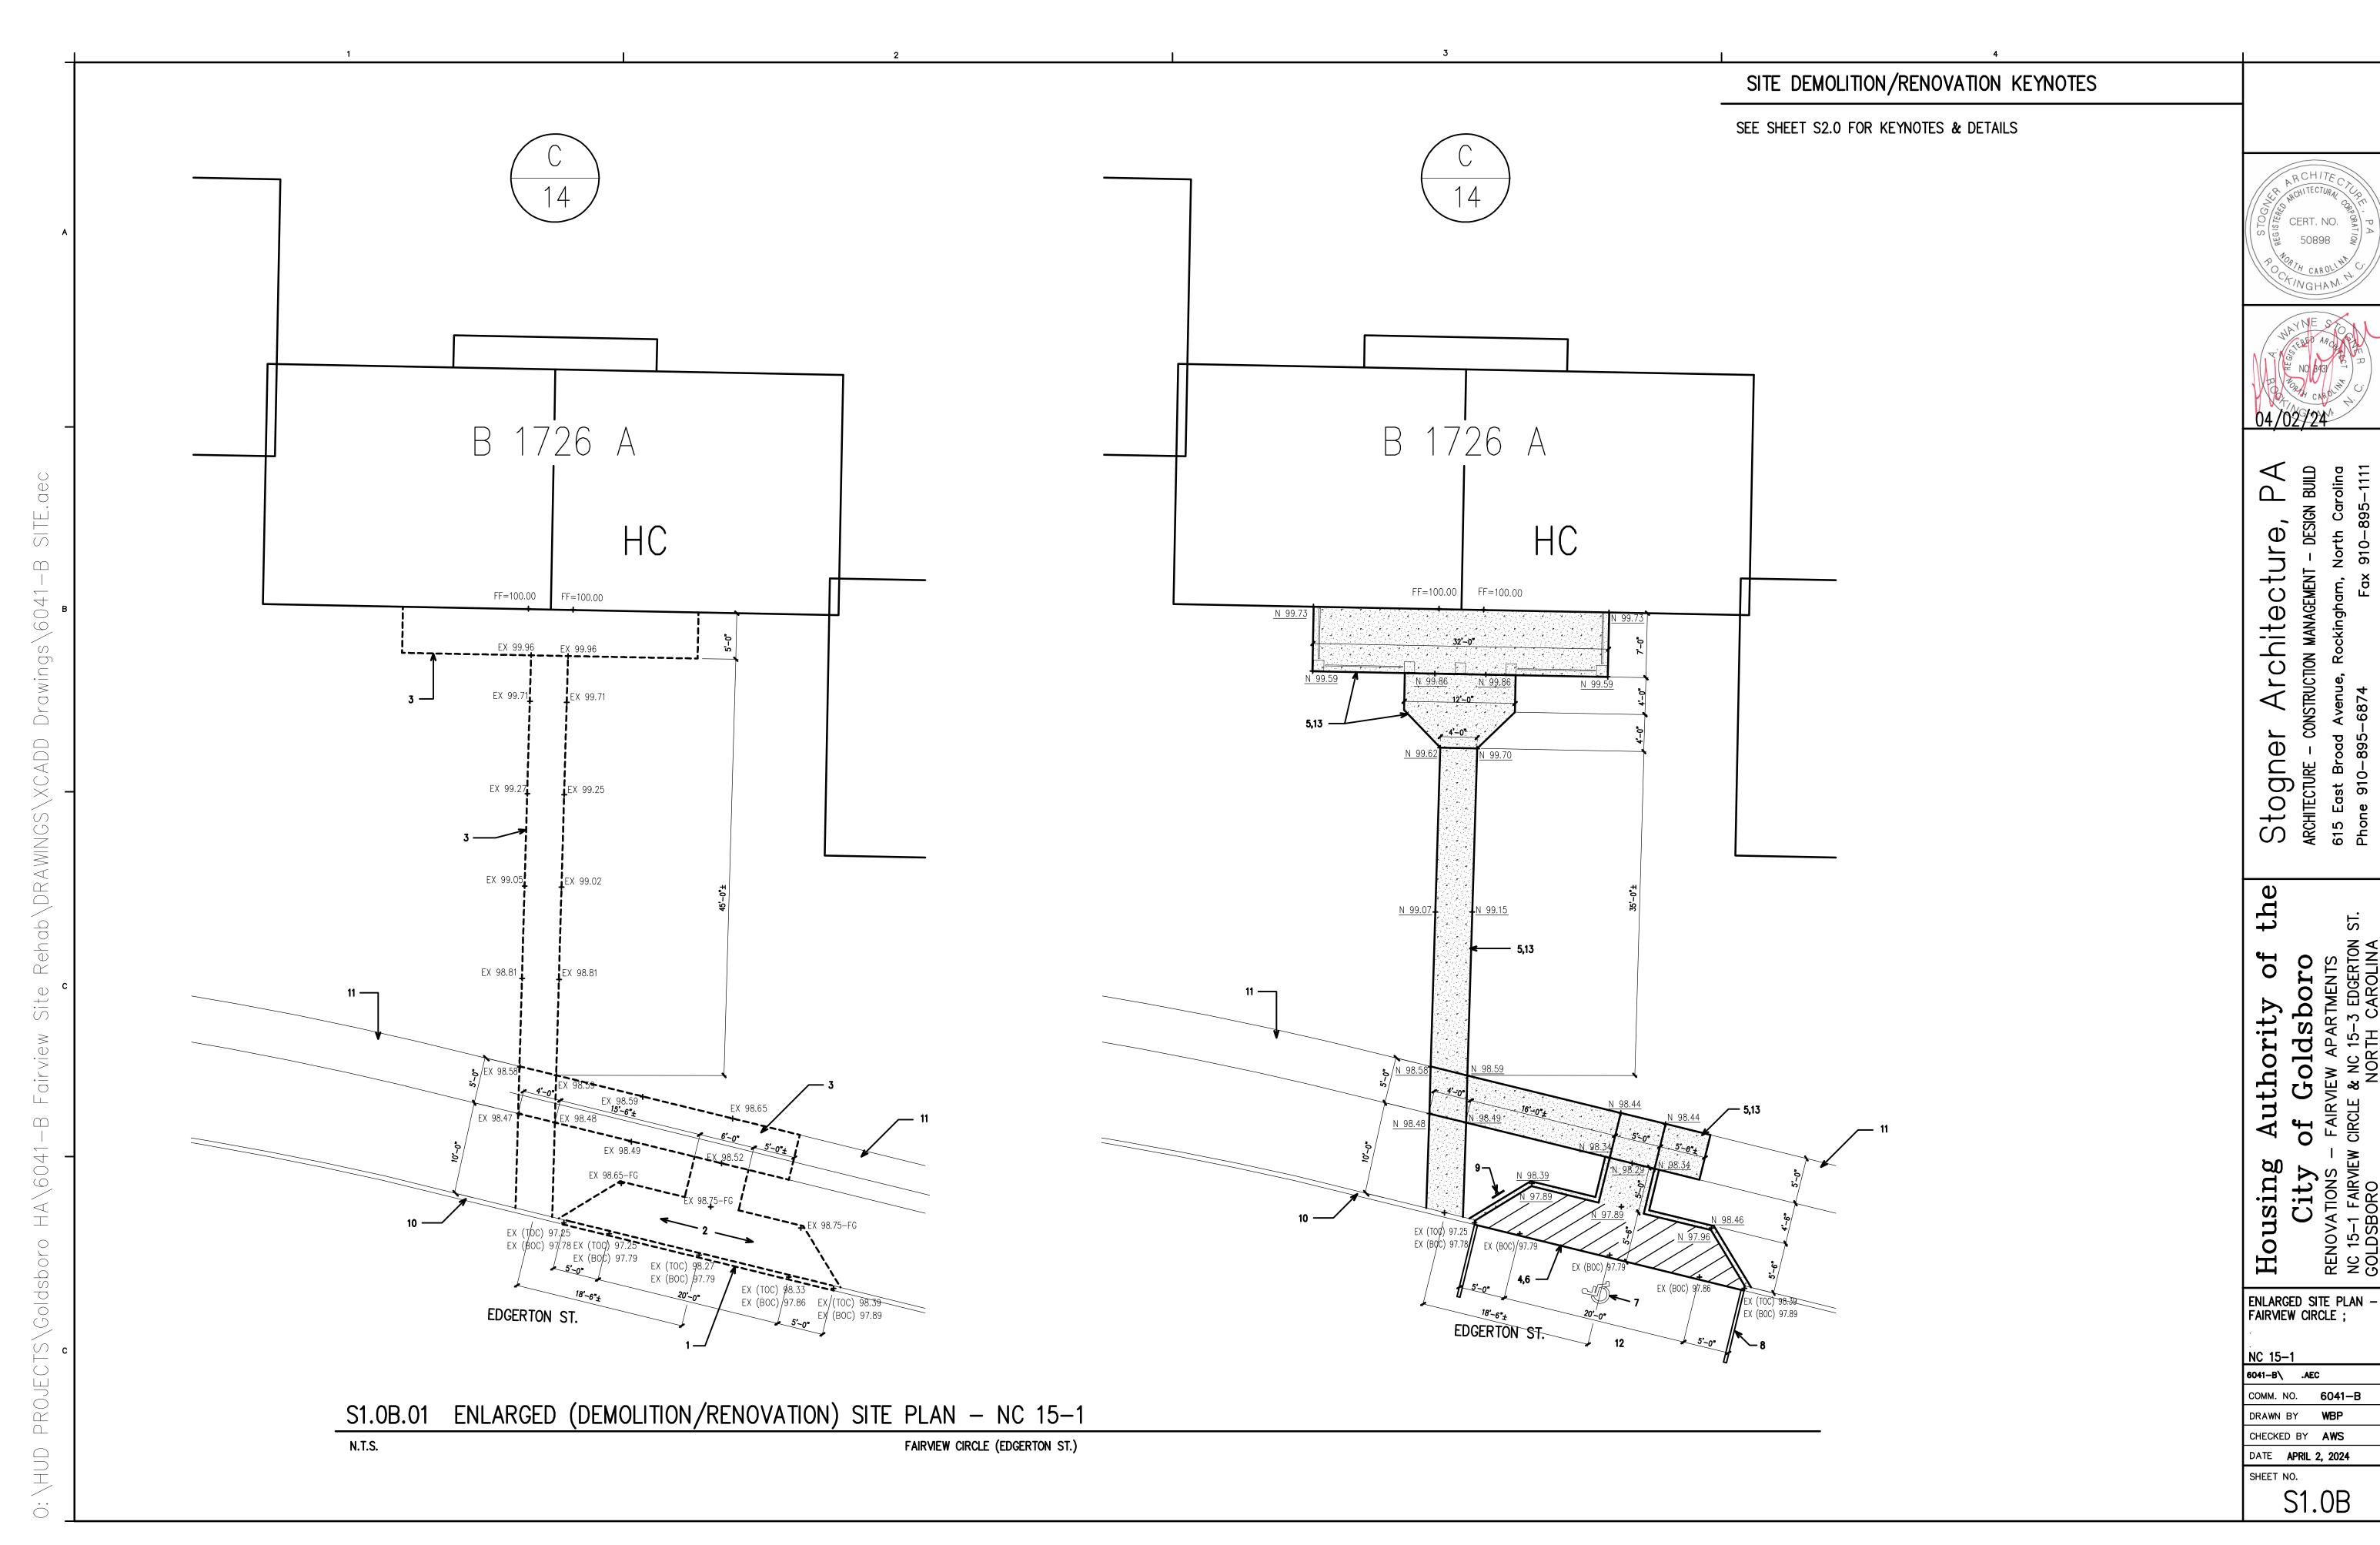
ENLARGED SITE PLAN -FAIRVIEW CIRCLE ;
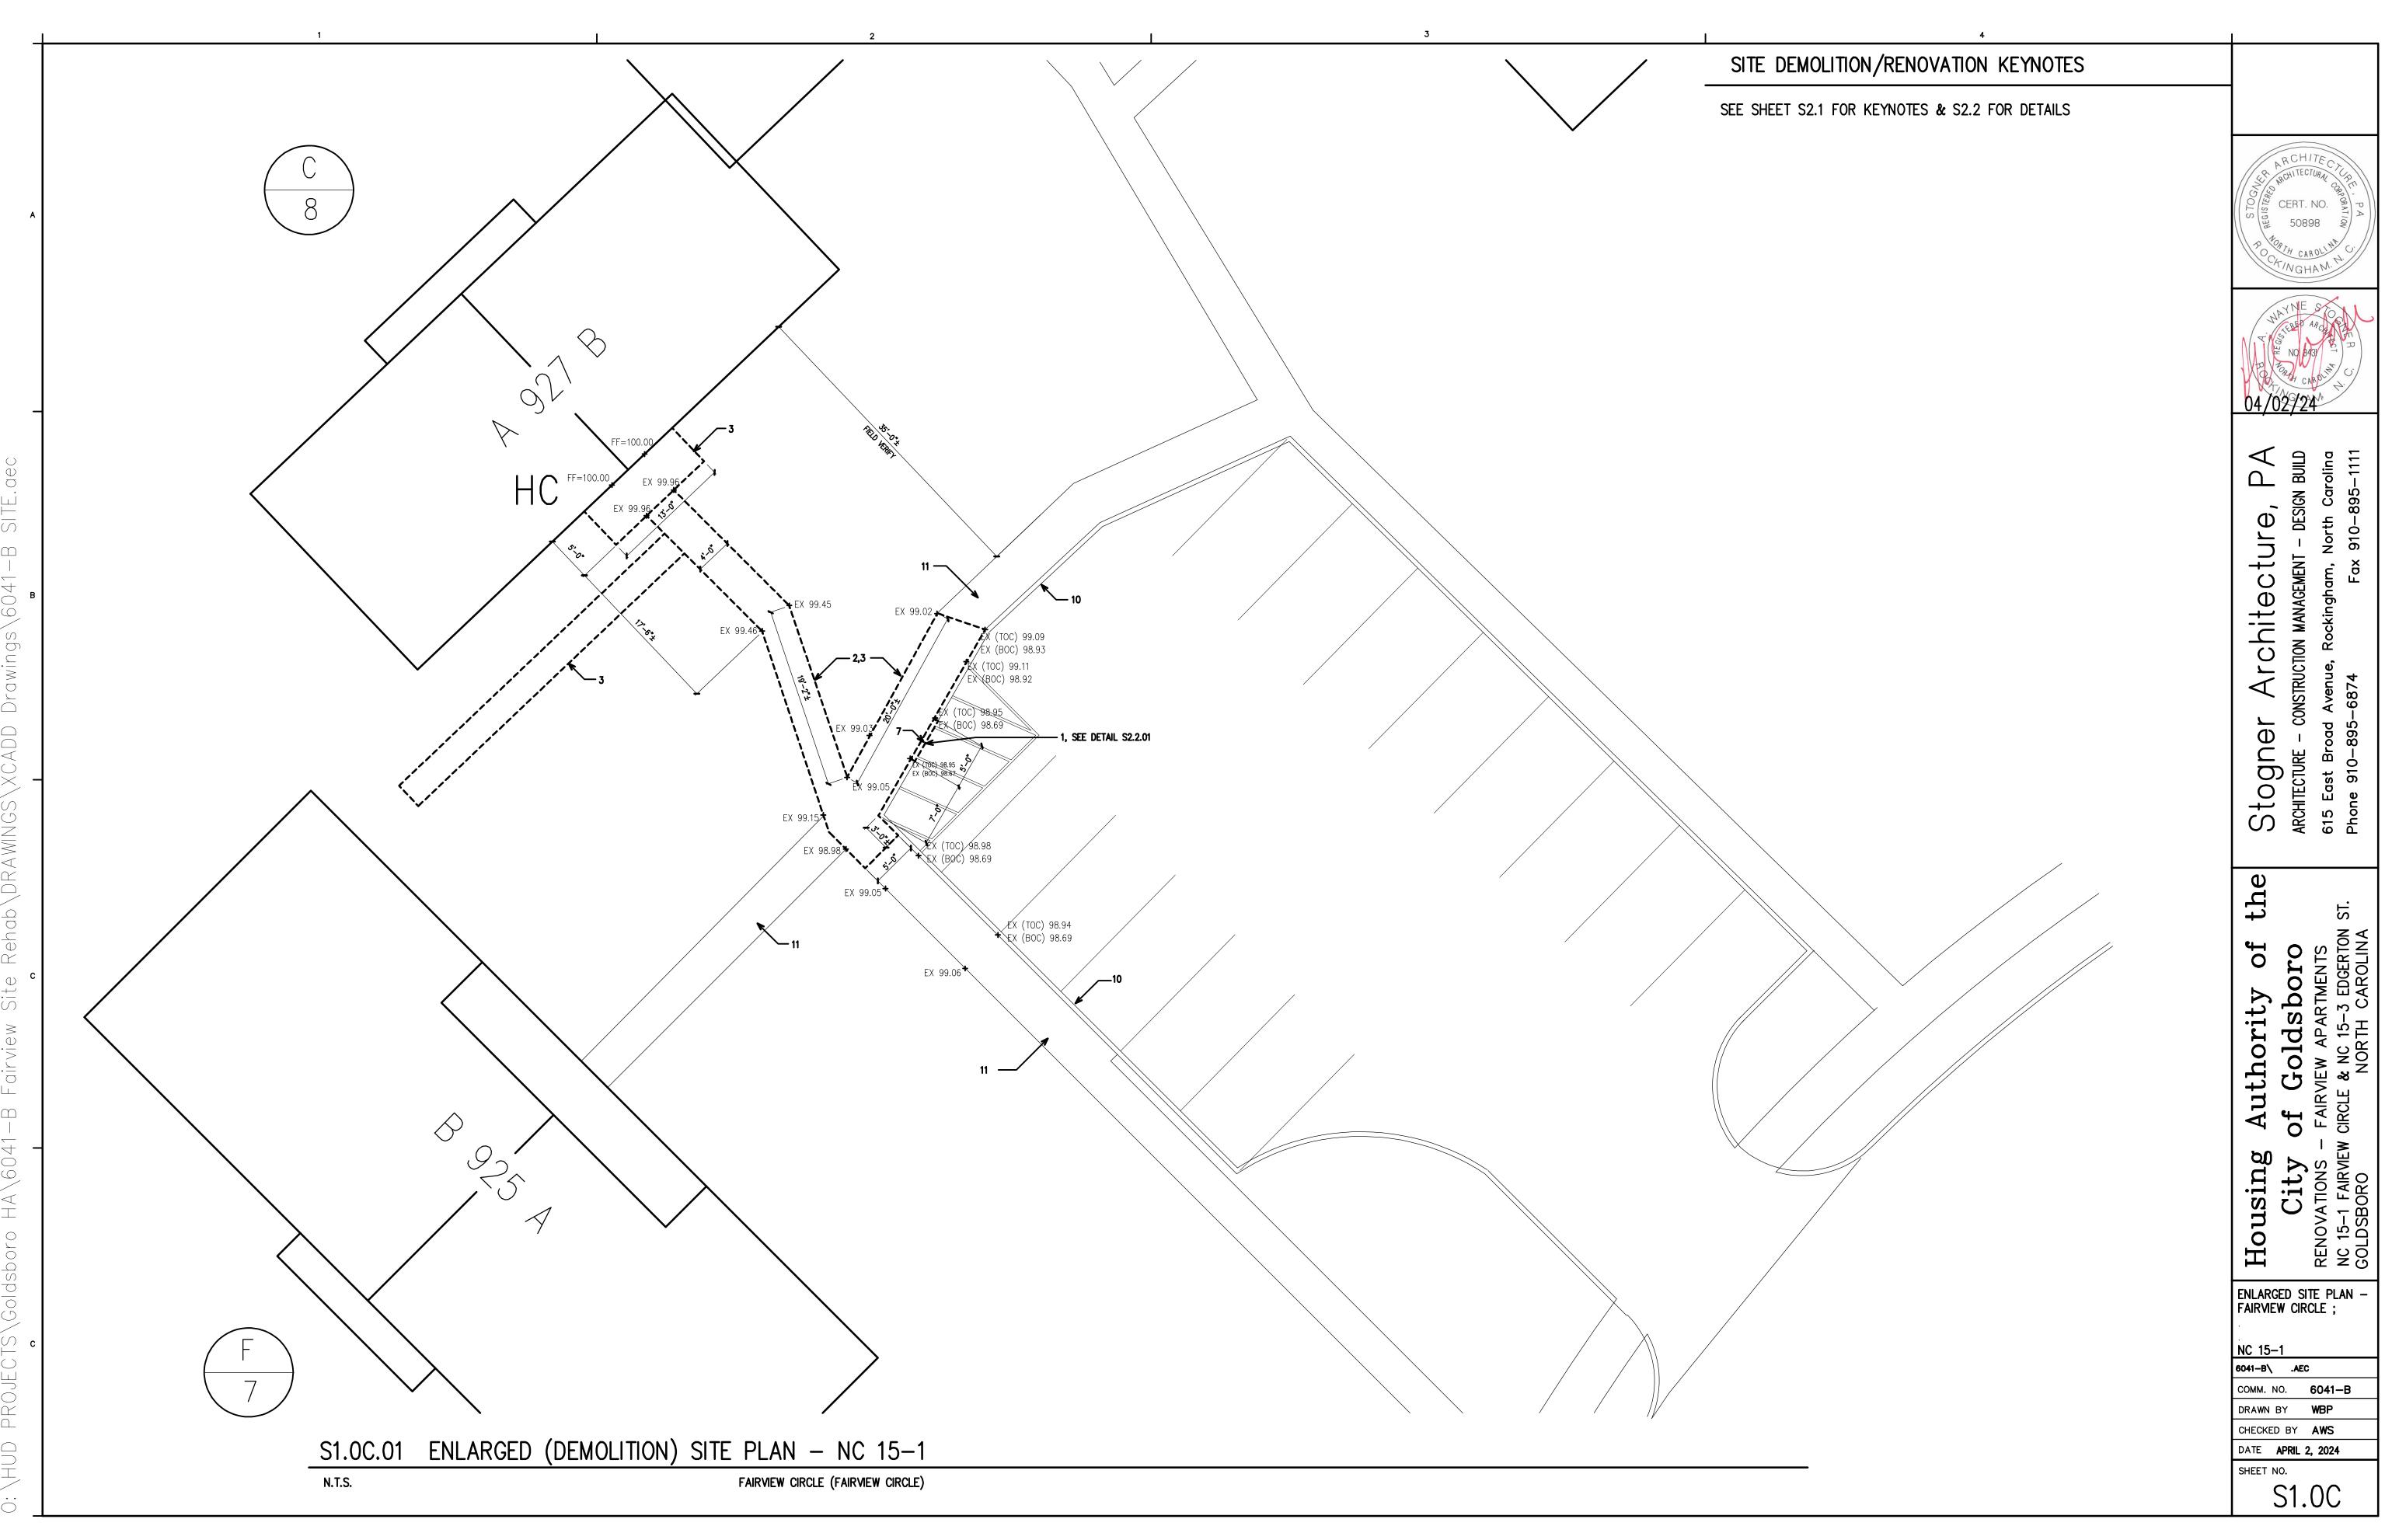
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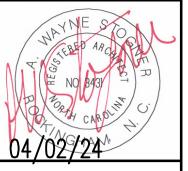
DATE APRIL 2, 2024
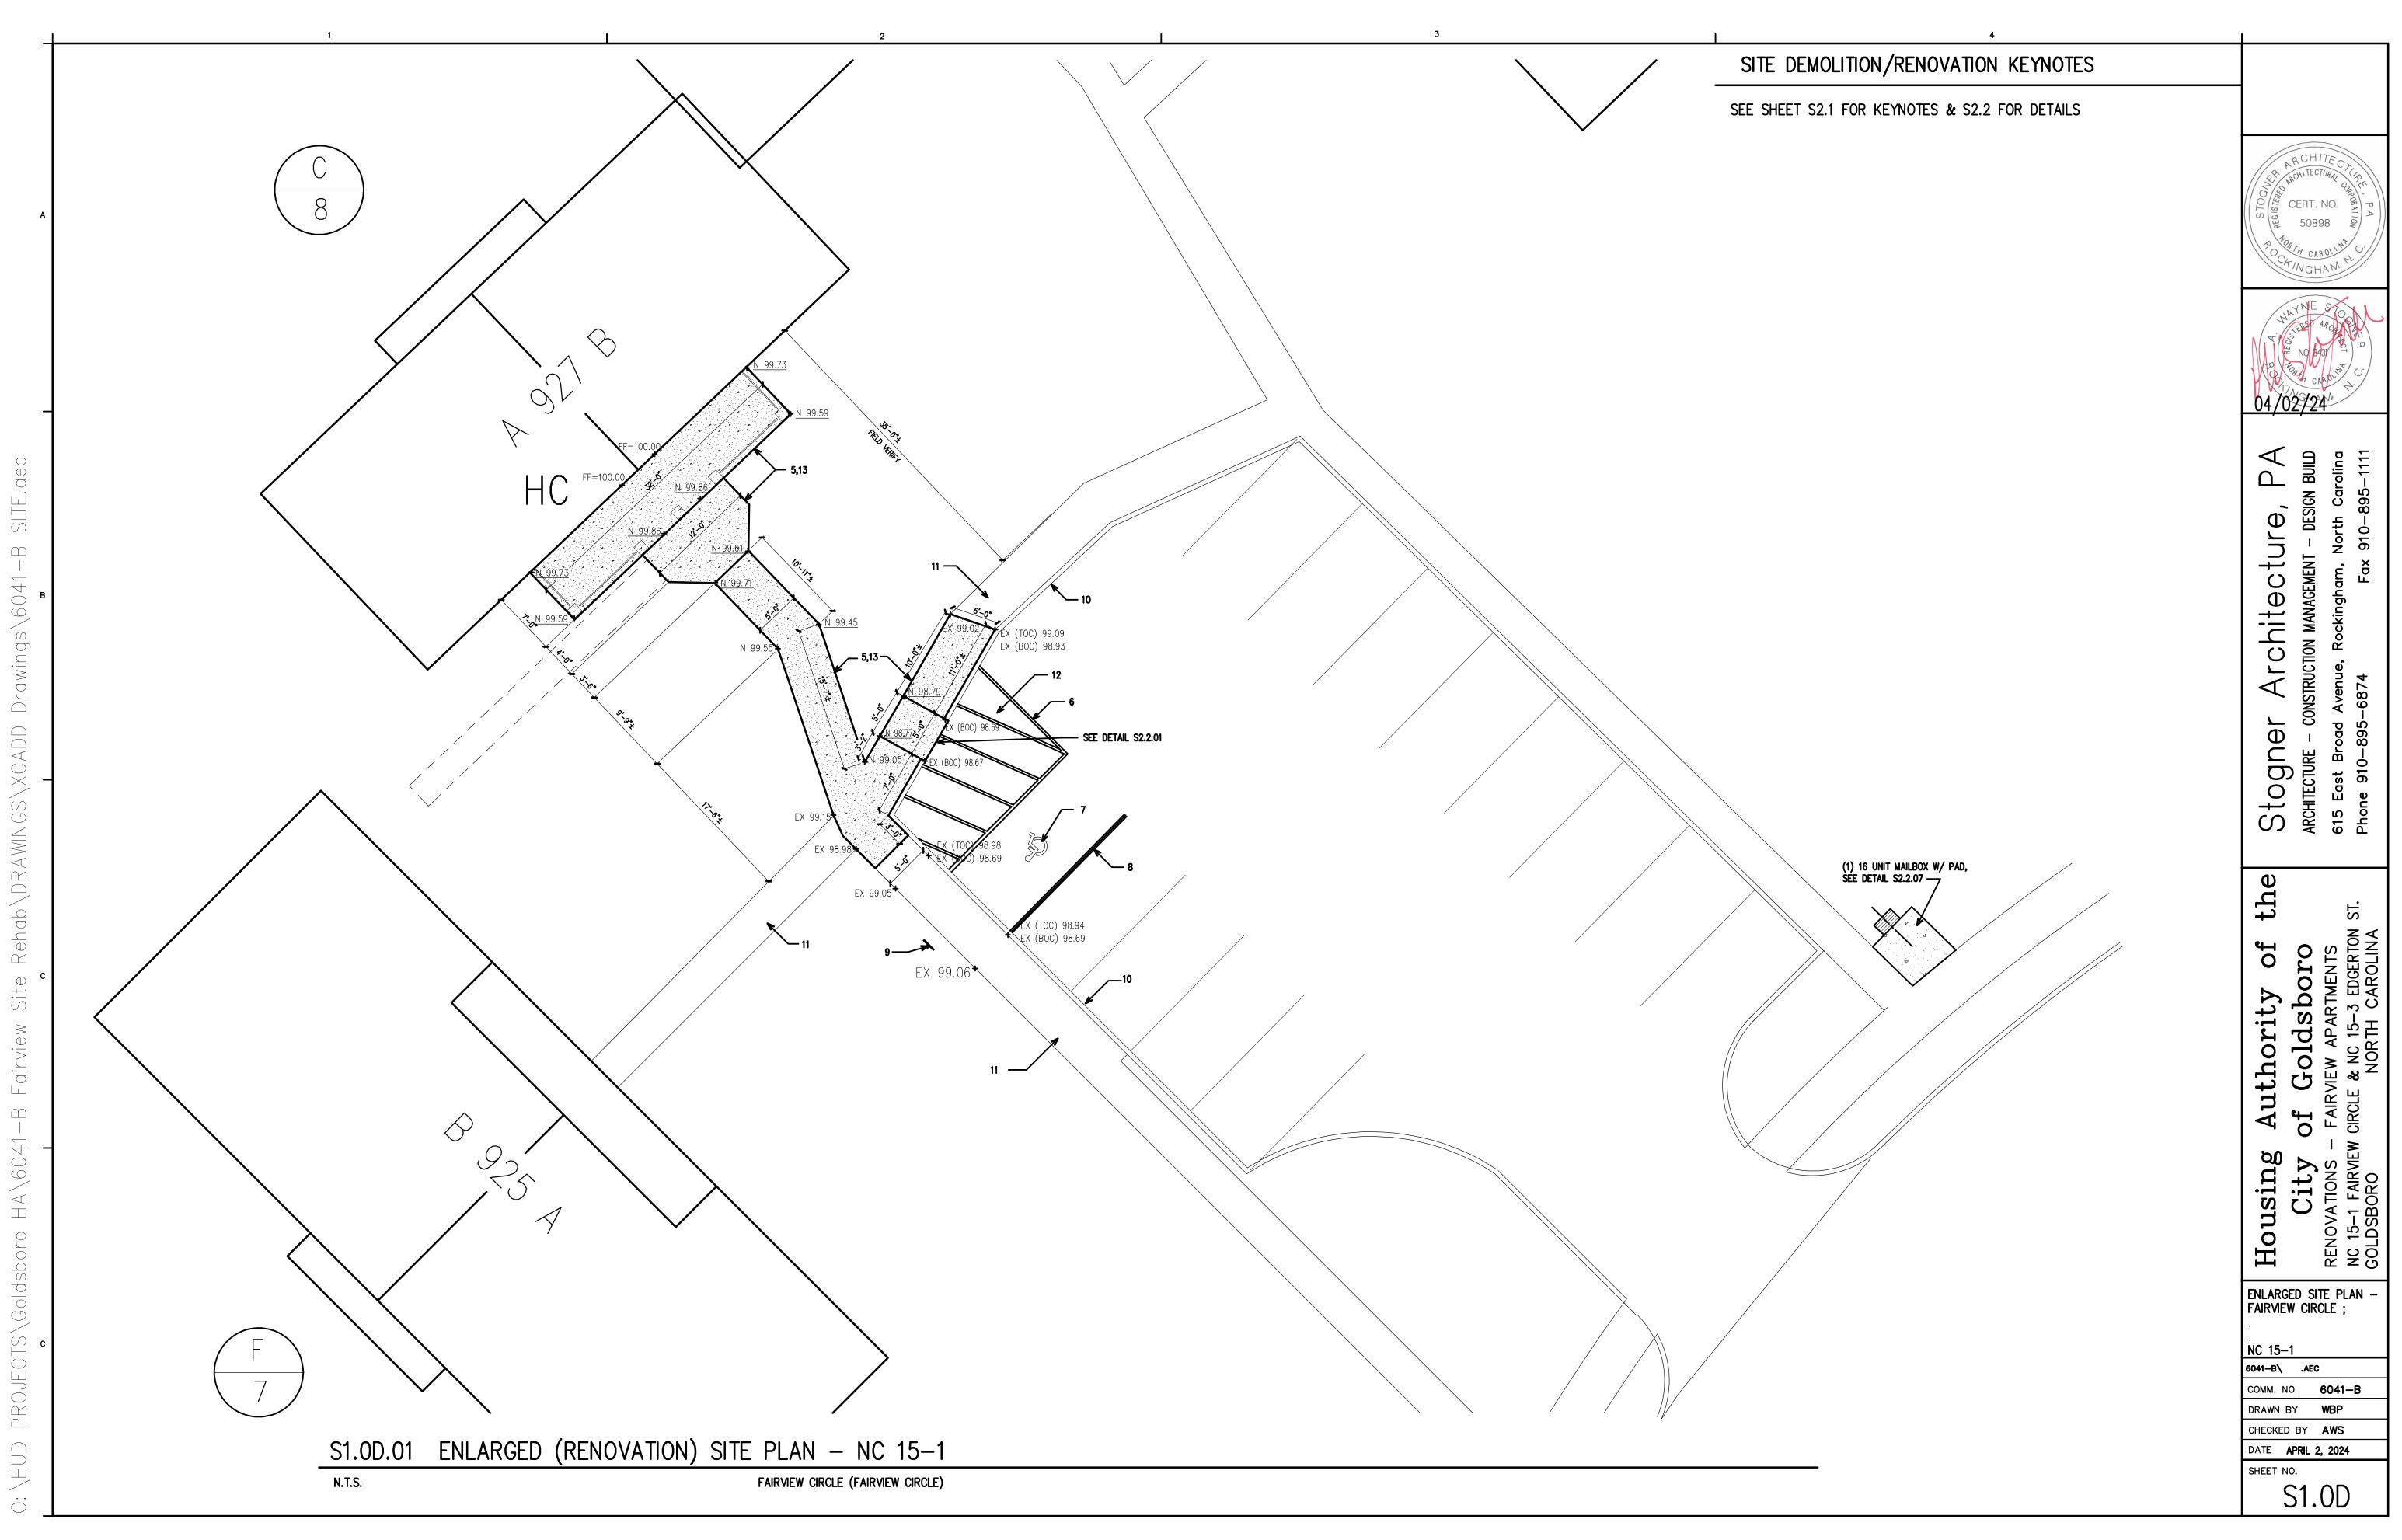
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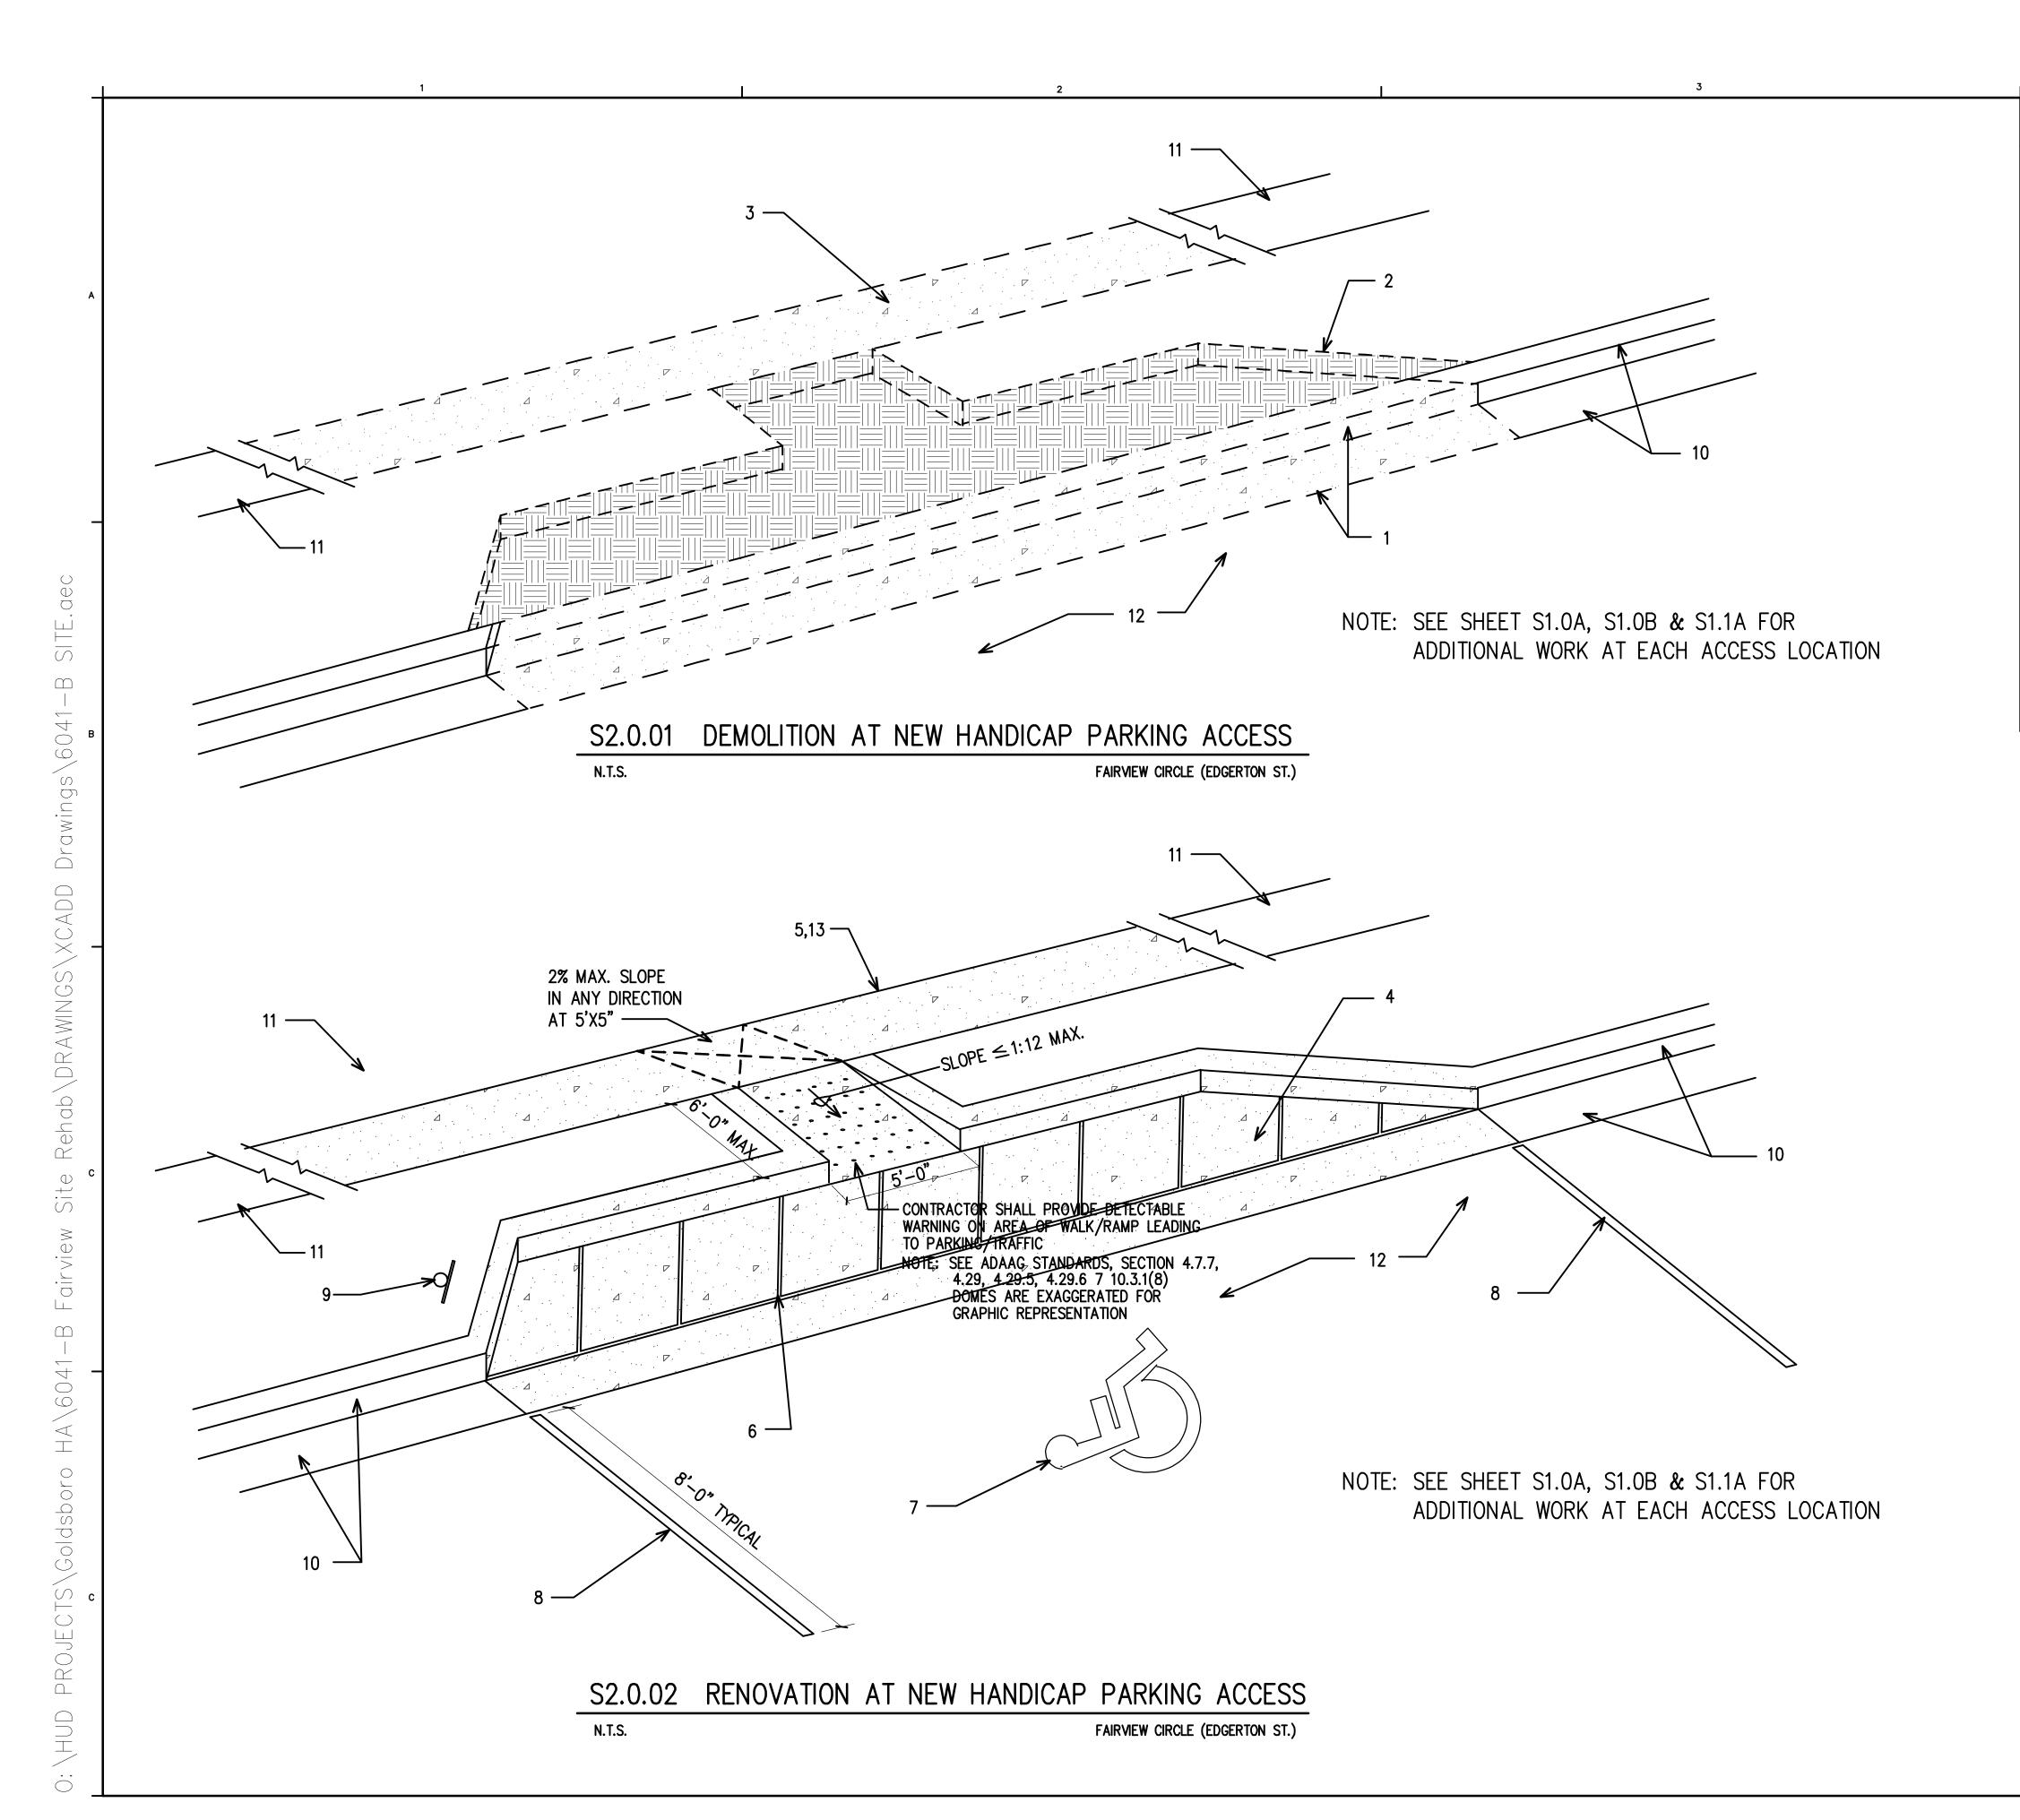
ENLARGED SITE PLAN - FAIRVIEW CIRCLE;

NC 15-3 6041-B\ .AEC
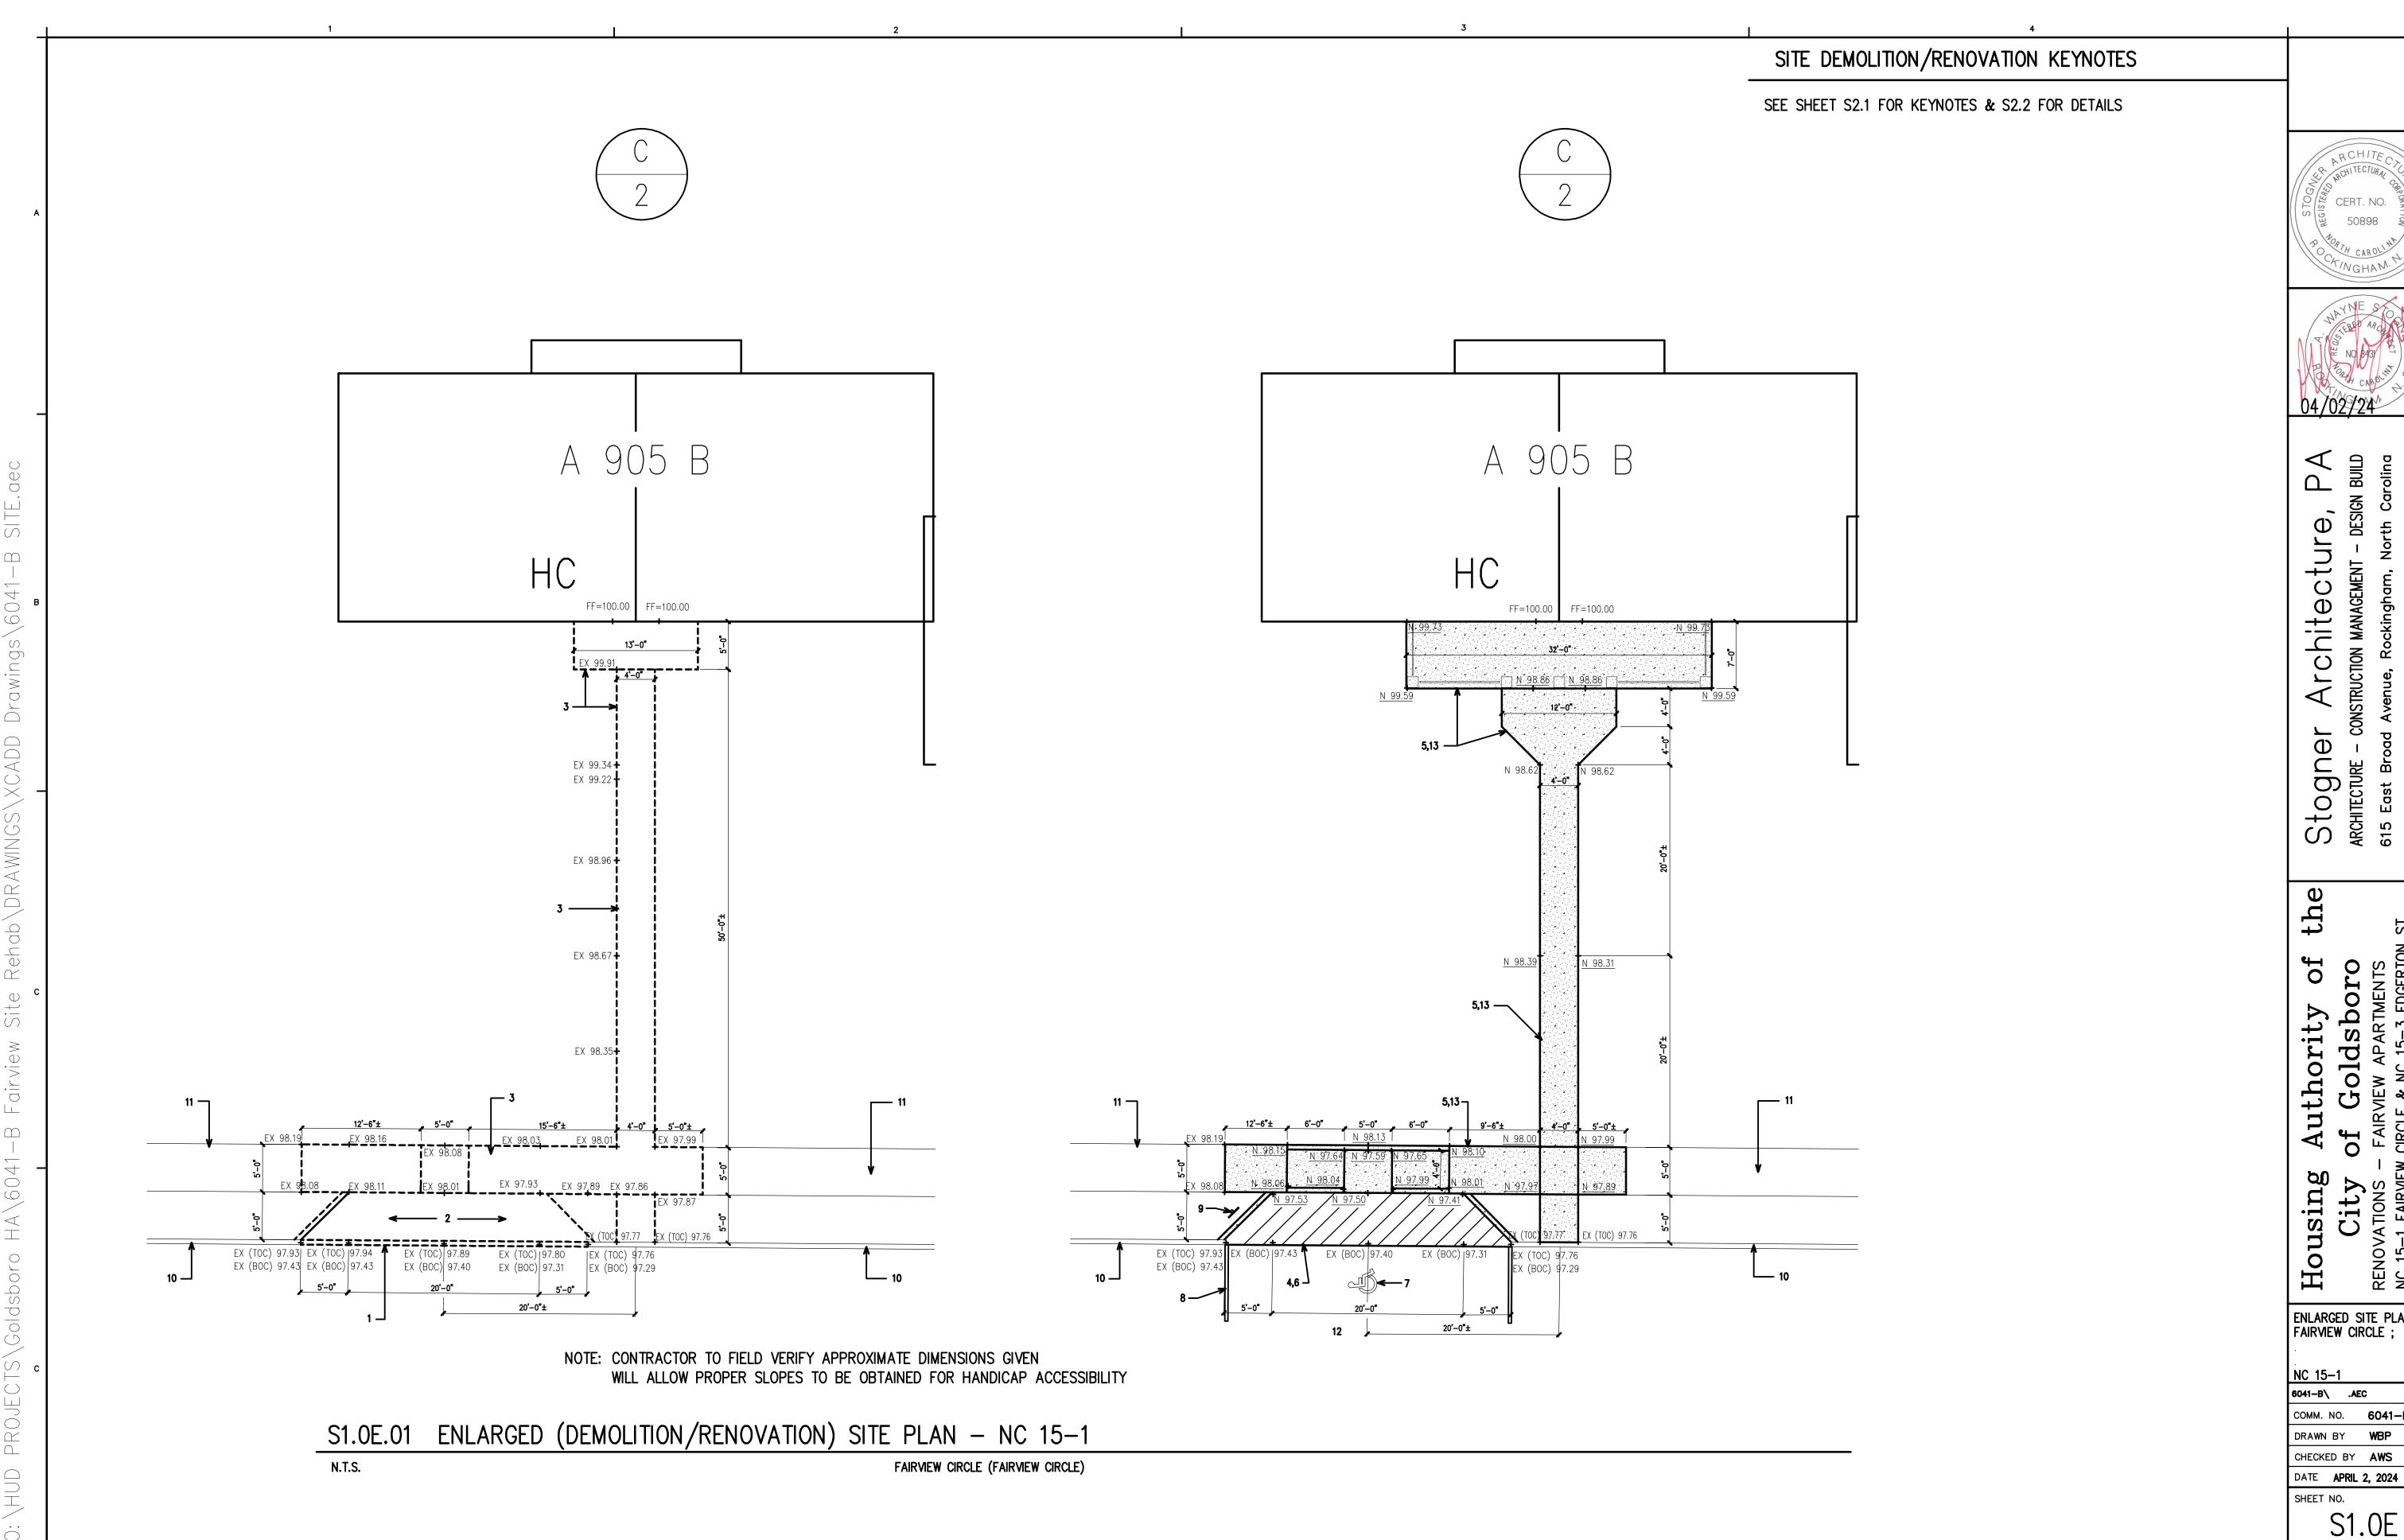
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S1.1A

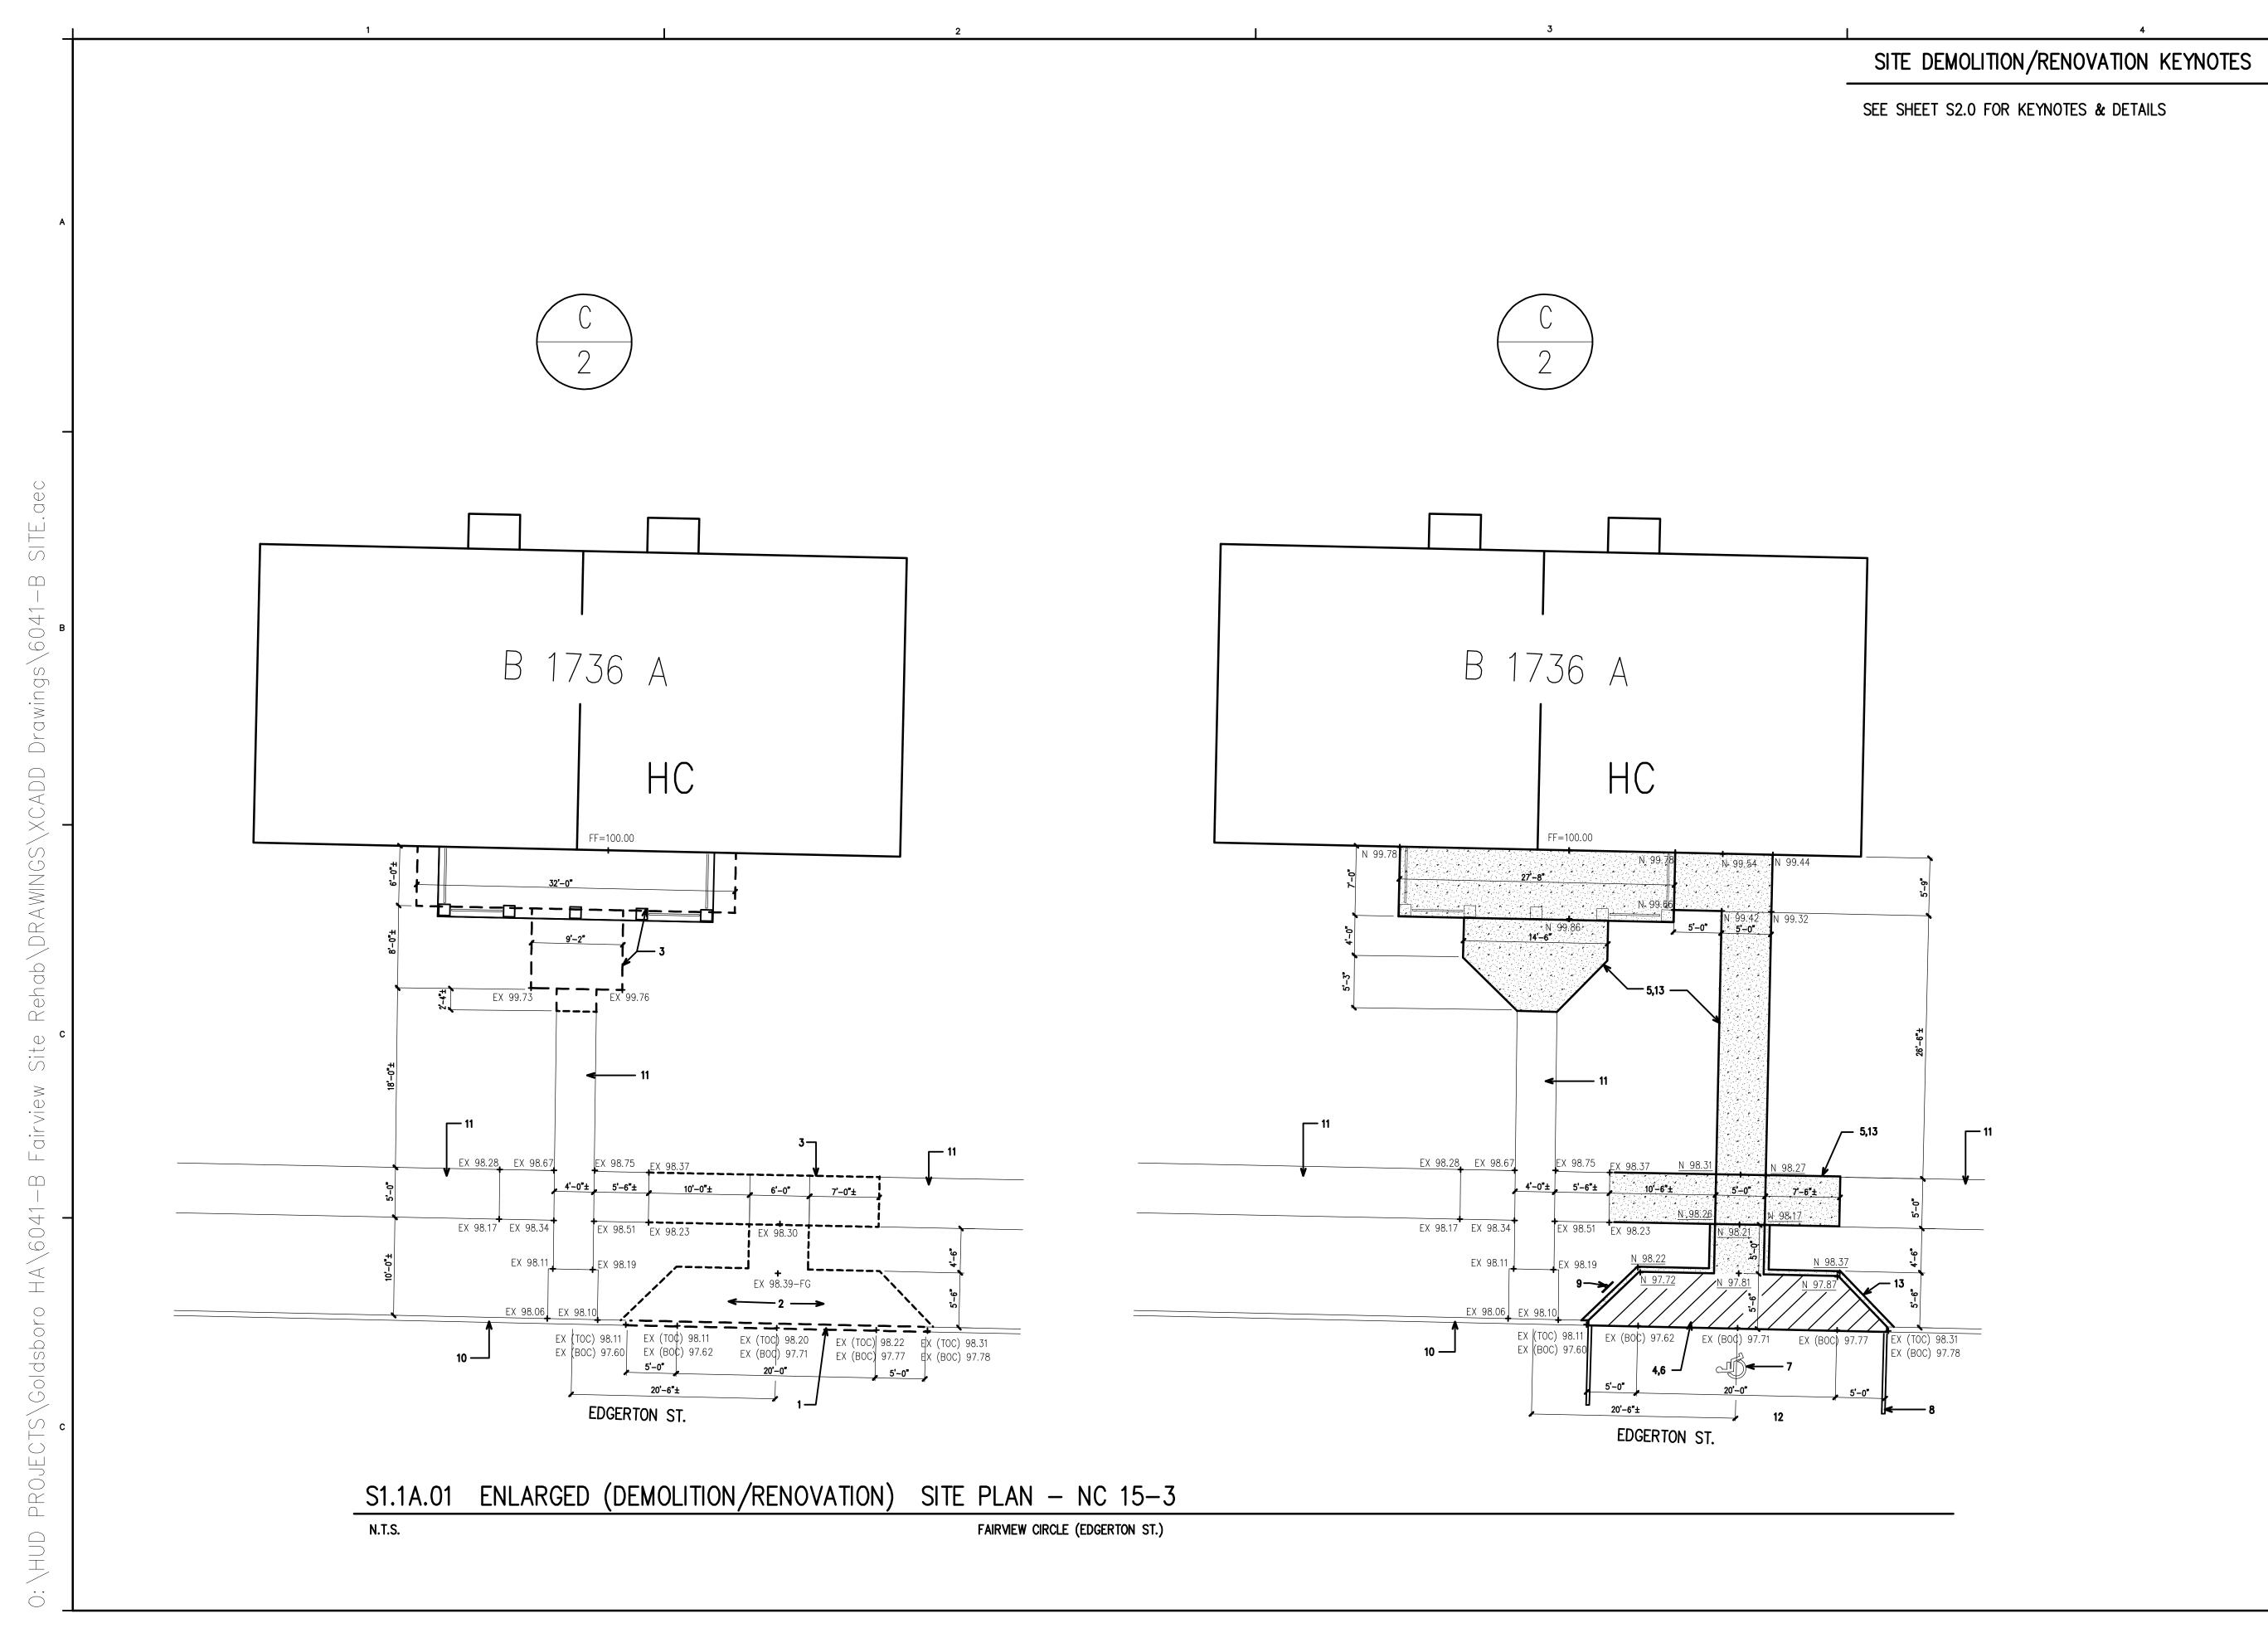
DATE APRIL 2, 2024 SHEET NO.



## SITE DEMOLITION/RENOVATION KEYNOTES

- . REMOVE EXISTING CONCRETE CURB/GUTTER AS SHOWN FOR NEW HANDICAP ACCESS.
- 2. REMOVE EXISTING GRADE FOR NEW HANDICAP ACCESS ADJACENT TO NEW/EXISTING WALK.
- 3. REMOVE EXISTING CONCRETE WALK FOR NEW HANDICAP ACCESS.
- 4. PROVIDE NEW 6" THK. 3000 PSI CONCRETE W/ FIBROUS REINFORCEMENT AT NEW HANDICAP ACCESS. MAX. SLOPE 2% IN ANY DIRECTION.
- 5. PROVIDE NEW 4" THK. 3000 PSI CONCRETE W/ FIBROUS REINFORCEMENT WALK W/ MAX. 2% CROSS-SLOPE.
- SEE A5.0, A5.1, & A5.2 FOR REVISED PORCH DETAILS.
- 6. PROVIDE 3" WHITE DIAGONAL STRIPING AT 24" O.C. AT ACCESS ASILE. 7. PROVIDE NEW PAINTED INTERNATIONAL SYMBOL OF ACCESS/HANDICAP
- SYMBOL AT PARKING SPACE COLOR (WHITE).
- 8. PROVIDE NEW 4"W. WHITE PAINTED STRIPING AT HANDICAP SPACE.
- 9. PROVIDE NEW HANDICAP PARKING SIGN.
- 10. EXISTING CONCRETE CURB/GUTTER TO REMAIN.
- 11. EXISTING CONCRETE WALK TO REMAIN, SEE SITE PLAN.
- 12. EXISTING ASPHALT TO REMAIN, CUT & PATCH AS REQUIRED TO CREATE NEW HANDICAP ACCESS.
- 13. PROVIDE NEW TOPSOIL ALONG ALL WALKS WHERE ADJACENT SOIL IS GREATER THAN 1/2" BELOW SURFACE OF WALK. EXTEND NEW SOIL OUT 24" MIN. FROM VERTICAL EDGE OF WALK AT 2% THEN TAPER DOWN @  $@ \le 5\%$  SLOPE, SEE S2.2.02. PROVIDE SEED AND STRAW.
- 14. PROVIDE NEW LOAM, SEED, STRAW AT ALL BARE GROUND & DISTRUBED AREAS THROUGHOUT SITE. OVERSEED ALL LAWN AREAS, AERATE (INCLUDING BARE GROUND AREAS), FERTILIZE THROUGHOUT SITE.



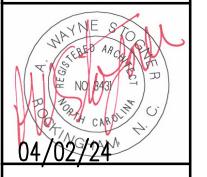

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ENLARGED SITE PLAN FAIRVIEW CIRCLE;


NC 15-1 & NC 15-3

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COMM. NO. **6041-B** DRAWN BY WBP

CHECKED BY AWS DATE APRIL 2, 2024

SHEET NO. S2.0

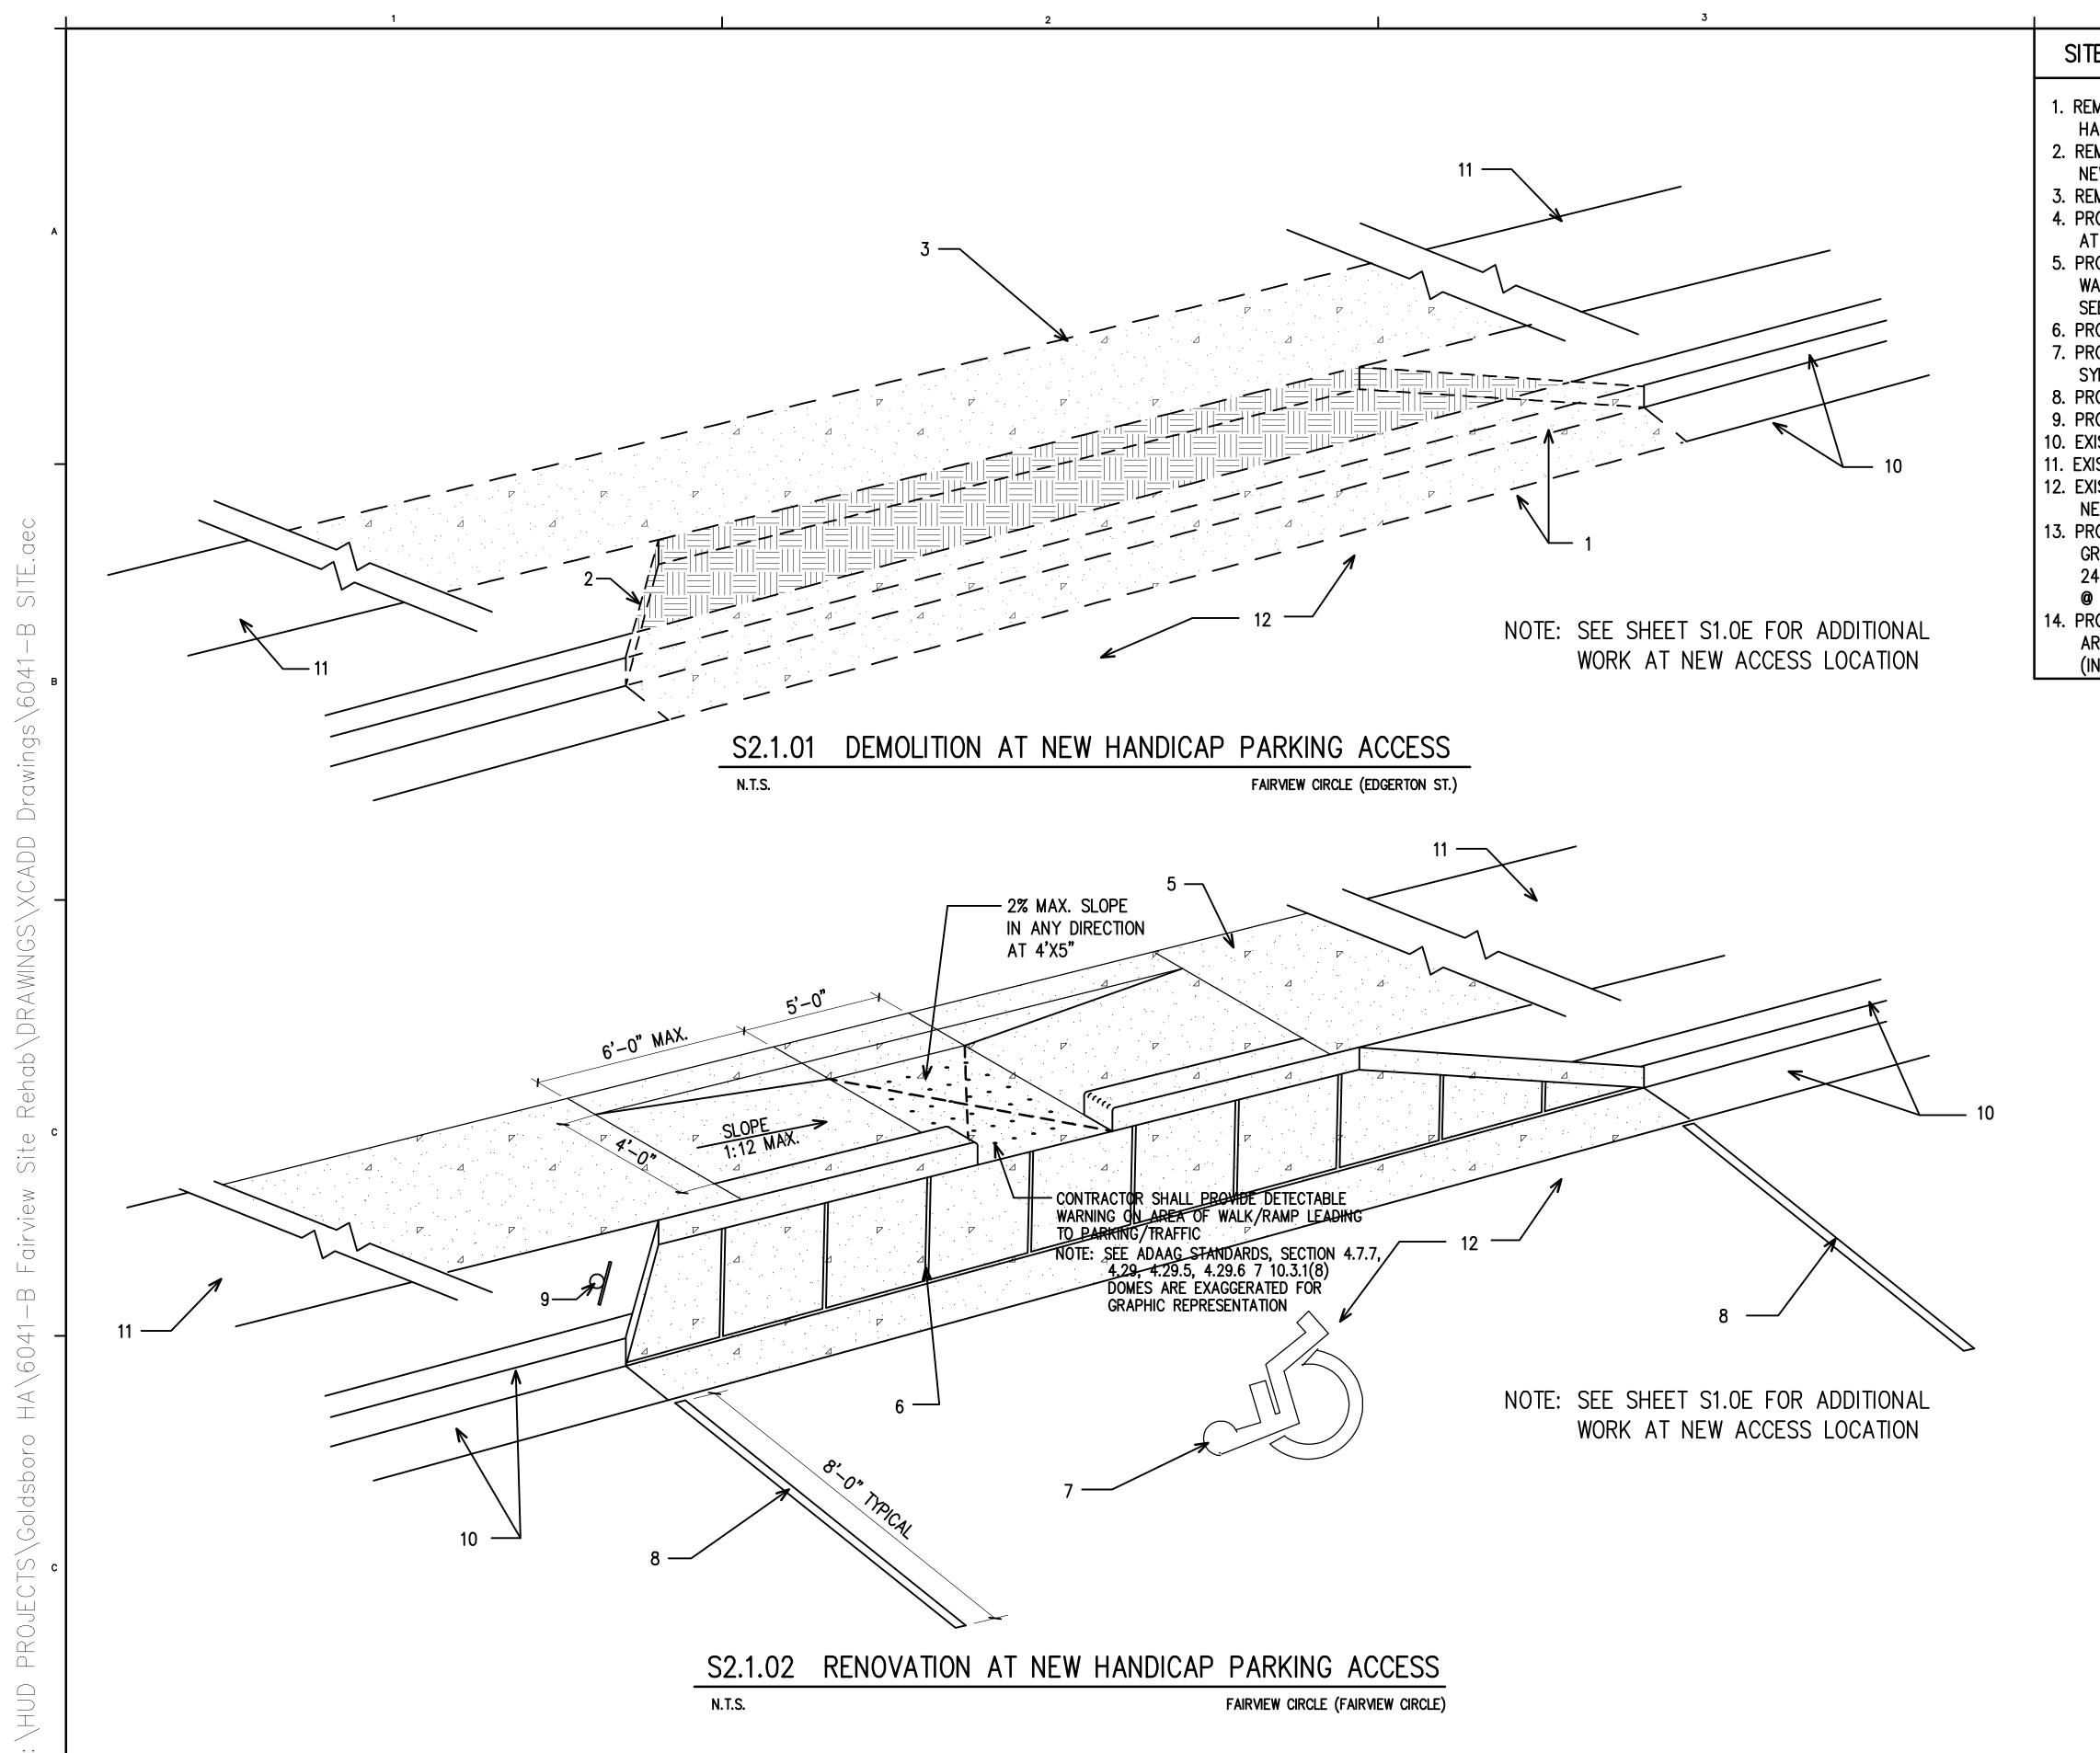

## SITE DEMOLITION/RENOVATION KEYNOTES

- 1. REMOVE EXISTING CONCRETE CURB/GUTTER AS SHOWN FOR NEW HANDICAP ACCESS.
- 2. REMOVE EXISTING GRADE FOR NEW HANDICAP ACCESS ADJACENT TO NEW/EXISTING WALK.
- 3. REMOVE EXISTING CONCRETE WALK FOR NEW HANDICAP ACCESS.
- 4. PROVIDE NEW 6" THK. 3000 PSI CONCRETE W/ FIBROUS REINFORCEMENT AT NEW HANDICAP ACCESS. MAX. SLOPE 2% IN ANY DIRECTION.
- 5. PROVIDE NEW 4" THK. 3000 PSI CONCRETE W/ FIBROUS REINFORCEMENT WALK W/ MAX. 2% CROSS-SLOPE.

SEE A5.0, A5.1, & A5.2 FOR REVISED PORCH DETAILS.

- 6. PROVIDE 3" WHITE DIAGONAL STRIPING AT 24" O.C. AT ACCESS ASILE. 7. PROVIDE NEW PAINTED INTERNATIONAL SYMBOL OF ACCESS/HANDICAP
- SYMBOL AT PARKING SPACE COLOR (WHITE).
- 8. PROVIDE NEW 4"W. WHITE PAINTED STRIPING AT HANDICAP SPACE.
- 9. PROVIDE NEW HANDICAP PARKING SIGN.
- 10. EXISTING CONCRETE CURB/GUTTER TO REMAIN.
- 11. EXISTING CONCRETE WALK TO REMAIN, SEE SITE PLAN.
- 12. EXISTING ASPHALT TO REMAIN, CUT & PATCH AS REQUIRED TO CREATE NEW HANDICAP ACCESS.
- 13. PROVIDE NEW TOPSOIL ALONG ALL WALKS WHERE ADJACENT SOIL IS GREATER THAN 1/2" BELOW SURFACE OF WALK. EXTEND NEW SOIL OUT 24" MIN. FROM VERTICAL EDGE OF WALK AT 2% THEN TAPER DOWN @ @ ≤ 5% SLOPE, SEE S2.2.02. PROVIDE SEED AND STRAW.
- 14. PROVIDE NEW LOAM, SEED, STRAW AT ALL BARE GROUND & DISTRUBED AREAS THROUGHOUT SITE. OVERSEED ALL LAWN AREAS, AERATE (INCLUDING BARE GROUND AREAS), FERTILIZE THROUGHOUT SITE.





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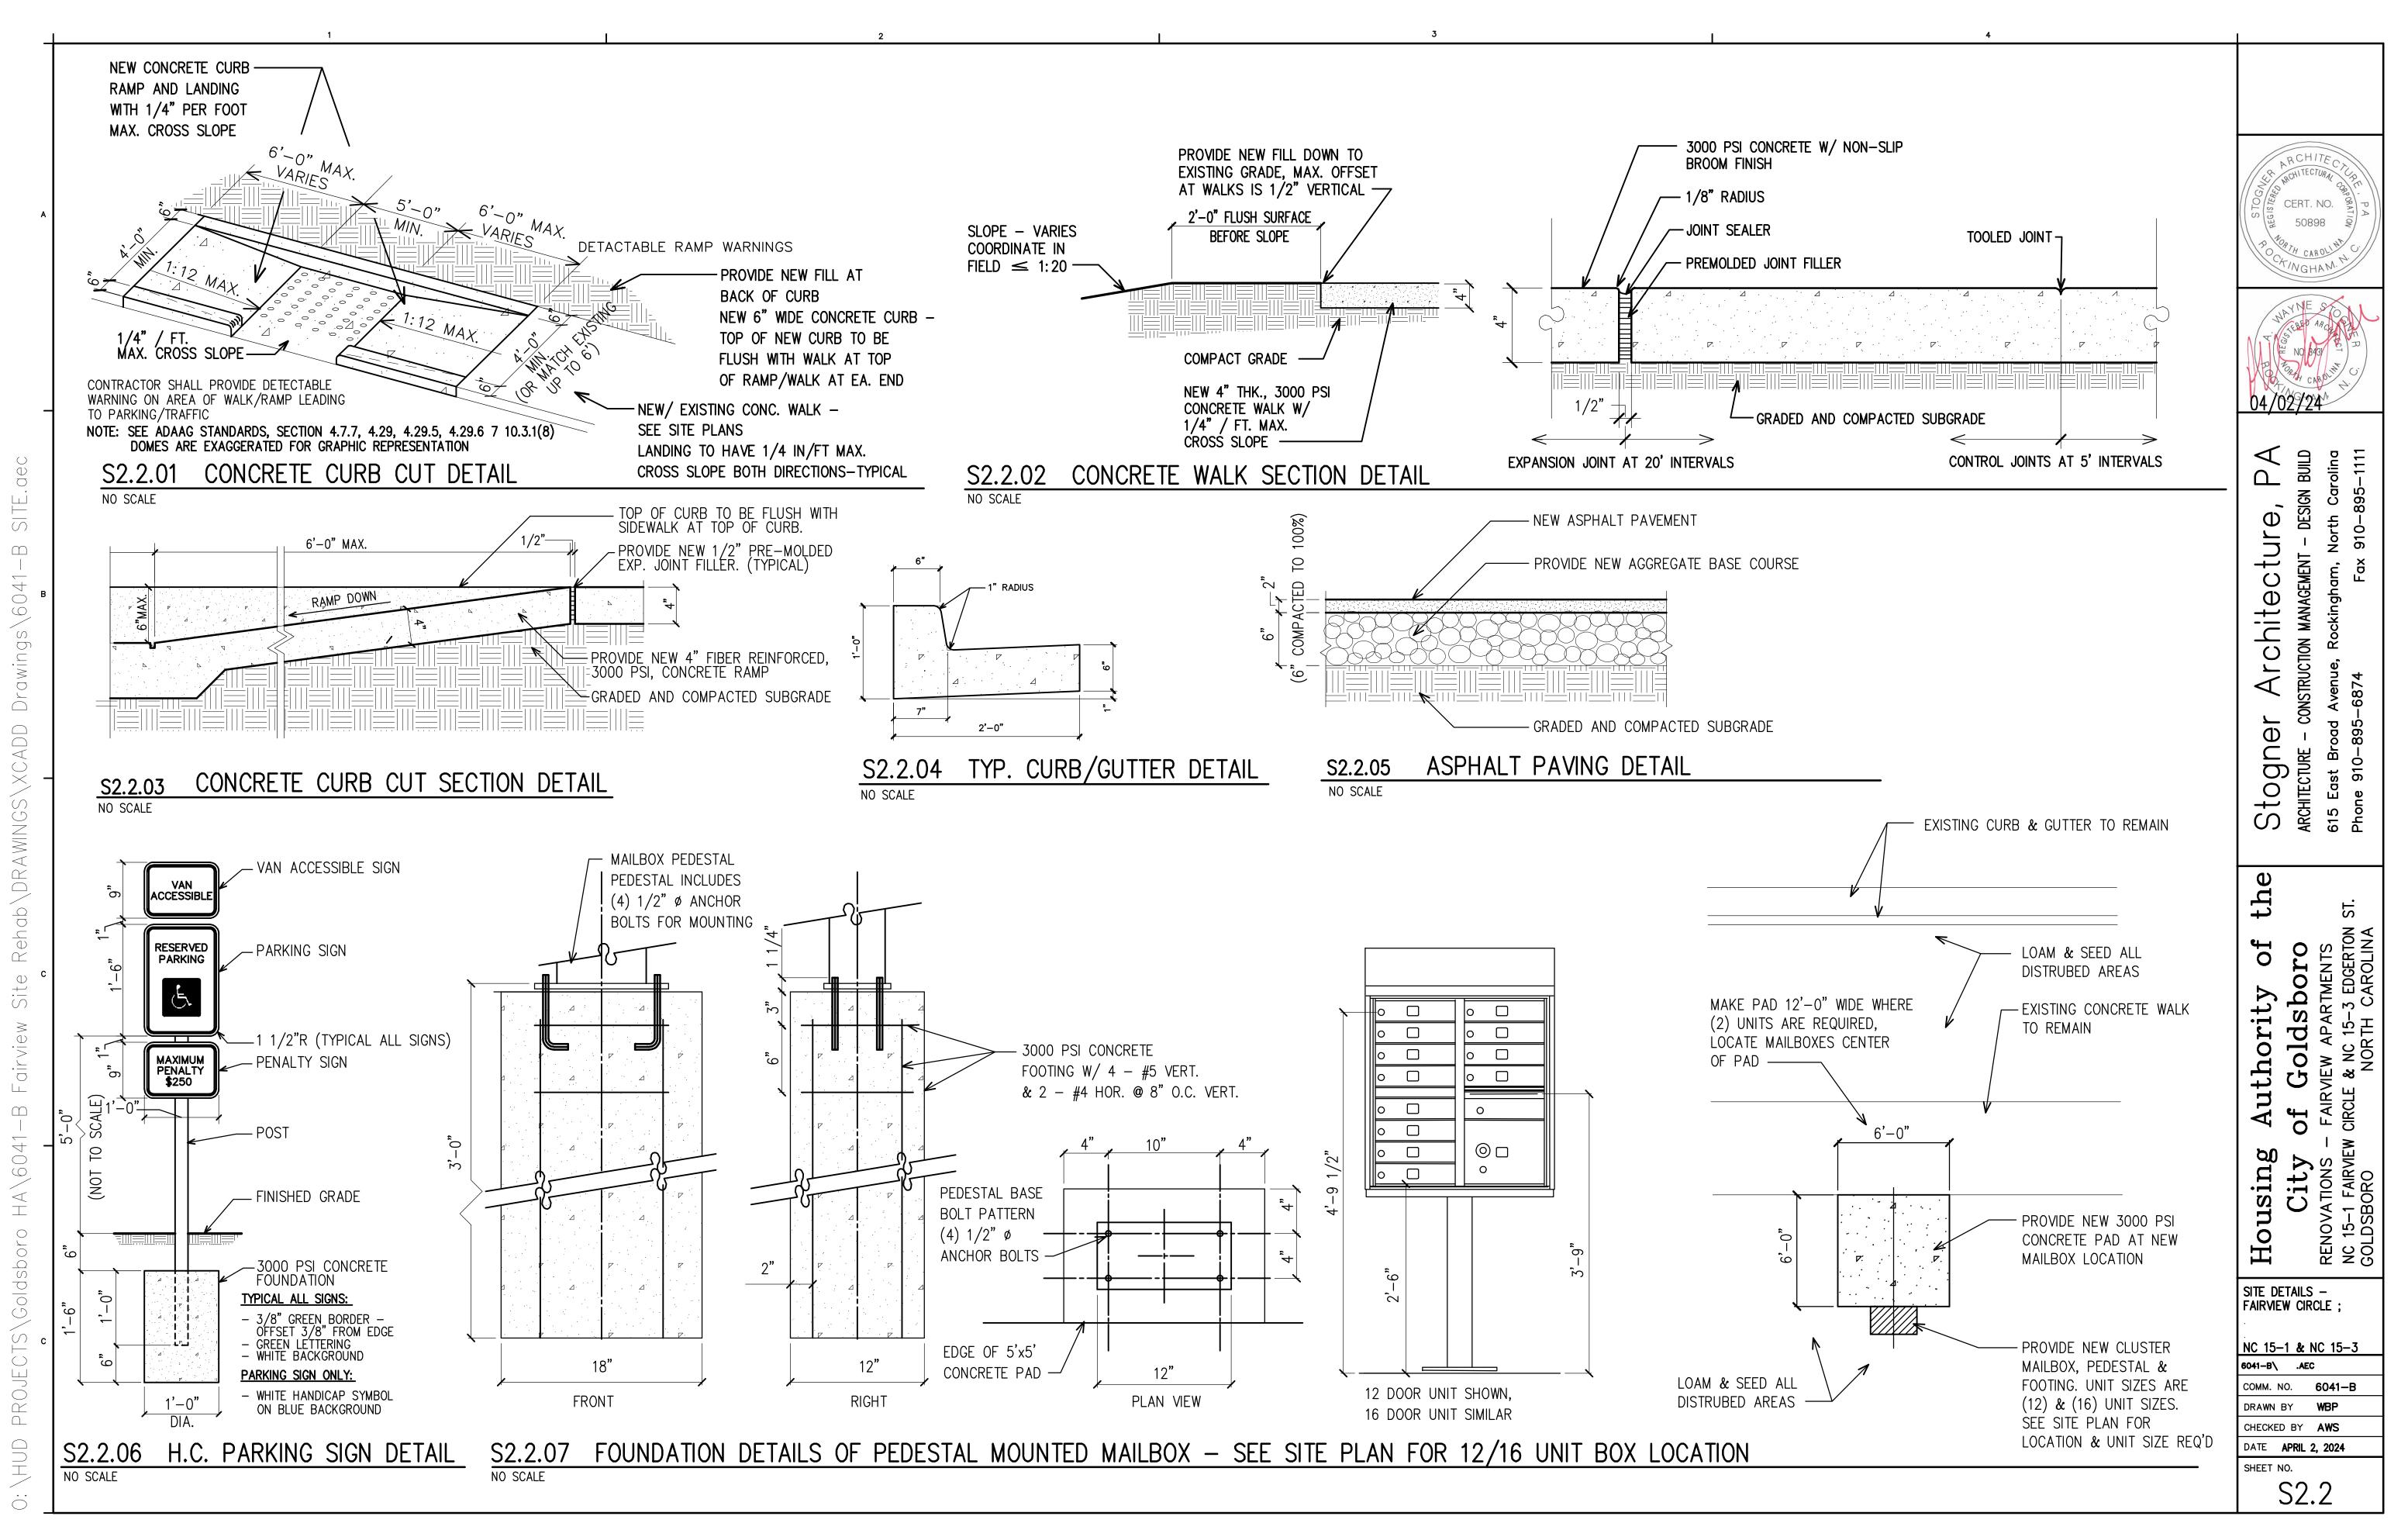
ENLARGED SITE PLAN FAIRVIEW CIRCLE;


NC 15-1

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BLDG. GROUP #1, KEY PLAN - ROOF PLAN, WINDOW LOCATIONS;


NC 15-1


6041-B\ A1.0.AEC COMM. NO. **6041-B** 


DRAWN BY WBP CHECKED BY AWS

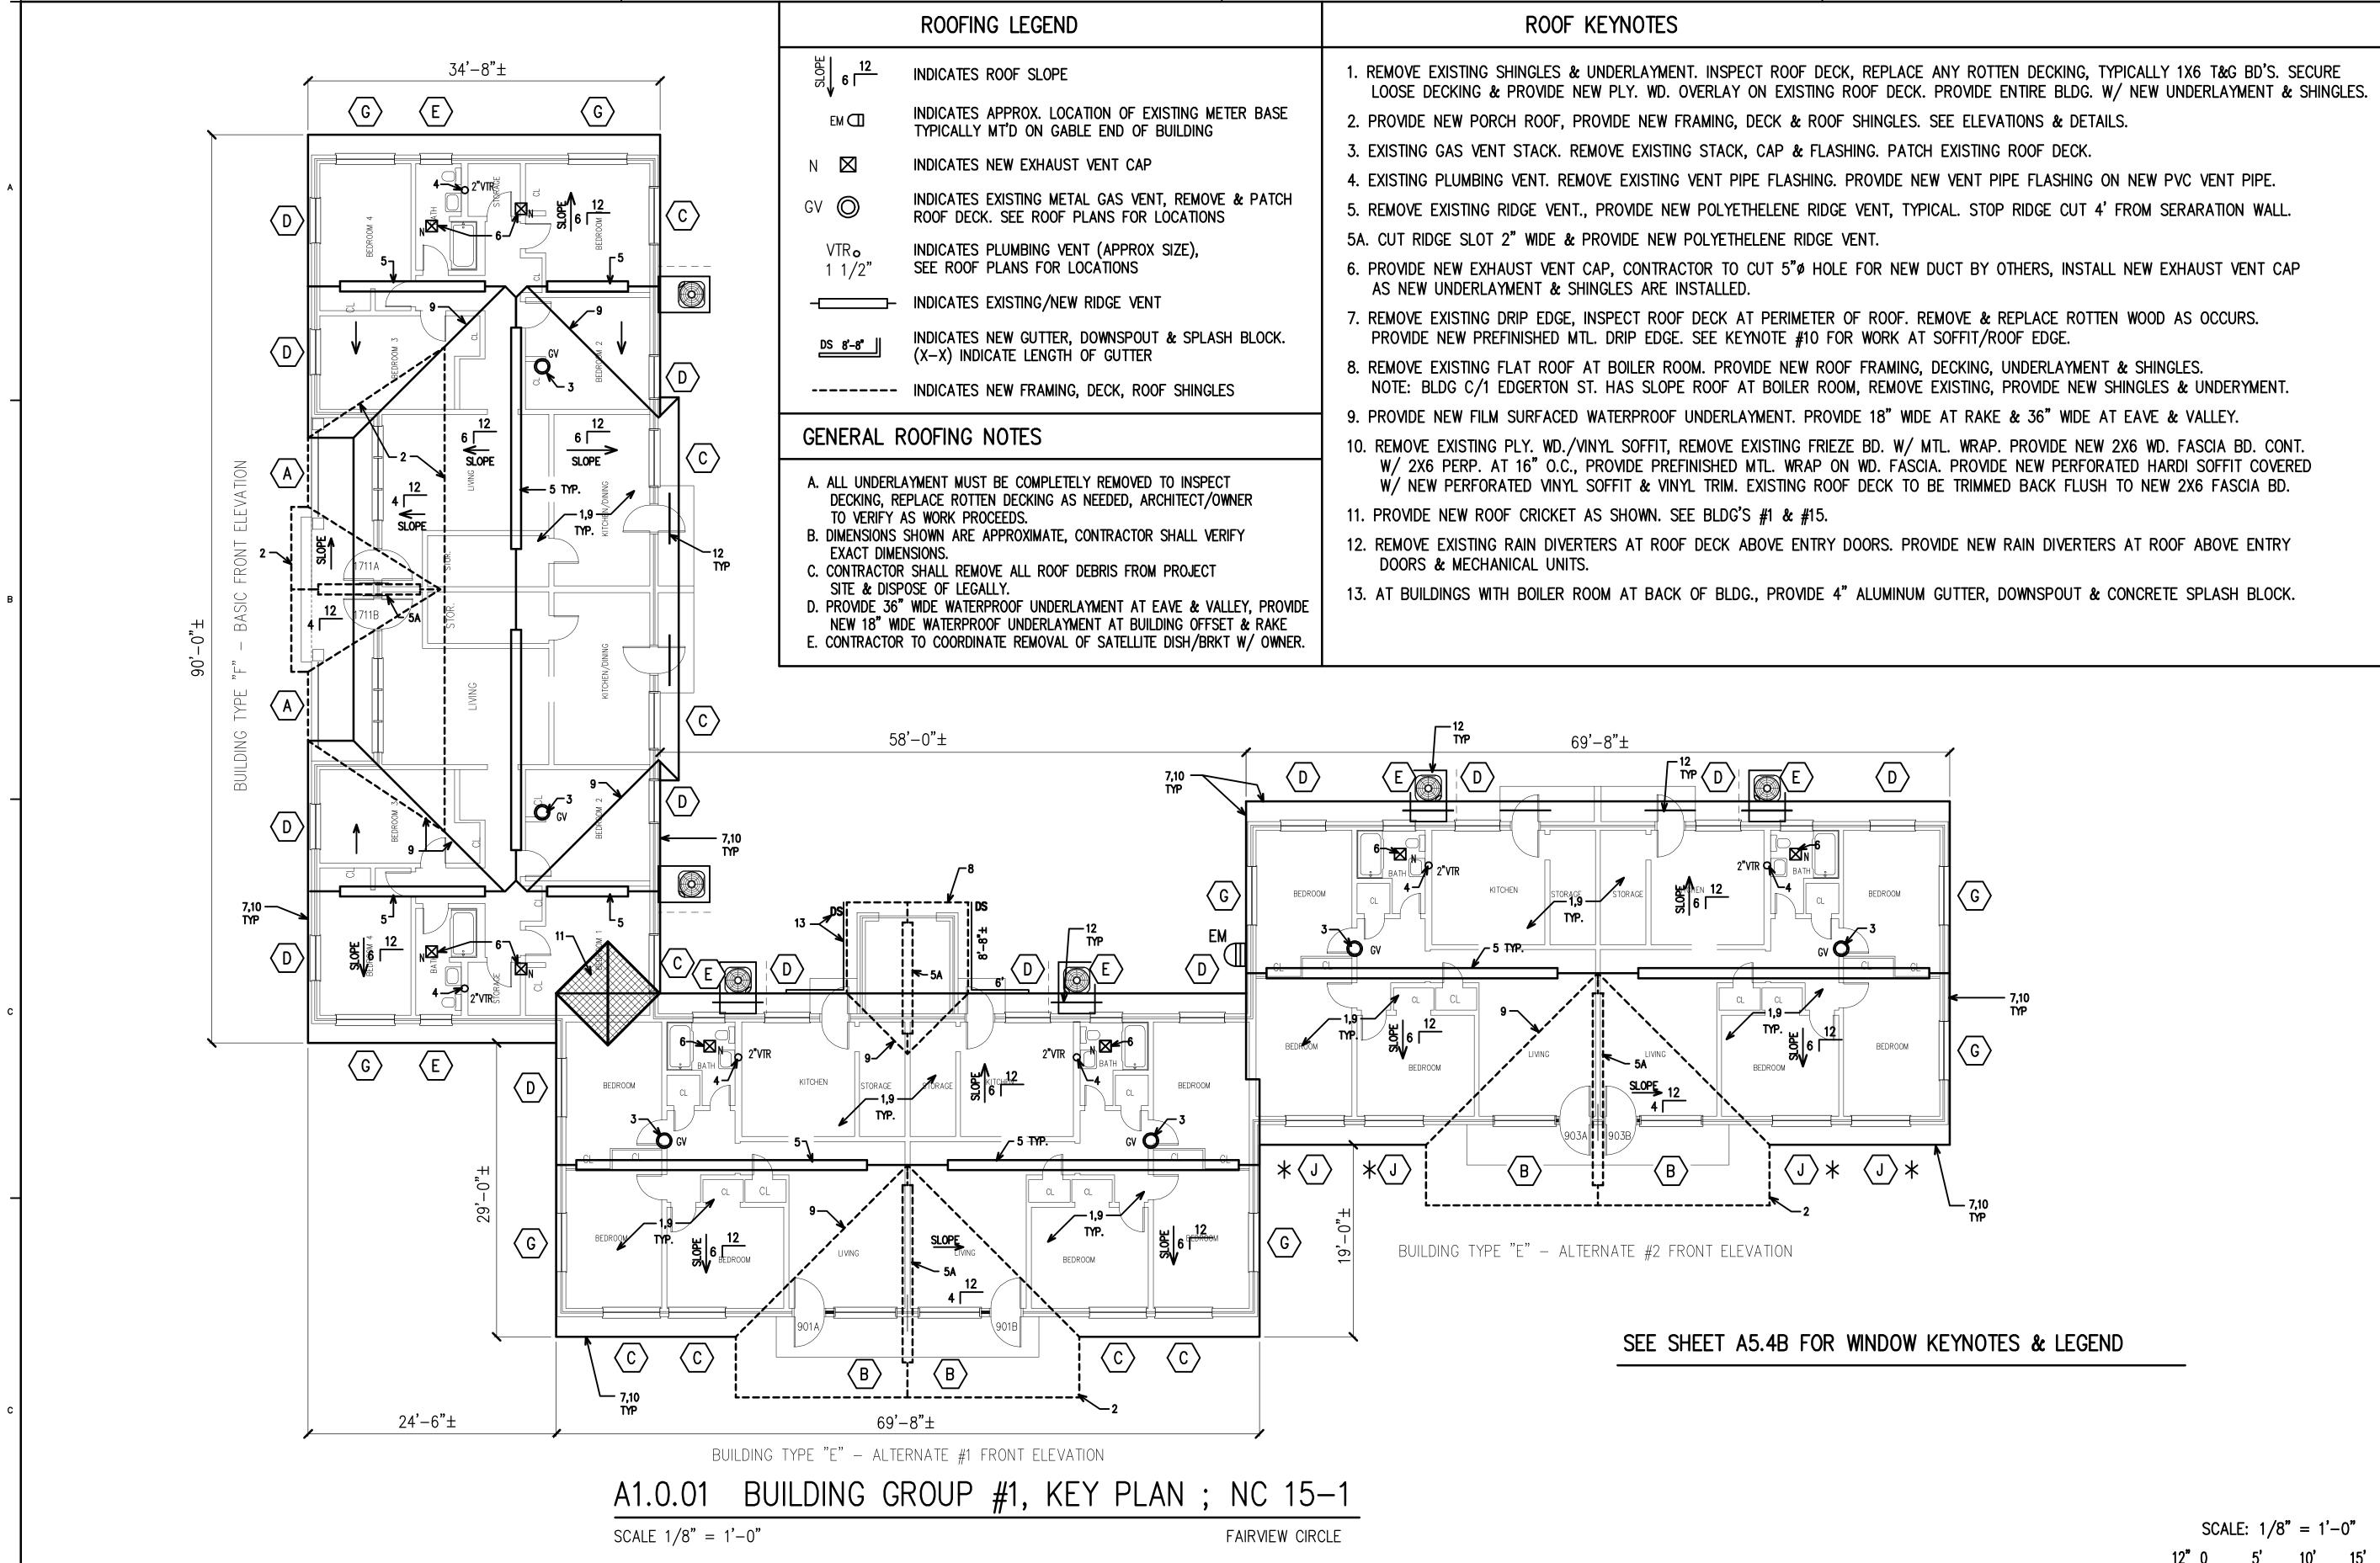DATE APRIL 2, 2024 SHEET NO.

A1.0

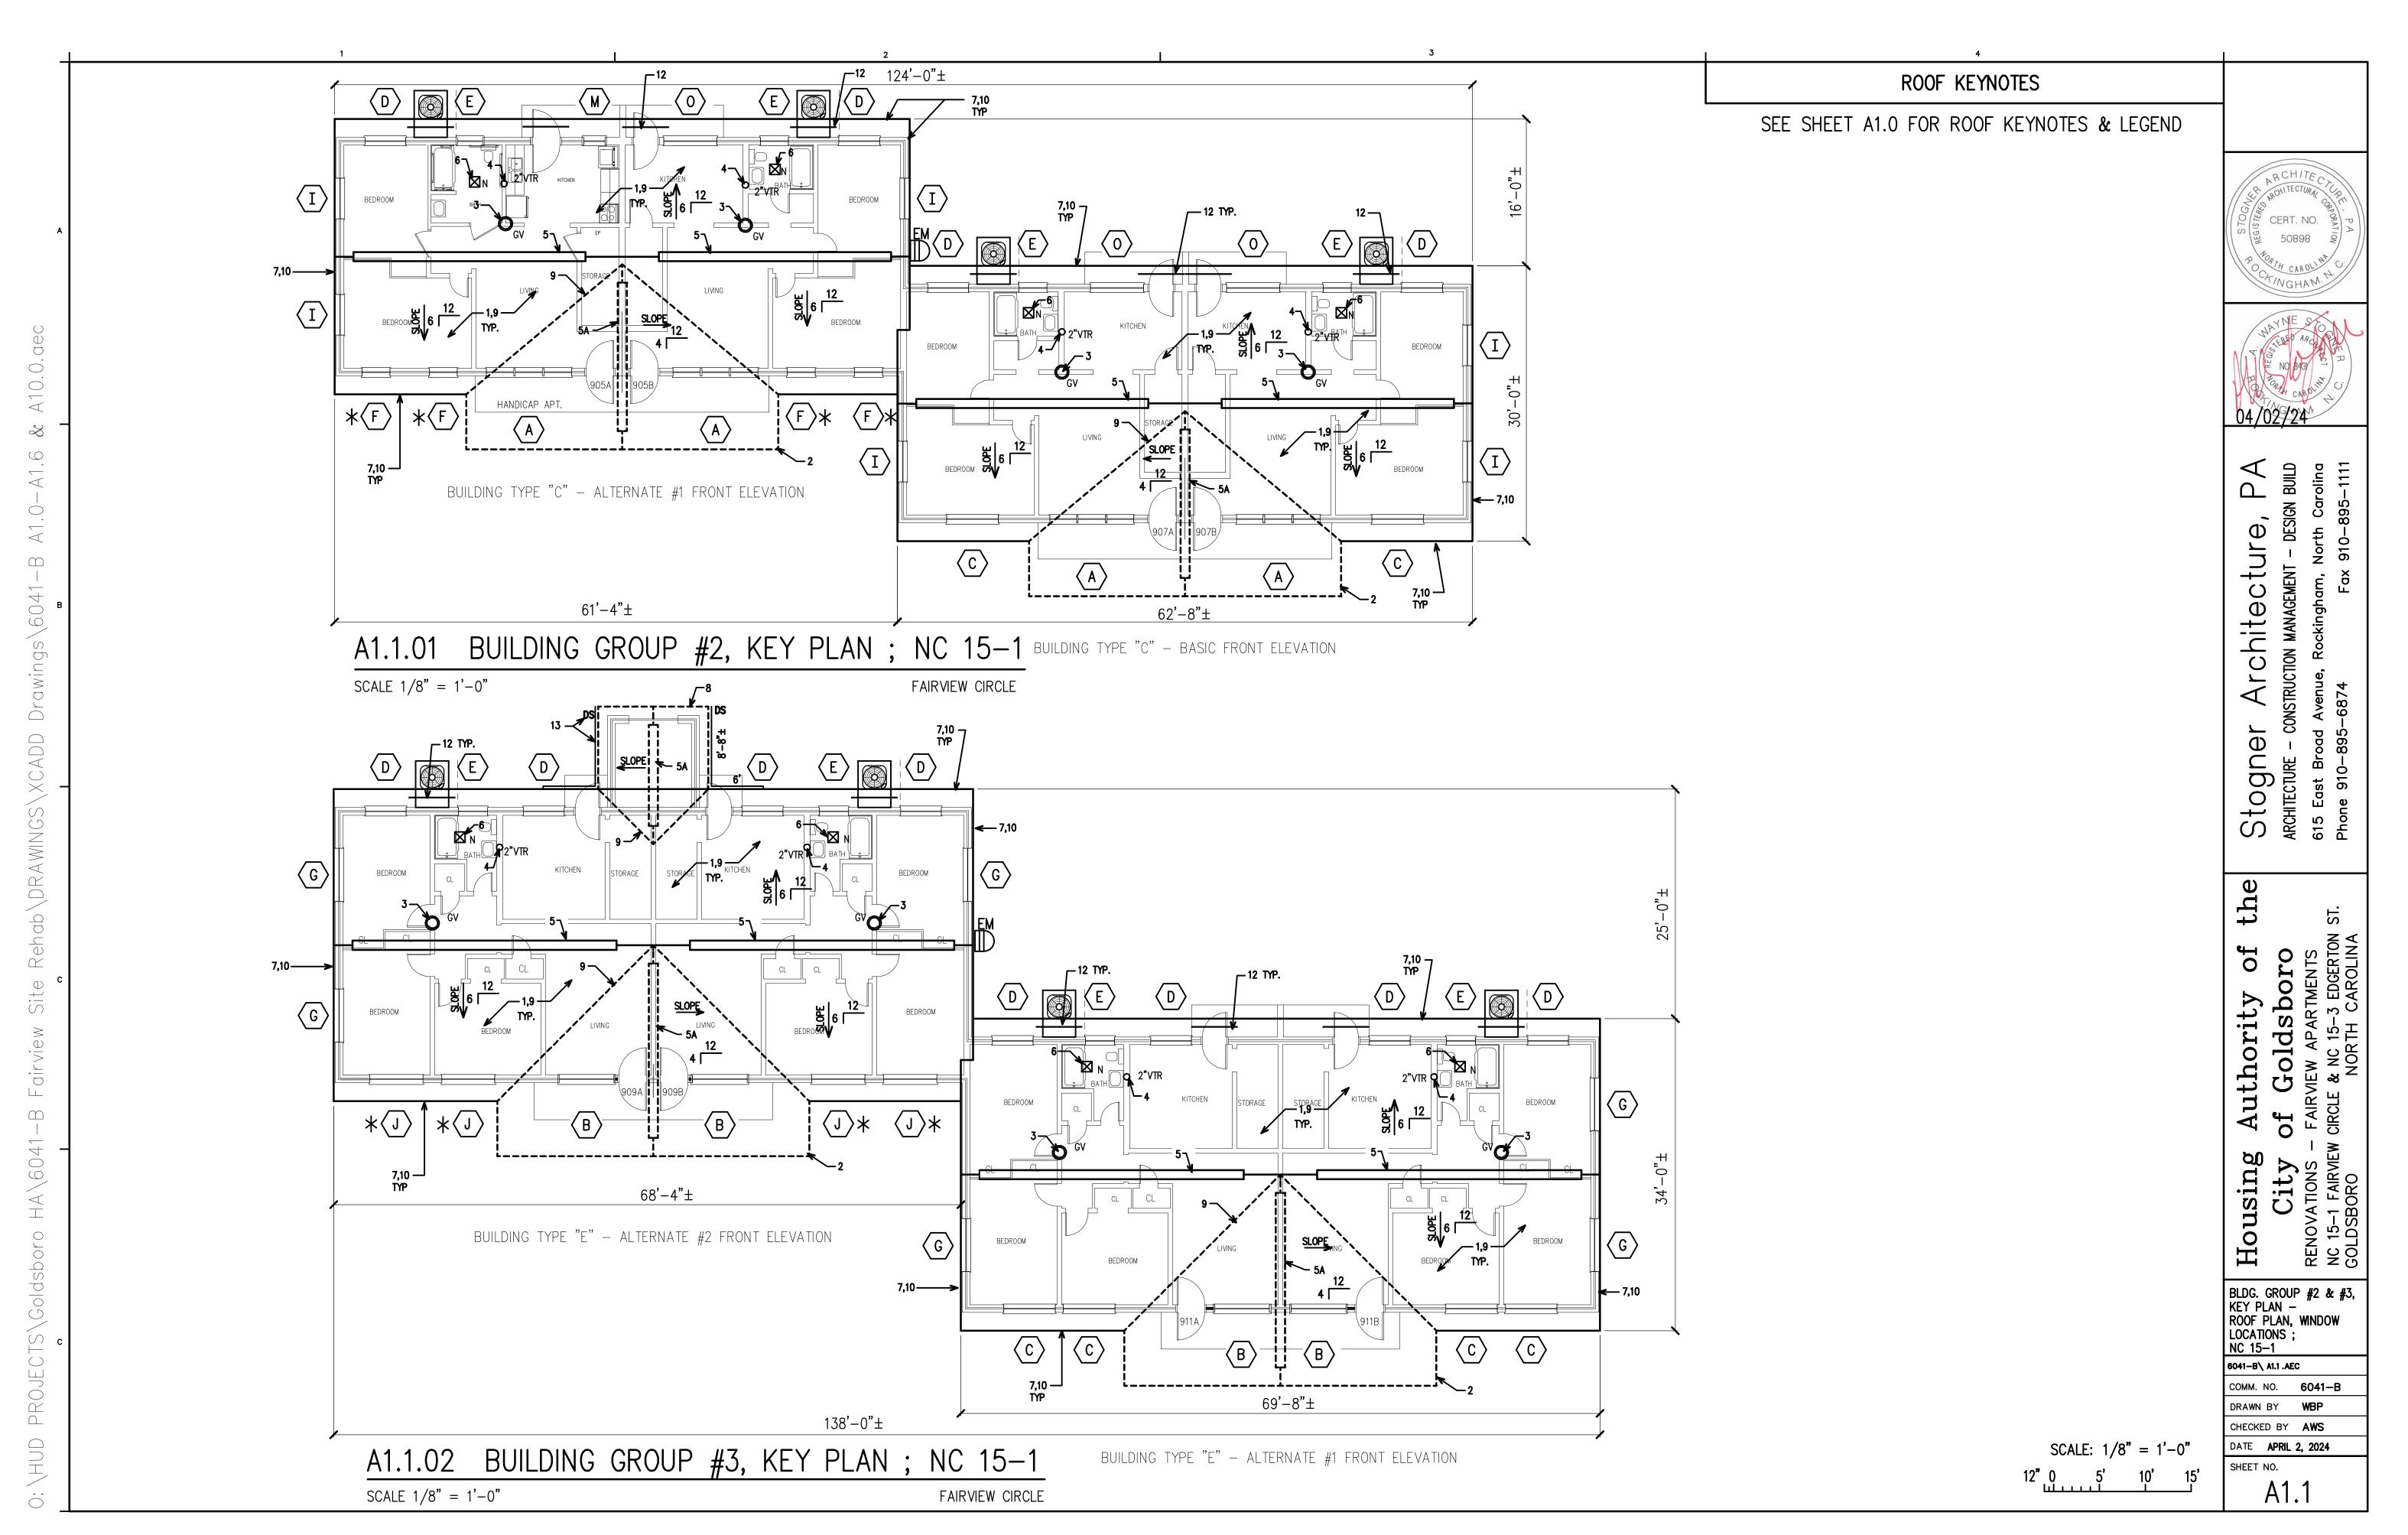

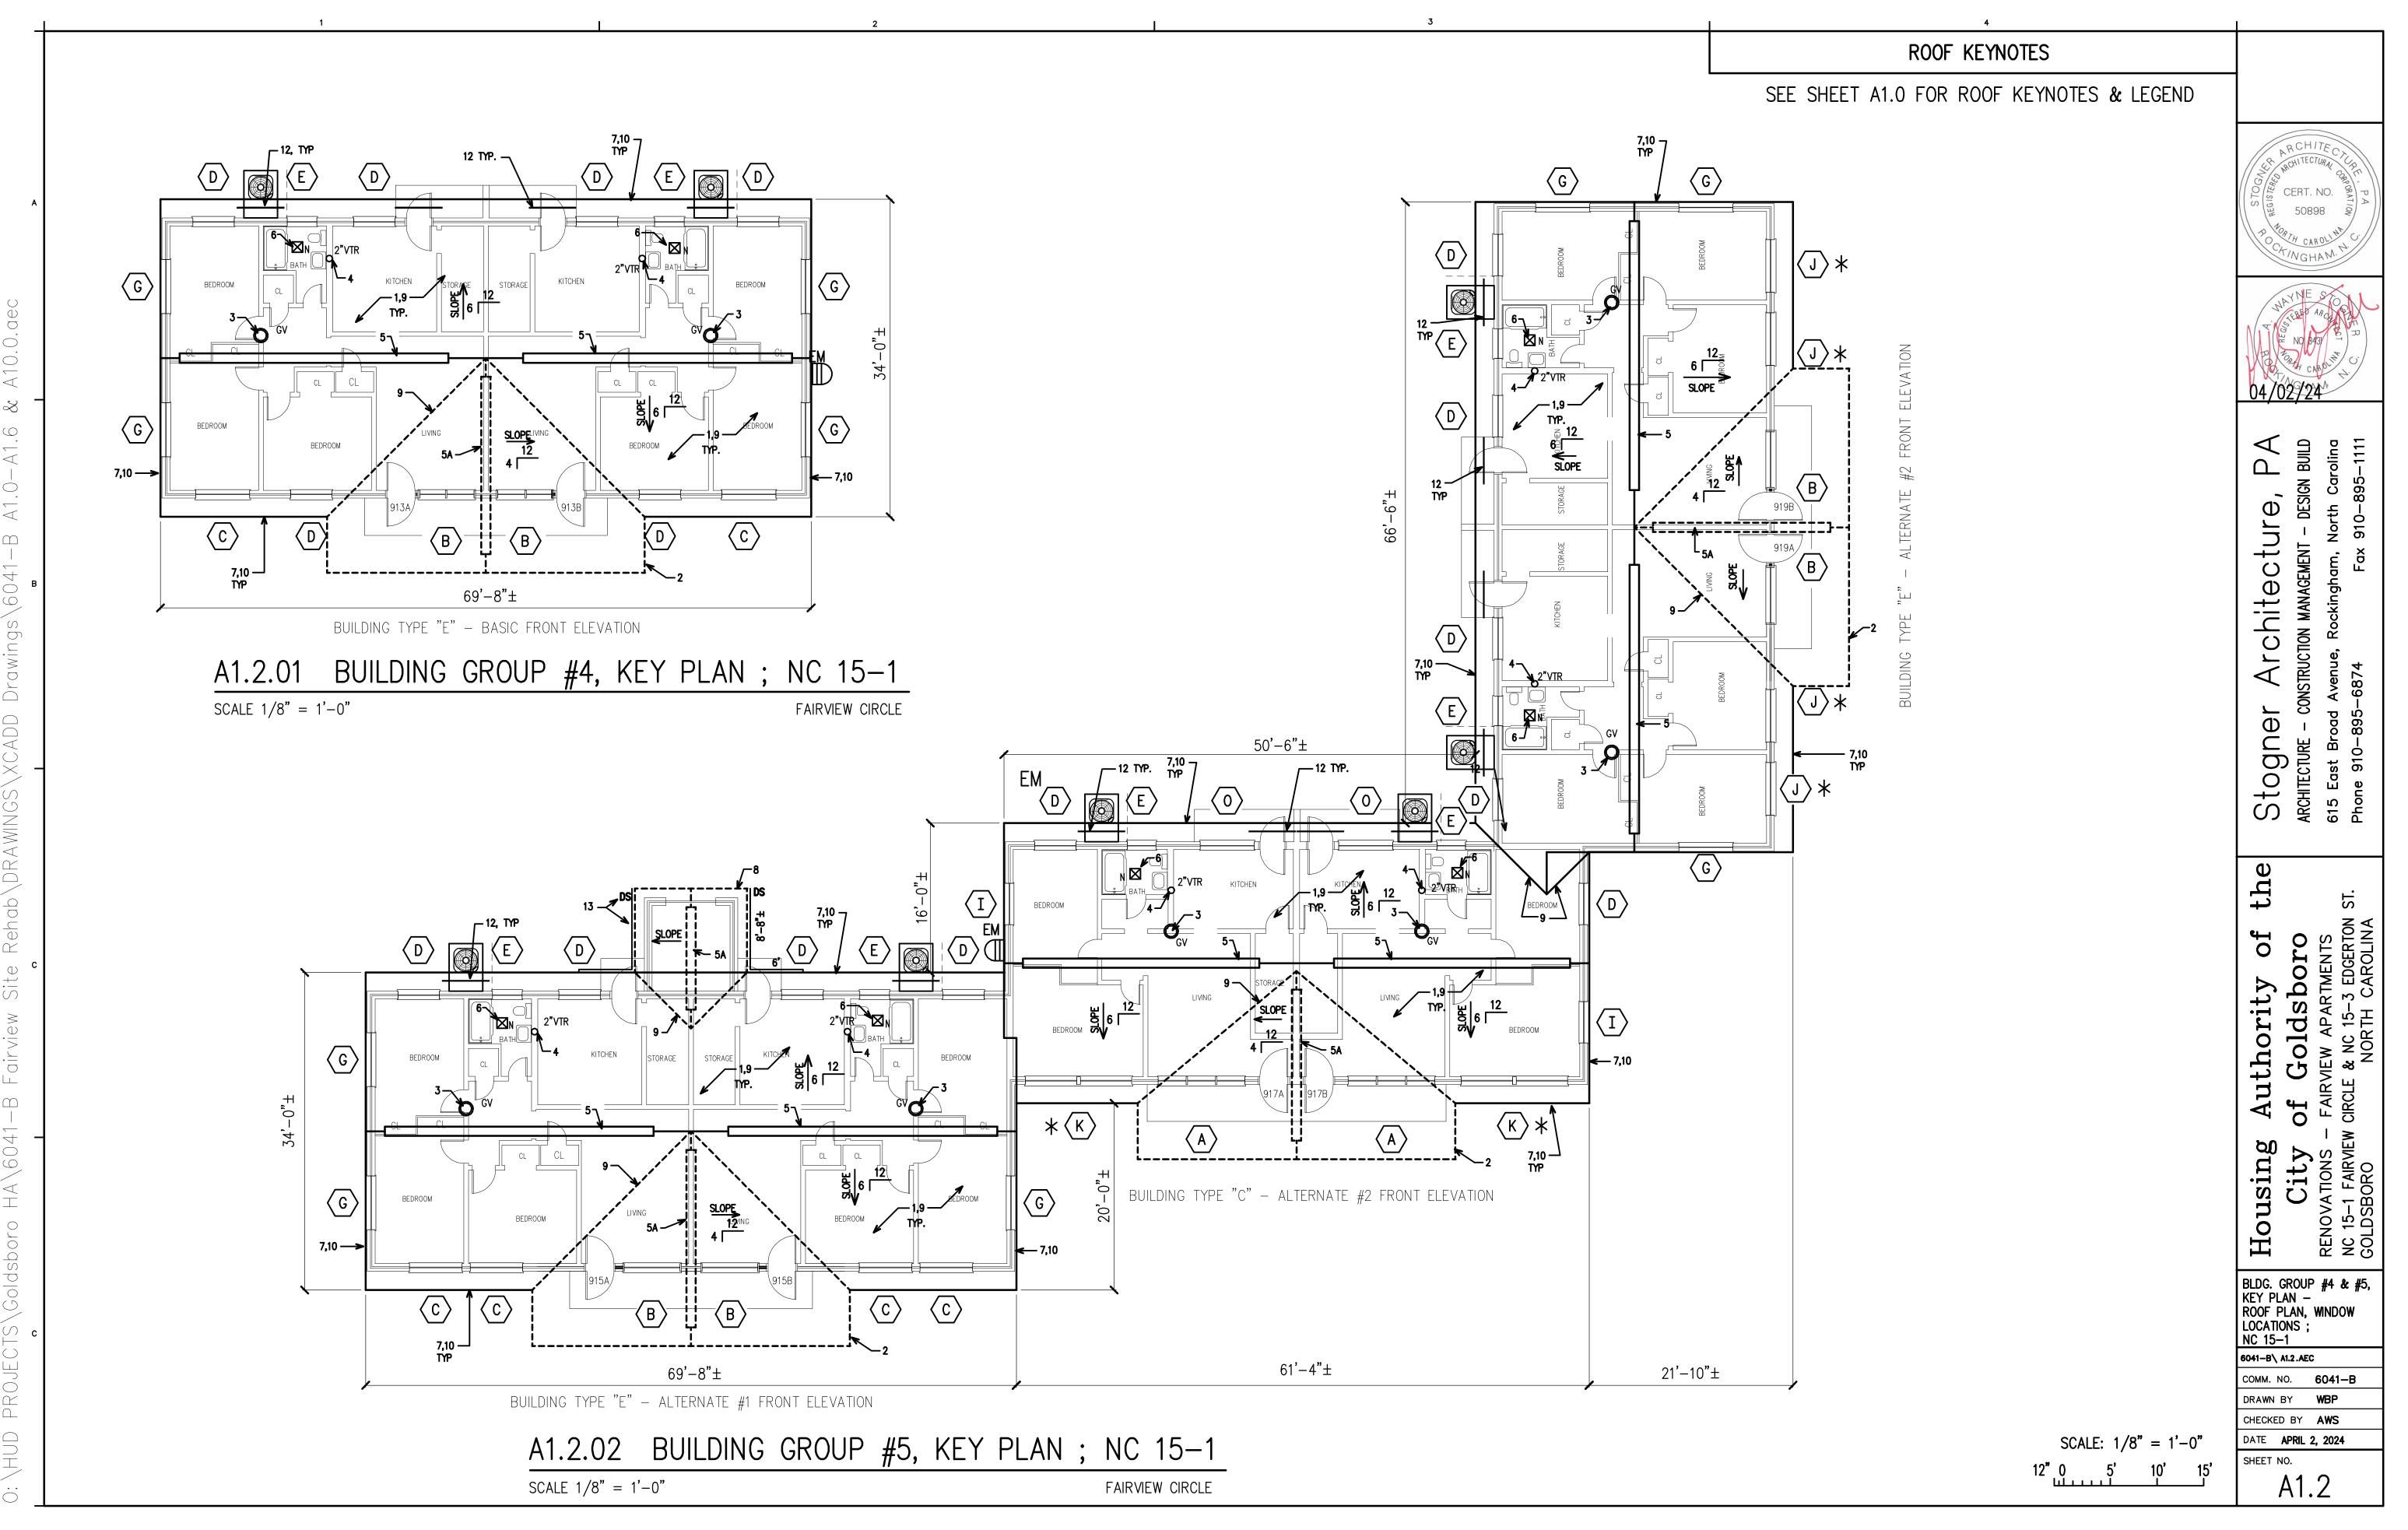

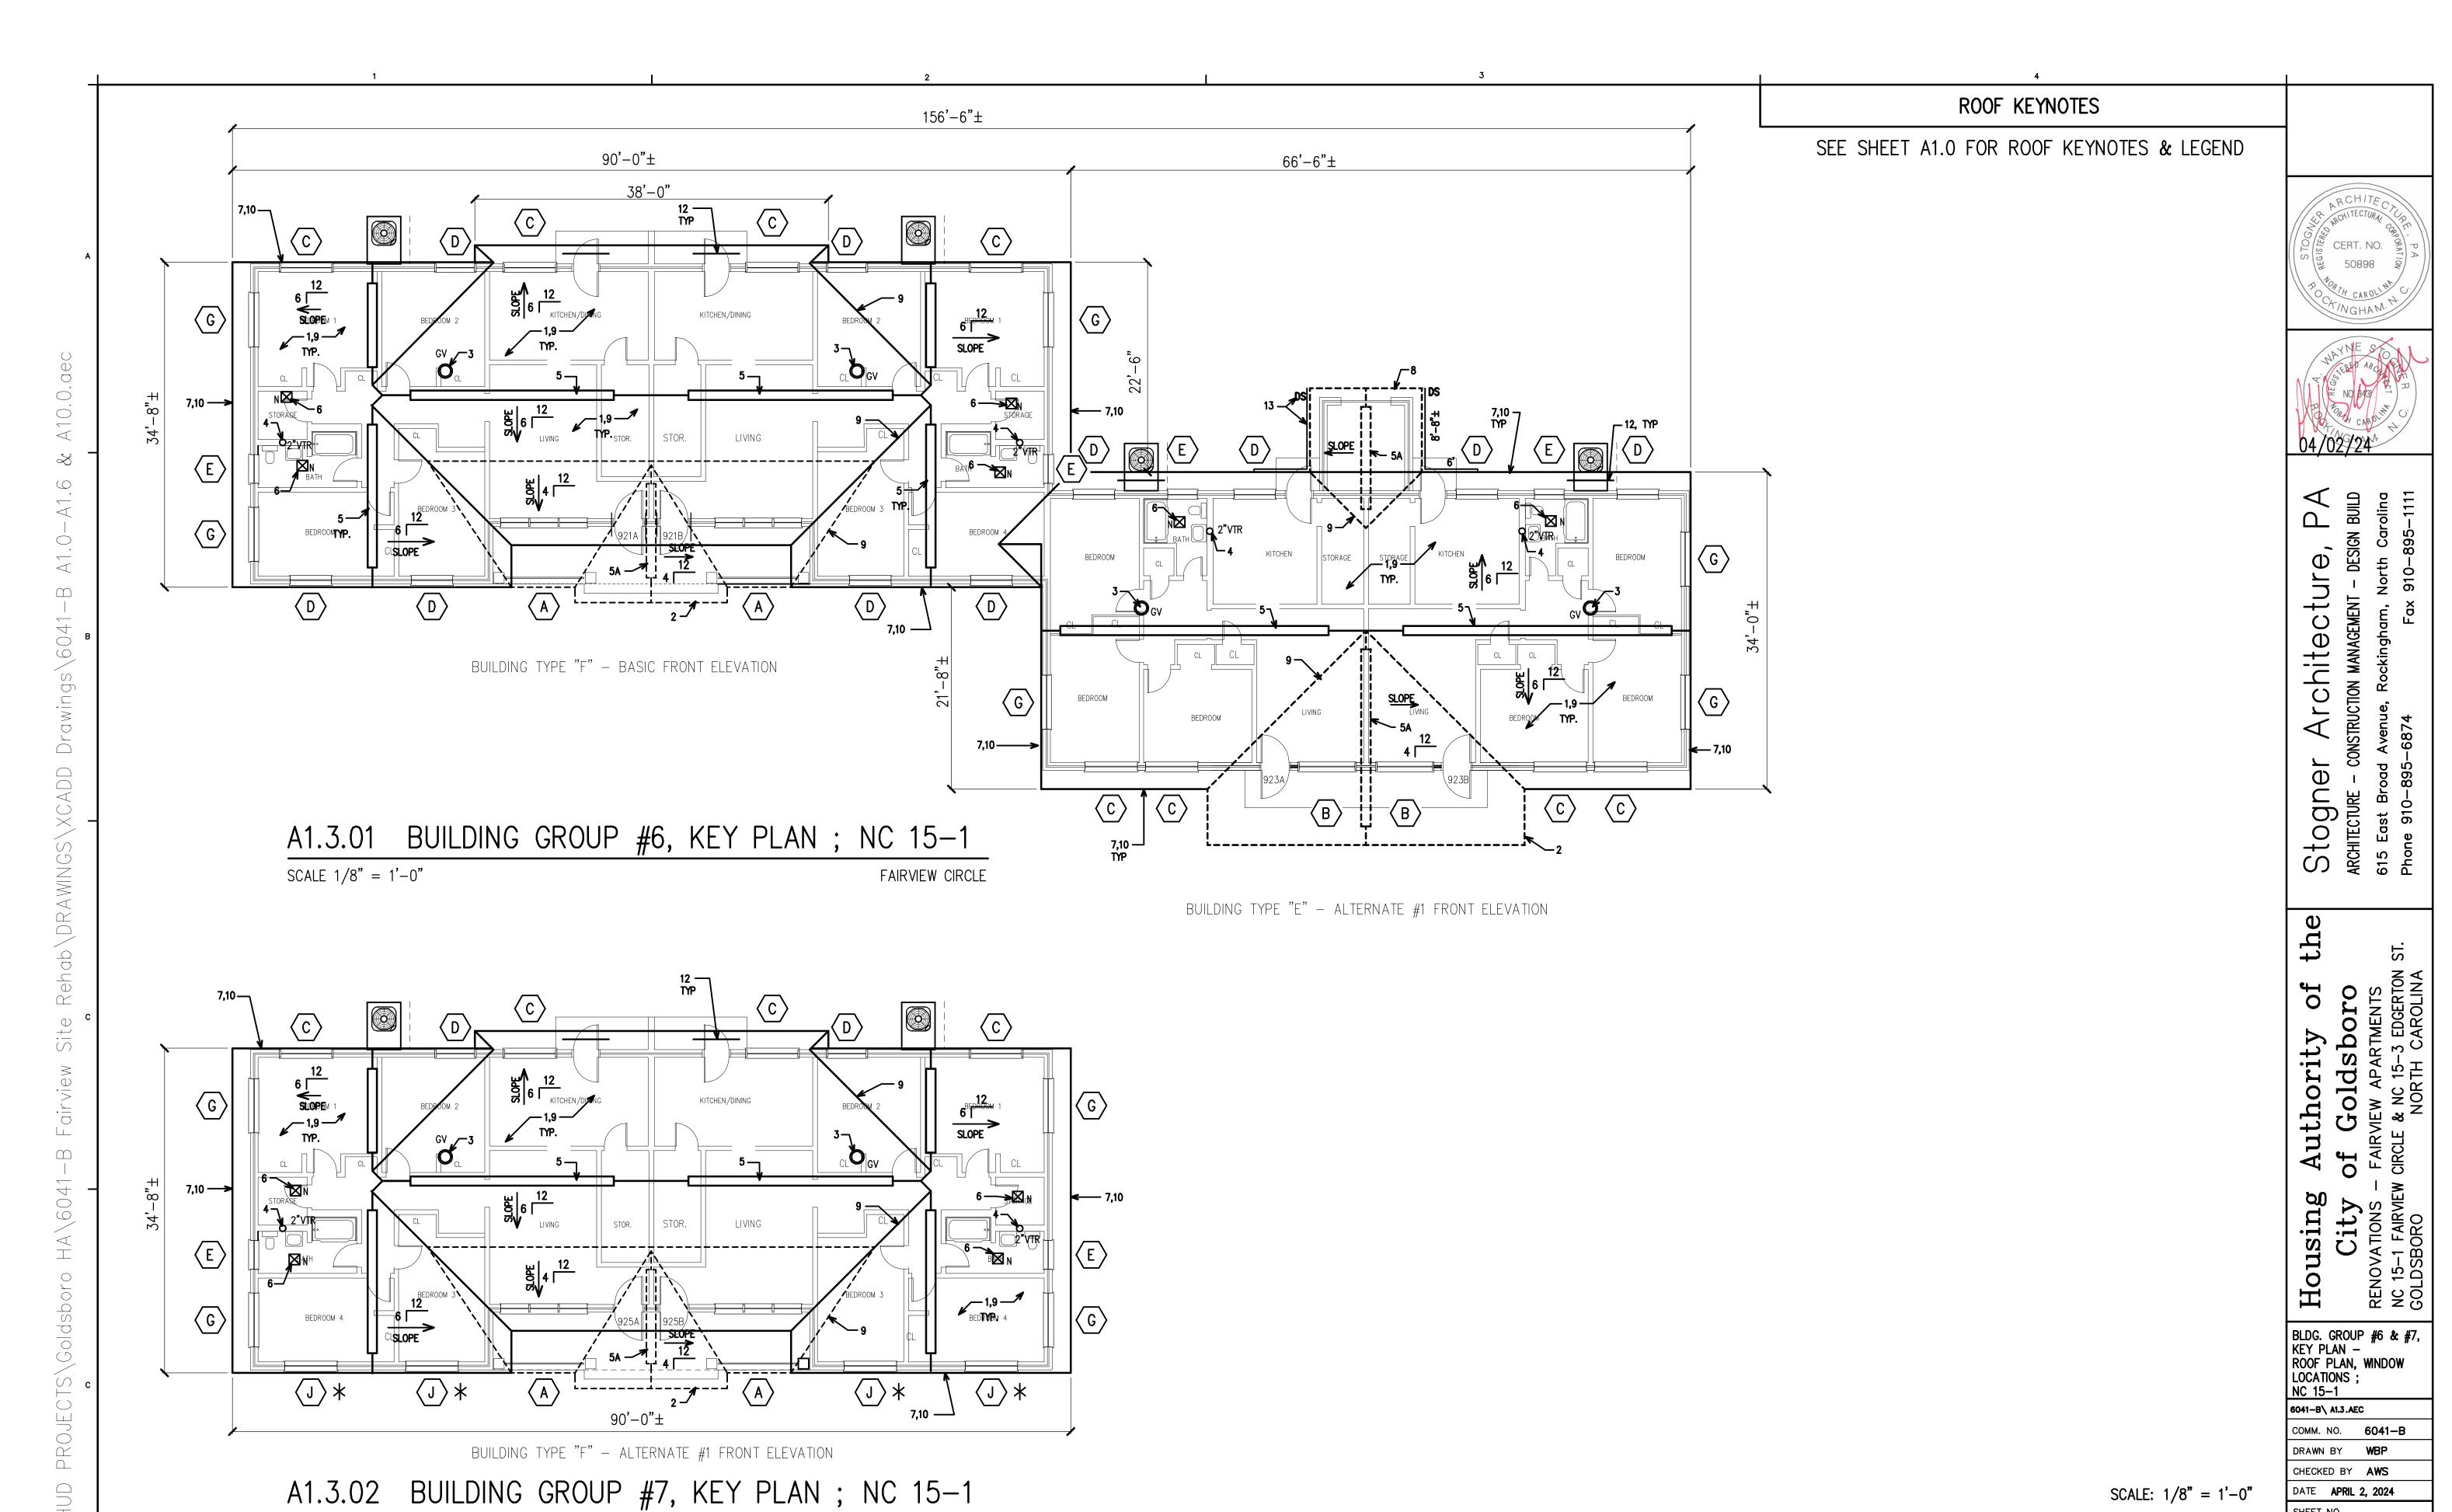

FAIRVIEW CIRCLE


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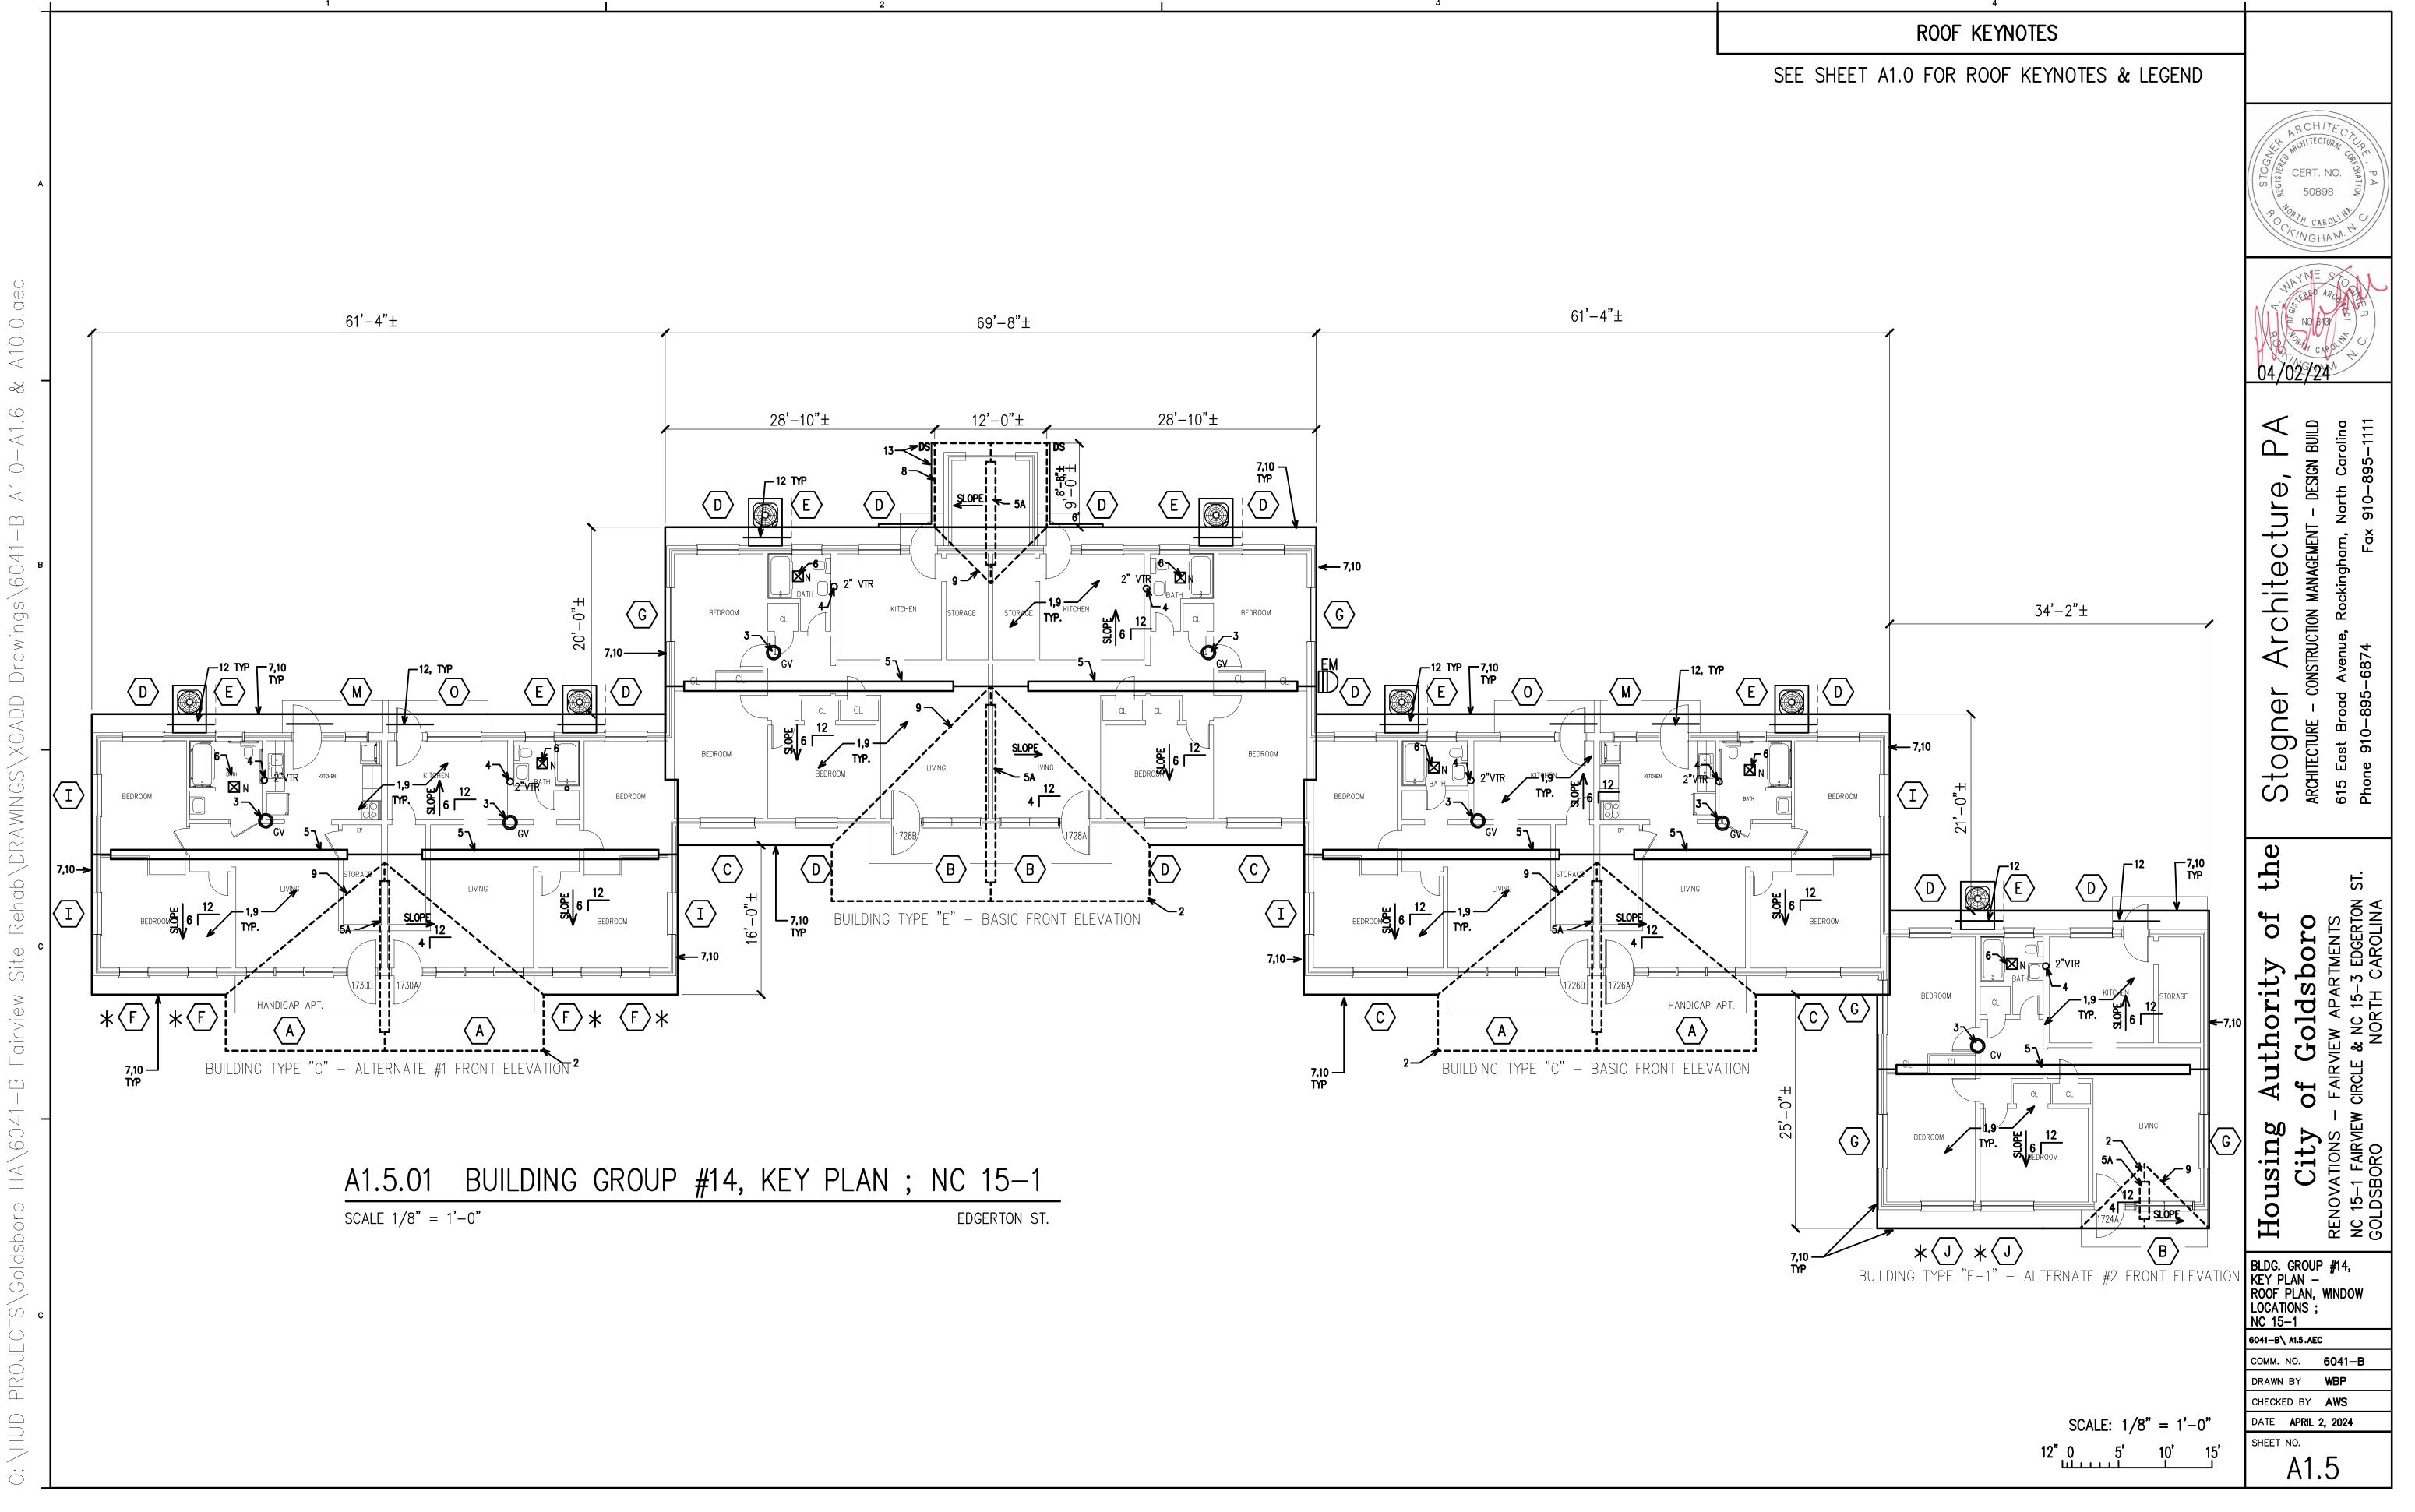
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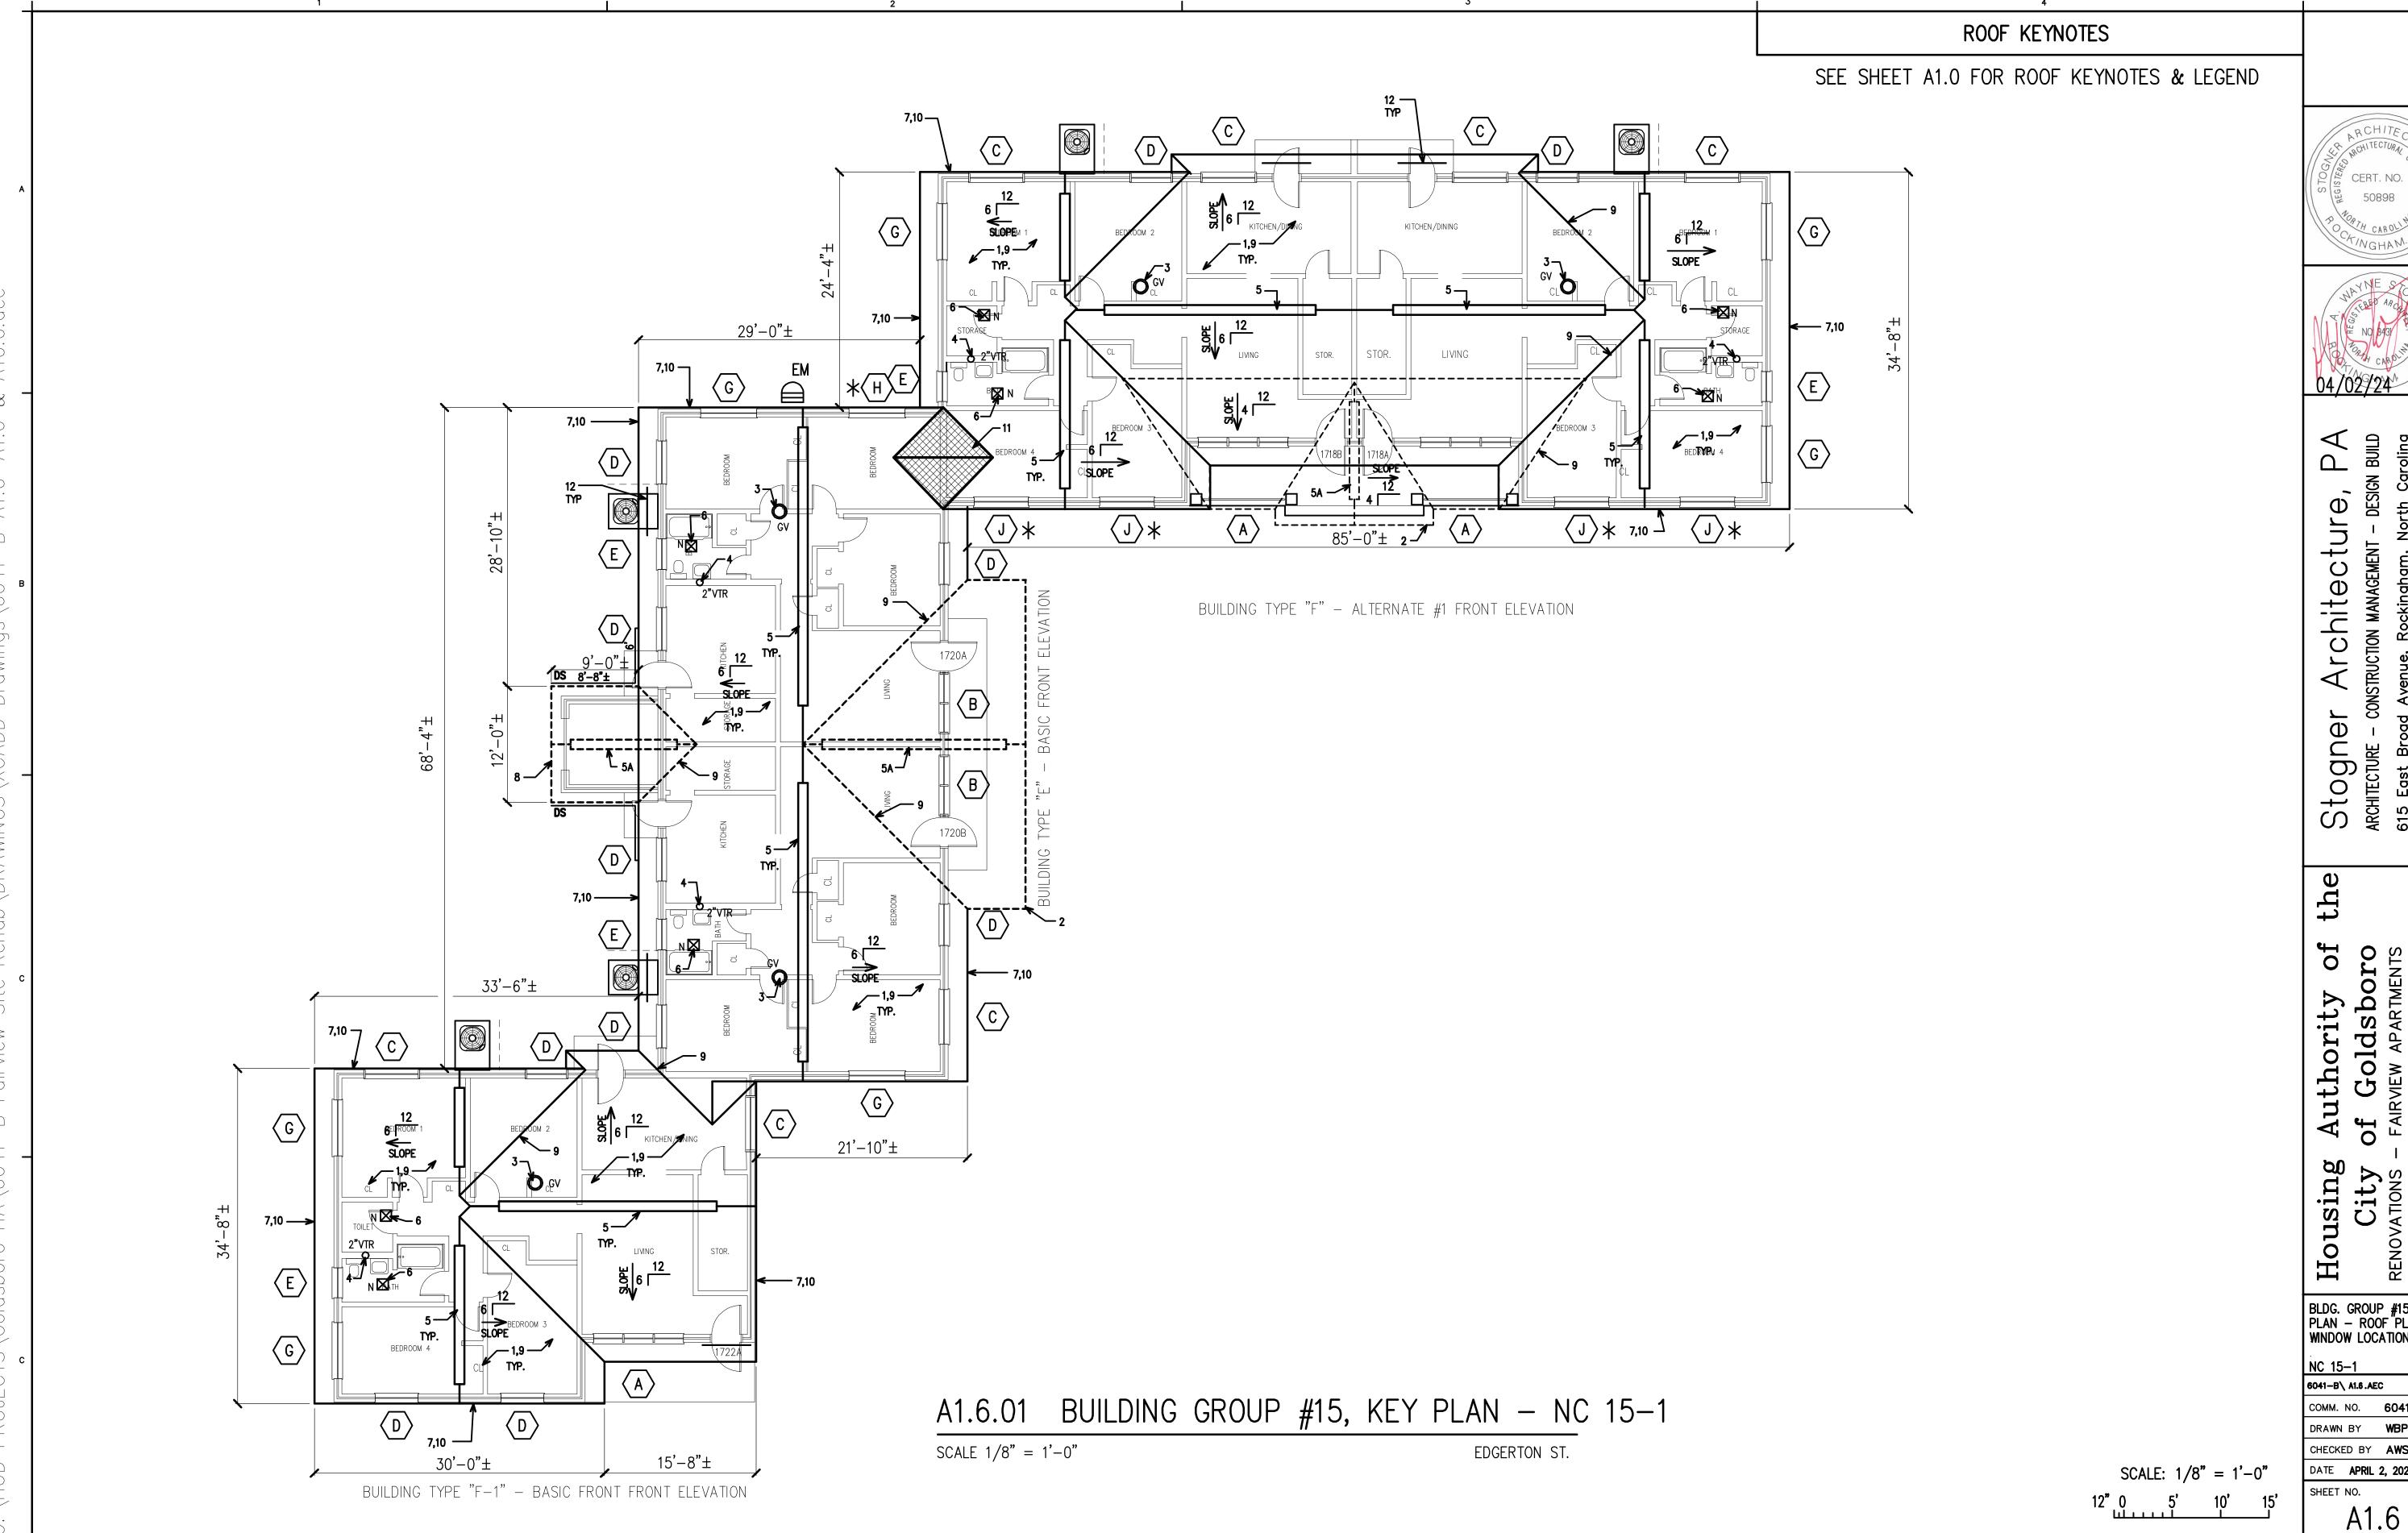
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SHEET NO.

A1.3





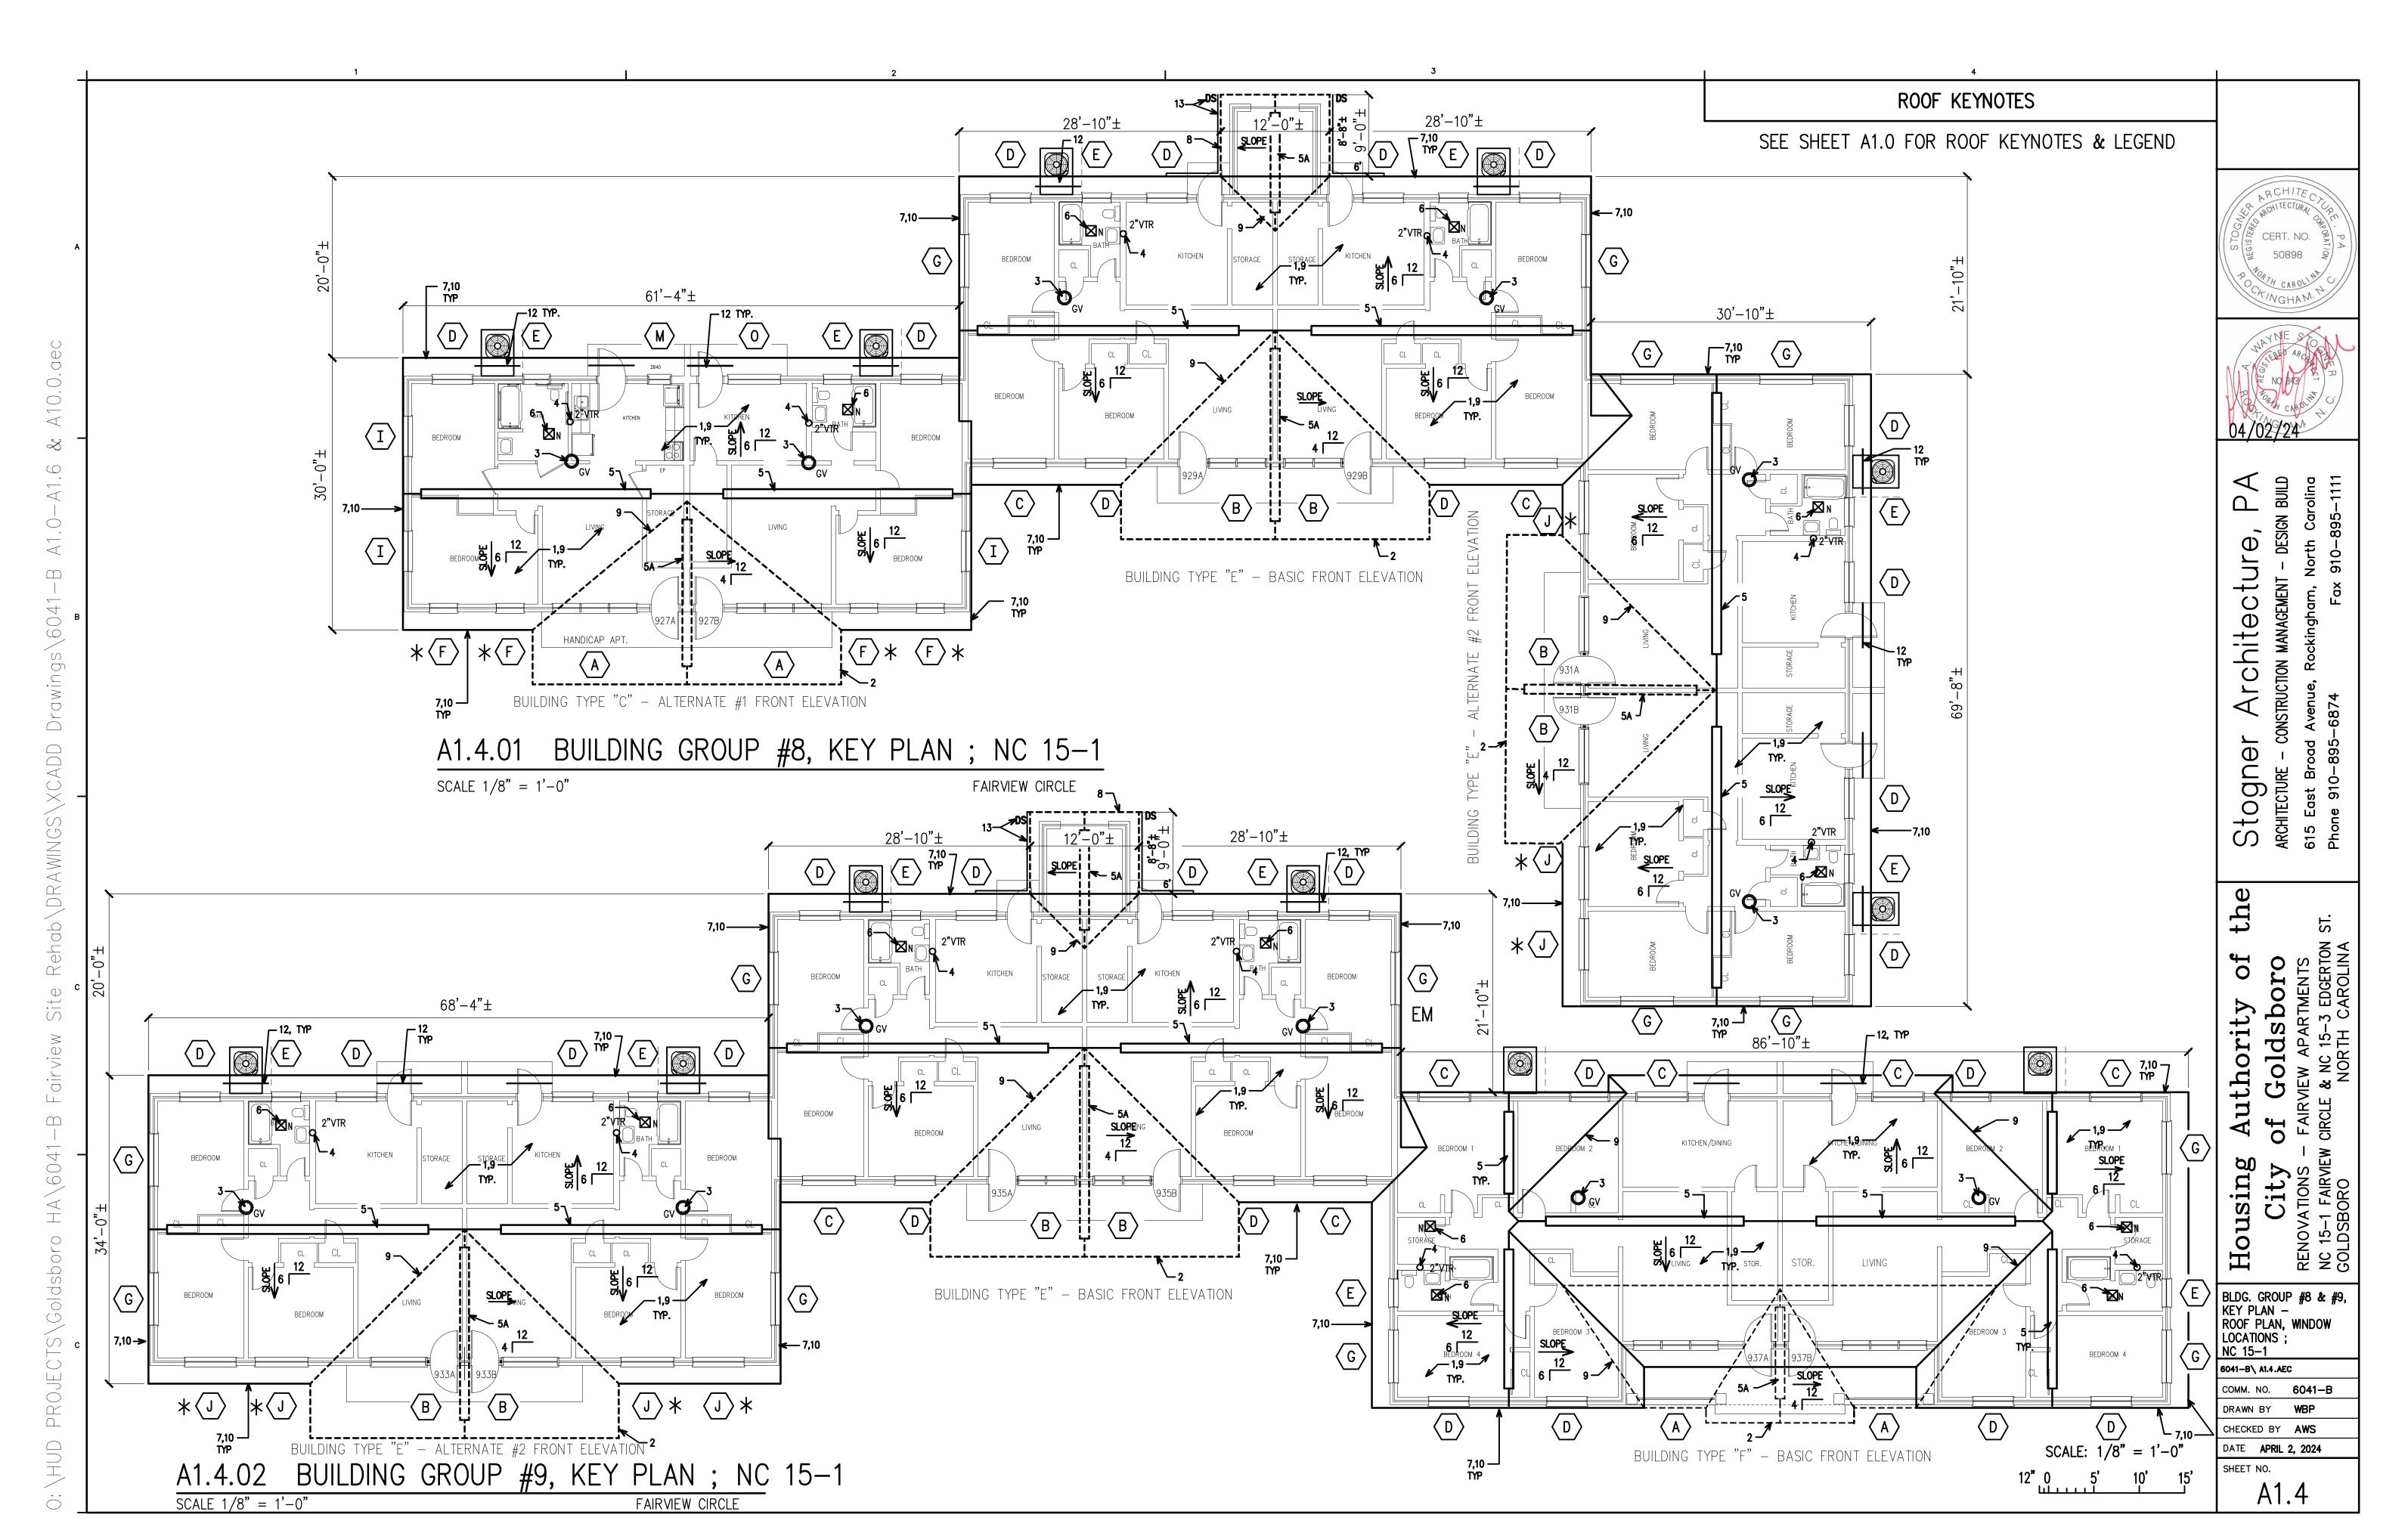

CERT. NO.



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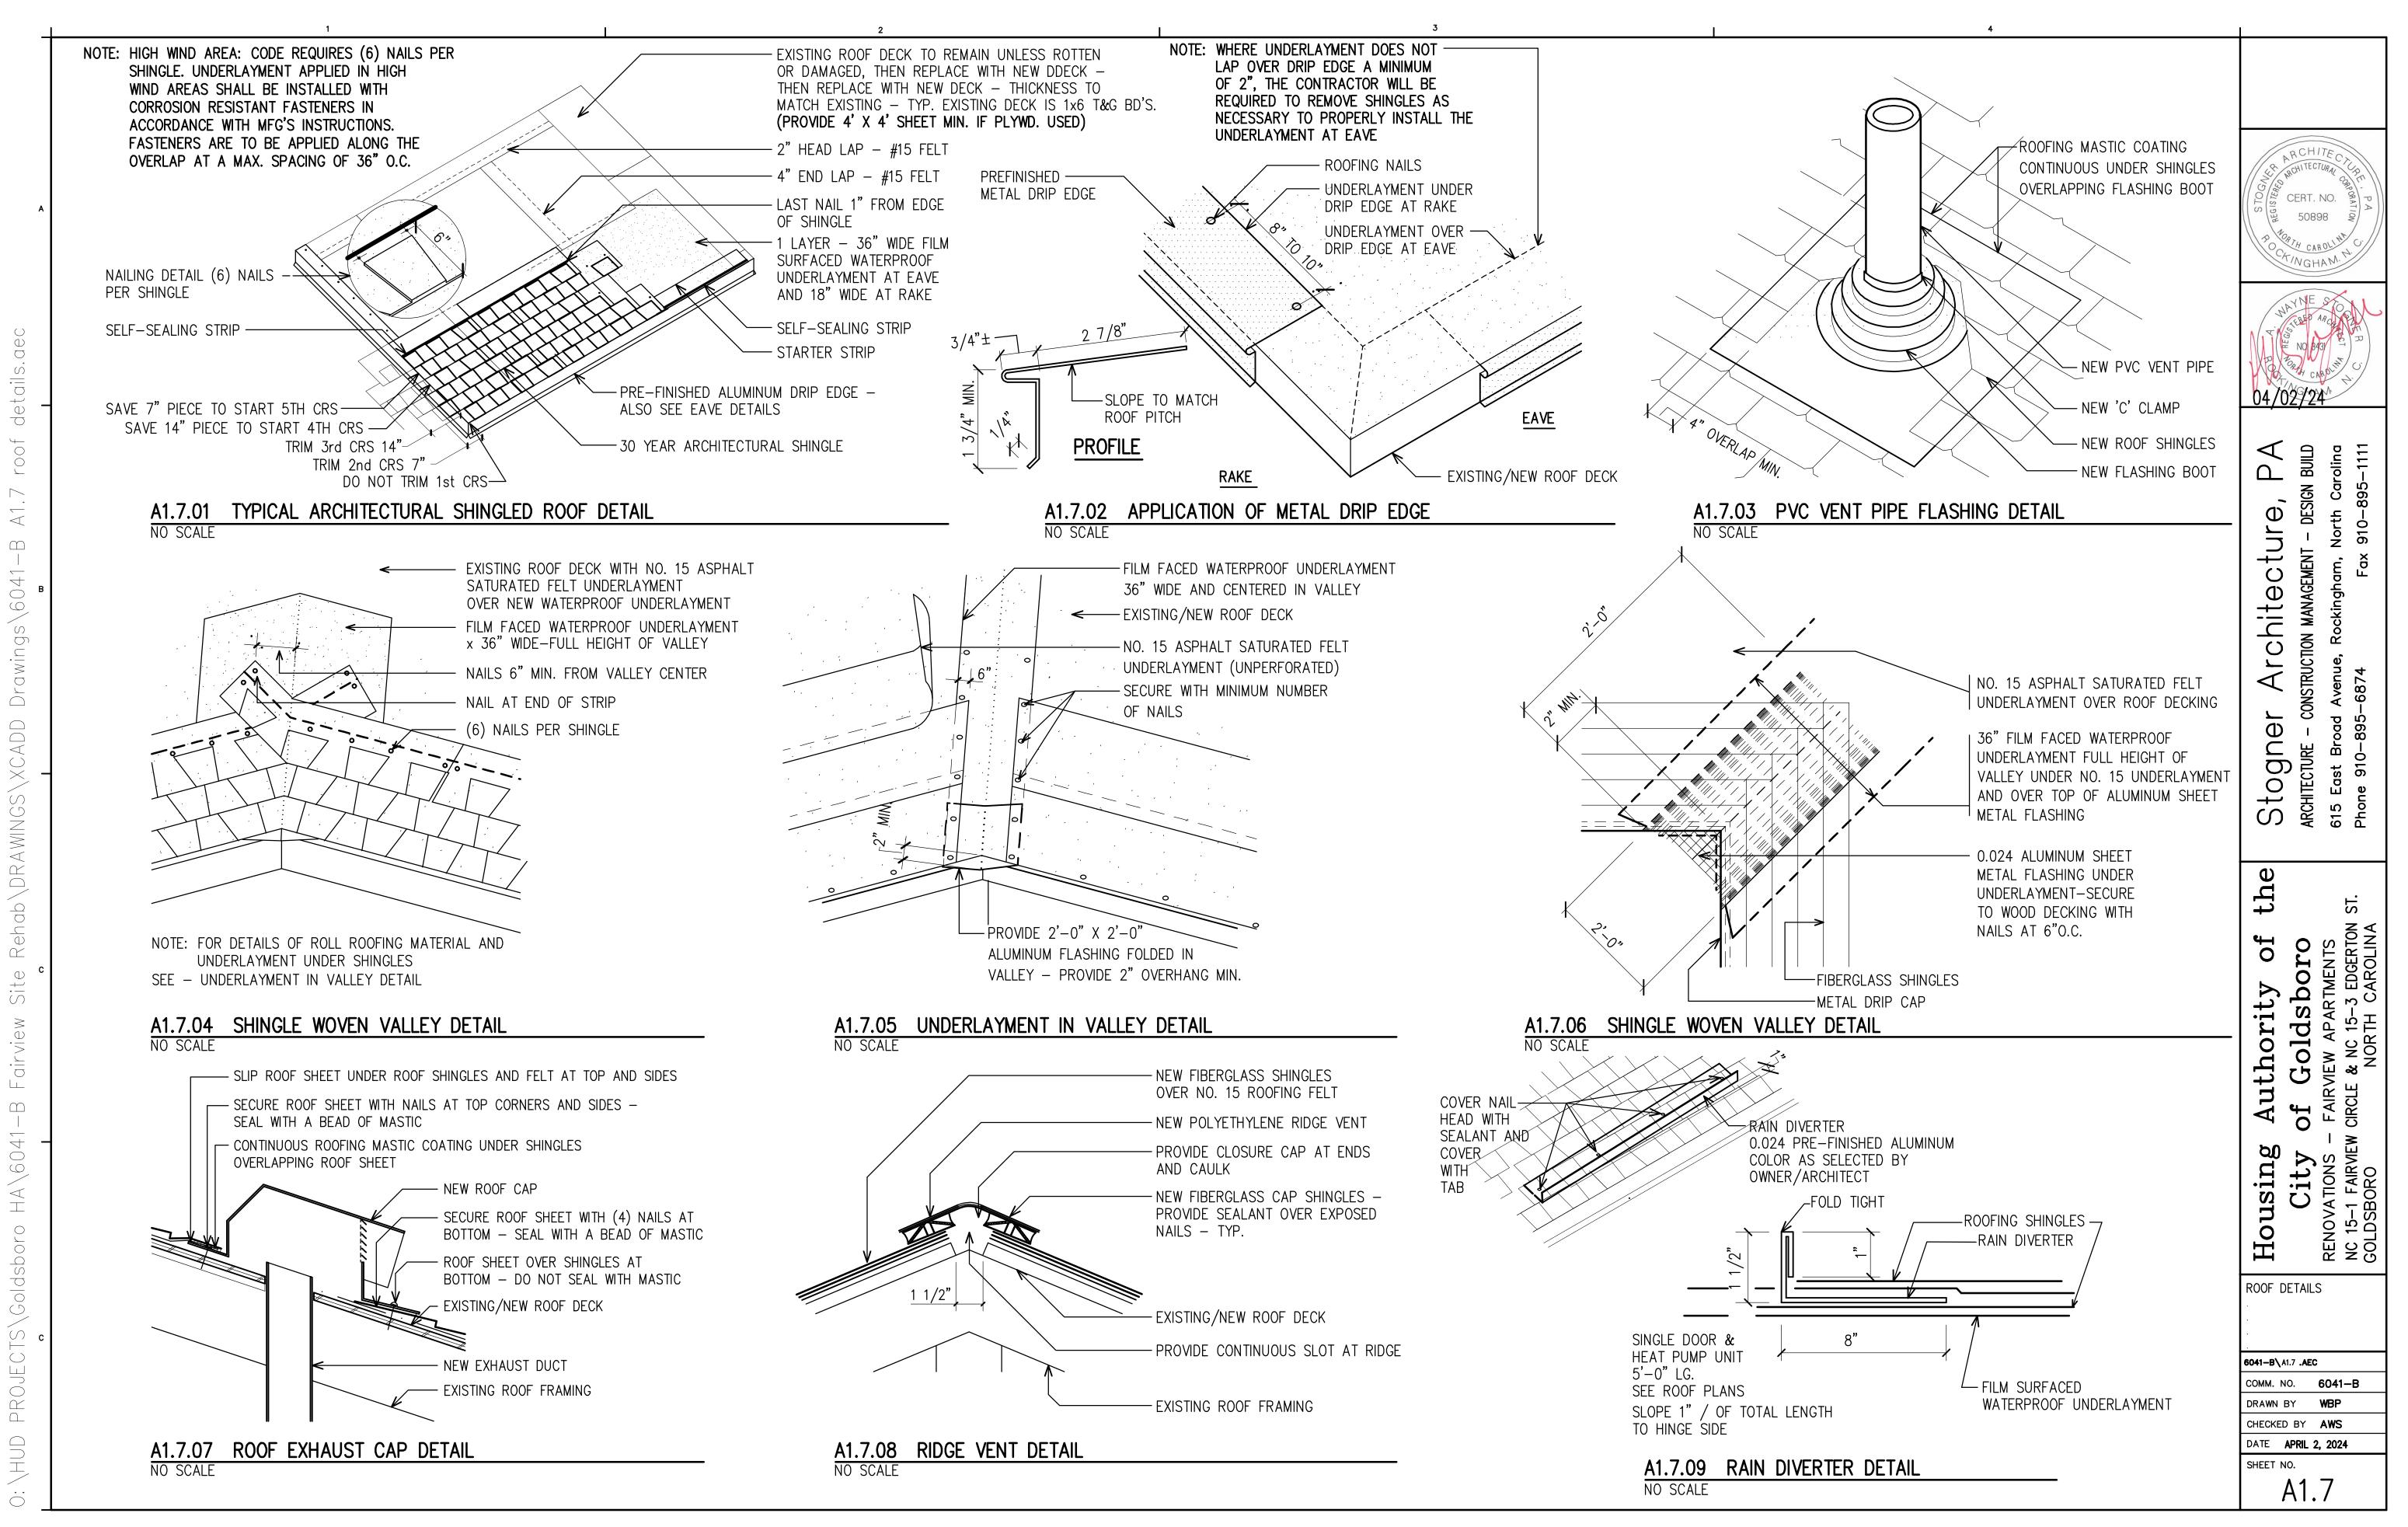
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ARCHITECTURE - COM
615 East Broad A
Phone 910-895-

BLDG. GROUP #15, KEY PLAN — ROOF PLAN, WINDOW LOCATIONS;

NC 15-1 6041-B\ A1.6.AEC


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- D1. REMOVE EXISTING CONCRETE PORCH STOOP COMPLETE.
- D2. EXISTING CONCRETE PORCH STOOP TO REMAIN.
- D3. CUT EXISTING FLOOR SLAB APPROX. 24" WIDE TO REPLACE UNDERSLAB SEWER PIPING & WATER SUPPLY PIPING.
- D4. REMOVE EXISTING PLASTER CEILING & ATTIC INSULATION COMPLETE.
- D5. REMOVE EXISTING ATTIC ACCESS.
- D6. REMOVE EXISTING PLASTER WALLS & FRAMING COMPLETE. D7. REMOVE EXISTING BASE, WALL CABINETS & COUNTERTOPS COMPLETE.
- D8. REMOVE EXISTING SHELVING & BRACKETS COMPLETE.
- D9. REMOVE EXISTING STORM DOORS, ENTRY DOORS, DOOR FRAMES & HARDWARE COMPLETE.
- D10. REMOVE EXISTING INTERIOR DOORS, DOOR FRAMES & HARDWARE.
- D11. REMOVE EXISTING PLUMBING FIXTURES, ASSOCIATED WASTE & SUPPLY PIPING. SEE PLUMBING DRAWINGS.
- D12. REMOVE EXISTING HEATER, DUCT WORK & SUPPLY GRILLS AS OCCURS. SEE MECHANICAL DRAWINGS.
- D13. REMOVE ALL VCT FLOOR TILE & WOOD BASE, ENTIRE APT.
- D14. REMOVE EXISTING CERAMIC TILE & BASE.
- D15. REMOVE EXISTING WINDOWS & TRIM COMPLETE. CUT EXISTING OPENING AS REQUIRED TO PROVIDE NEW WINDOW TO MEET EGRESS REQUIREMENTS. SEE WINDOW SCHEDULE & BUILDING ELEVATIONS FOR LOCATIONS THAT REQUIRE MODIFICATION OF EXISTING OPENINGS.
- D16. REMOVE EXISTING & PROVIDE NEW ROOF SHINGLES & NEW PORCH, SEE SHEETS A1.0 - A1.6 & PORCH DETAILS SHEET A5.0, A5.1 & A5.2
- D17. REMOVE EXISTING FLAT ROOF AT OLD BOILER ROOM & EXISTING VINYL SIDING/PLY. WD. AT OPENING. SEE A1.0-A1.6 & A3.0-A3.1, A3.3.
- D18. AT BLDG. TYPE "E" W/ BASIC FRONT ELEVATION, REMOVE EXISTING VINYL SIDING BETWEEN FRONT WINDOWS.
- D19. REMOVE EXISTING WALL MT'D MAILBOX & FASTENERS, FILL HOLES W/ MORTAR TO MATCH BRICK.





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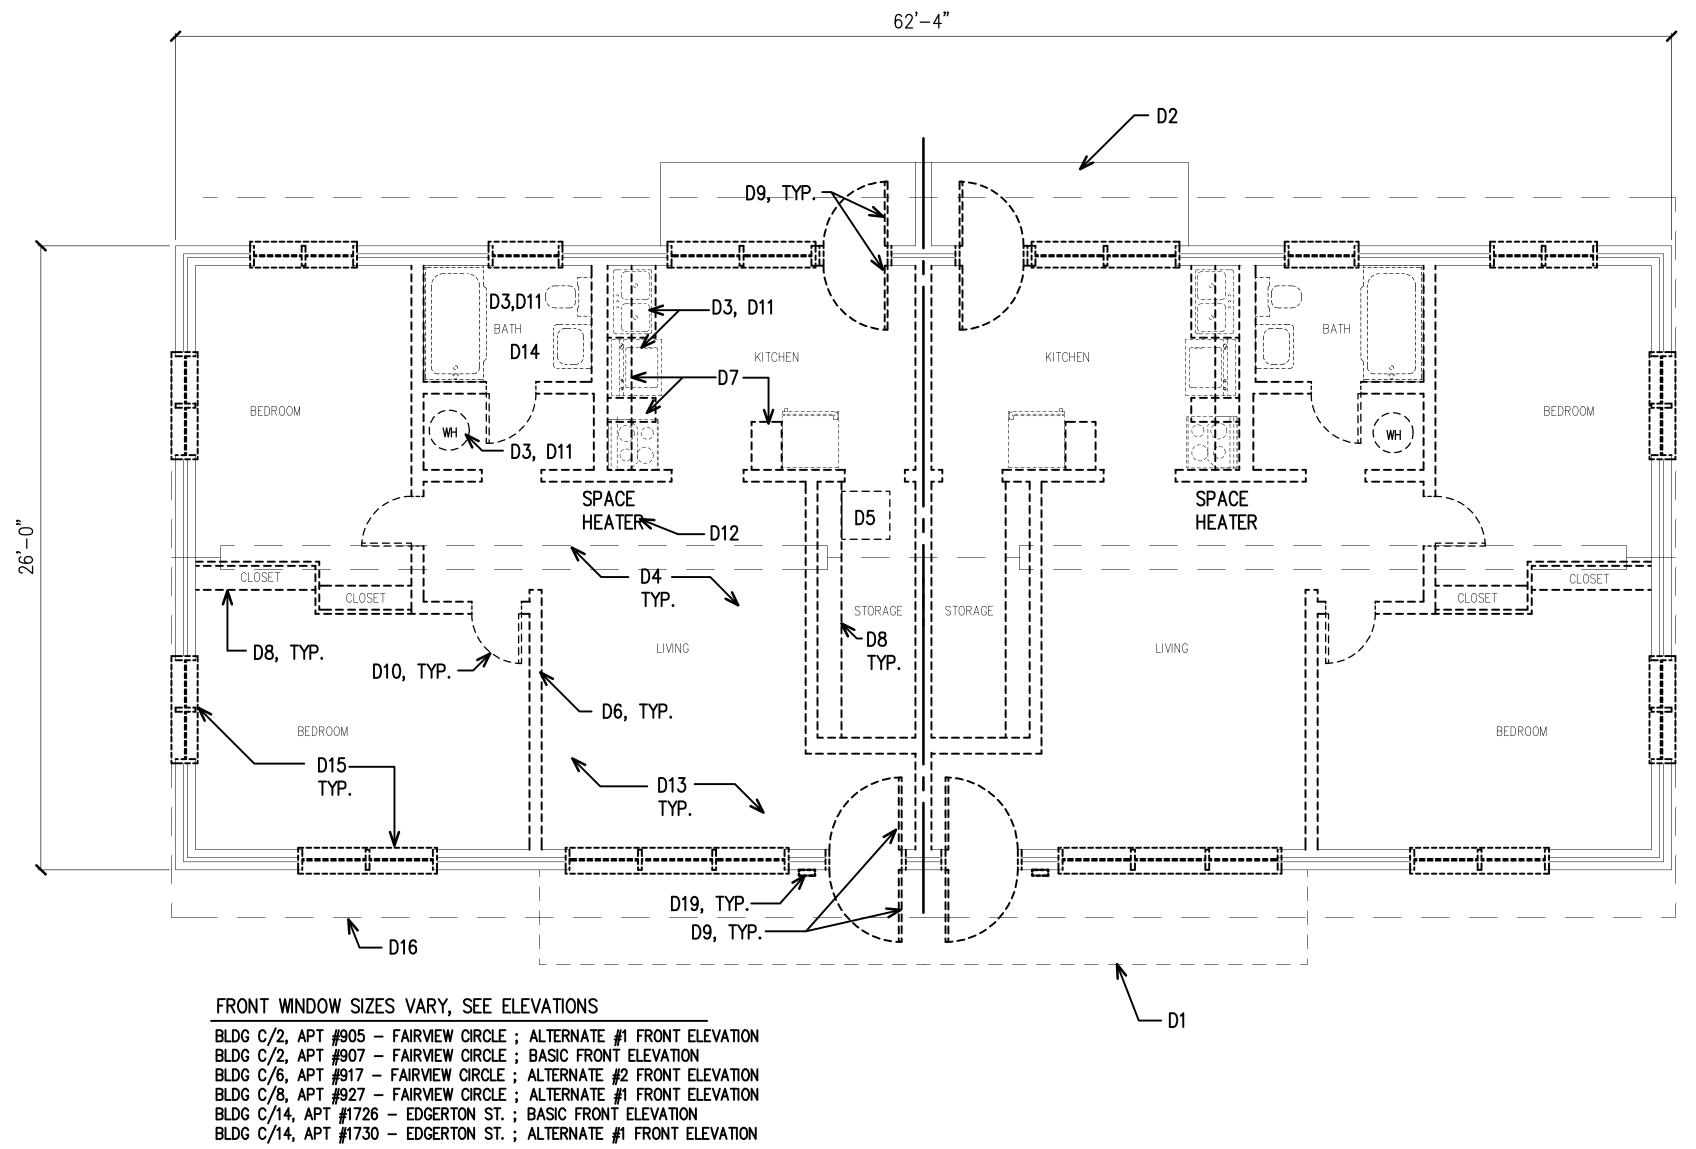
**DEMOLITION FLOOR PLAN** TWO BEDROOM UNIT -BUILDING TYPE "C"; NC 15-1

6041-B\A2.0 .AEC

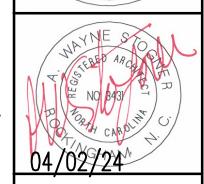COMM. NO. **6041-B** DRAWN BY WBP

CHECKED BY AWS DATE APRIL 2, 2024

SHEET NO. A2.0



BUILDING TYPE 'C'

SCALE:  $1/4^{\circ} = 1'-0''$ 


### RENOVATION KEYNOTES

- R1. PROVIDE NEW 4" THK., 3000 PSI CONCRETE PORCH SLAB. SEE A5.0, A5.1 & A5.2 FOR REVISED PORCH/ROOF PLAN.
- R2. PROVIDE NEW SEWER DRAIN, WATER SUPPLY PIPING. BACKFILL AND COMPACT TO 98%, TREAT TRENCH & ENTIRE BLDG. FOR TERMITES. PROVIDE 4" STONE, VAPOR BARRIER, DRILL EXISTING SLAB @ 24" O.C., 6" DEEP & PROVIDE 12" LONG #5 BAR, POUR NEW 4" THK., 3000 PSI CONCRETE FLUSH W/ EXISTING SLAB. PROVIDE 4"ø CLEANOUT @ EXTERIOR OF BLDG., TIE TO EXISTING SEWER. SEE PLUMBING DRAWINGS.
- R3. PROVIDE NEW 1/2" GYP. BD. CEILING THROUGHOUT & R38 INSULATION IN ATTIC. PROVIDE INSULATION STOPS AS REQ'D.
- R4. PROVIDE NEW 20"X30" MIN. CLEAR ATTIC ACCESS. FIELD VERIFY EXACT LOCATION.
- R5. PROVIDE 1 1/2" RIGID INSULATION BOARD BETWEEN MTL. "Z" STRIPS MT'D VERTICAL @ 16" O.C. - TYPICAL AT OUTSIDE WALLS. PROVIDE FASTENERS TO EXTEND INTO BLOCK WALL BEYOND PLASTER. PROVIDE 1/2" GYP. BD. ON "Z" STRIPS, COORDINATE WORK W/ ELECTRICAL & PLUMBING CONTRACTOR.
- R5A. PROVIDE NEW 1HR. FIRE RATED SEPARATION WALL (1) LAYER 5/8" FIRE RATED GYP. BD. EA. SIDE ON 2X6 WD. STUDS @ 16" O.C., FASTEN GYP. BD. 8" O.C. PARTITION TO RUN FROM FRONT WALL TO REAR WALL CONTINUOUS & TOP OF FINISH FLOOR TO UNDERSIDE OF ROOF DECK. (DESIGN BASIS UL305) PROVIDE (1) LAYER OF 5" SOUND BATT INSULATION TO 2FT. ABOVE CEILING. CONTRACTOR SHALL PROVIDE UL RATED DEVICES FOR RATING REQUIRED STAGGER PENETRATIONS & FIRESTOP.
- R5B. PROVIDE 2X4 WD. FRAMING WALL W/ PRESSURE TREATED PLATE & 1/2" GYP. BD. EA. SIDE. PRIME & PAINT (2) COATS.
- R5C. PROVIDE 2X4 WD. FRAMING WALL W/ PRESSURE TREATED PLATE & 1/2" MOLD & MOISTURE RESISTANT GYP. BD. AT LAUNDRY & MECHANICAL ROOMS. PRIME & PAINT (2) COATS.
- R6. PROVIDE NEW WD. CLOSET SHELF, PRIME & PAINT. AT TYP. BEDROOM & HALL CLOSET (1) SHELF & ROD, AT STORAGE & LINEN CLOSET (4) SHELVES.
- R7. PROVIDE NEW WALL & BASE CABINETS, NEW SOLID SURFACE COUNTERTOPS W/ SPLASH.
- R8. PROVIDE NEW HOLLOW MTL. DOOR FRAME, INSULATED MTL. DOOR, HARDWARE & WEATHER STRIPPING. PROVIDE NEW STORM DOORS.
- R9. PROVIDE NEW WD. DOOR FRAME, SOLID CORE WD. DOOR & HARDWARE. PROVIDE DOOR STOPS AT WALL WHEN OPEN 90° TO ADJACENT WALL.
- R10. PROVIDE NEW PLUMBING FIXTURES, WASTE & SUPPLY PIPING. SEE PLUMBING DRAWINGS. PROVIDE MOLD & MOISTURE RESISTANT
- GYP. BD. AT LAUNDRY & MECHANICAL ROOMS. R11. PROVIDE NEW HVAC & ASSOCIATED WORK. SEE MECHANICAL DRAWINGS. NEW PAD SIZE TO BE (42"x60") MIN. PROVIDE MOLD & MOISTURE
- RESISTANT GYP. BD. AT LAUNDRY & MECHANICAL ROOMS. R12. PROVIDE NEW LVT (BASE BID) & VCT (ALT BID), PAINTED WD. BASE & SHOE MOLD THROÙGHOUT ÁPARTMENT.
- R13. PROVIDE NEW CERAMIC TILE & BASE AT BATHROOMS.
- R14. PROVIDE NEW VINYL REPLACEMENT WINDOWS, SEE BLDG. KEY & ELEVATIONS FOR WINDOW SIZE & LOCATIONS.
- R15. PROVIDE NEW FULL PET SCREEN IN ALUMINUM FRAME W/ HARDWARE AT ALL WINDOWS.
- R16. PROVIDE NEW SHUTTERS AT WINDOWS SHOWN ON ELEVATIONS.
- R17. PROVIDE NEW PORCH, OVERHANG & ROOF.
- SEE SHEETS A1.0 A1.6 & PORCH DETAILS A5.0, A5.1 & A5.2. R18. PROVIDE NEW WD. TRUSSES, WD. DECKING, UNDERLAYMENT & SHINGLES
- PROVIDE NEW SHEATHING, SIDING & TRIM AT OPENING, SEE ELEVATIONS. SEE SHEETS A1.0 - A1.6 & A3.0 - A3.1, A3.3.

R19. AT BLDG. TYPE "E" W/ BASIC FRONT ELEVATION, PROVIDE NEW SIDING & TRIM.

SCALE:  $1/4^{\circ} = 1'-0''$ 



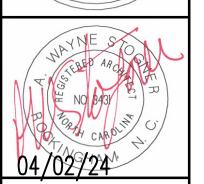

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RENOVATION FLOOR PLAN TWO BEDROOM UNIT -BUILDING TYPE "C"; NC 15-1

6041-B\A2.1 .AEC

COMM. NO. **6041-B** DRAWN BY

CHECKED BY AWS DATE **APRIL 2, 2024** 

SHEET NO. A2.1

RENOVATION FLOOR PLAN, TWO BEDROOM UNIT; NC 15-1

BUILDING TYPE 'C' SCALE 1/4" = 1'-0"

SCALE:  $1/4^{\circ} = 1'-0^{\circ}$ 

DRAWN BY WBP

CHECKED BY AWS DATE **APRIL 2, 2024** 

A2.2

SHEET NO.

CERT. NO.


BUILD

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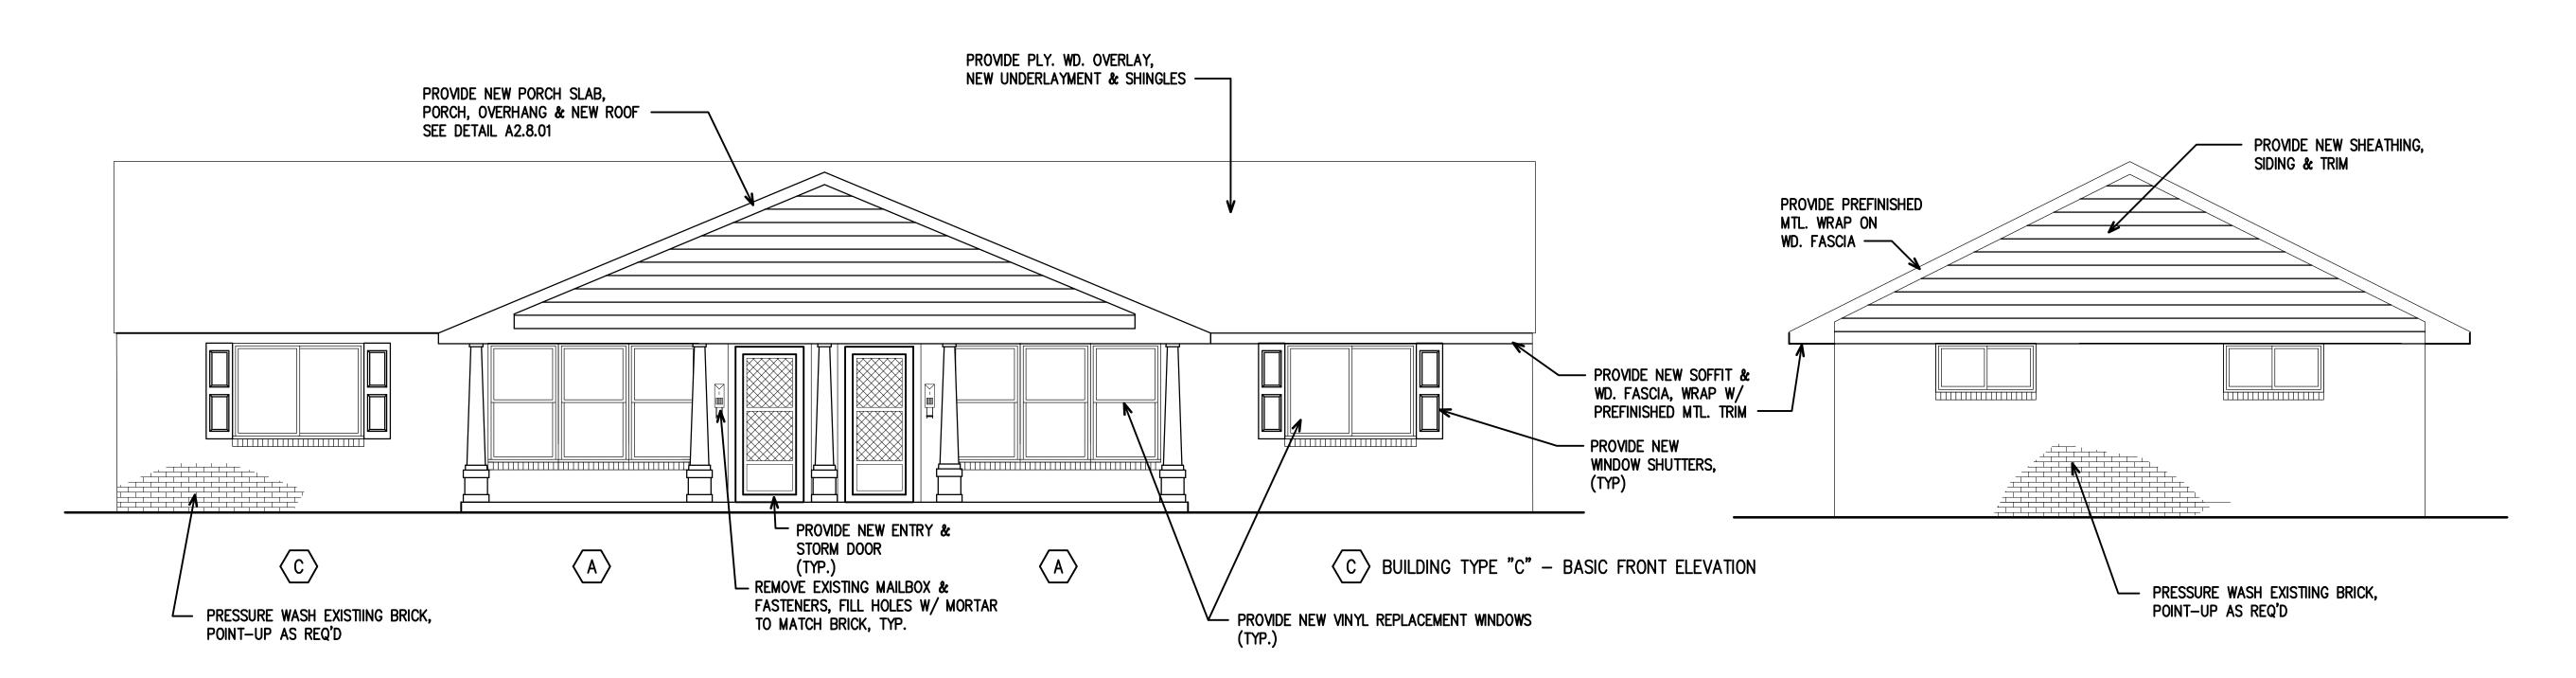
A2.3

SCALE: 1/4" = 1'-0"

CERT. NO.

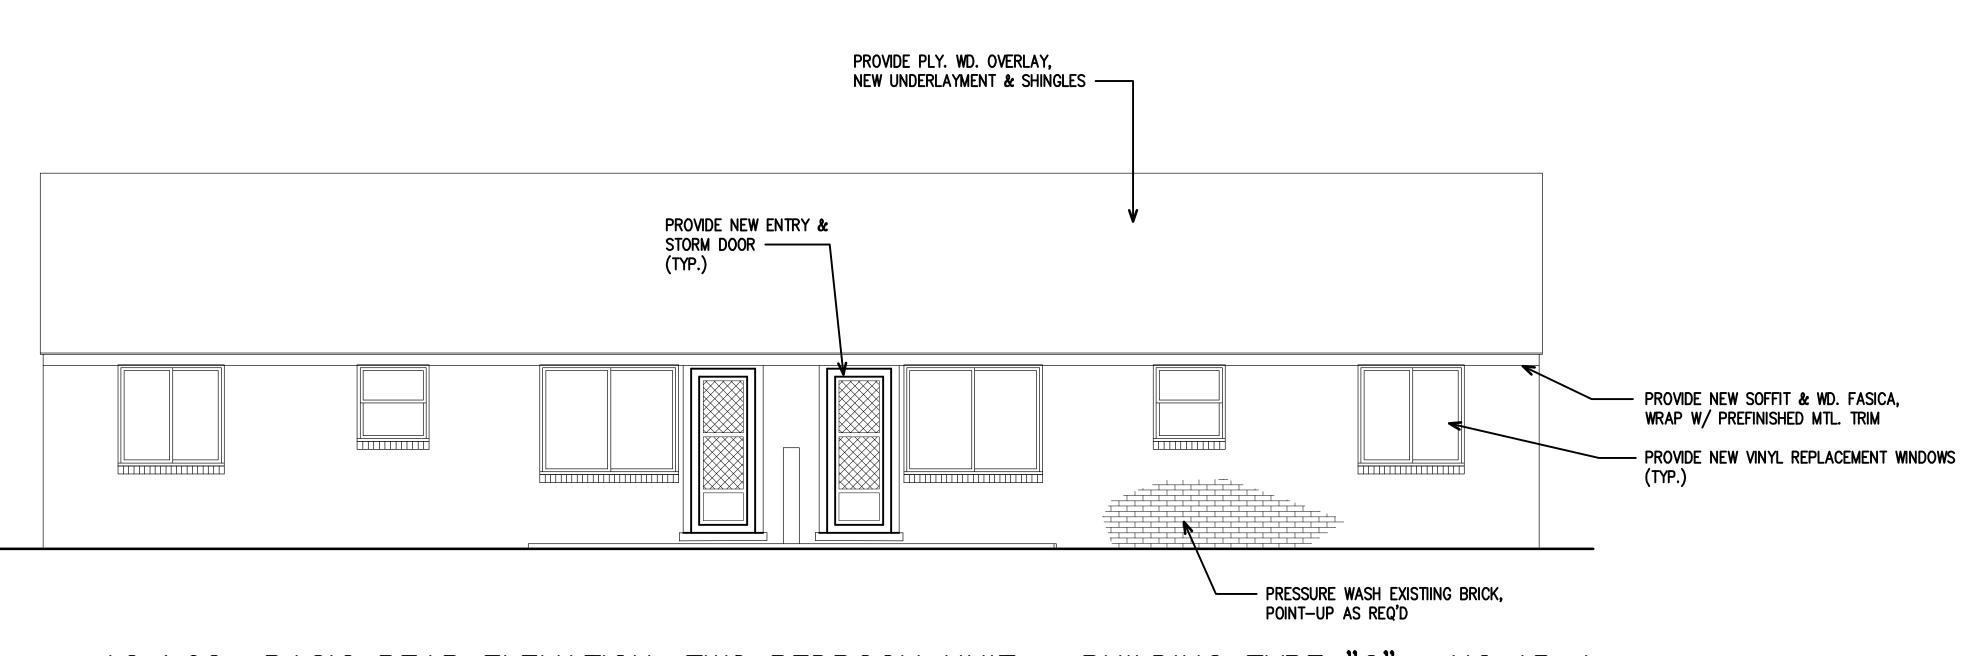


A2.4.02 BASIC REAR ELEVATION, TWO BEDROOM UNIT - BUILDING TYPE "C"; NC 15-1 SCALE 1/4" = 1'-0"



A2.4.01 BASIC FRONT ELEVATION, TWO BEDROOM UNIT - BUILDING TYPE "C"; NC 15-1 SCALE 1/4" = 1'-0"

SCALE:  $1/4^{\circ} = 1'-0''$ 

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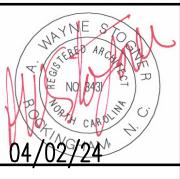
Housing

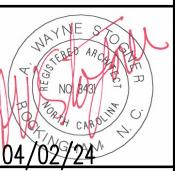BASIC FRONT ELEVATION, TWO BEDROOM UNIT — BUILDING TYPE "C"; NC 15-1 6041-B\A2.4 .AEC COMM. NO. **6041-B** DRAWN BY WBP

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SHEET NO. A2.4





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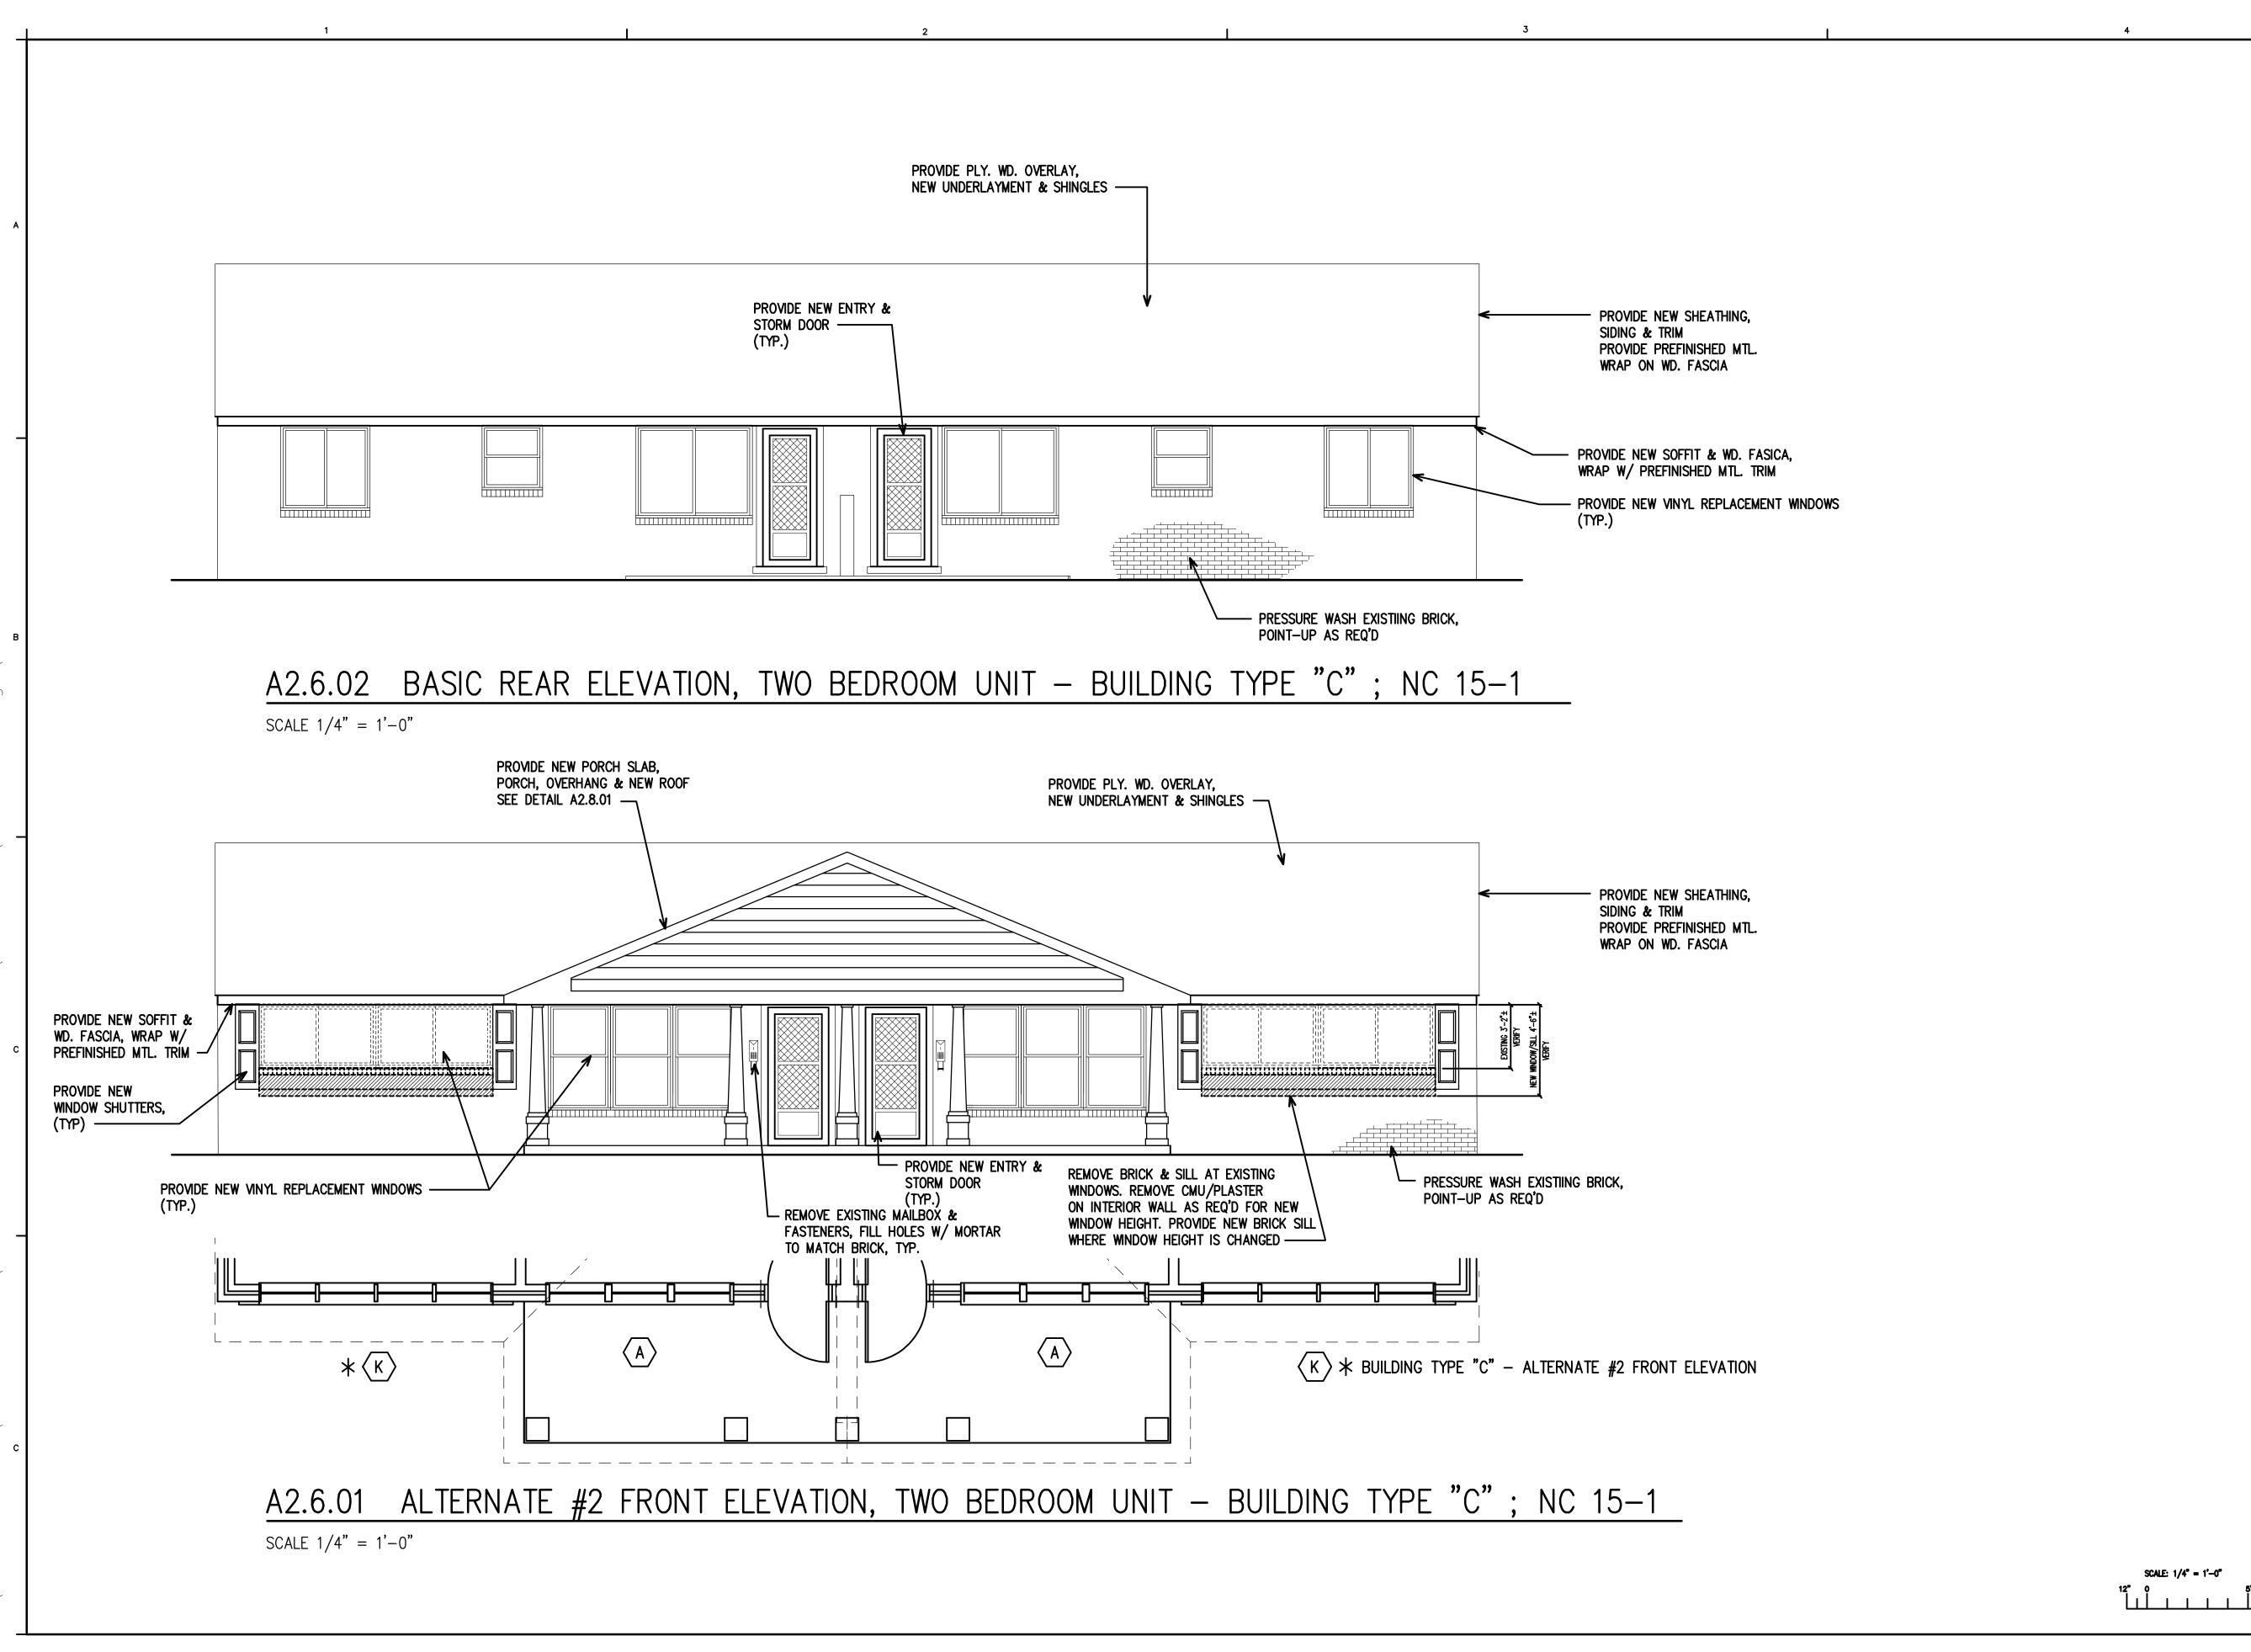
ALTERNATE #1 FRONT ELEVATION, TWO BEDROOM UNIT - BUILDING TYPE "C"; NC 15-1

6041-B\A2.5 .AEC

COMM. NO. **6041-B** DRAWN BY WBP CHECKED BY AWS

DATE **APRIL 2, 2024** SHEET NO. A2.5

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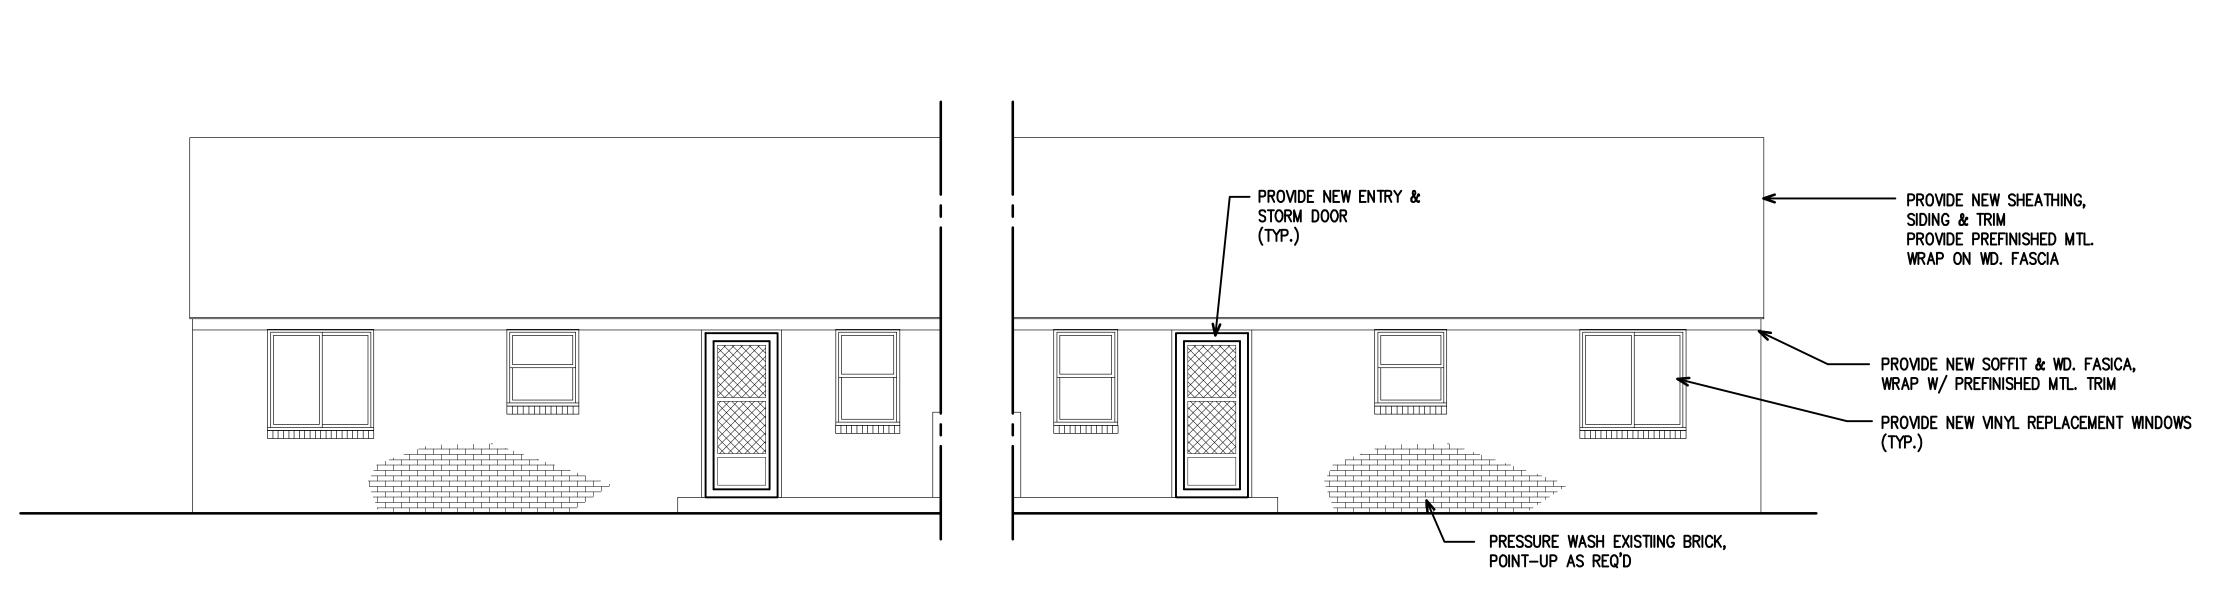
Housing

ALTERNATE #2 FRONT ELEVATION, TWO BEDROOM UNIT —
BUILDING TYPE "C";
NC 15—1 6041-B\A2.6 .AEC

COMM. NO. **6041-B** DRAWN BY WBP CHECKED BY AWS


DATE **APRIL 2, 2024** SHEET NO.

A2.6



# A2.7.02 REAR ELEVATION, HANDICAP TWO BEDROOM UNIT - BUILDING TYPE "C"; NC 15-1

SCALE 1/4" = 1'-0"

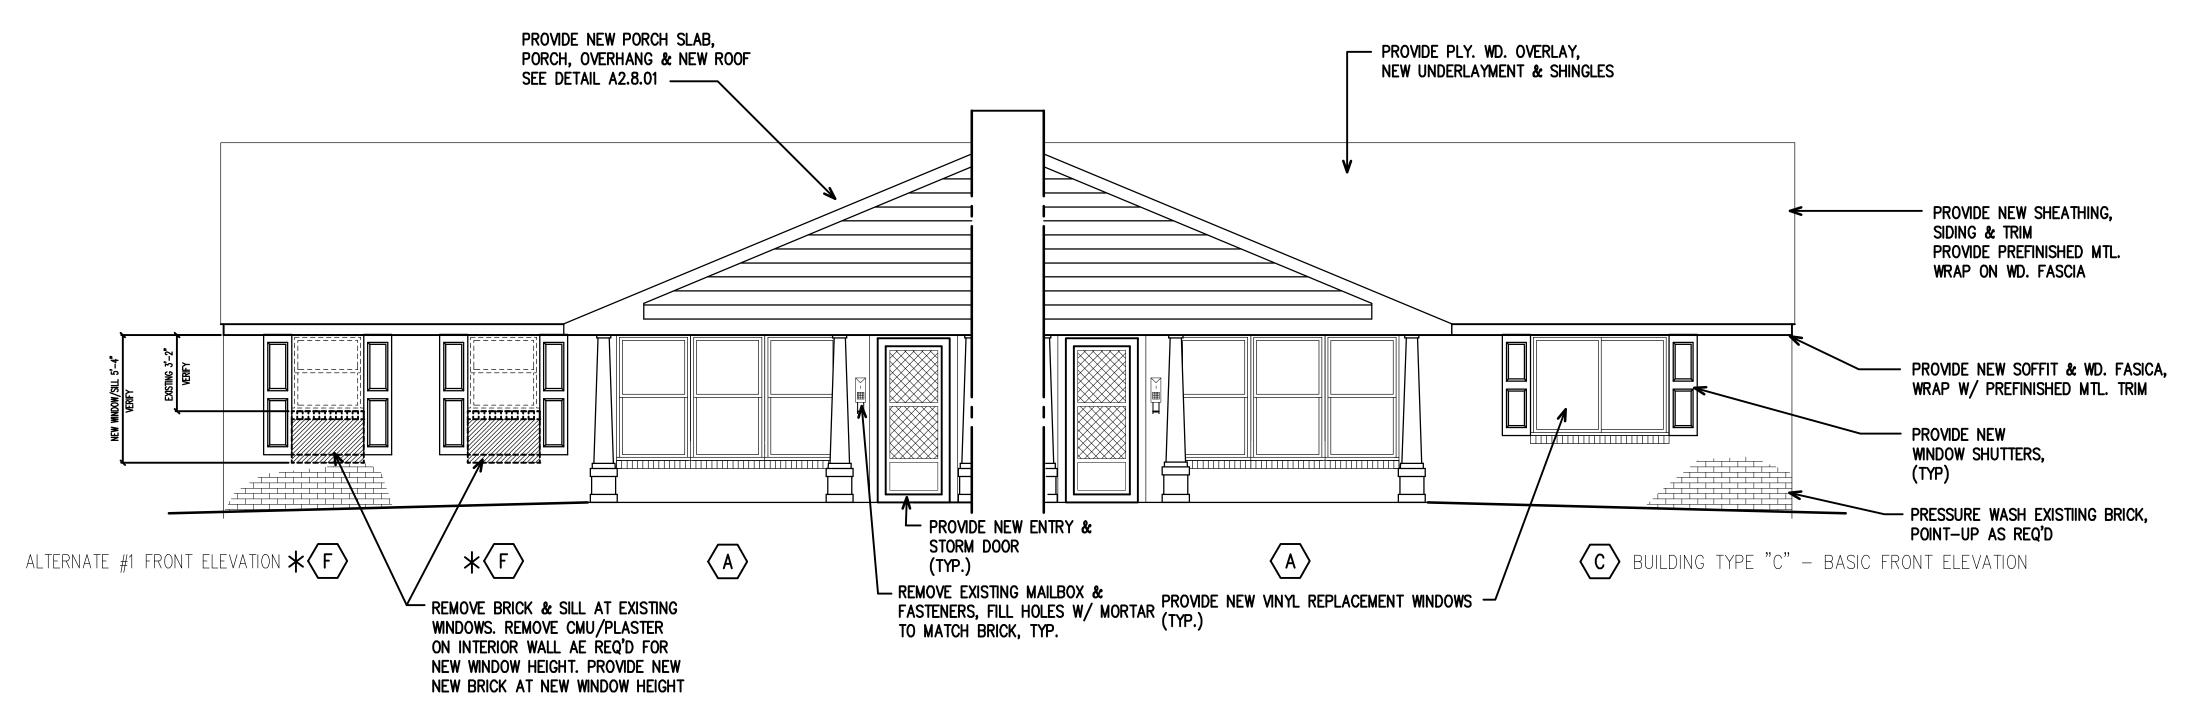

## BASIC FRONT ELEVATION, HANDICAP TWO BEDROOM UNIT — BUILDING TYPE "C"; NC 15-1

SCALE 1/4" = 1'-0"

#### HANDICAP APARTMENT

HANDICAP APARTMENT

BLDG C/14 APT. #1726A - EDGERTON ST.

BLDG C/2, APT. #905A - FAIRVIEW CIRCLE BLDG C/8, APT. #927A - FAIRVIEW CIRCLE

BLDG C/14, APT. #1730B - EDGERTON ST.


FRONT WINDOWS VARIES, SEE ELEVATIONS

BLDG C/2, APT #905A - FAIRVIEW CIRCLE; ALTERNATE #1 FRONT ELEVATION, SEE A2.5.01 BLDG C/8, APT #927A - FAIRVIEW CIRCLE; ALTERNATE #1 FRONT ELEVATION, SEE A2.5.01 BLDG C/14, APT #1726A - EDGERTON ST.; BASIC FRONT ELEVATION

BLDG C/14, APT #1730B - EDGERTON ST.; ALTERNATE #1 FRONT ELEVATION, SEE A2.5.01

SCALE:  $1/4^{\circ} = 1'-0''$ 



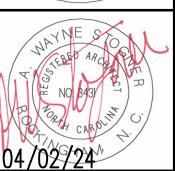

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of ( FAIRV CIRCLE Housing


REAR ELEVATION, HANDICAP TWO BEDROOM UNIT -BUILDING TYPE "C"; NC 15-1

6041-B\A2.7 .AEC


COMM. NO. **6041-B** DRAWN BY WBP CHECKED BY AWS

DATE **APRIL 2, 2024** SHEET NO.

A2.7

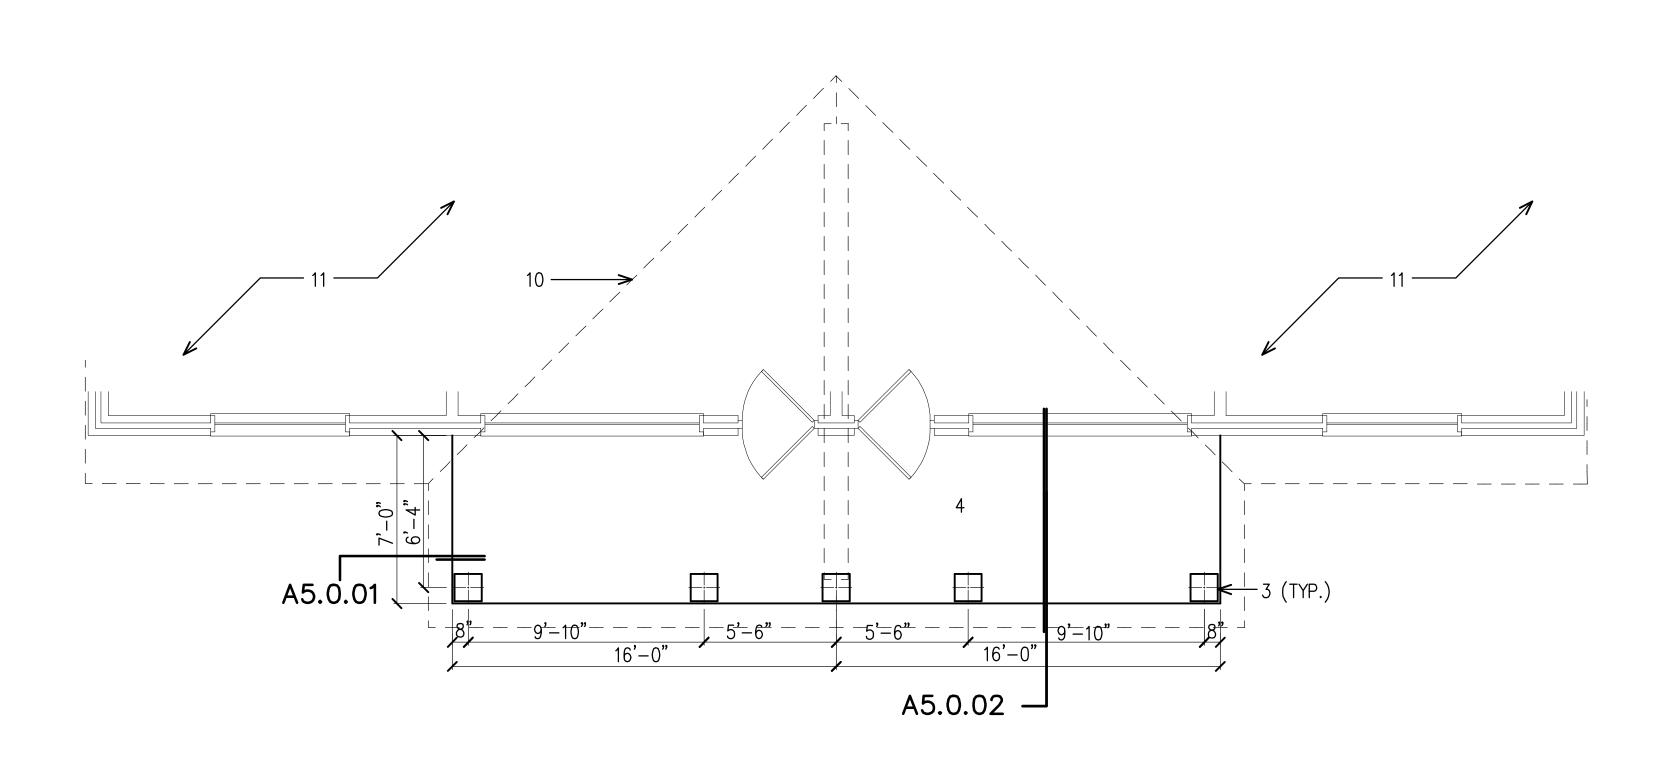

A2.8.01 REVISED PORCH/ROOF PLAN, TWO BEDROOM UNIT - BUILDING TYPE "C"; NC 15-1 SCALE: 1/4" = 1'-0"

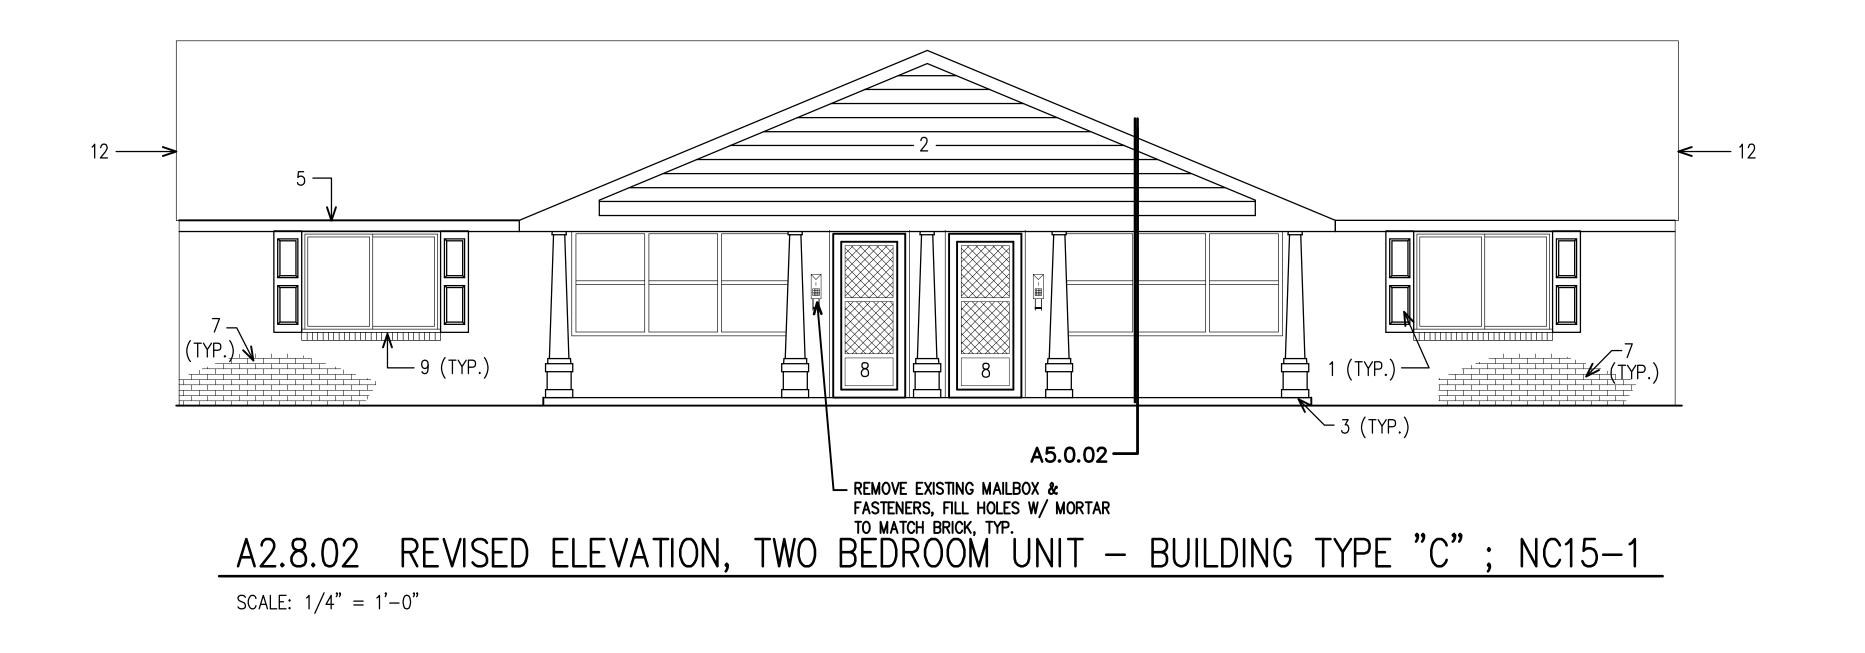


## KEYNOTES - REVISED PORCH/ROOF, FRONT ELEVATION

- 1. PROVIDE NEW WINDOW SHUTTERS.
- 2. PROVIDE NEW SIDING AND TRIM.
- 3. PROVIDE NEW PORCH COLUMN.
- 4. PROVIDE NEW FRONT PORCH SLAD. POUR WITH 3000PSI CONCRETE.
- 5. REMOVE EXISTING METAL WRAP FROM FREIZE BOARD AND EXISTING WOOD, VENTED SOFFIT. PROVIDE NEW 2x6 WOOD FASCIA AND SOFFIT CONTINUOUS.

WRAP FASCIA WITH NEW PRE FINISHED METAL. SEE DETAIL A5.5.

- 6. NOT USED.
- 7. PRESSURE WASH EXISTING BRICK, PATCH AND POINT-UP AS REQUIRED.
- 8. EXISTING ENTRY DOOR AND STORM DOOR TO REPLACED.
- 9. EXISTING WINDOWS TO BE REPLACED.
- 10. PROVIDE NEW PORCH, OVERHANG AND ROOF.
- 11. EXISTING ROOF, SEE SHEET A1.0-A1.6 FOR WORK ASSOCIATED WITH ROOF
- 12. REMOVE EXISTING SIDING, TRIM & SHEATHING COMPLETE. PROVIDE NEW SIDING AND TRIM.



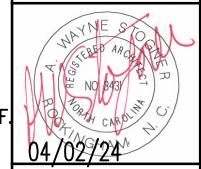

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REVISED PORCH/ROOF PLAN, FRONT ELEVATION, TWO BEDROOM UNIT — BUILDING TYPE "C"; NC 15-1


6041-B\A2.8 .AEC

COMM. NO. **6041-B** DRAWN BY WBP

CHECKED BY AWS DATE APRIL 2, 2024

SHEET NO. A2.8

SCALE:  $1/4^{\circ} = 1'-0''$ 

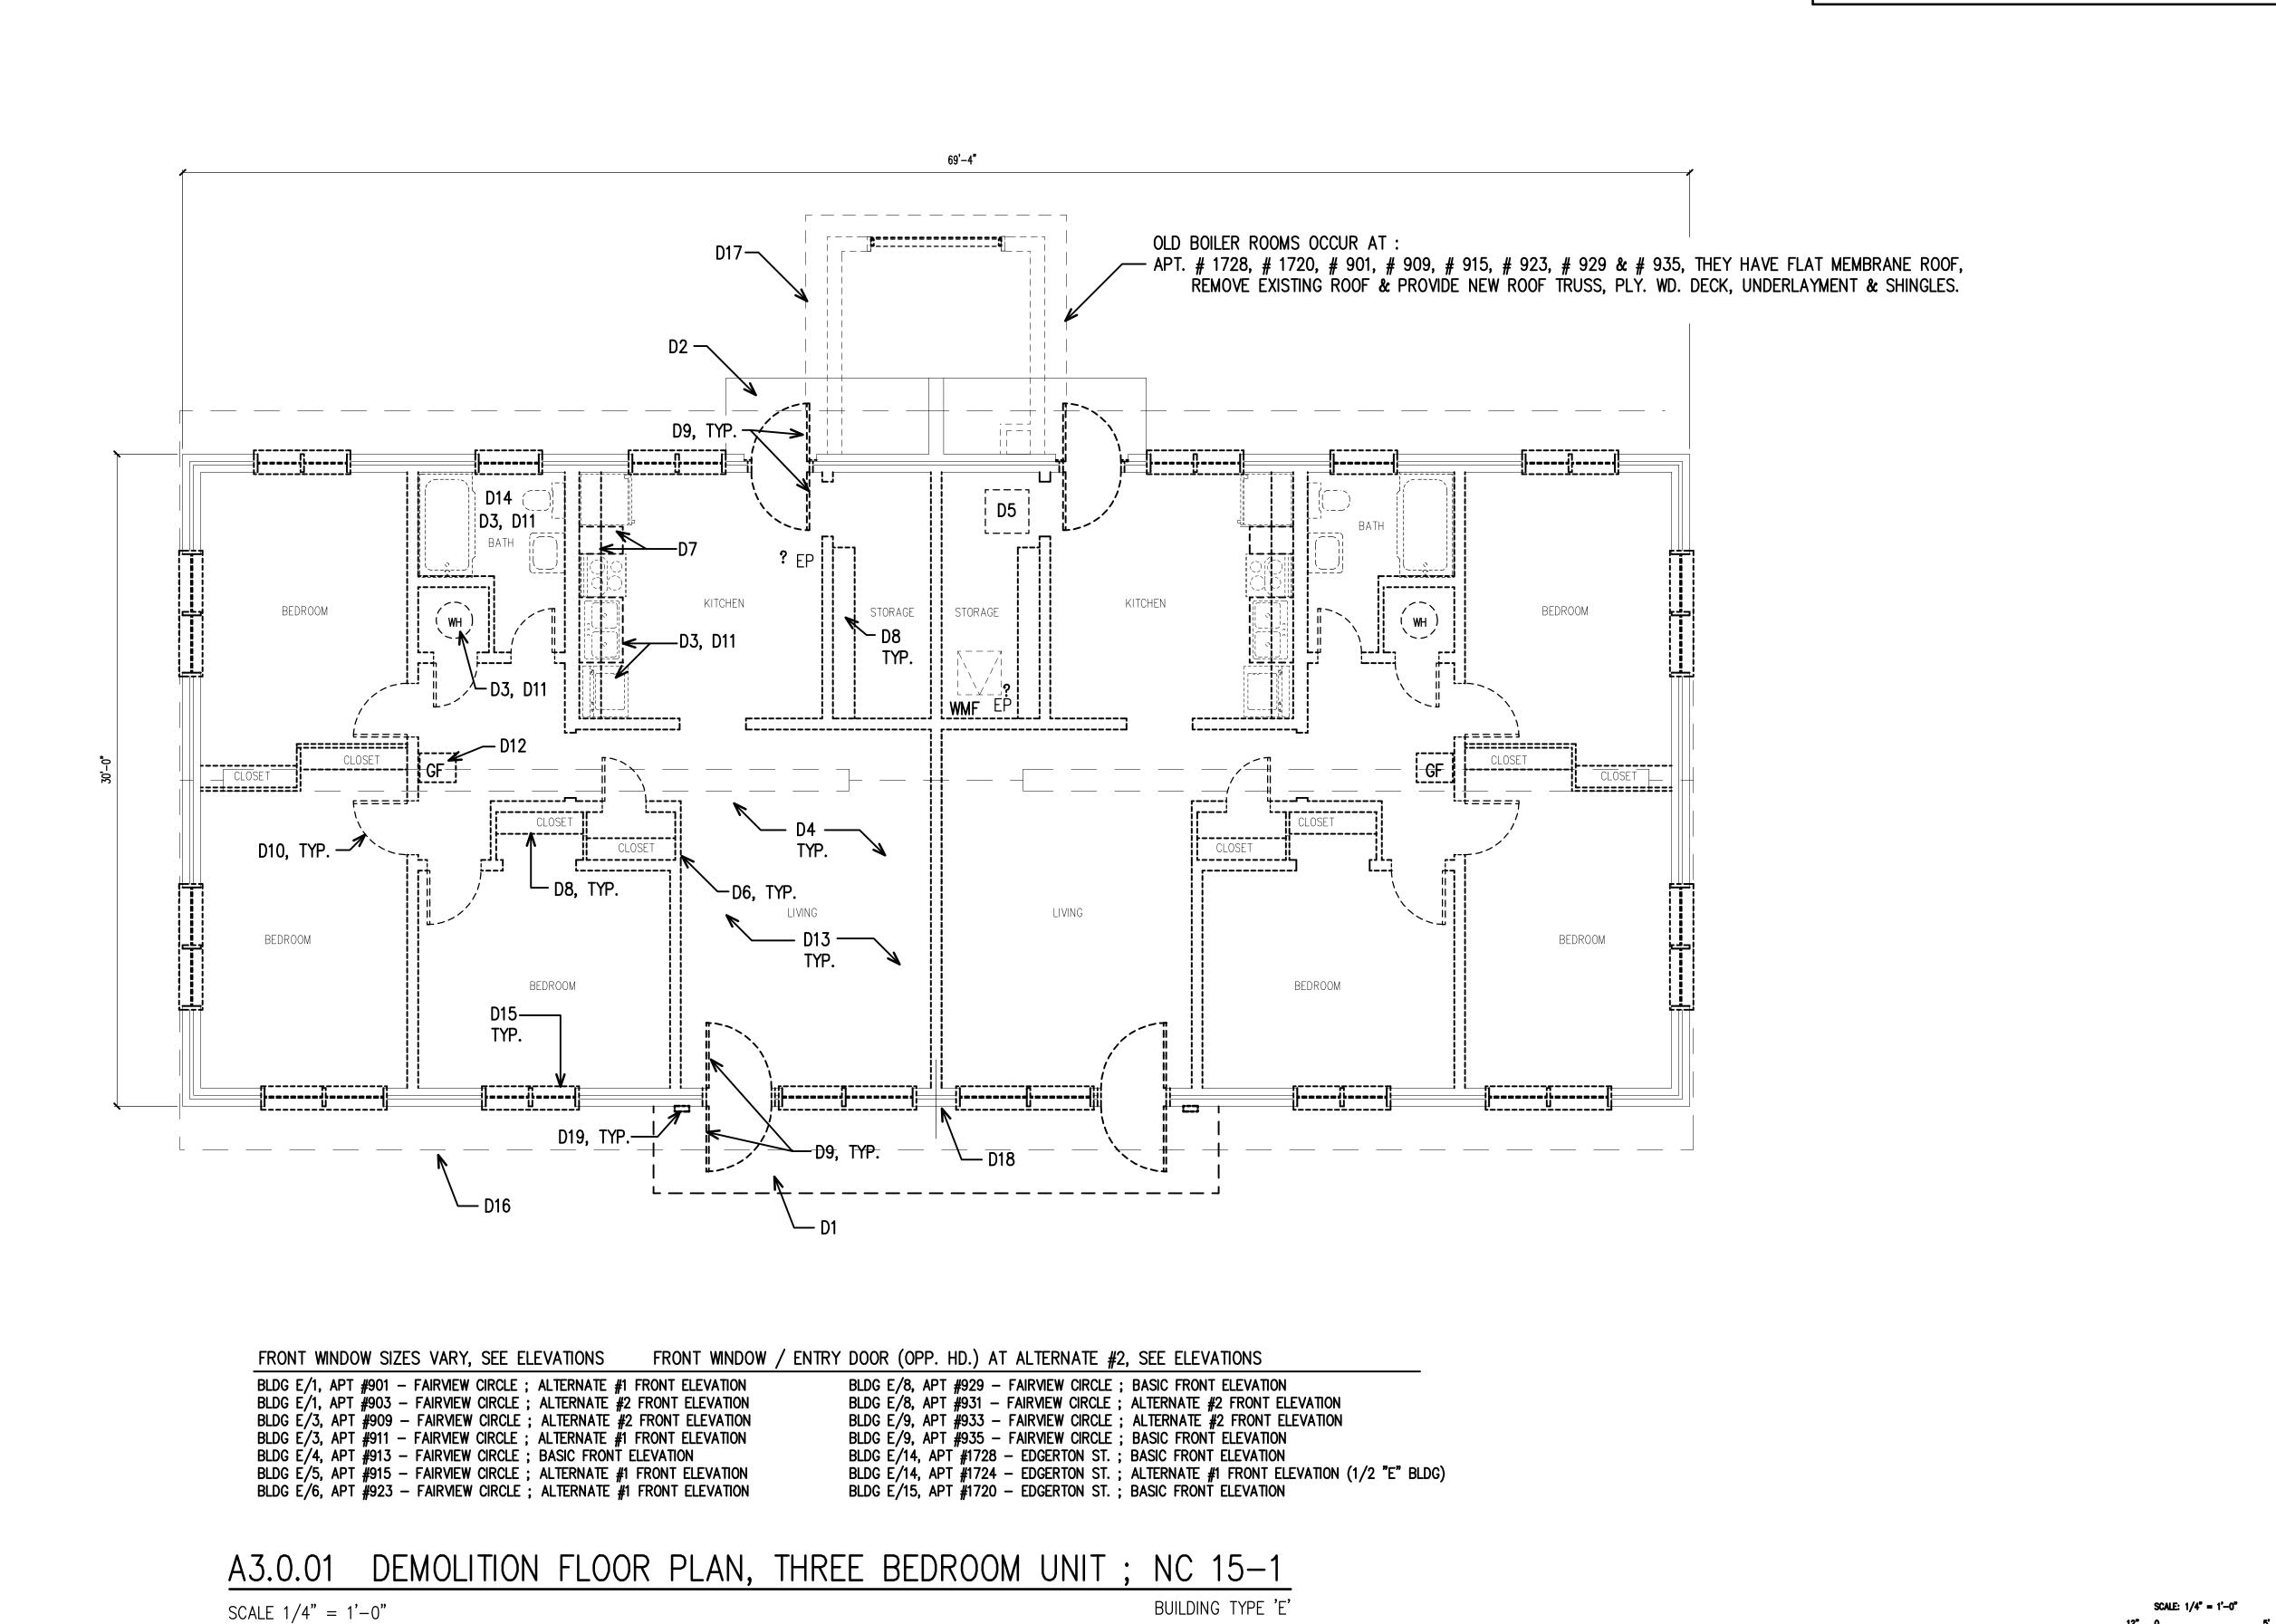

CERT. NO.




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DEMOLITION FLOOR PLAN, THREE BEDROOM UNIT -BUILDING TYPE "E";

NC 15-1 6041-B\A3.0 .AEC

COMM. NO. **6041-B** DRAWN BY WBP CHECKED BY AWS DATE APRIL 2, 2024

SHEET NO. A3.0

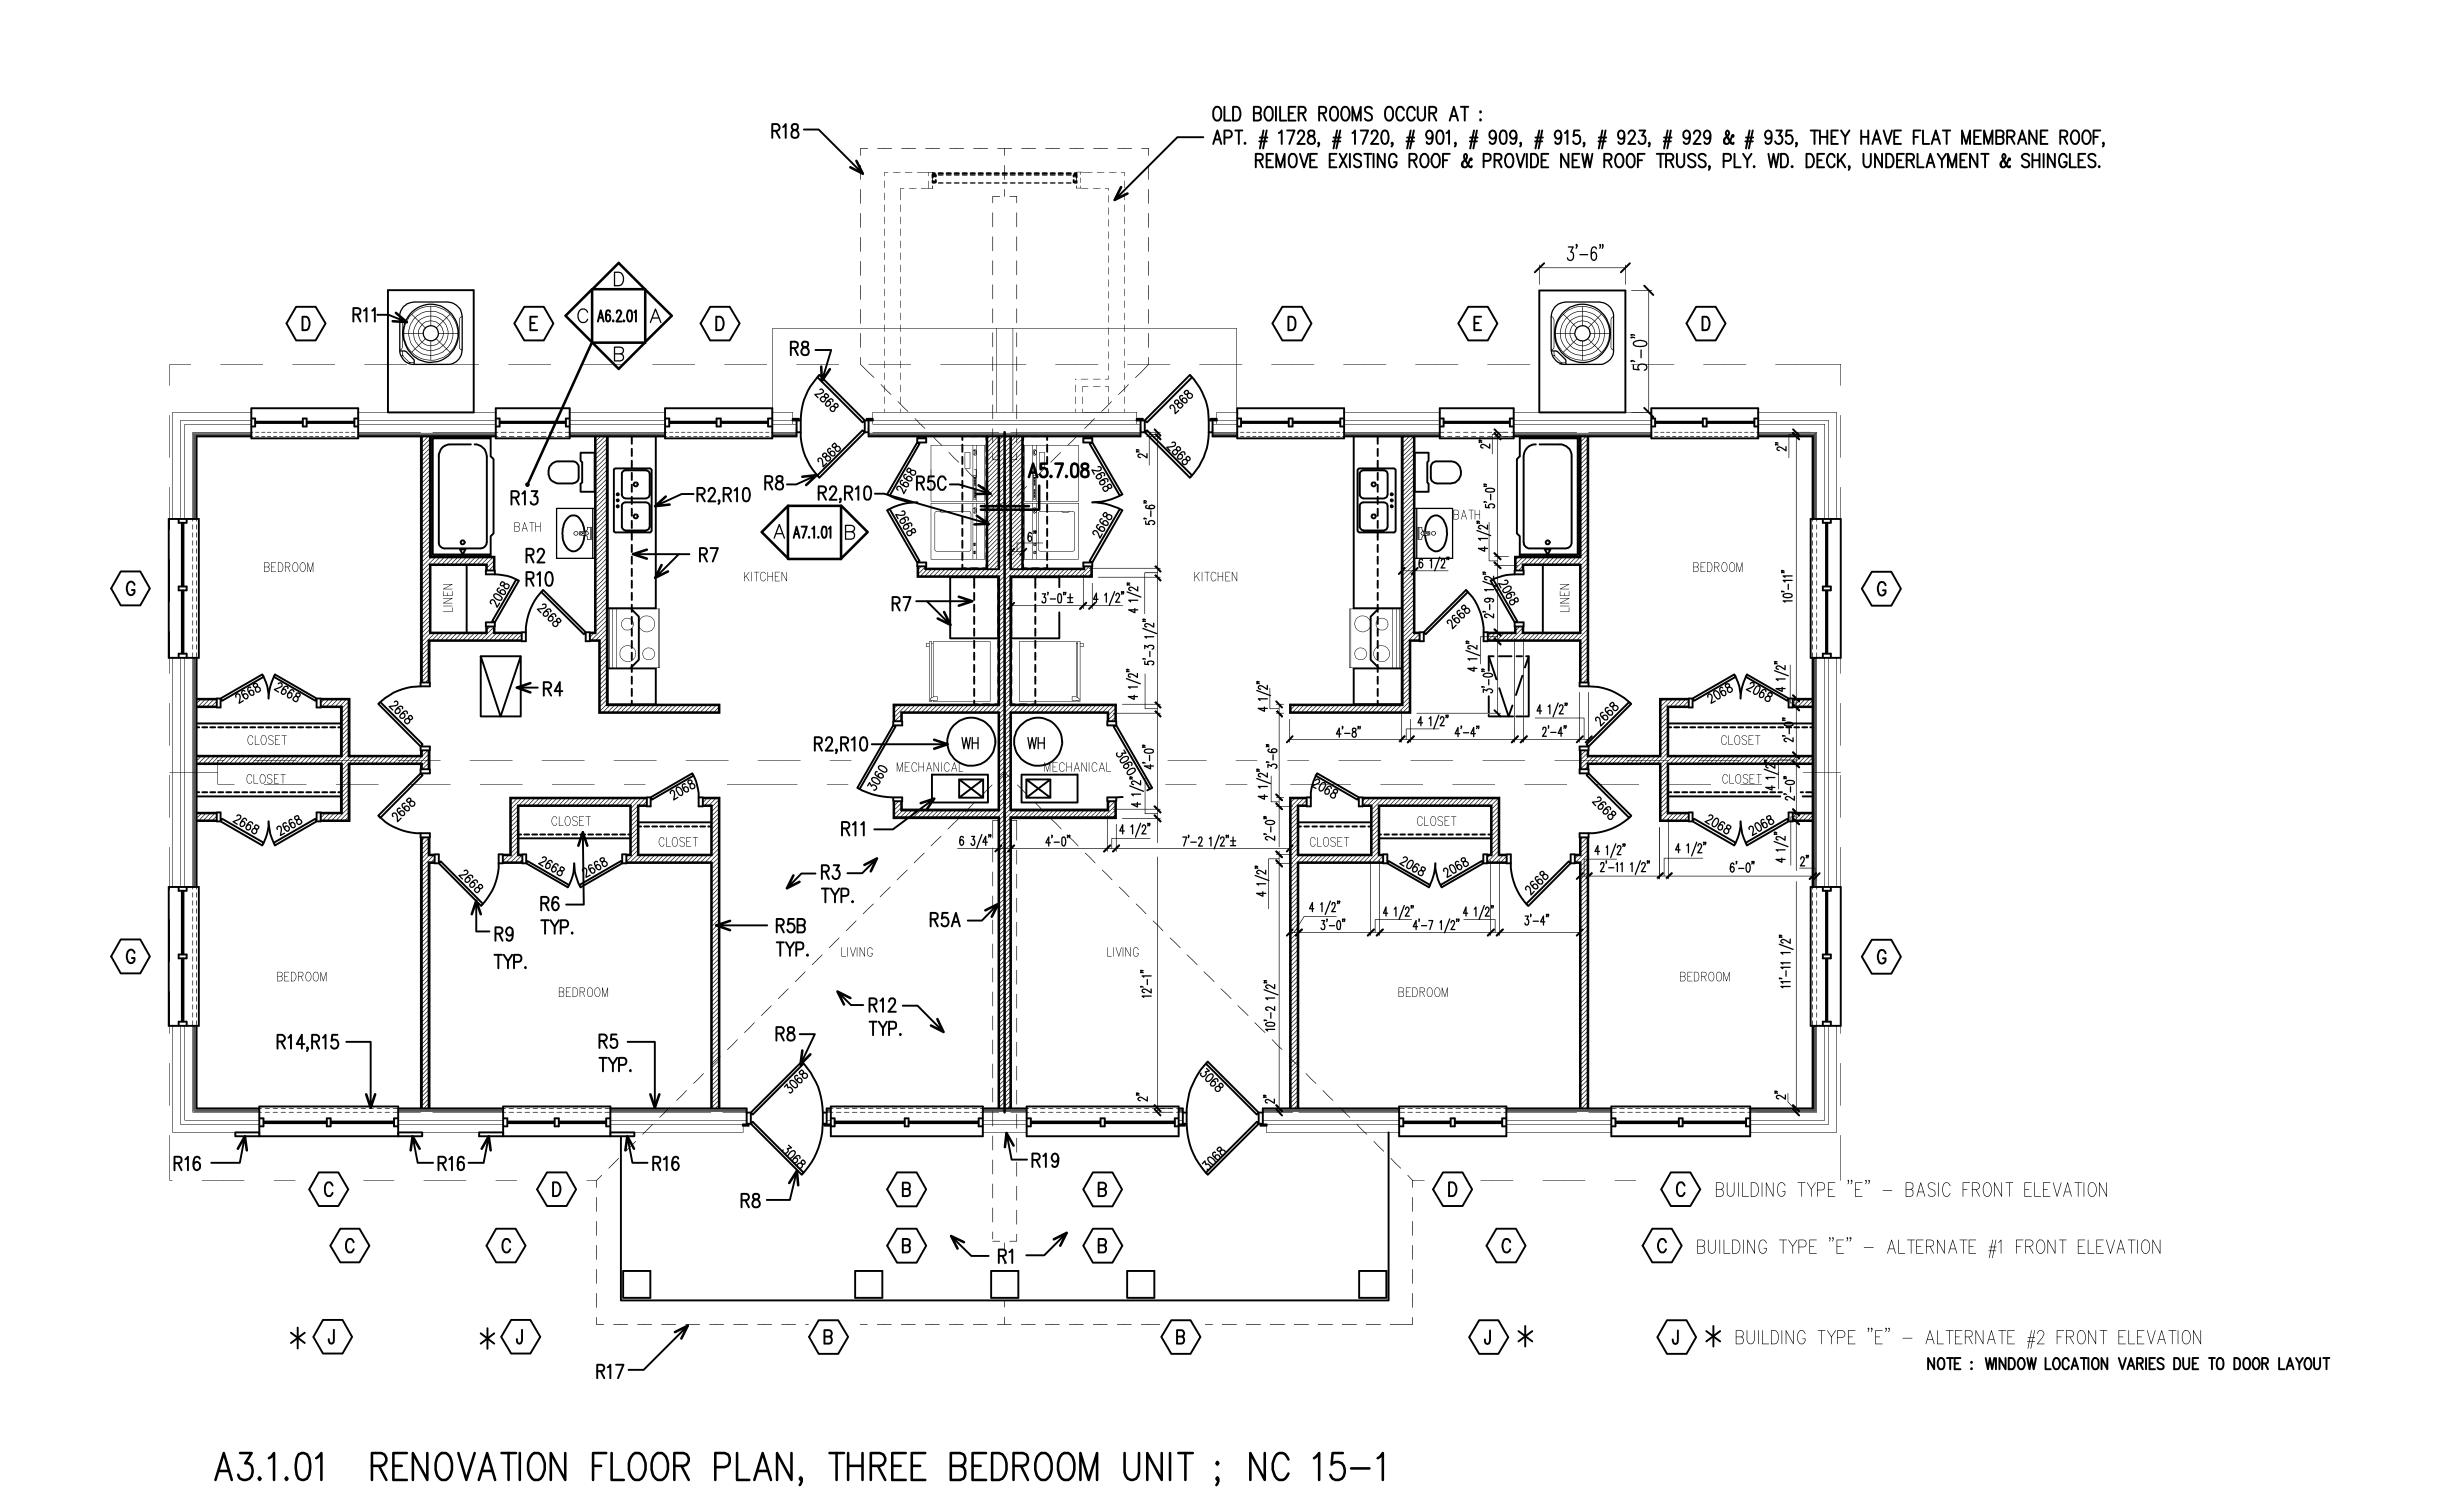

BUILDING TYPE 'E'

RENOVATION FLOOR PLAN, THREE BEDROOM UNIT -BUILDING TYPE "E"; NC 15-1

CERT. NO.

6041-B\A3.1 .AEC

COMM. NO. **6041-B** DRAWN BY WBP CHECKED BY AWS

DATE **APRIL 2, 2024** SHEET NO. A3.1

SCALE: 1/4" = 1'-0"

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SCALE 1/4" = 1'-0"

6041B BID SET DRAWINGS - Page 32 of 142

SEE SHEET A2.0 FOR DEMOLITION KEYNOTES

SEE SHEET A2.1 FOR RENOVATION KEYNOTES

CERT. NO.


DEMOLITION/RENOVATION FLOOR PLAN,
THREE BEDROOM UNIT —
BUILDING TYPE "E—1";
NC 15—1

6041-B\A3.2 .AEC

COMM. NO. **6041-B** DRAWN BY WBP CHECKED BY AWS

DATE **APRIL 2, 2024** SHEET NO.

A3.2

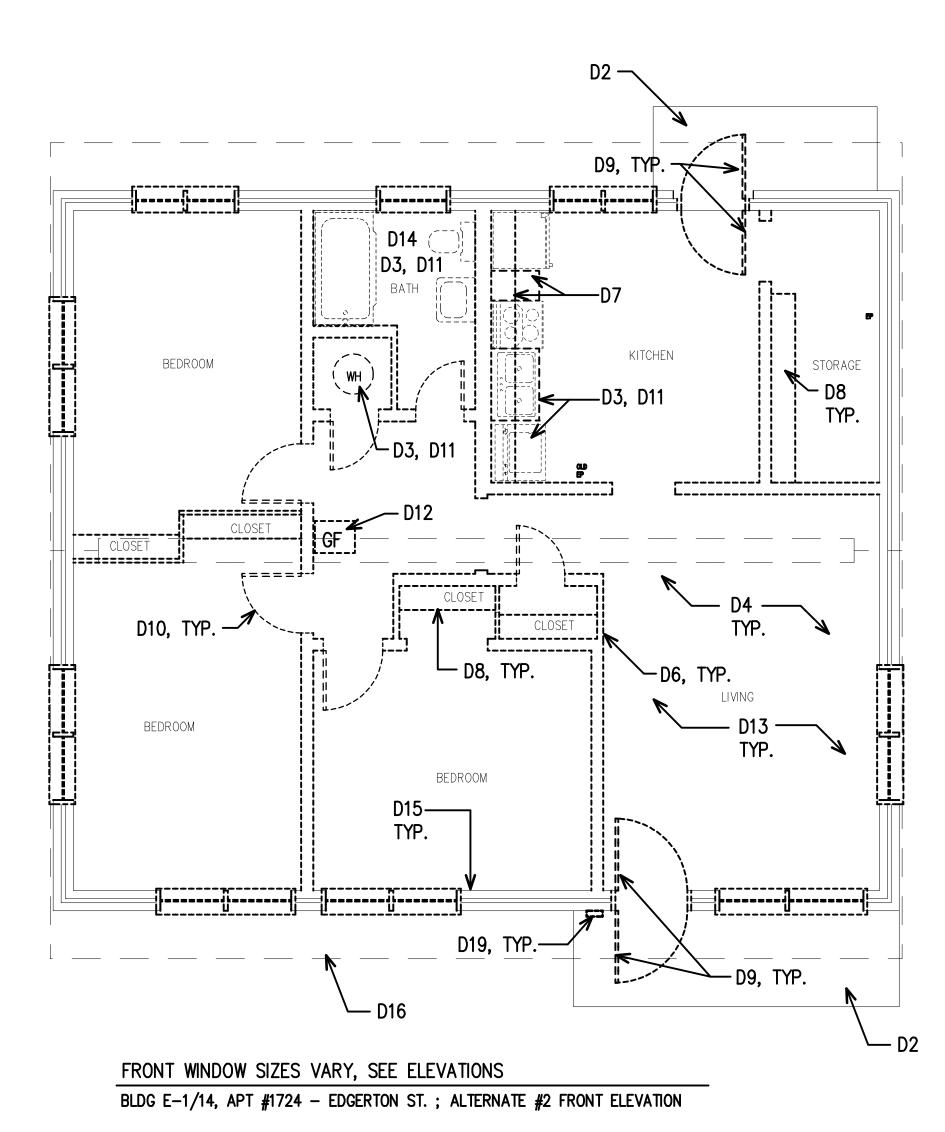

DEMOLITION FLOOR PLAN, THREE BEDROOM UNIT; NC 15-1 BUILDING TYPE 'E-1' SCALE 1/4" = 1'-0"

A3.2.02 RENOVATION FLOOR PLAN, THREE BEDROOM UNIT; NC 15-1 BUILDING TYPE 'E-1'

SCALE: 1/4" = 1'-0"

BUILDING TYPE "E" - ALTERNATE #2 FRONT ELEVATION

SCALE 1/4" = 1'-0"

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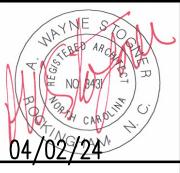
CERT. NO. 04/02/24 , PA Architecture, Stogner
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Phone 910-895-Housing BASIC FRONT ELEVATION, THREE BEDROOM UNIT — BUILDING TYPE "E"; NC 15-1 6041-B\A3.3 .AEC COMM. NO. **6041-B** DRAWN BY WBP

DATE APRIL 2, 2024

A3.3

SHEET NO.





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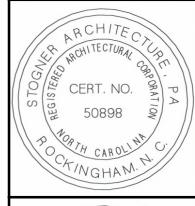
Housing

ALTERNATE #1 FRONT ELEVATION, THREE BEDROOM UNIT —
BUILDING TYPE "E";
NC 15—1

6041-B\A3.4 .AEC

COMM. NO. **6041-B** DRAWN BY WBP CHECKED BY AWS

DATE **APRIL 2, 2024** SHEET NO. A3.4





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Housing

ALTERNATE #2 FRONT ELEVATION, THREE BEDROOM UNIT —
BUILDING TYPE "E";
NC 15—1

6041-B\A3.5 .AEC


COMM. NO. **6041-B** DRAWN BY WBP CHECKED BY AWS

DATE **APRIL 2, 2024** SHEET NO. A3.5

## KEYNOTES - REVISED PORCH/ROOF, FRONT ELEVATION

- 1. PROVIDE NEW WINDOW SHUTTERS.
- 2. PROVIDE NEW SIDING AND TRIM.
- 3. PROVIDE NEW PORCH COLUMN.
- 4. PROVIDE NEW FRONT PORCH SLAD. POUR WITH 3000PSI CONCRETE.
- 5. REMOVE EXISTING METAL WRAP FROM FREIZE BOARD AND EXISTING WOOD, VENTED SOFFIT.
- PROVIDE NEW 2x6 WOOD FASCIA AND SOFFIT CONTINUOUS. WRAP FASCIA WITH NEW PRE FINISHED METAL. SEE DETAIL A5.5.
- 6. NOT USED.
- 7. EXISTING BRICK. CLEAN, PATCH AND POINT-UP AS REQUIRED.
- 8. EXISTING ENTRY DOOR AND STORM DOOR TO REPLACED.
- 9. EXISTING WINDOWS TO BE REPLACED.
- 10. PROVIDE NEW PORCH, OVERHANG AND ROOF.
- 11. EXISTING ROOF, SEE SHEET A1.0-A1.6 FOR WORK ASSOCIATED WITH ROOF
- 12. REMOVE EXISTING SIDING, TRIM & SHEATHING COMPLETE. PROVIDE NEW SIDING AND TRIM.



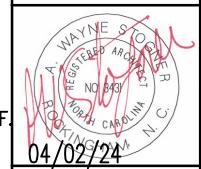

REVISED PORCH/ROOF PLAN, FRONT ELEVATION, THREE BEDROOM UNIT — BUILDING TYPE "E"; NC 15-1


6041-B\A3.6 .AEC

COMM. NO. **6041-B** DRAWN BY WBP

CHECKED BY AWS DATE APRIL 2, 2024

SHEET NO. A3.6

SCALE:  $1/4^{\circ} = 1'-0''$ 

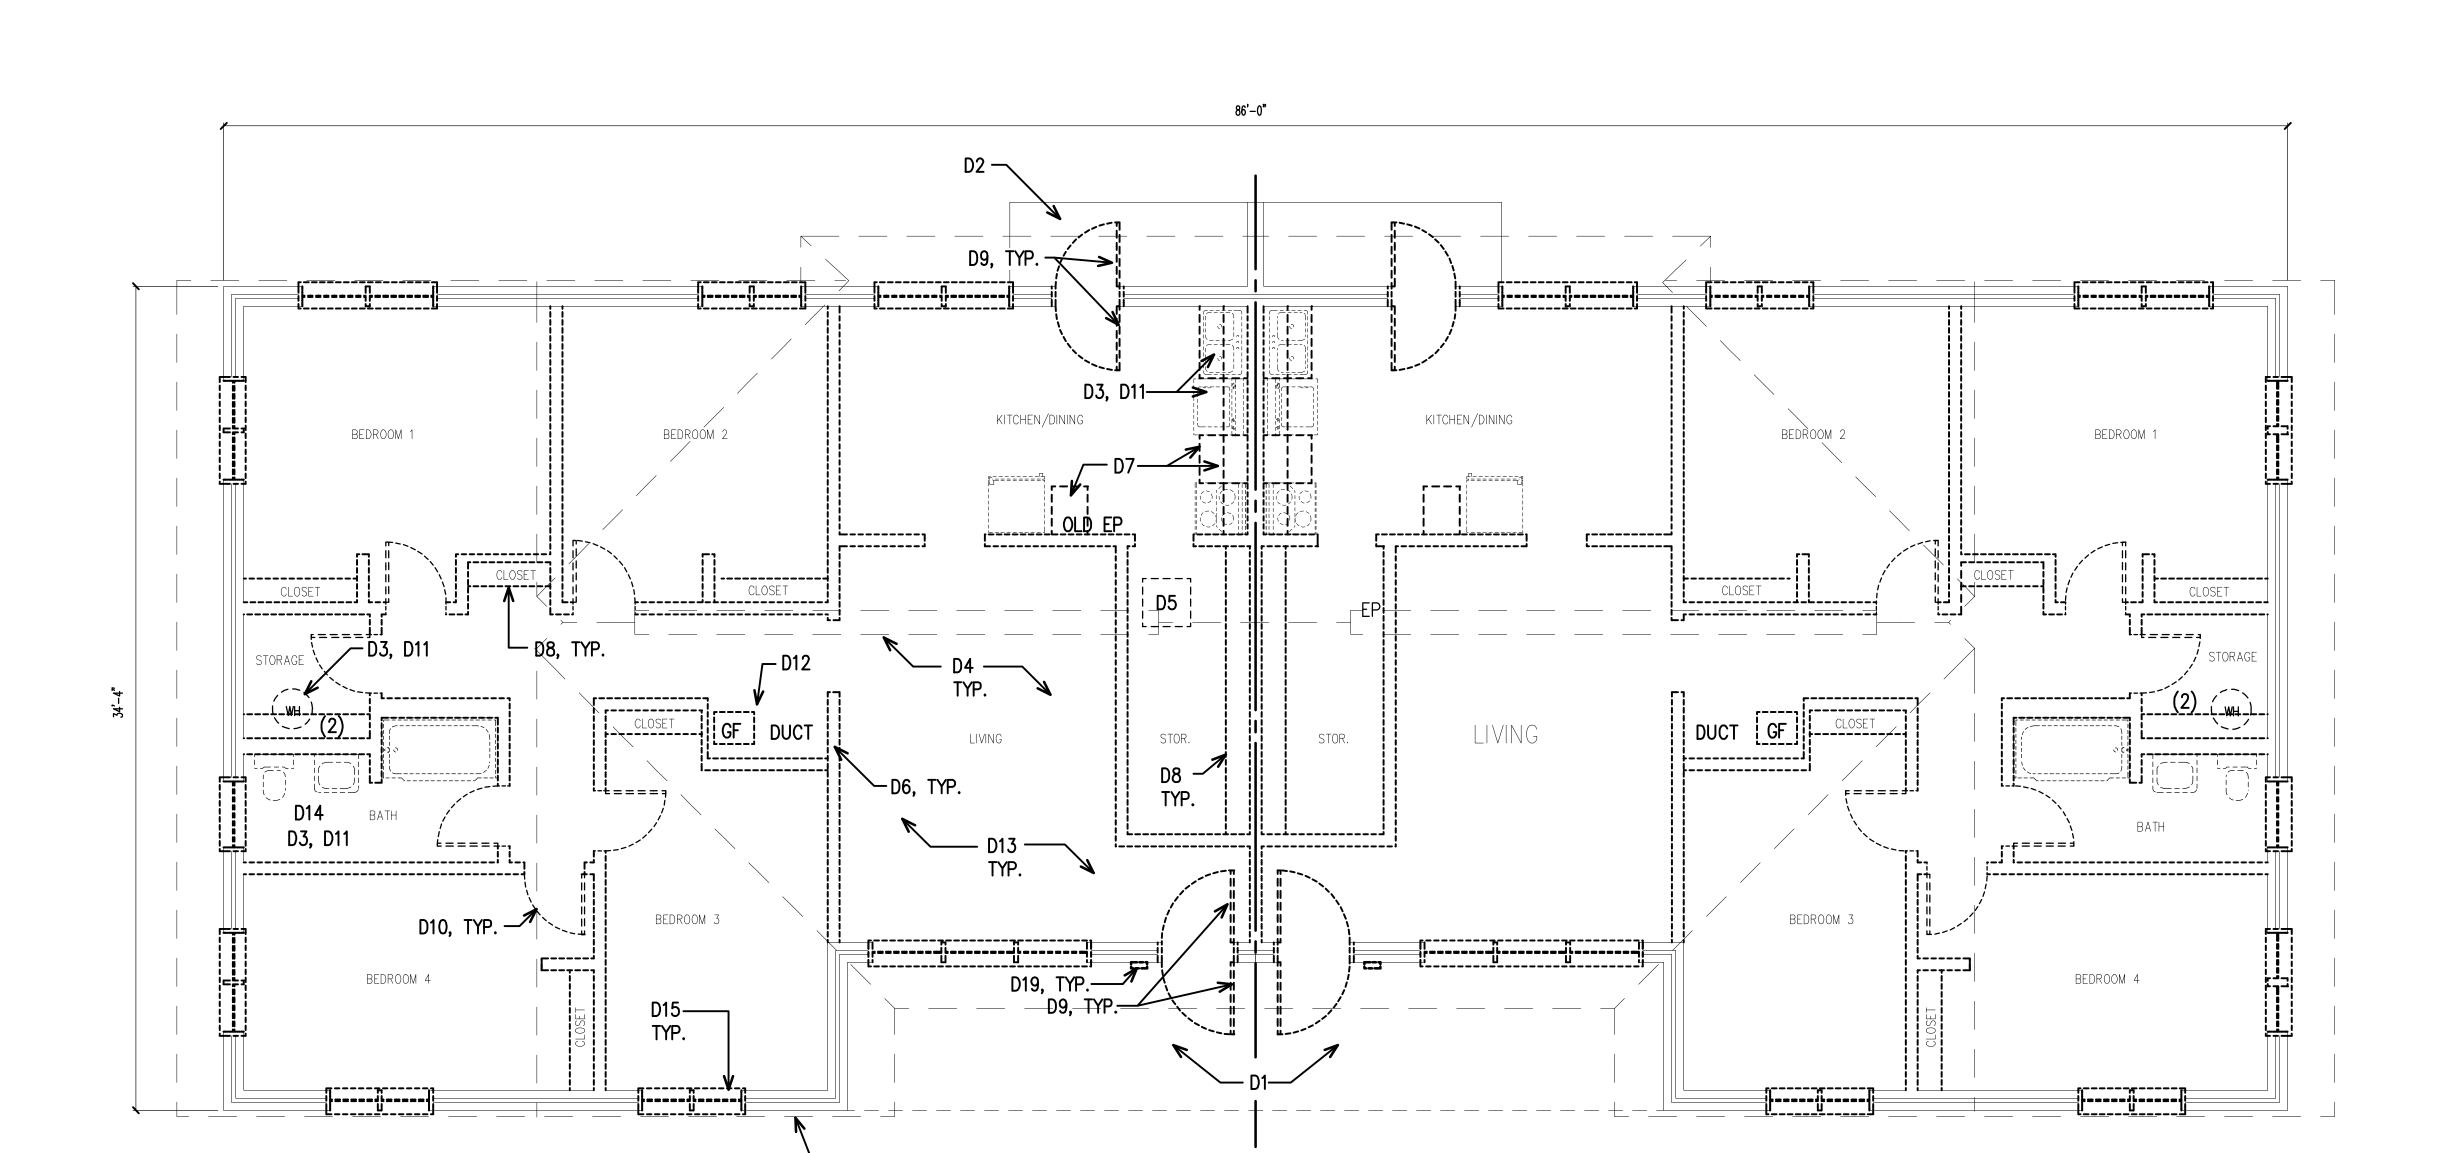

FRONT WINDOW SIZES VARY, SEE ELEVATIONS

BLDG F/1, APT #1711 - EDGERTON ST.; BASIC FRONT ELEVATION
BLDG F/6, APT #921 - FAIRVIEW CIRCLE; BASIC FRONT ELEVATION
BLDG F/7, APT #925 - FAIRVIEW CIRCLE; ALTERNATE #1 FRONT ELEVATION
BLDG F/9, APT #937 - FAIRVIEW CIRCLE; BASIC FRONT ELEVATION
BLDG F-1/15, APT #1722 - EDGERTON ST.; BASIC FRONT ELEVATION
BLDG F/15, APT #1718 - EDGERTON ST.; ALTERNATE #1 FRONT ELEVATION

DEMOLITION FLOOR PLAN, FOUR BEDROOM UNIT; NC 15-1

BUILDING TYPE 'F' SCALE 1/4" = 1'-0"

SCALE:  $1/4^{\circ} = 1'-0''$ 

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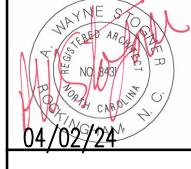
DEMOLITION FLOOR PLAN, FOUR BEDROOM UNIT -BUILDING TYPE "F"; NC 15-1

6041-B\A4.0 .AEC

COMM. NO. **6041-B** DRAWN BY WBP CHECKED BY AWS DATE **APRIL 2, 2024** 

> SHEET NO. A4.0





RENOVATION FLOOR PLAN, FOUR BEDROOM UNIT —
BUILDING TYPE "F";
NC 15—1

6041-B\A4.1 .AEC

COMM. NO. **6041-B** DRAWN BY WBP CHECKED BY AWS

DATE **APRIL 2, 2024** SHEET NO. A4.1

KITCHEN/DINING BEDROOM 1 BEDROOM 2 BEDROOM 1  $\langle G \rangle$ BEDROOM 4  $\langle A \rangle$ BUILDING TYPE "F" - BASIC FRONT ELEVATION (J)\*  $\langle J \rangle *$  $\langle A \rangle$  $\langle A \rangle$  $\langle \mathsf{J} \rangle *$ J \* BUILDING TYPE "F" - ALTERNATE #1 FRONT ELEVATION

RENOVATION FLOOR PLAN, FOUR BEDROOM UNIT; NC 15-1 SCALE 1/4" = 1'-0"

BUILDING TYPE 'F'

SCALE: 1/4" = 1'-0"

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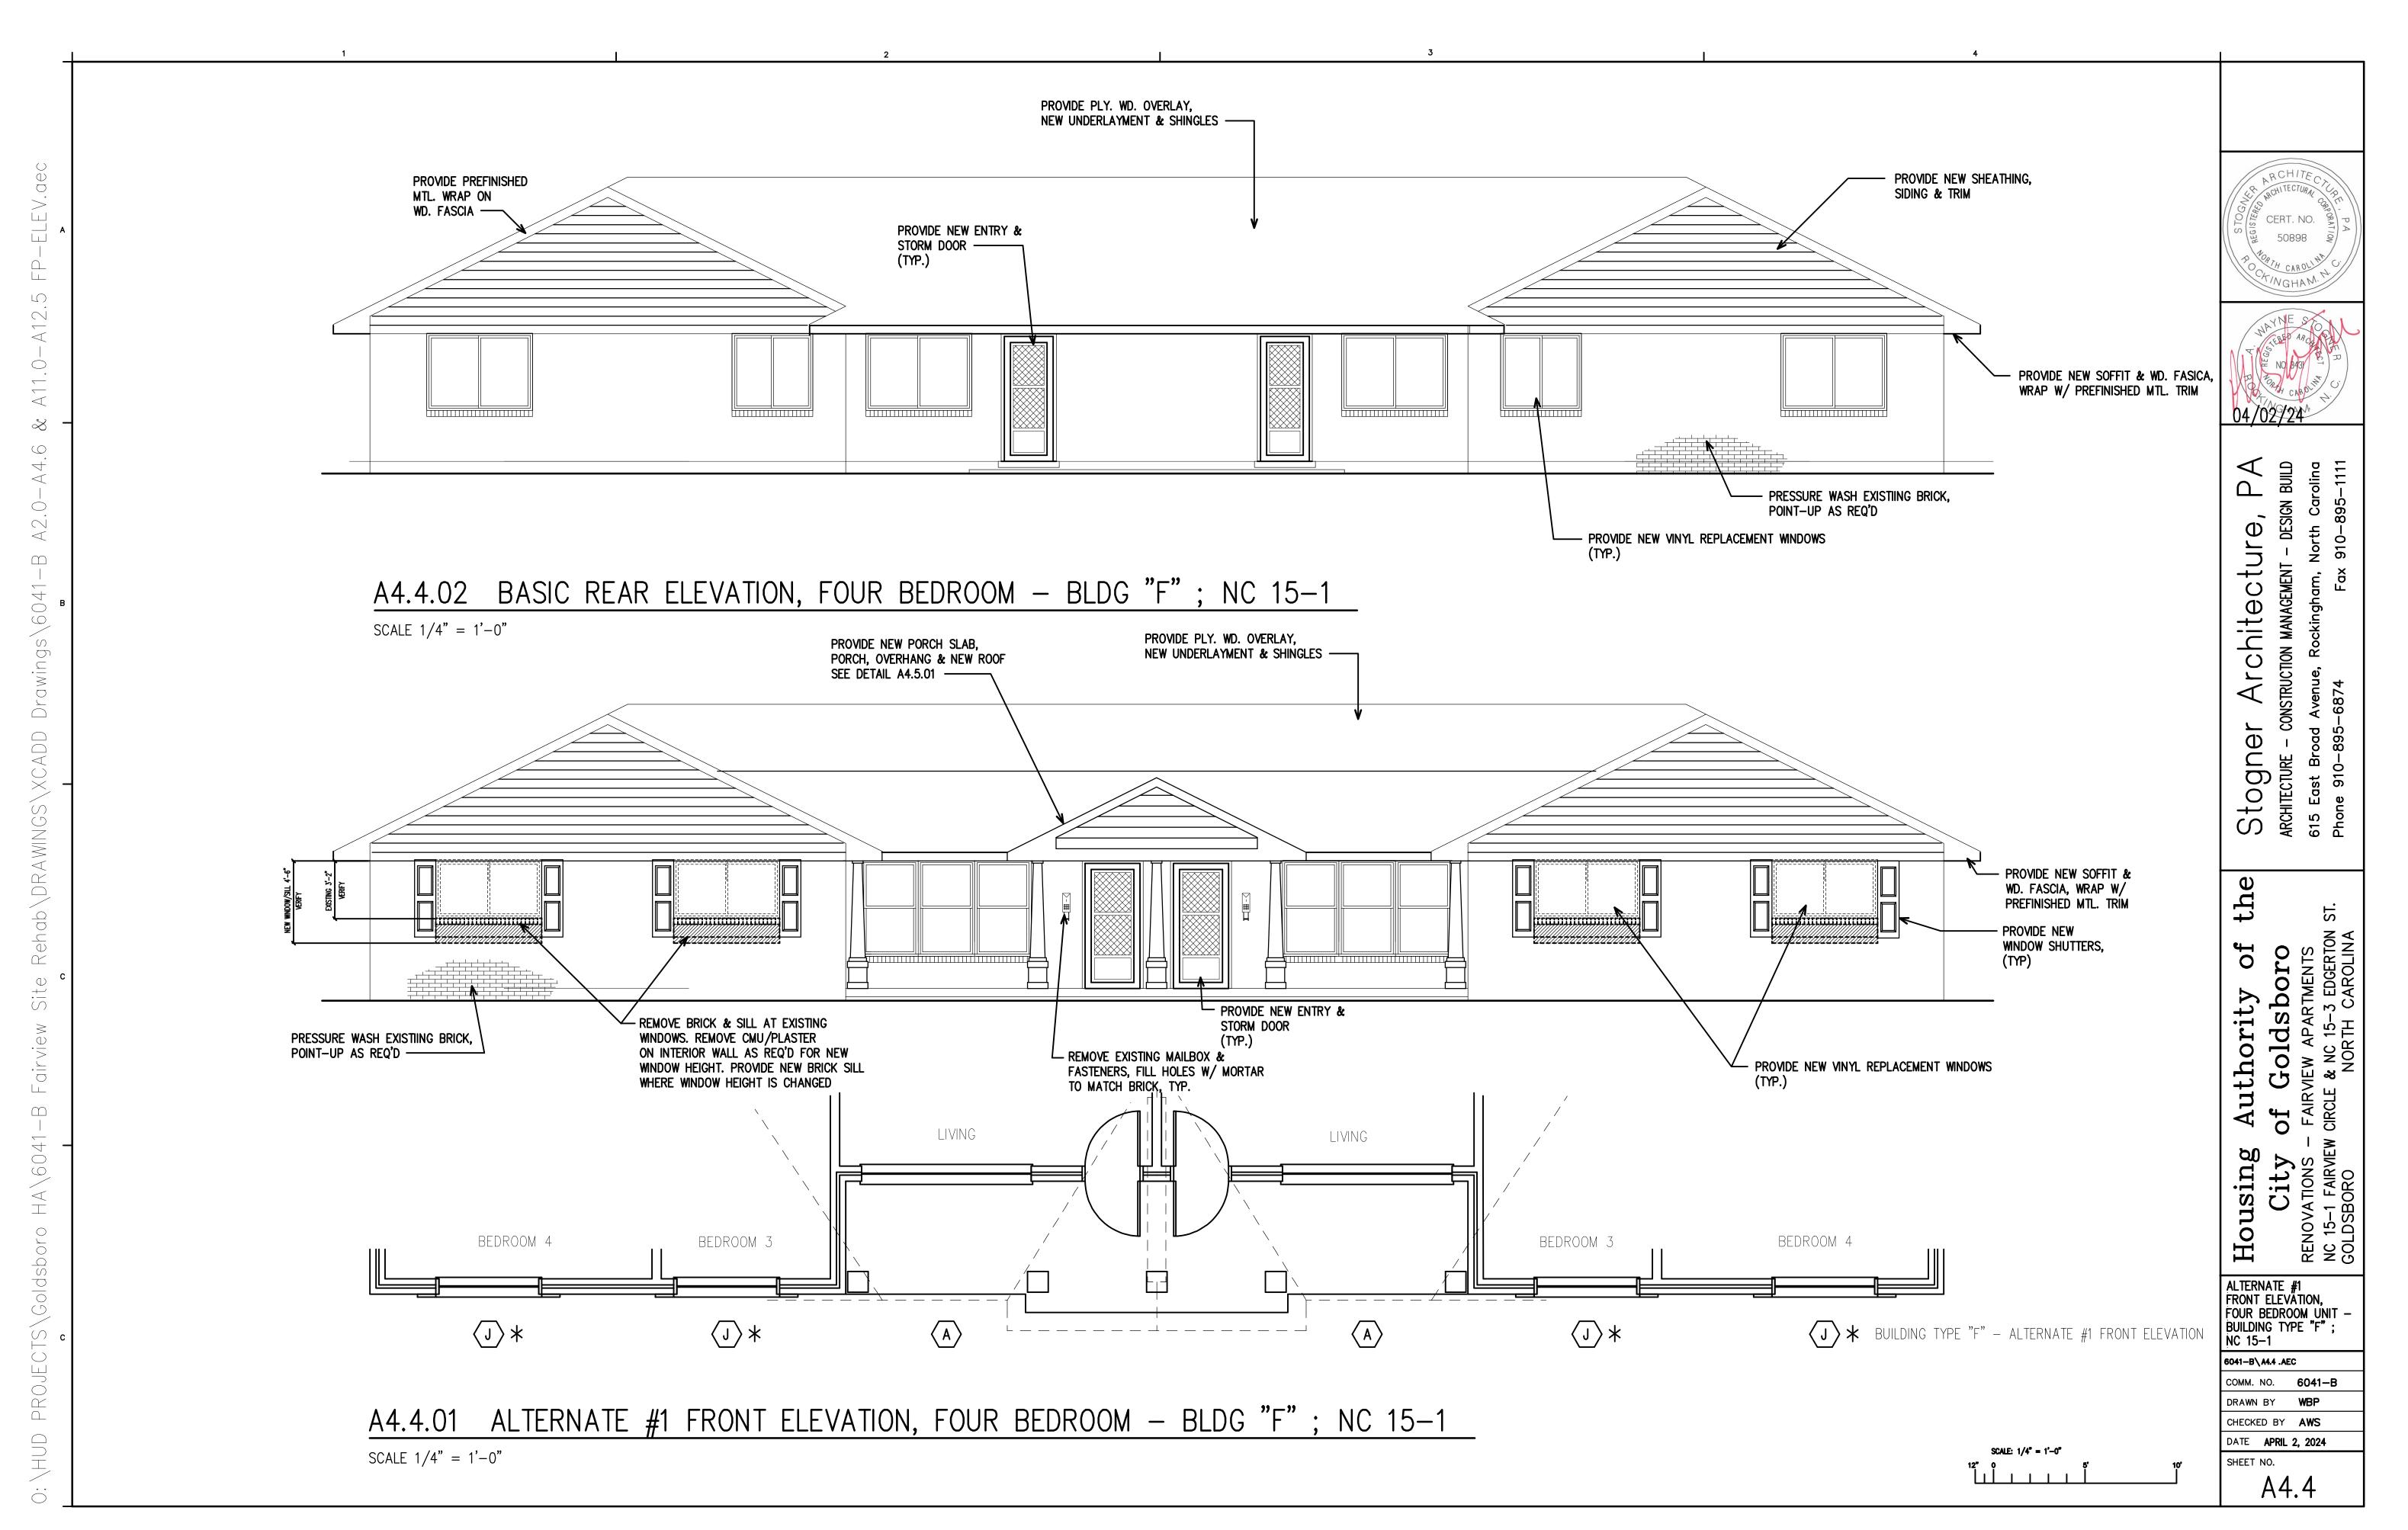
SEE SHEET A2.0 FOR DEMOLITION KEYNOTES SEE SHEET A2.1 FOR RENOVATION KEYNOTES CERT. NO. 04/02/24 rchitectur BUILDING TYPE 'F-1' DEMOLITION/RENOVATION FLOOR PLAN, FOUR BEDROOM UNIT - BUILDING TYPE "F-1"; NC 15-1 6041-B\A4.2 .AEC COMM. NO. **6041-B** DRAWN BY WBP


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CHECKED BY AWS DATE **APRIL 2, 2024** 

A4.2

SHEET NO.



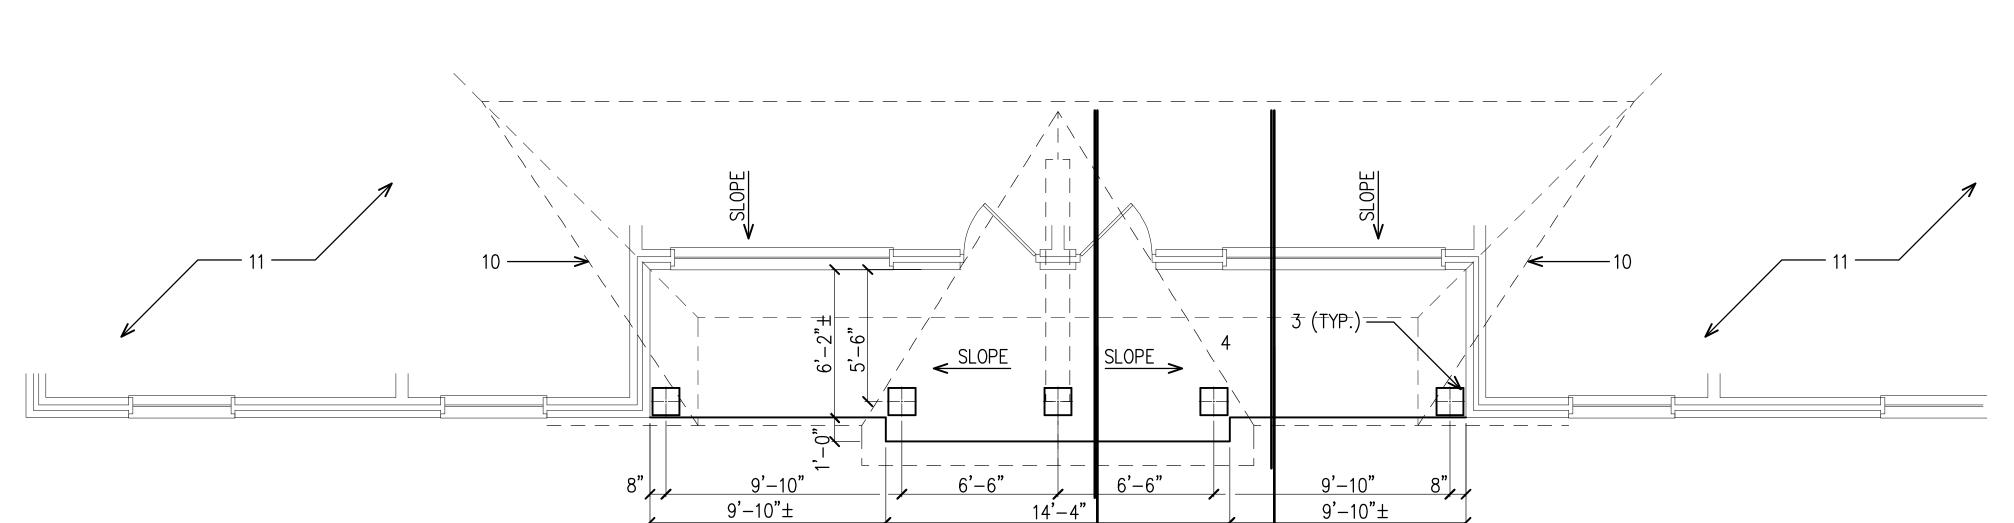

A5.1.01 —

A5.2.01

## KEYNOTES - REVISED PORCH/ROOF, FRONT ELEVATION

- 1. PROVIDE NEW WINDOW SHUTTERS.
- 2. PROVIDE NEW SIDING AND TRIM.
- 3. PROVIDE NEW PORCH COLUMN.
- 4. PROVIDE NEW FRONT PORCH SLAD. POUR WITH 3000PSI CONCRETE.
- 5. REMOVE EXISTING METAL WRAP FROM FREIZE BOARD AND EXISTING WOOD, VENTED SOFFIT.

PROVIDE NEW 2x6 WOOD FASCIA AND SOFFIT CONTINUOUS. WRAP FASCIA WITH NEW PRE FINISHED METAL. SEE DETAIL A5.5.

- 6. NOT USED.
- 7. EXISTING BRICK. CLEAN, PATCH AND POINT-UP AS REQUIRED.
- 8. EXISTING ENTRY DOOR AND STORM DOOR TO REPLACED.
- 9. EXISTING WINDOWS TO BE REPLACED.
- 10. PROVIDE NEW PORCH, OVERHANG AND ROOF.
- 11. EXISTING ROOF, SEE SHEET A1.0-A1.6 FOR WORK ASSOCIATED WITH ROOF
- 12. REMOVE EXISTING SIDING, TRIM & SHEATHING COMPLETE. PROVIDE NEW SIDING AND TRIM.

CERT. NO.



REVISED PORCH/ROOF PLAN, FRONT ELEVATION, FOUR BEDROOM UNIT — BUILDING TYPE "F";


6041-B\A4.5 .AEC

COMM. NO. **6041-B** DRAWN BY WBP CHECKED BY AWS

DATE APRIL 2, 2024


SHEET NO. A4.5


A4.5.01 REVISED PORCH/ROOF PLAN, FOUR BEDROOM UNIT - BUILDING TYPE "F"; NC 15-1 SCALE: 1/8" = 1'-0"

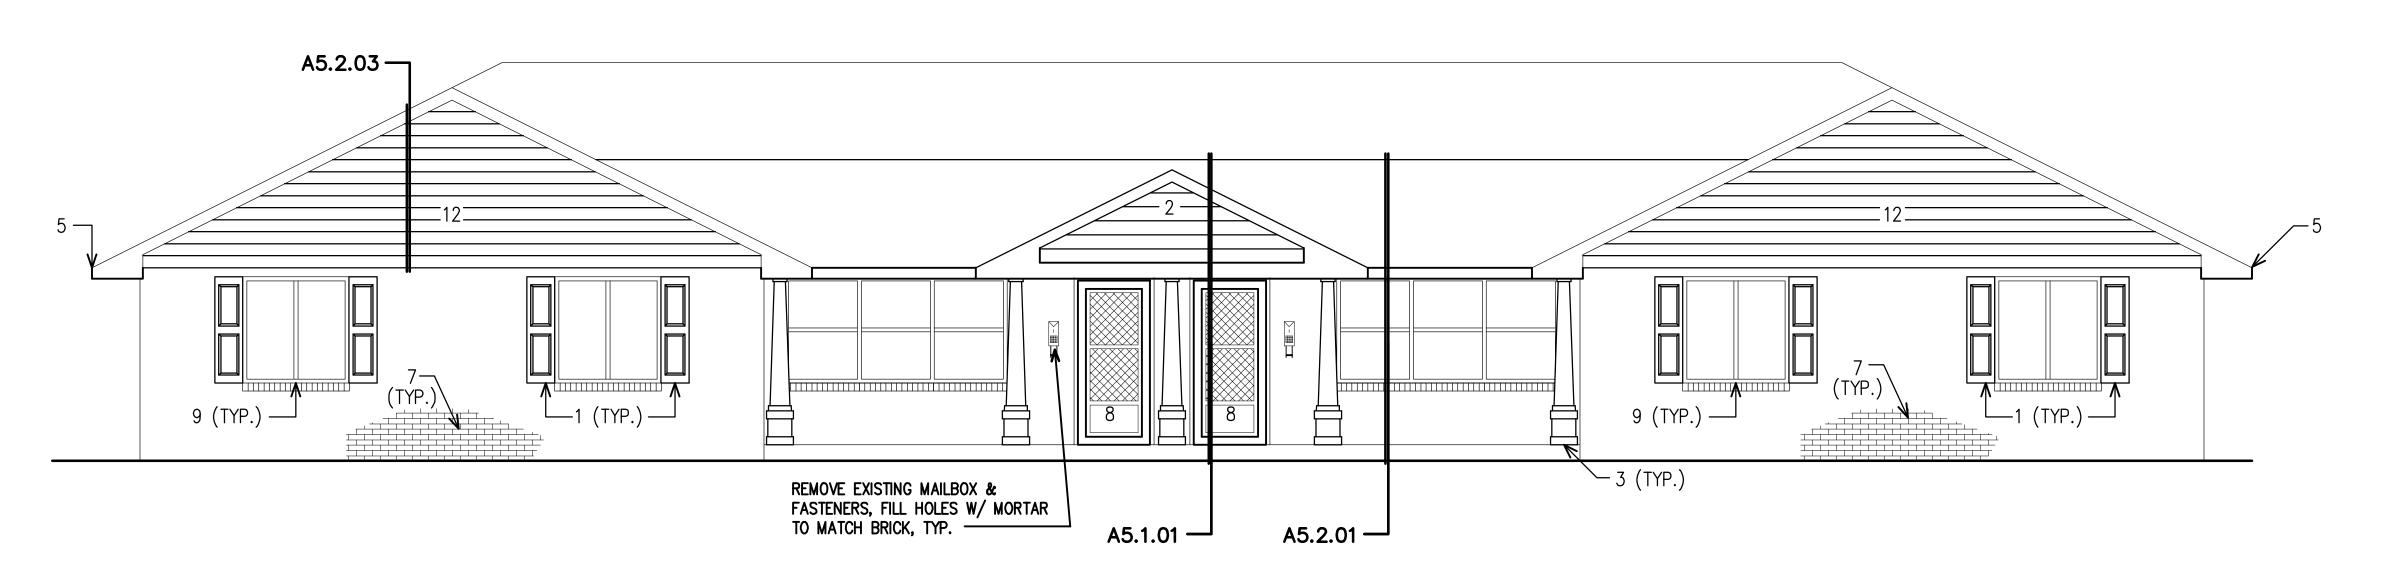


A4.5.02 REVISED ELEVATION, FOUR BEDROOM UNIT - BUILDING TYPE "F"; NC 15-1 SCALE: 1/4" = 1'-0"

SCALE:  $1/4^{\circ} = 1'-0''$ 

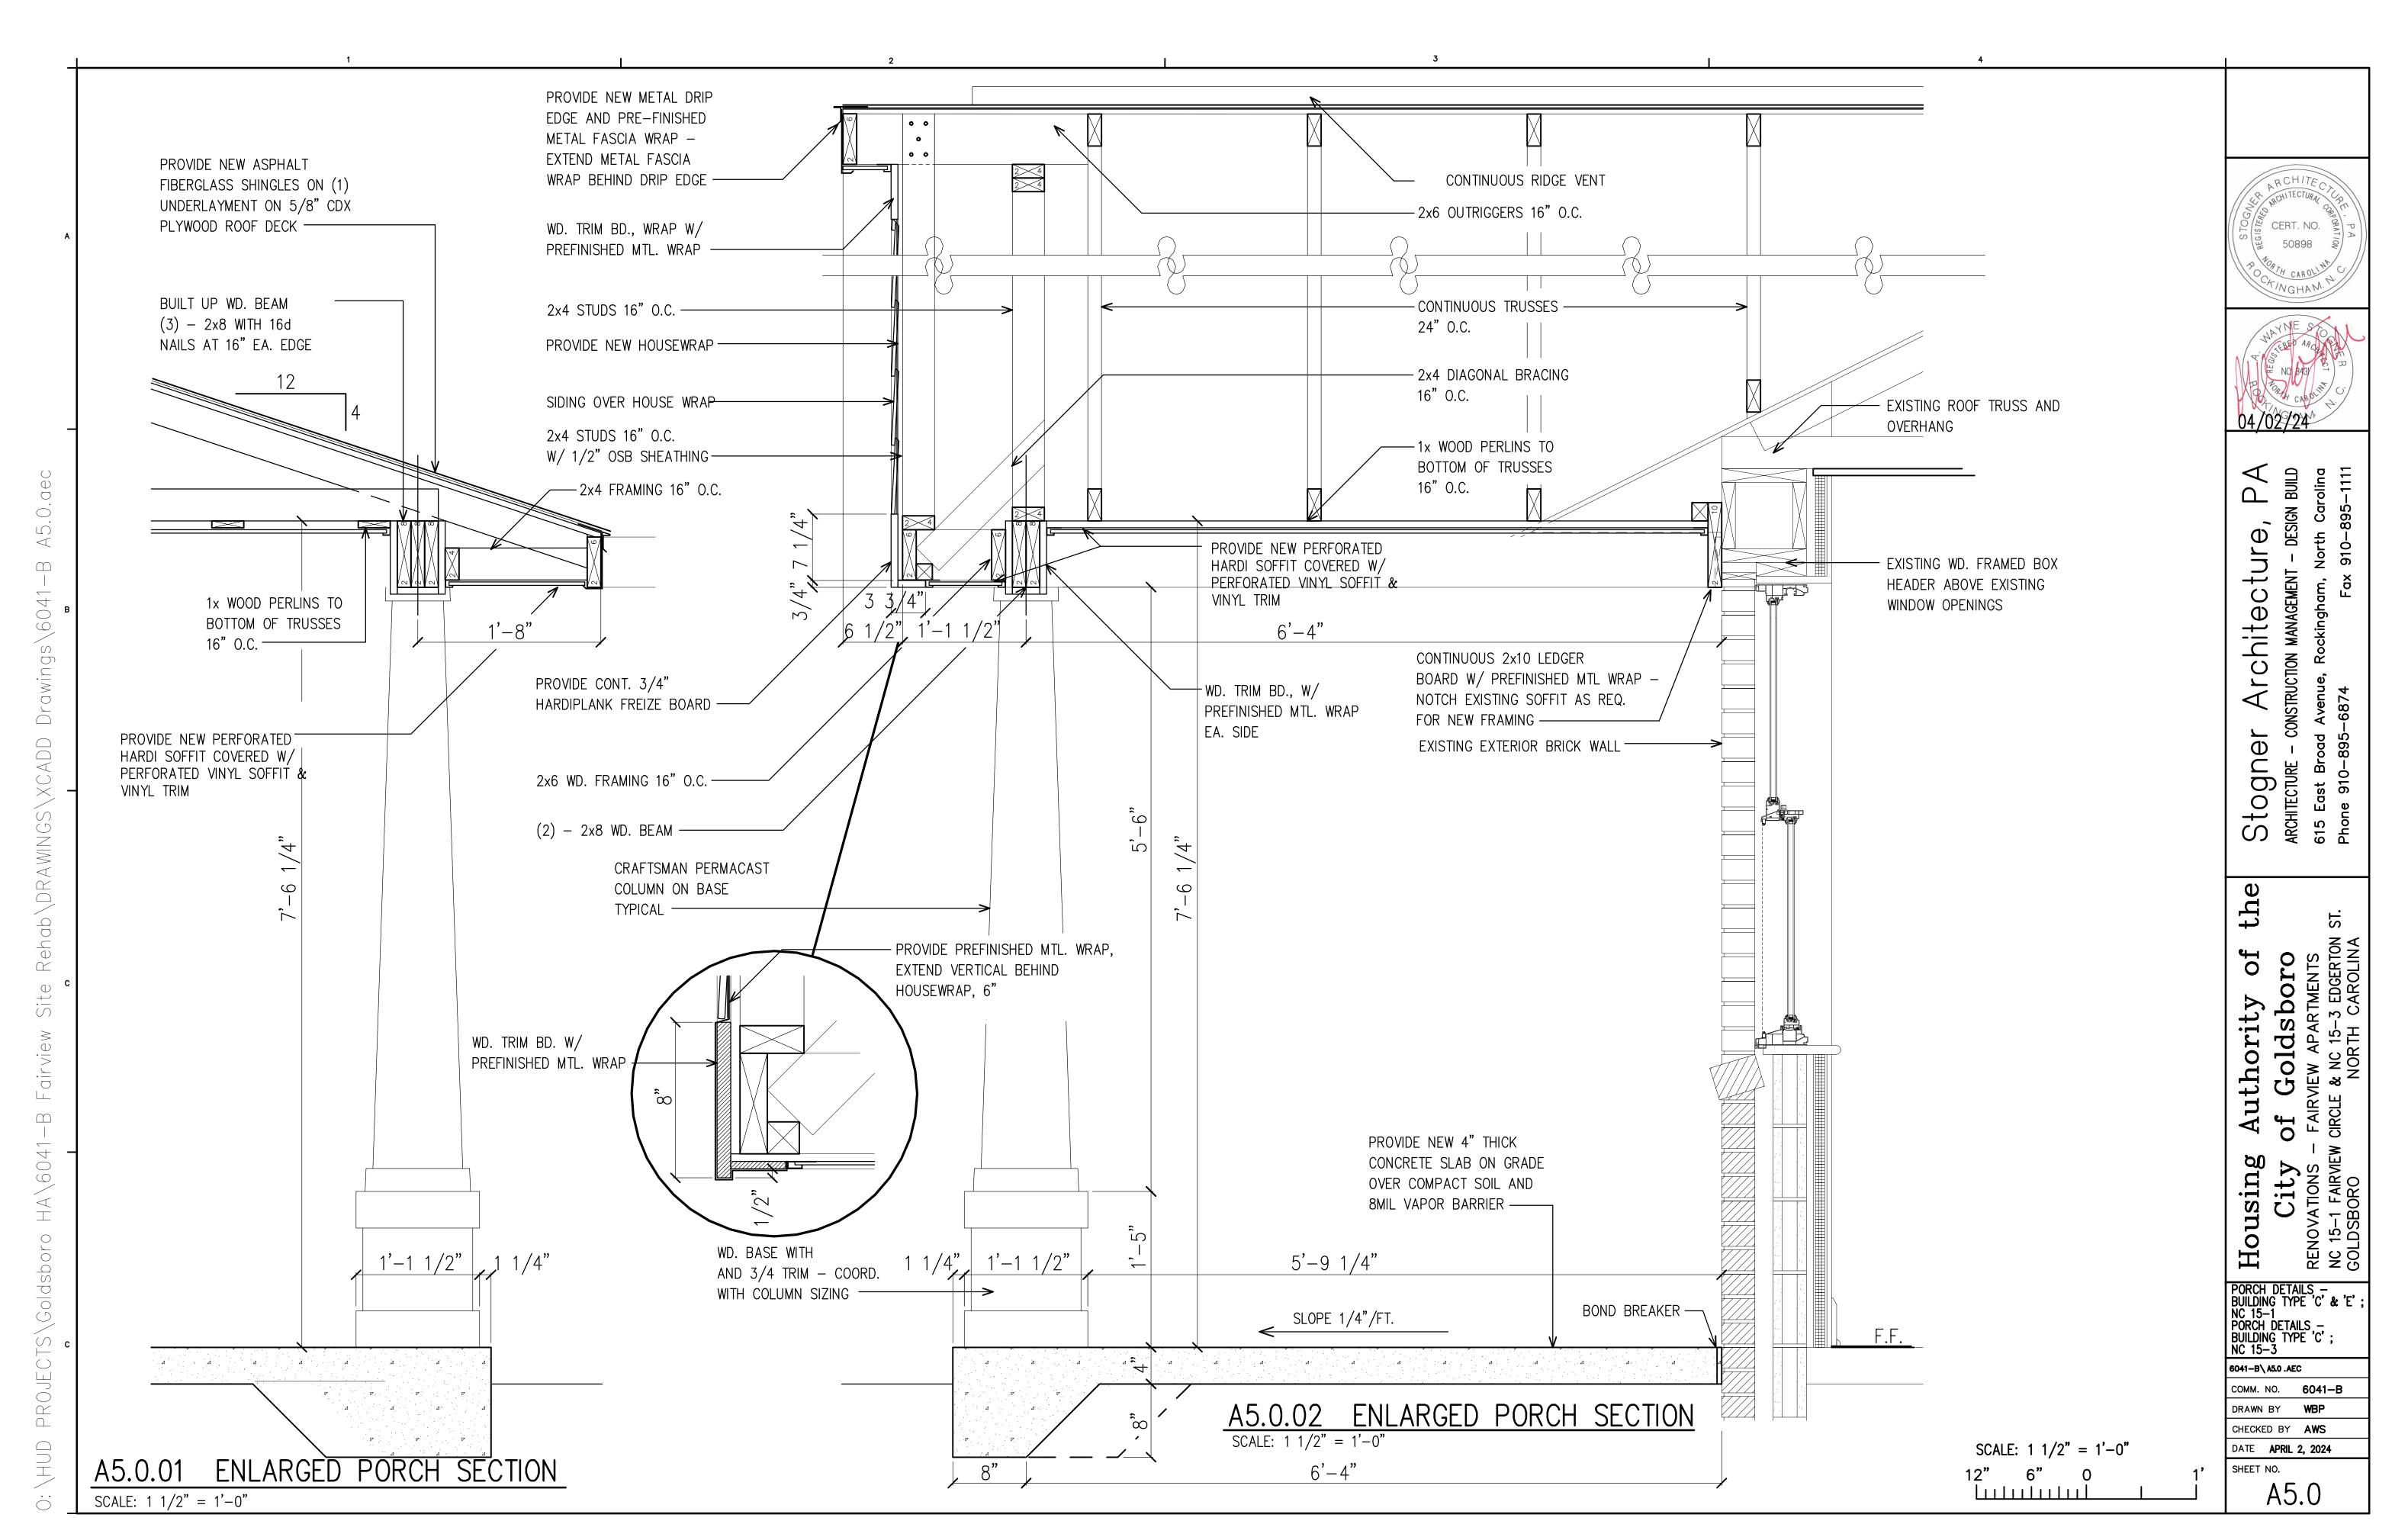

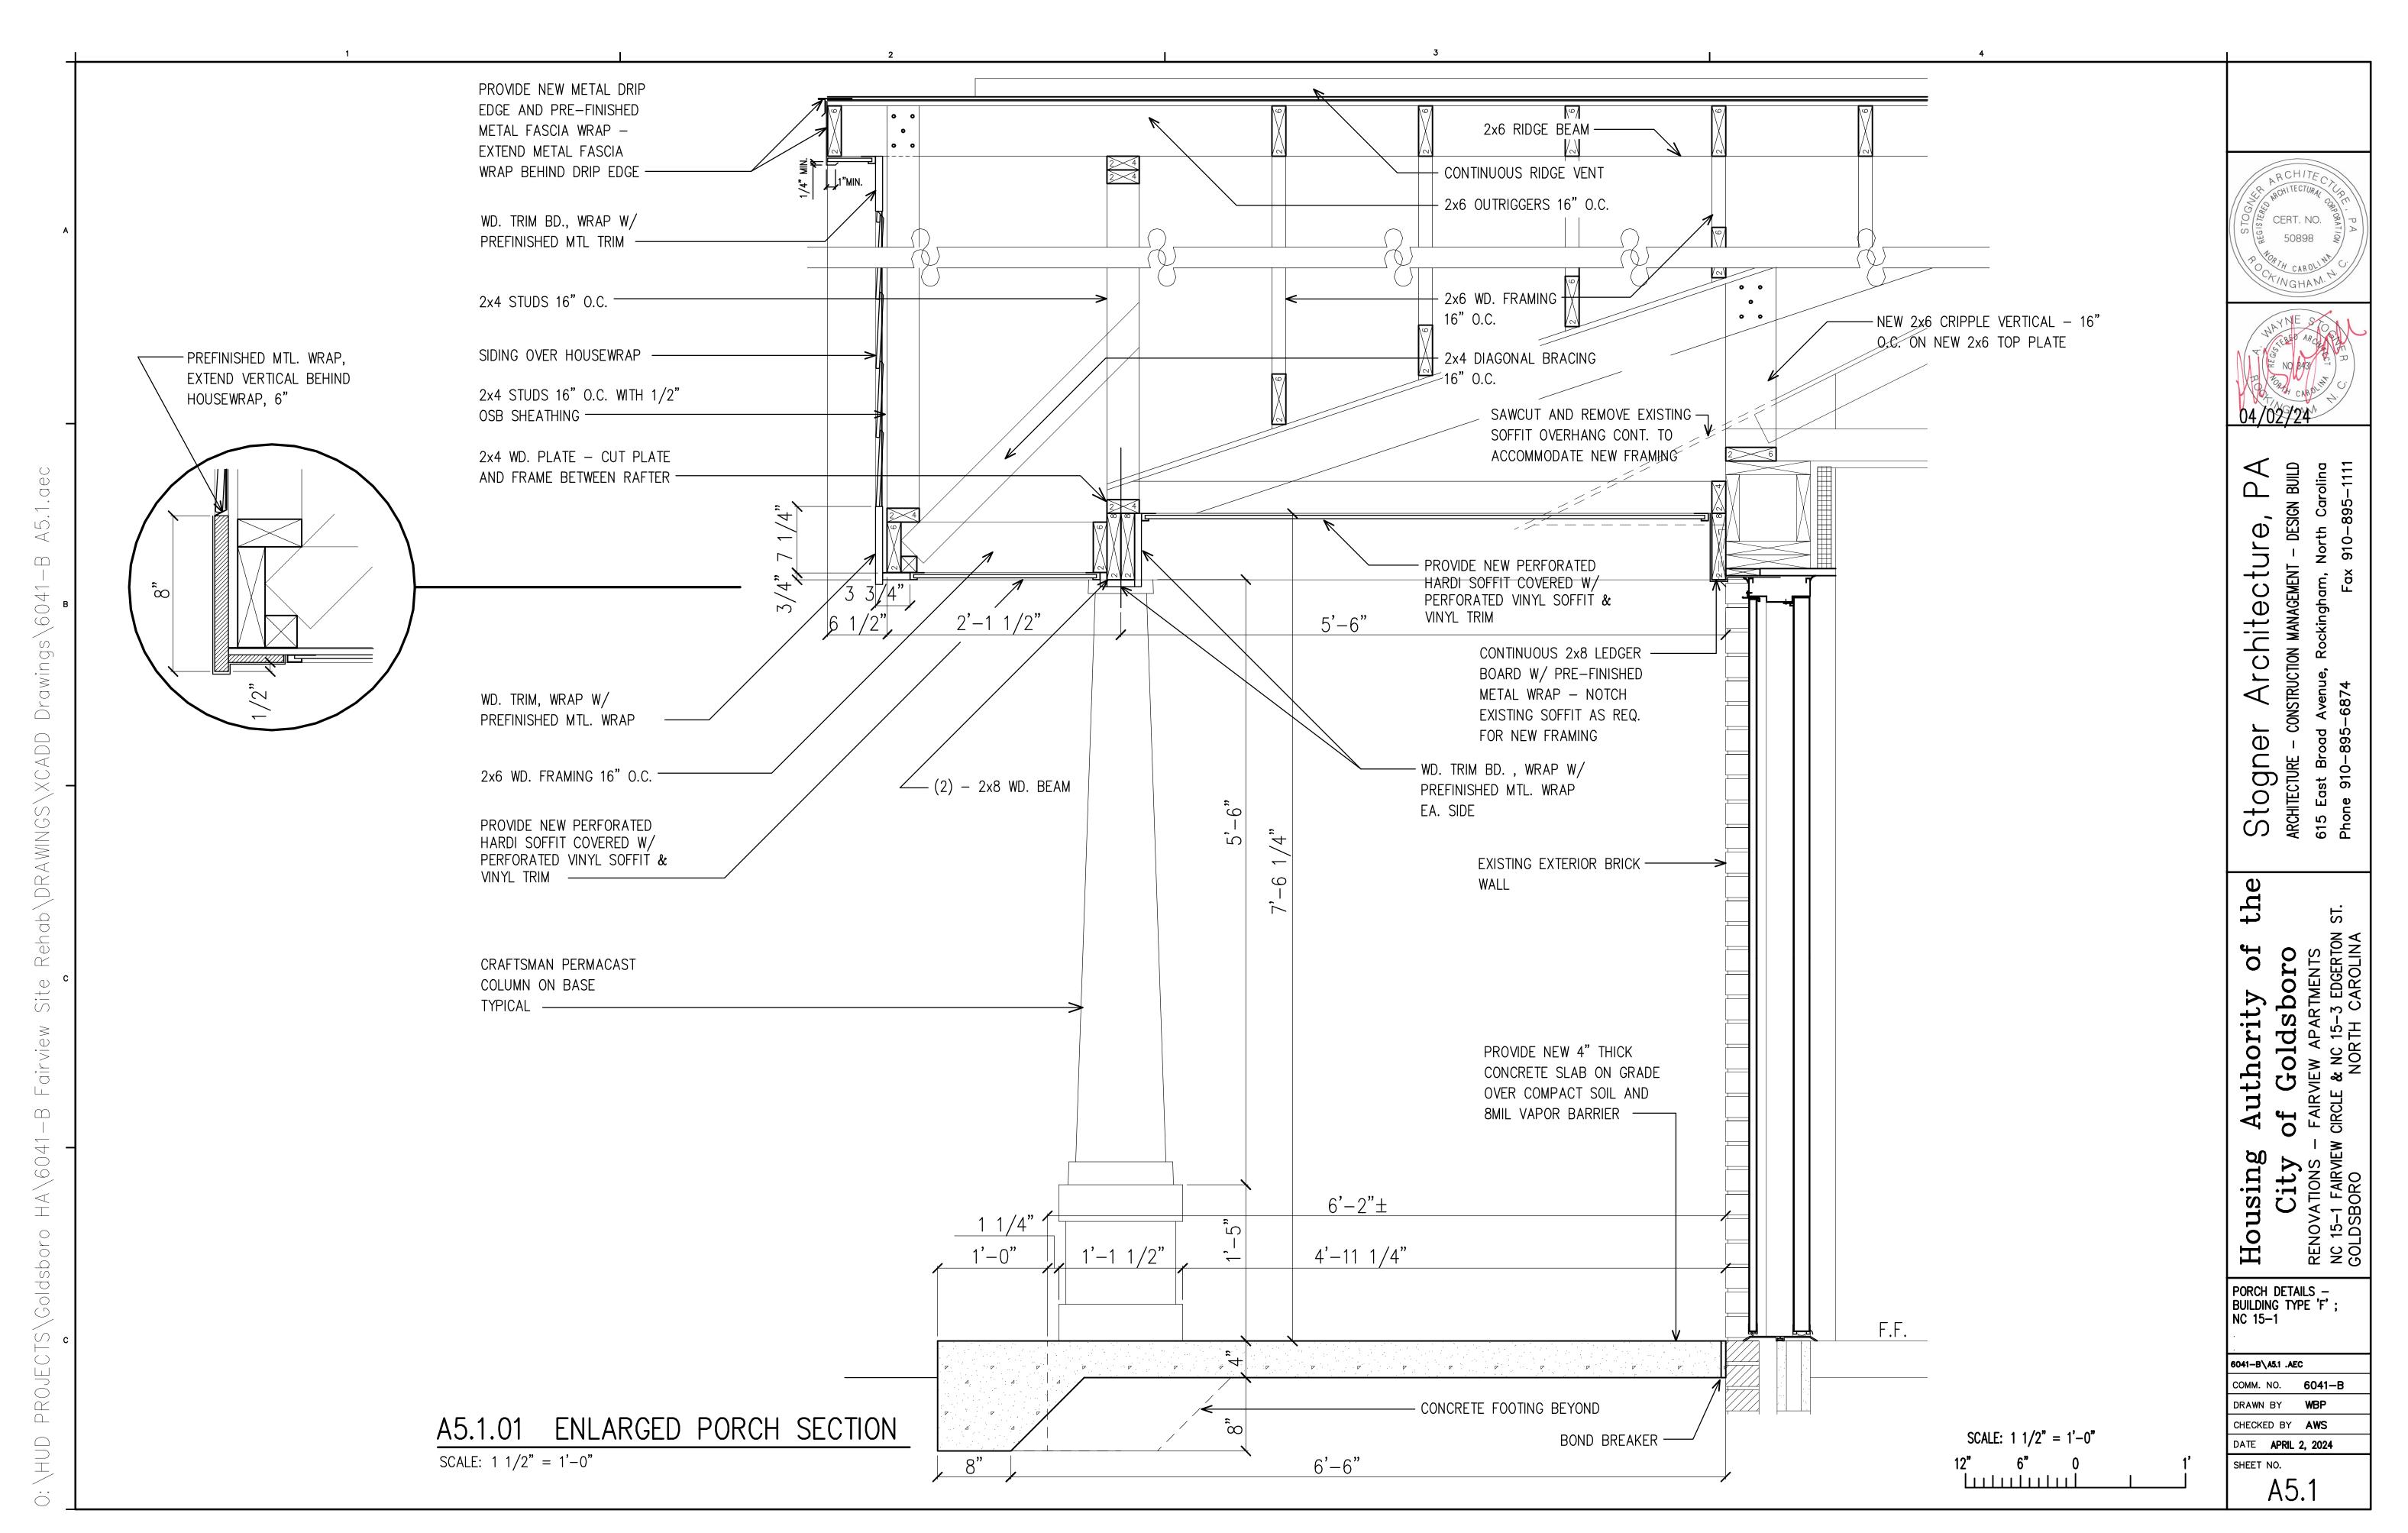

CERT. NO. 50898

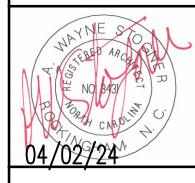



 $_{\rm MSN}$  BUILD Carolina 395-1111

PORCH DETAILS — BUILDING TYPE 'F', TYPICAL SOFFIT & RAKE DETAIL ; NC 15-1

COMM. NO. **6041-B** DRAWN BY WBP CHECKED BY AWS

DATE **APRIL 2, 2024** 

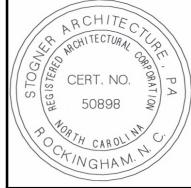

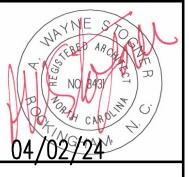


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EXISTING/DEMO SECTION AT TYP. WINDOW NC 15-1 & NC 15-3

6041-B\ A5.3.AEC COMM. NO. **6041-B** DRAWN BY WBP

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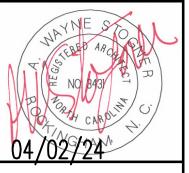
NEW/RENO SECTION AT TYP. WINDOW NC 15-1 & NC 15-3

6041-B\ A5.4.AEC
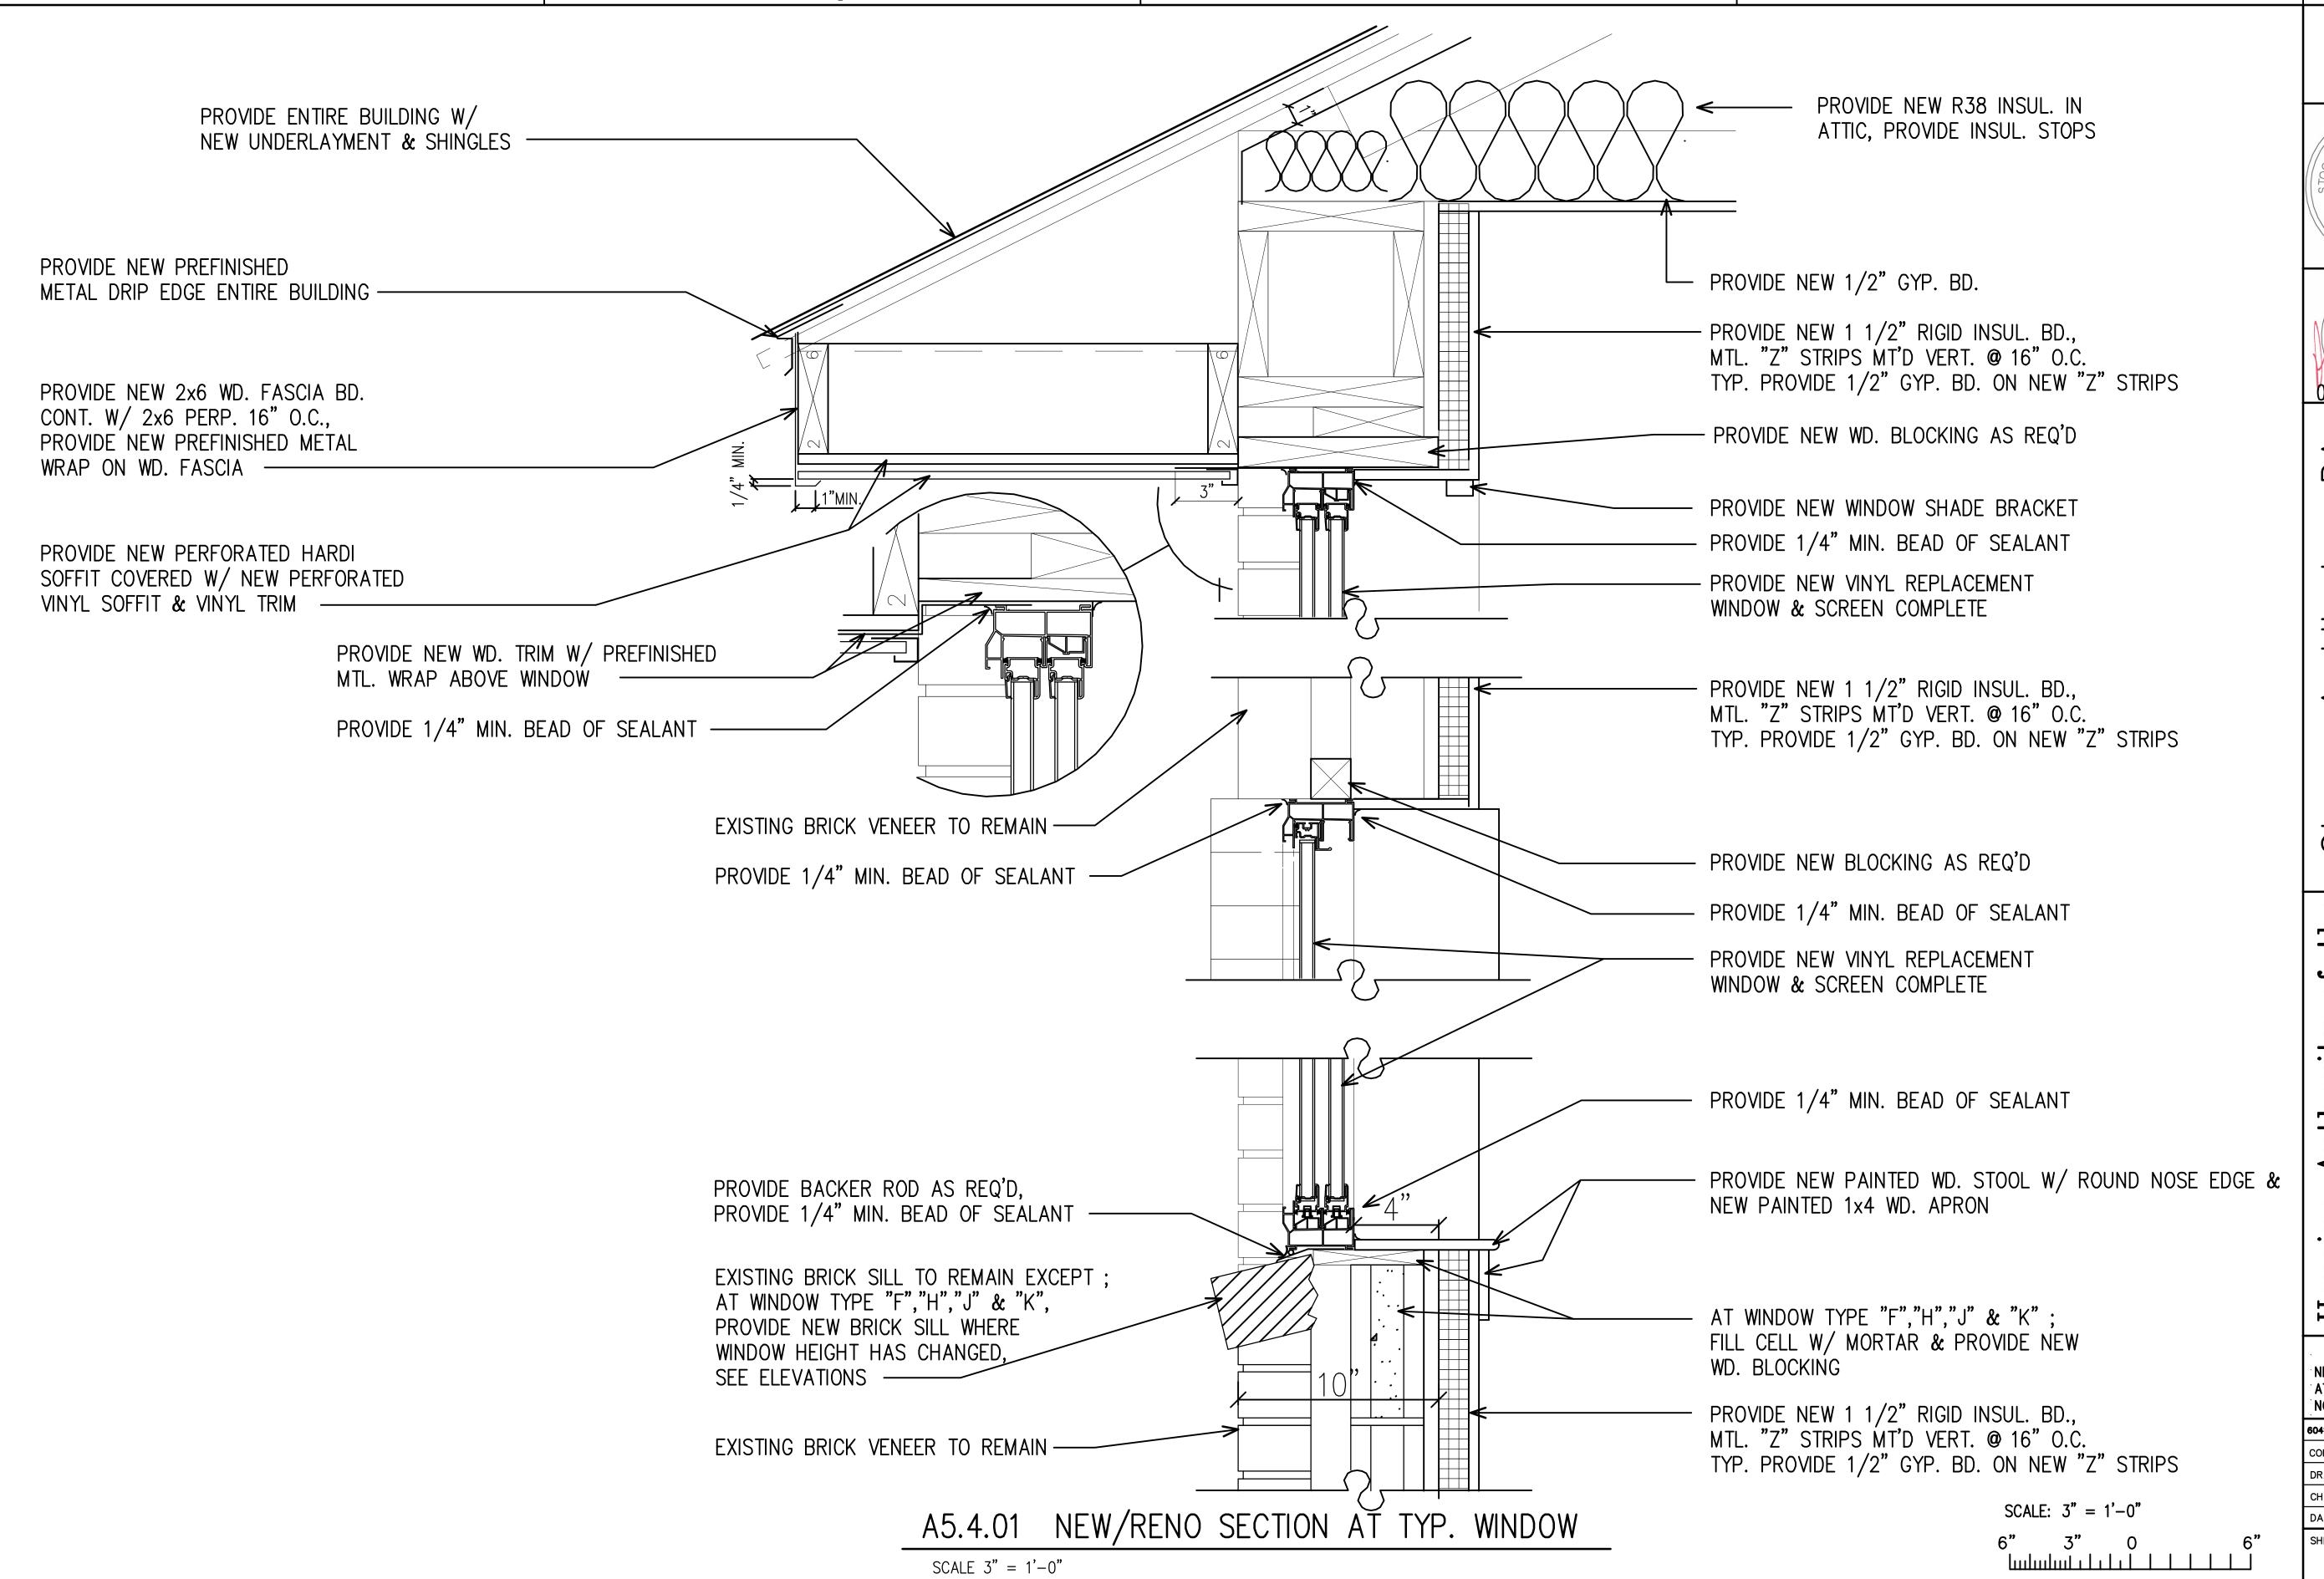
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DATE **APRIL 2, 2024** SHEET NO. A5.4





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EXISTING/DEMO SECTION AT WINDOW NC 15-1 & NC 15-3

6041-B\ A5.4A.AEC


COMM. NO. **6041-B** DRAWN BY WBP CHECKED BY AWS

DATE **APRIL 2, 2024** SHEET NO. A5.4A



PROVIDE NEW R38 INSUL. IN

ATTIC, PROVIDE INSUL. STOPS

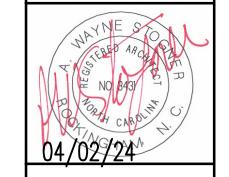

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NEW WD. BLOCKING

- NEW HOLLOW METAL

PROVIDE BLOCKING &

FILL CELL W/ MORTAR

1/4" ANCHOR BOLT,

- NEW THRESHOLD IN


BED OF SEALANT

SCALE: 3'' = 1'-0''

DOOR FRAME

Housing

NEW/RENO SECTION AT WINDOW NC 15-1 & NC 15-3 6041-B\ A5.4B.AEC COMM. NO. **6041-B** DRAWN BY WBP CHECKED BY AWS DATE **APRIL 2, 2024** SHEET NO. A5.4B

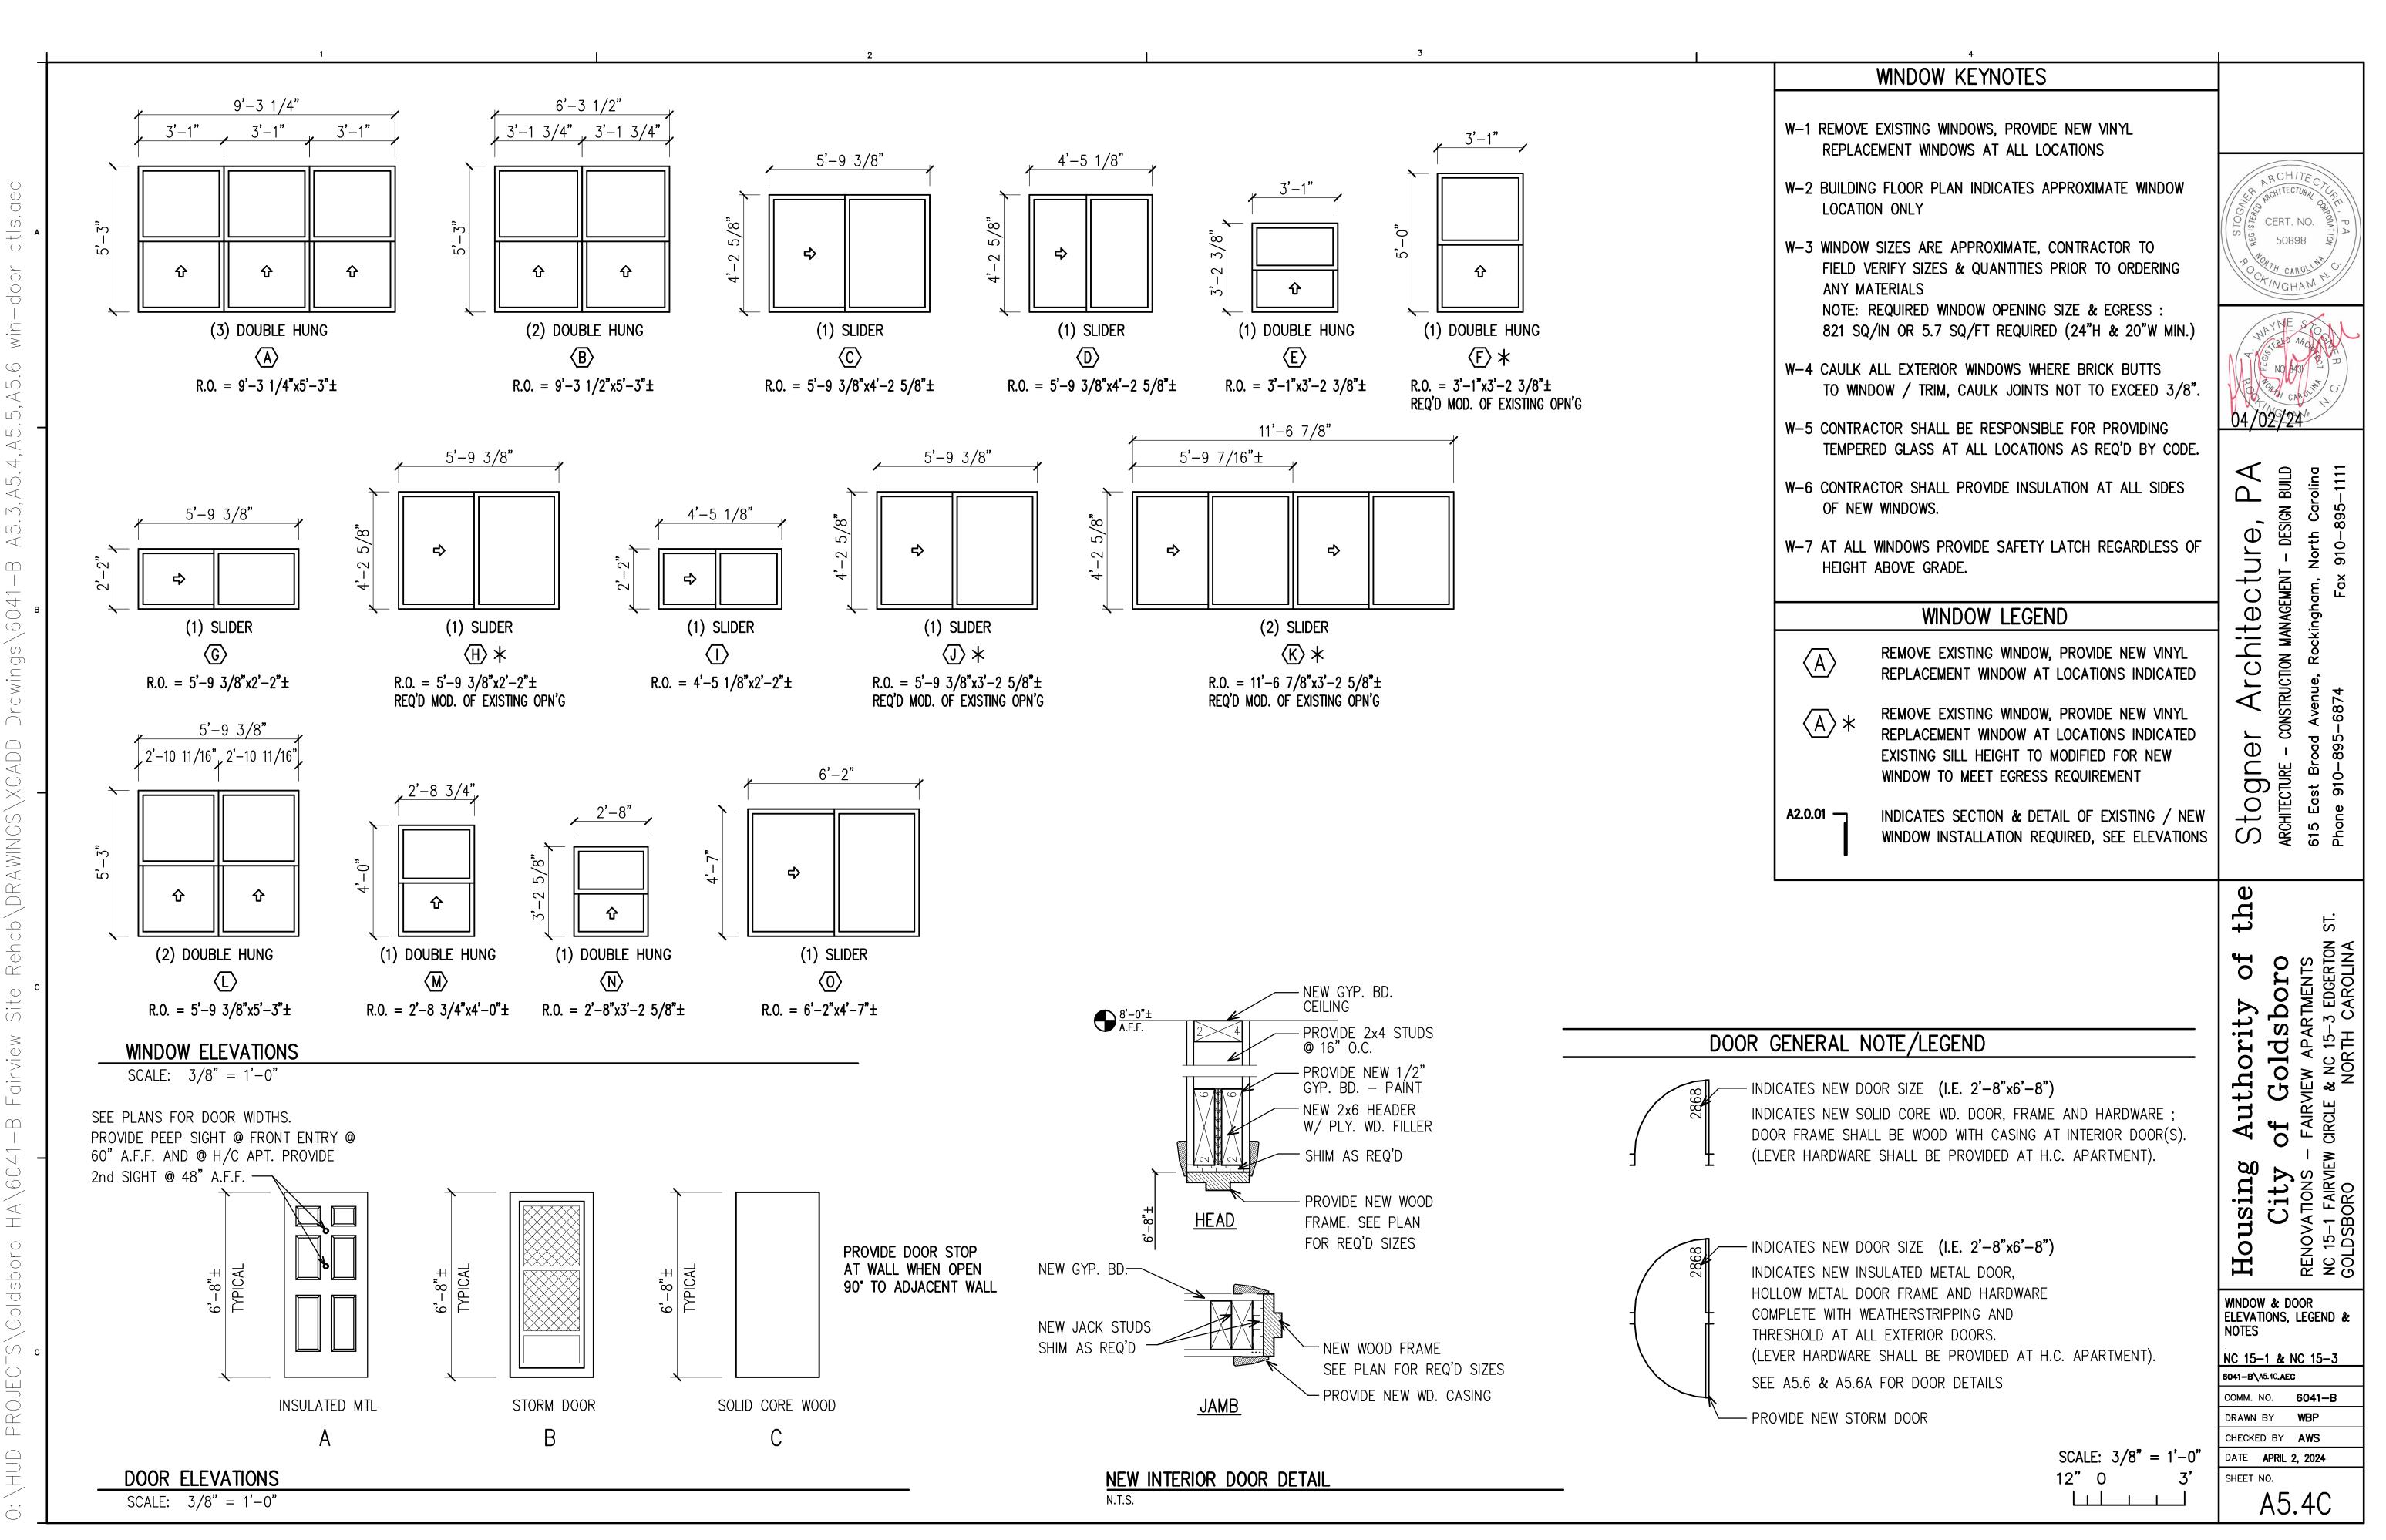





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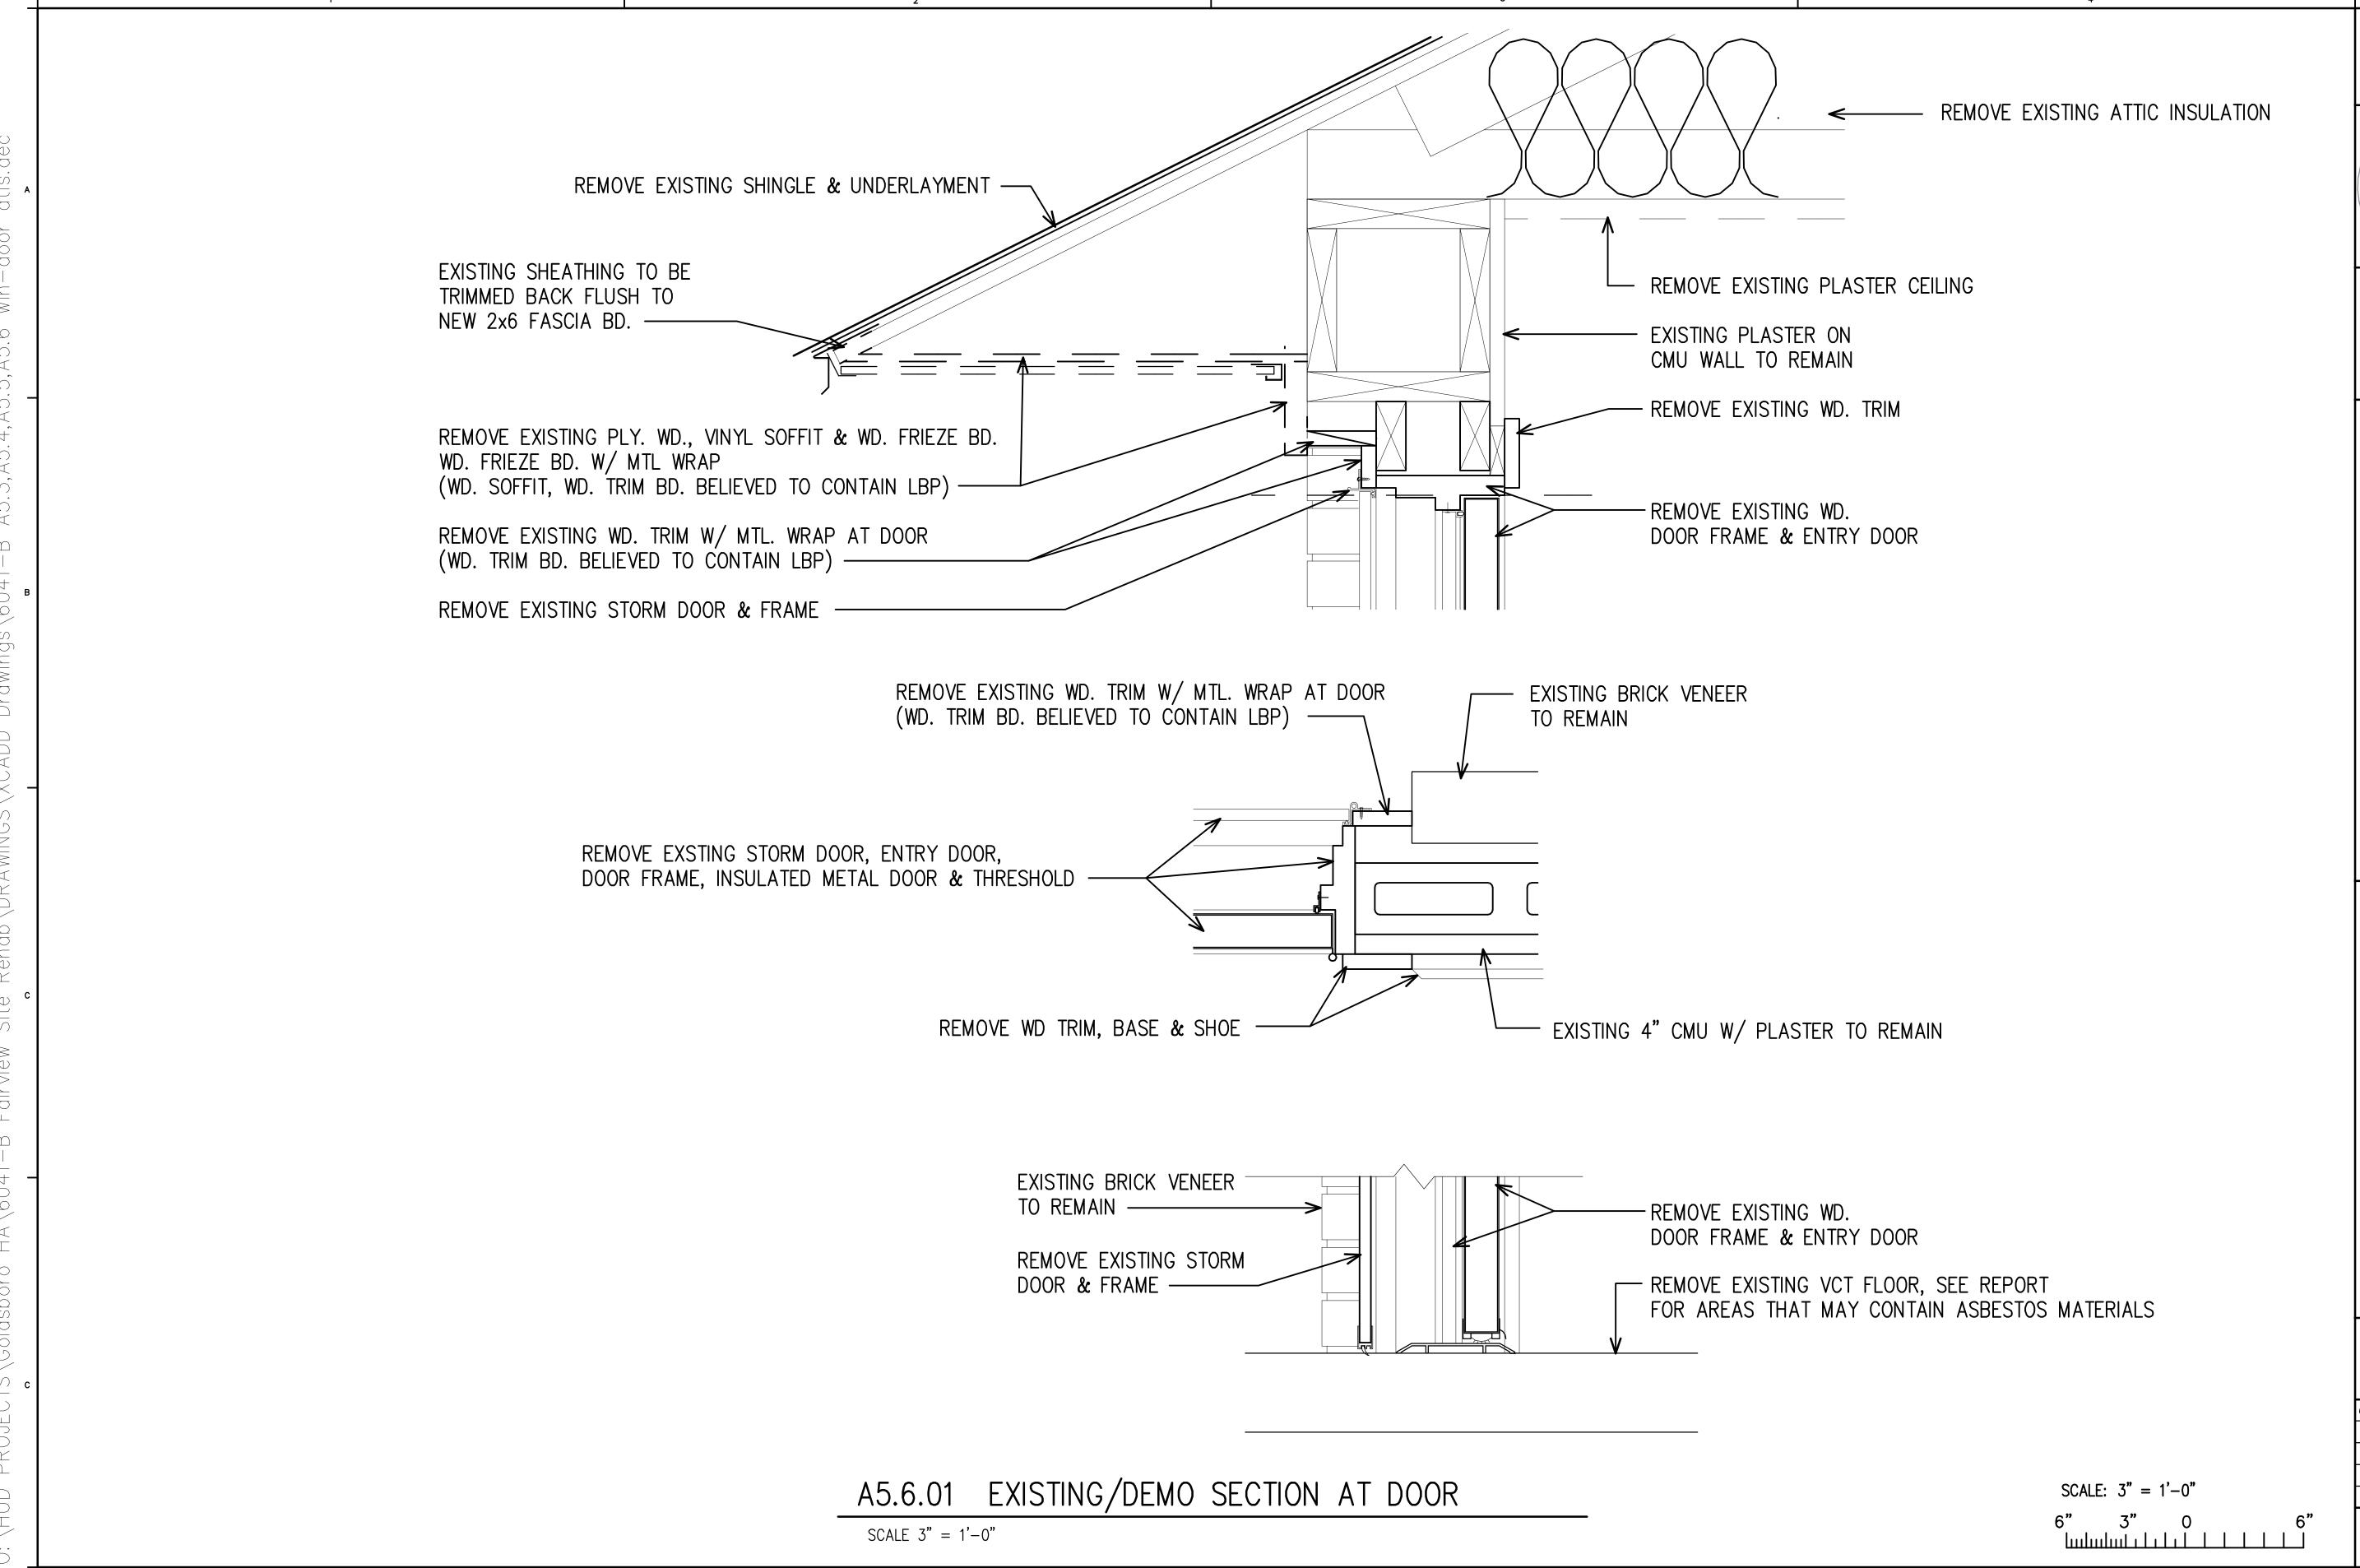
TYPICAL EXTERIOR WALL SECTION, NC 15-1 & NC 15-3


6041-B\ A5.5.AEC


COMM. NO. **6041-B** DRAWN BY WBP CHECKED BY AWS

DATE **APRIL 2, 2024** SHEET NO.

A5.5



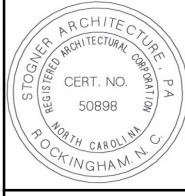

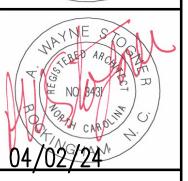

04/02/24

EXISTING/DEMO SECTION AT DOOR NC 15-1 & NC 15-3 6041-B\ A5.6.AEC COMM. NO. **6041-B** DRAWN BY WBP

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A5.6





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Housing Authority of the City of Goldsboro

HOUS

NEM/KENO SECTION

NC 15-1 F

GOLDSBO

AT DOOR NC 15-1 & NC 15-3

6041-B\ A5.6.AEC

COMM. NO. 6041-B


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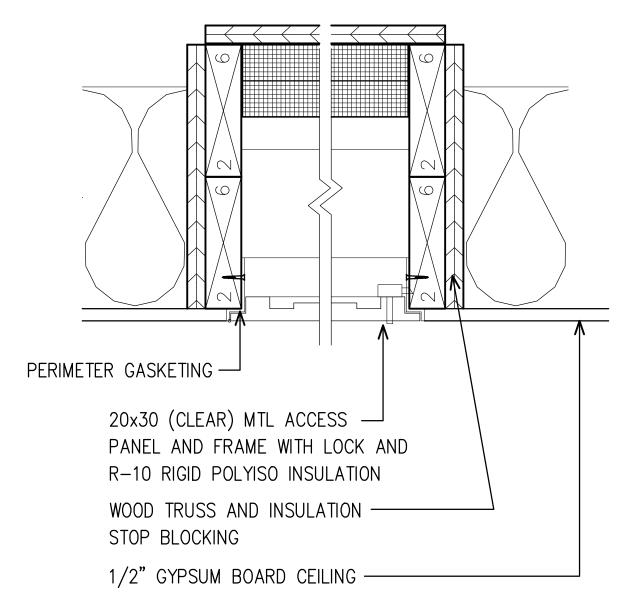
CHECKED BY AWS

DATE APRIL 2 2024

 DATE
 APRIL 2, 2024


 SHEET NO.
 A5.6A



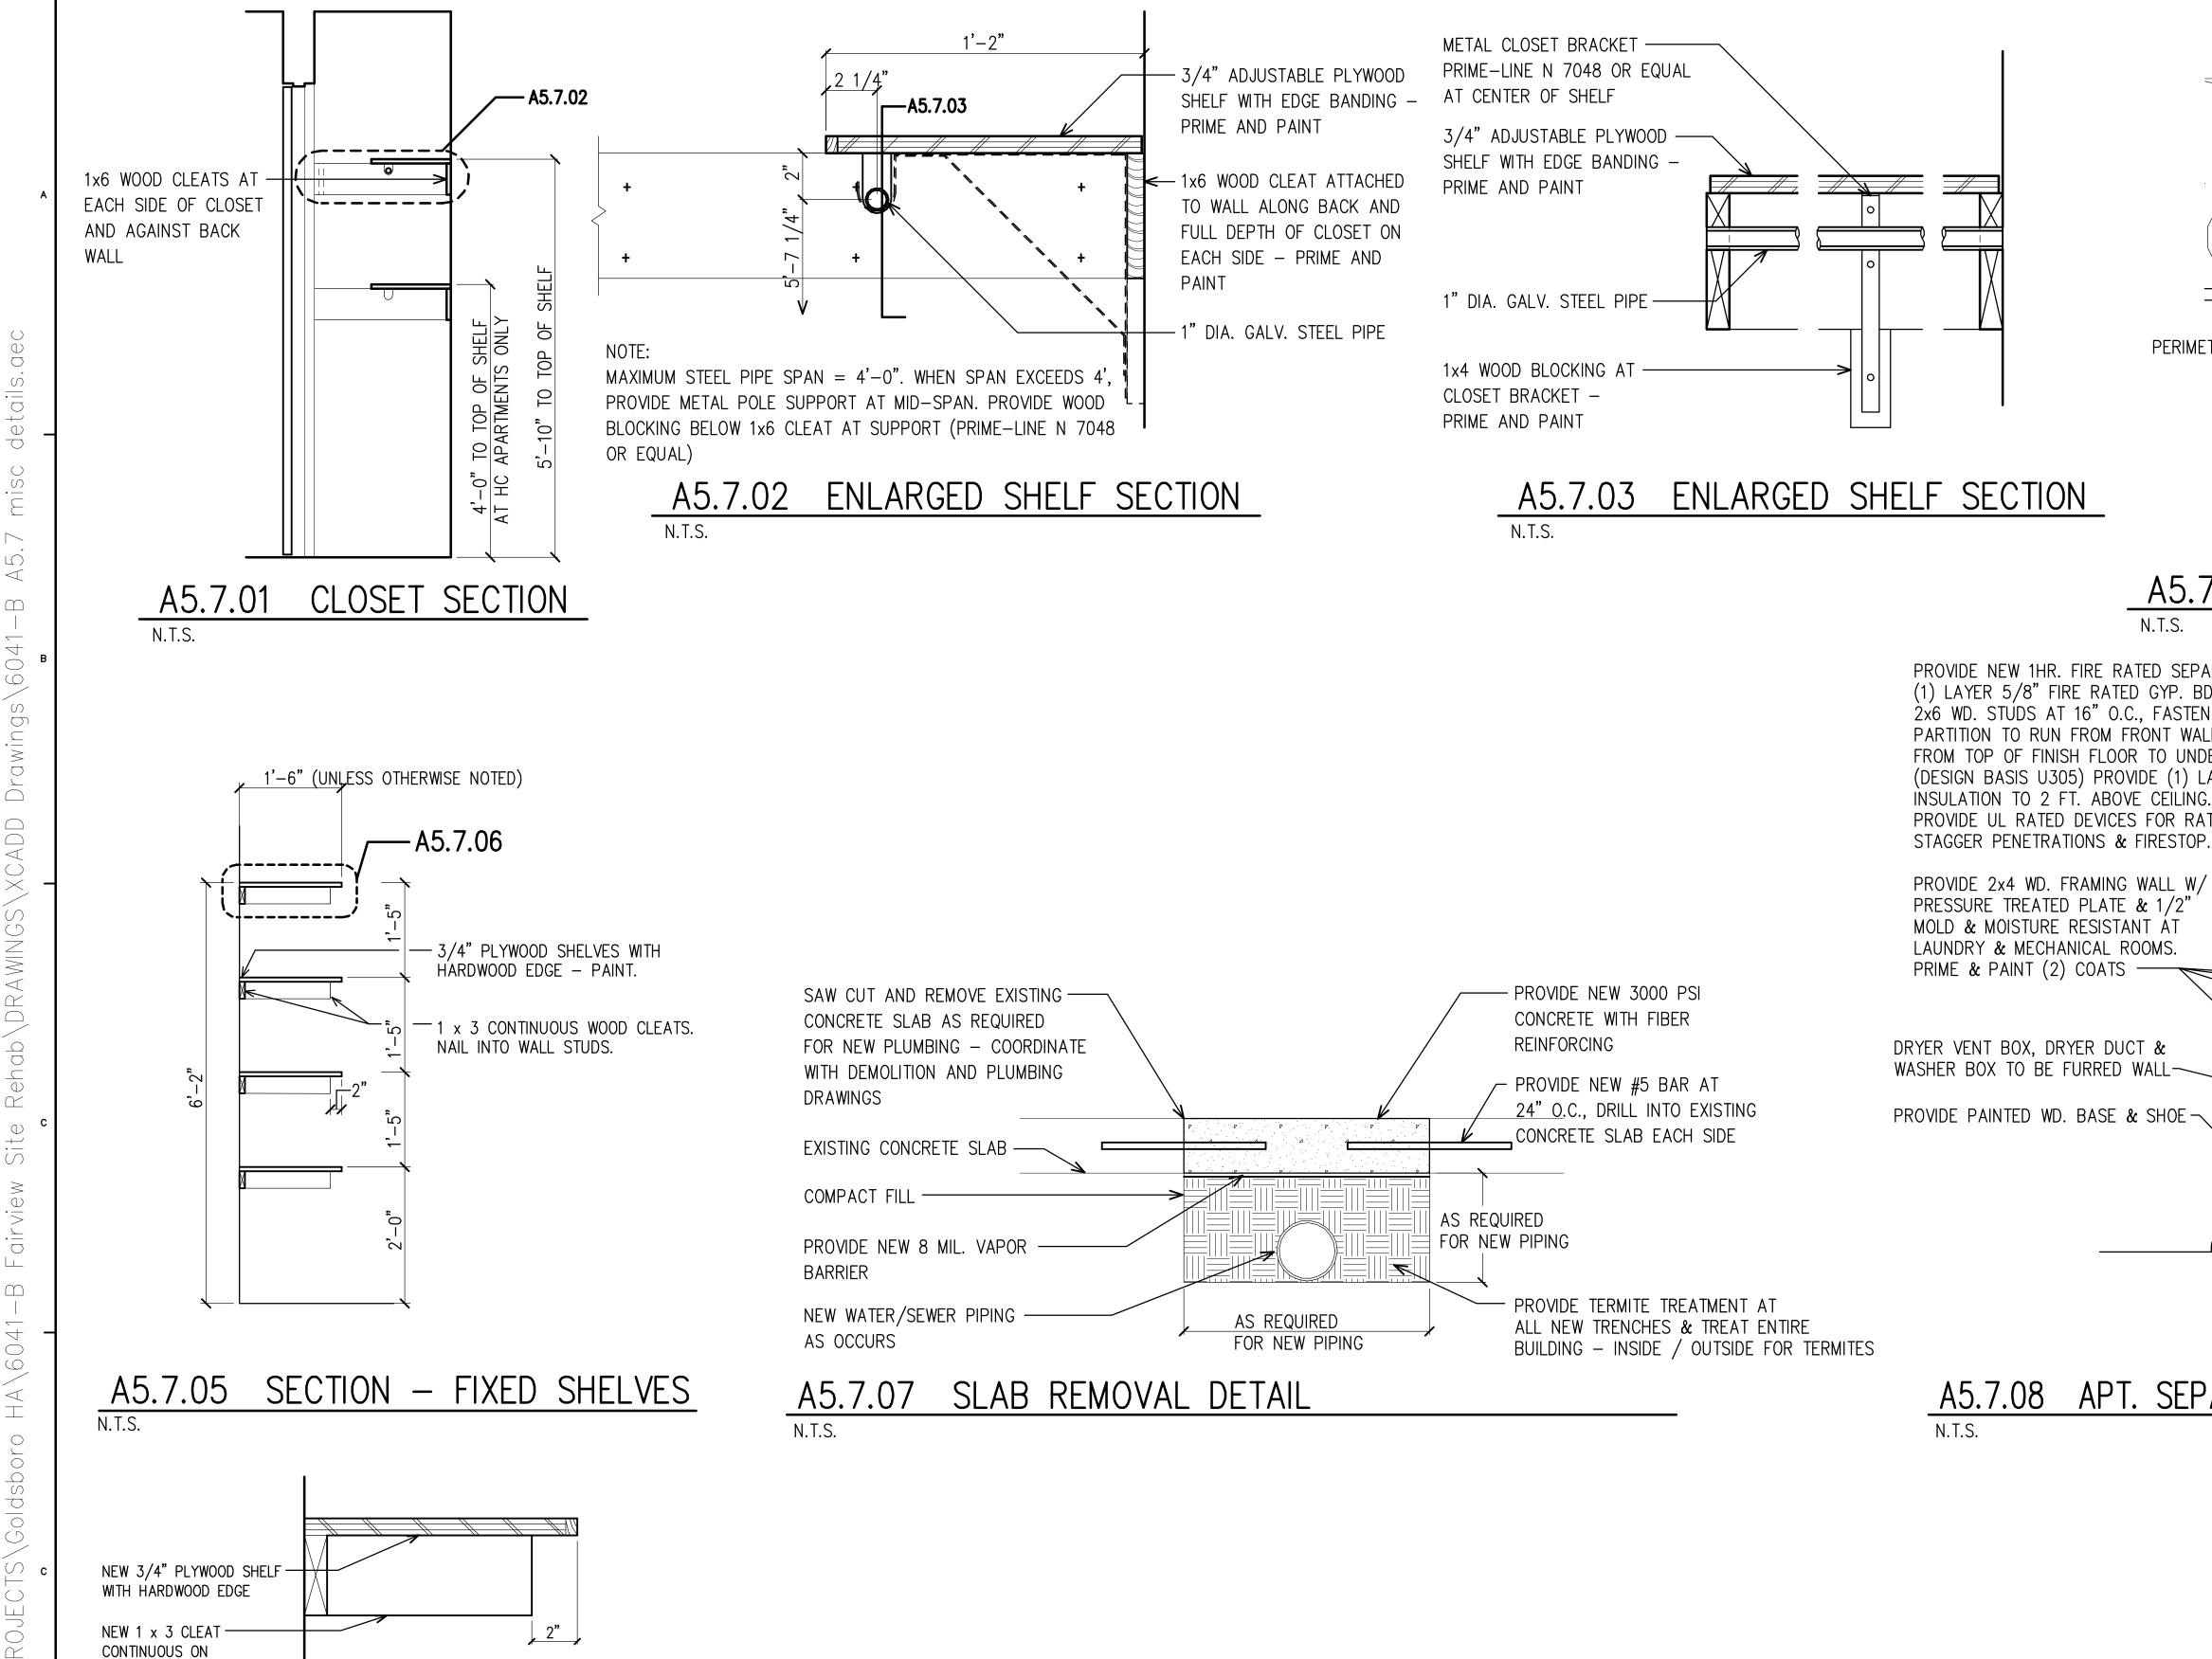

A5.7.04 CEILING ACCESS PANEL

PROVIDE NEW 1HR. FIRE RATED SEPARATION WALL -(1) LAYER 5/8" FIRE RATED GYP. BD. EA. SIDE ON 2x6 WD. STÚDS AT 16" O.C., FASTEN GYP. BD. 8" O.C. PARTITION TO RUN FROM FRONT WALL TO REAR WALL & FROM TOP OF FINISH FLOOR TO UNDERSIDE OF ROOF DECK (DESIGN BASIS U305) PROVIDE (1) LAYER OF 5" SOUND BATT INSULATION TO 2 FT. ABOVE CEILING. CONTRACTOR SHALL PROVIDE UL RATED DEVICES FOR RATING REQUIRED

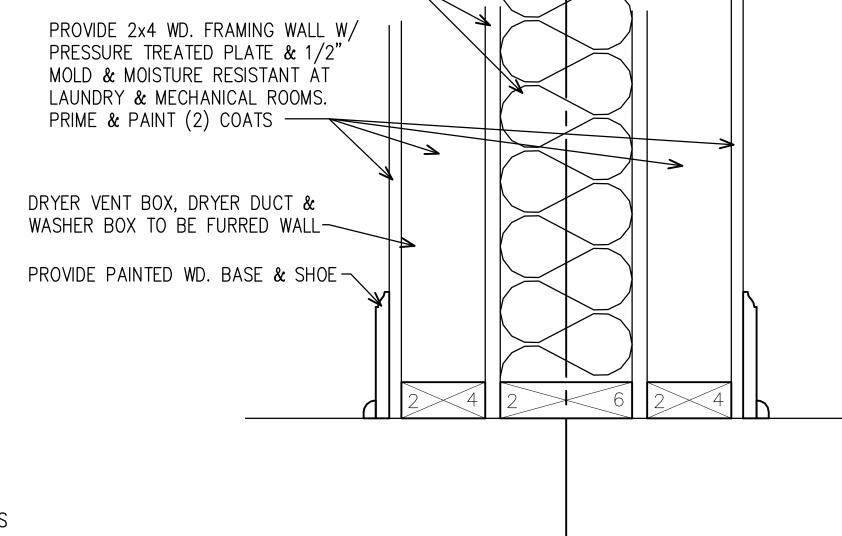

A5.7.08 APT. SEPARATION WALL/LAUNDRY RM. WALL

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MISCELLANEOUS DETAILS

6041-B\ A5.7.AEC COMM. NO. **6041-B** 


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A5.7

ENLARGED SHELF SECTION

SIDE AND BACK WALLS

N.T.S.

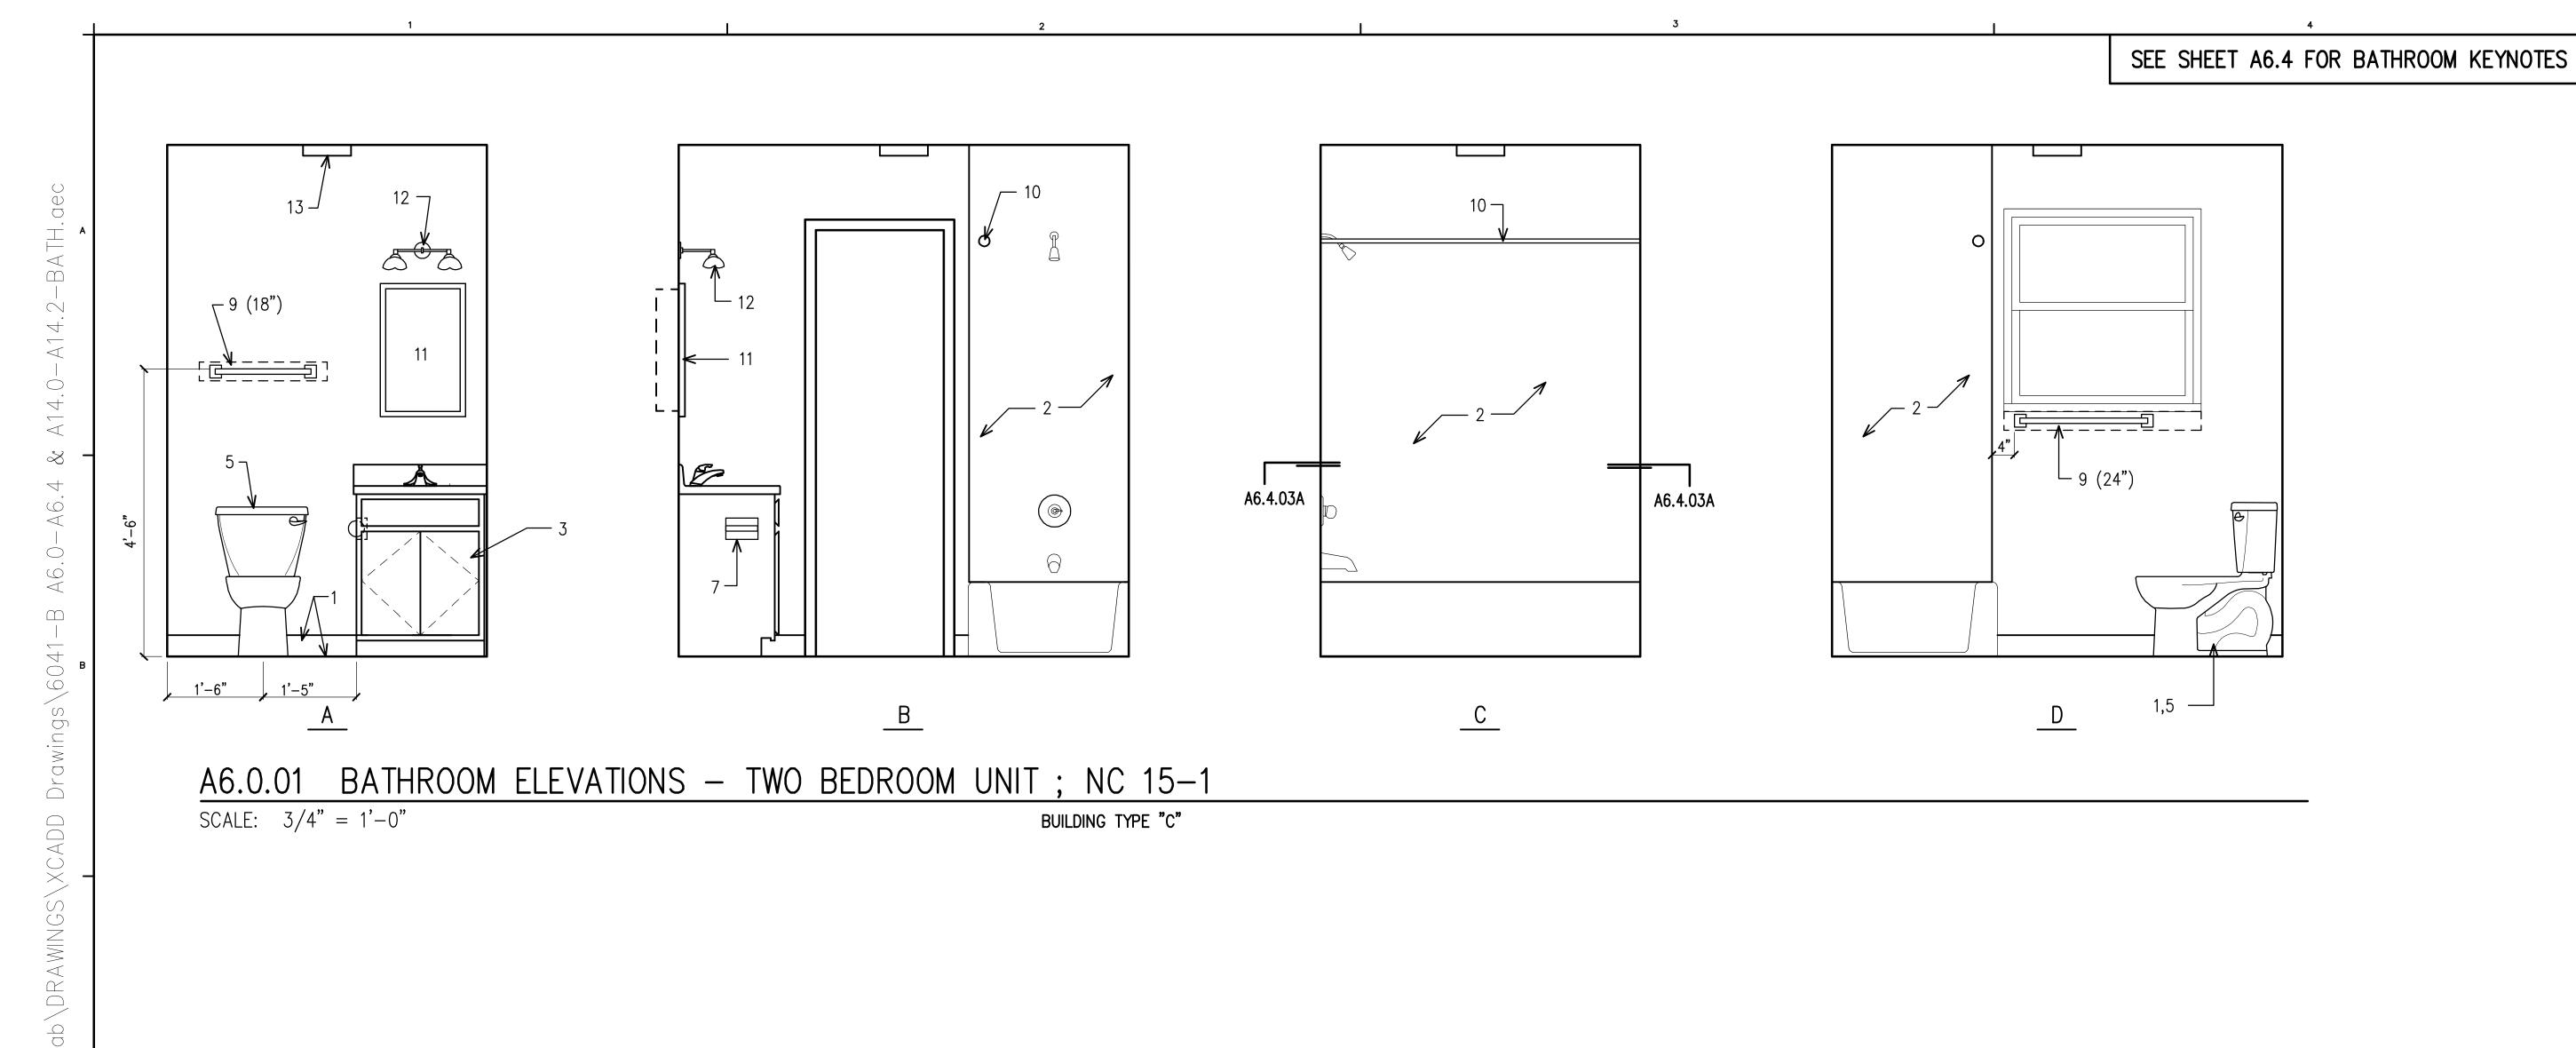

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BATHROOM ELEVATIONS, TWO BEDROOM UNIT;


NC 15-1 6041-B\ A6.0.AEC

COMM. NO. **6041-B** DRAWN BY WBP CHECKED BY AWS

DATE APRIL 2, 2024 SHEET NO.


A6.0

SCALE: 3/4 = 1'-0"

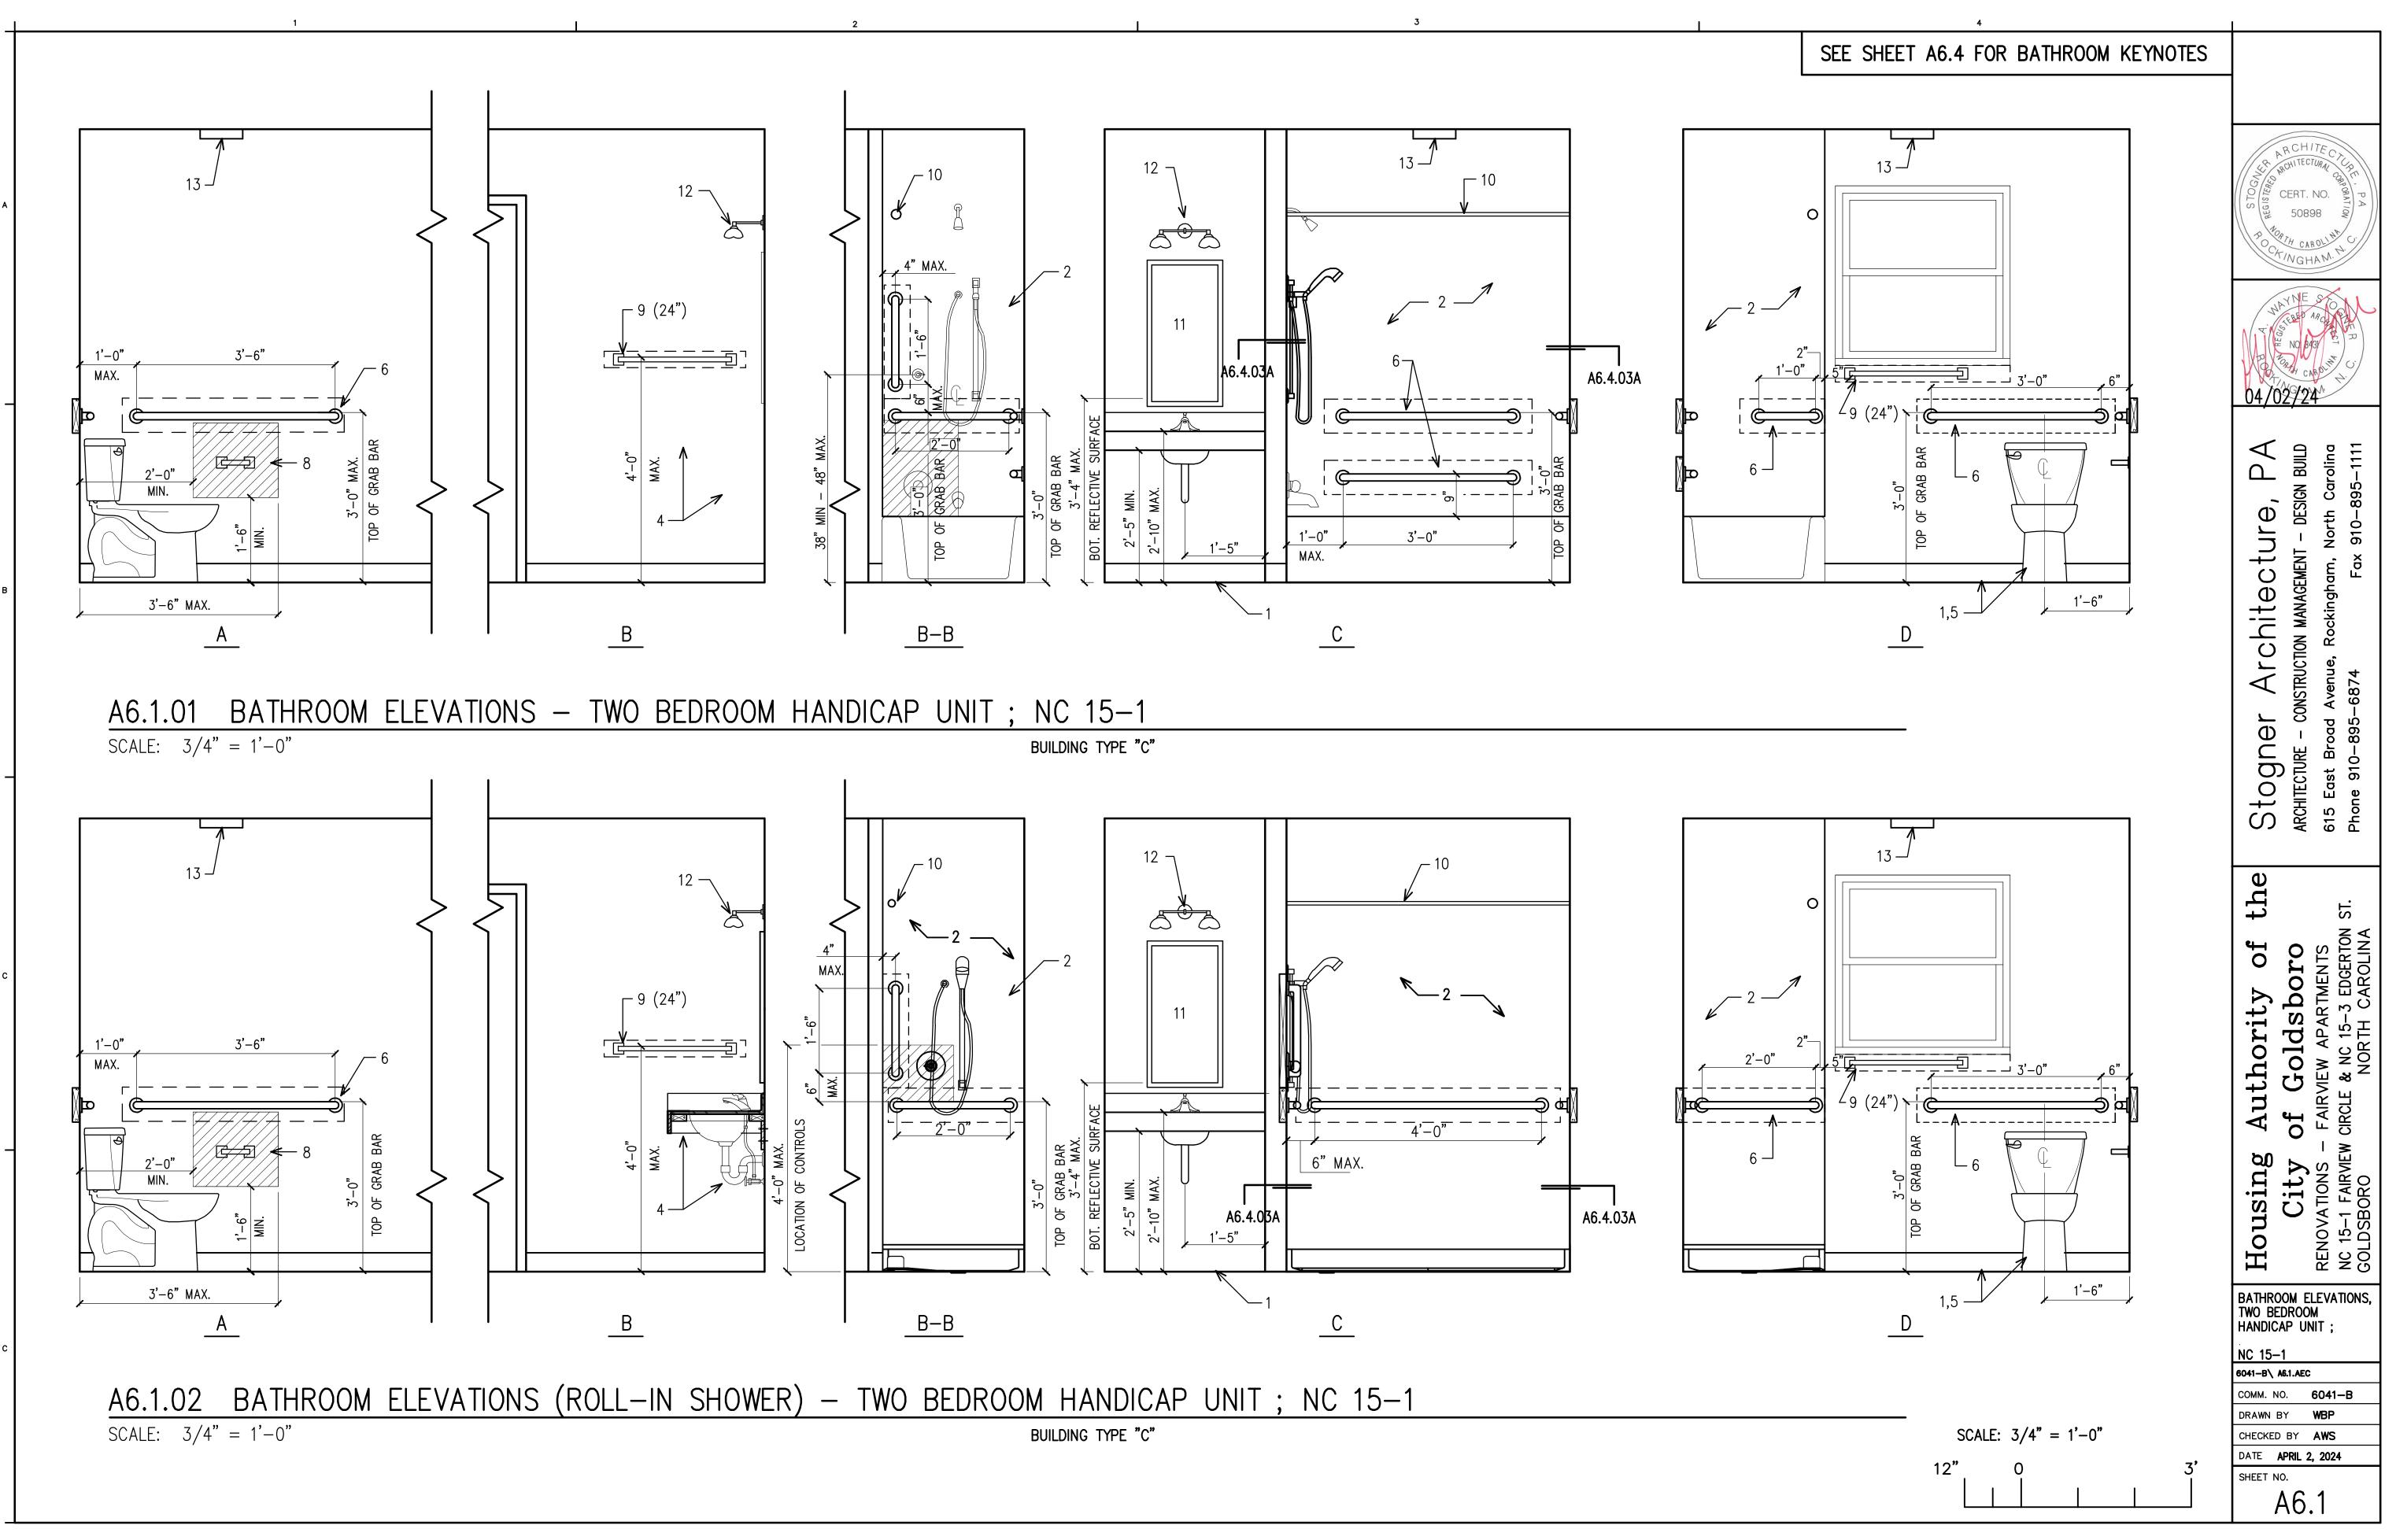

Fairview


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Fairview
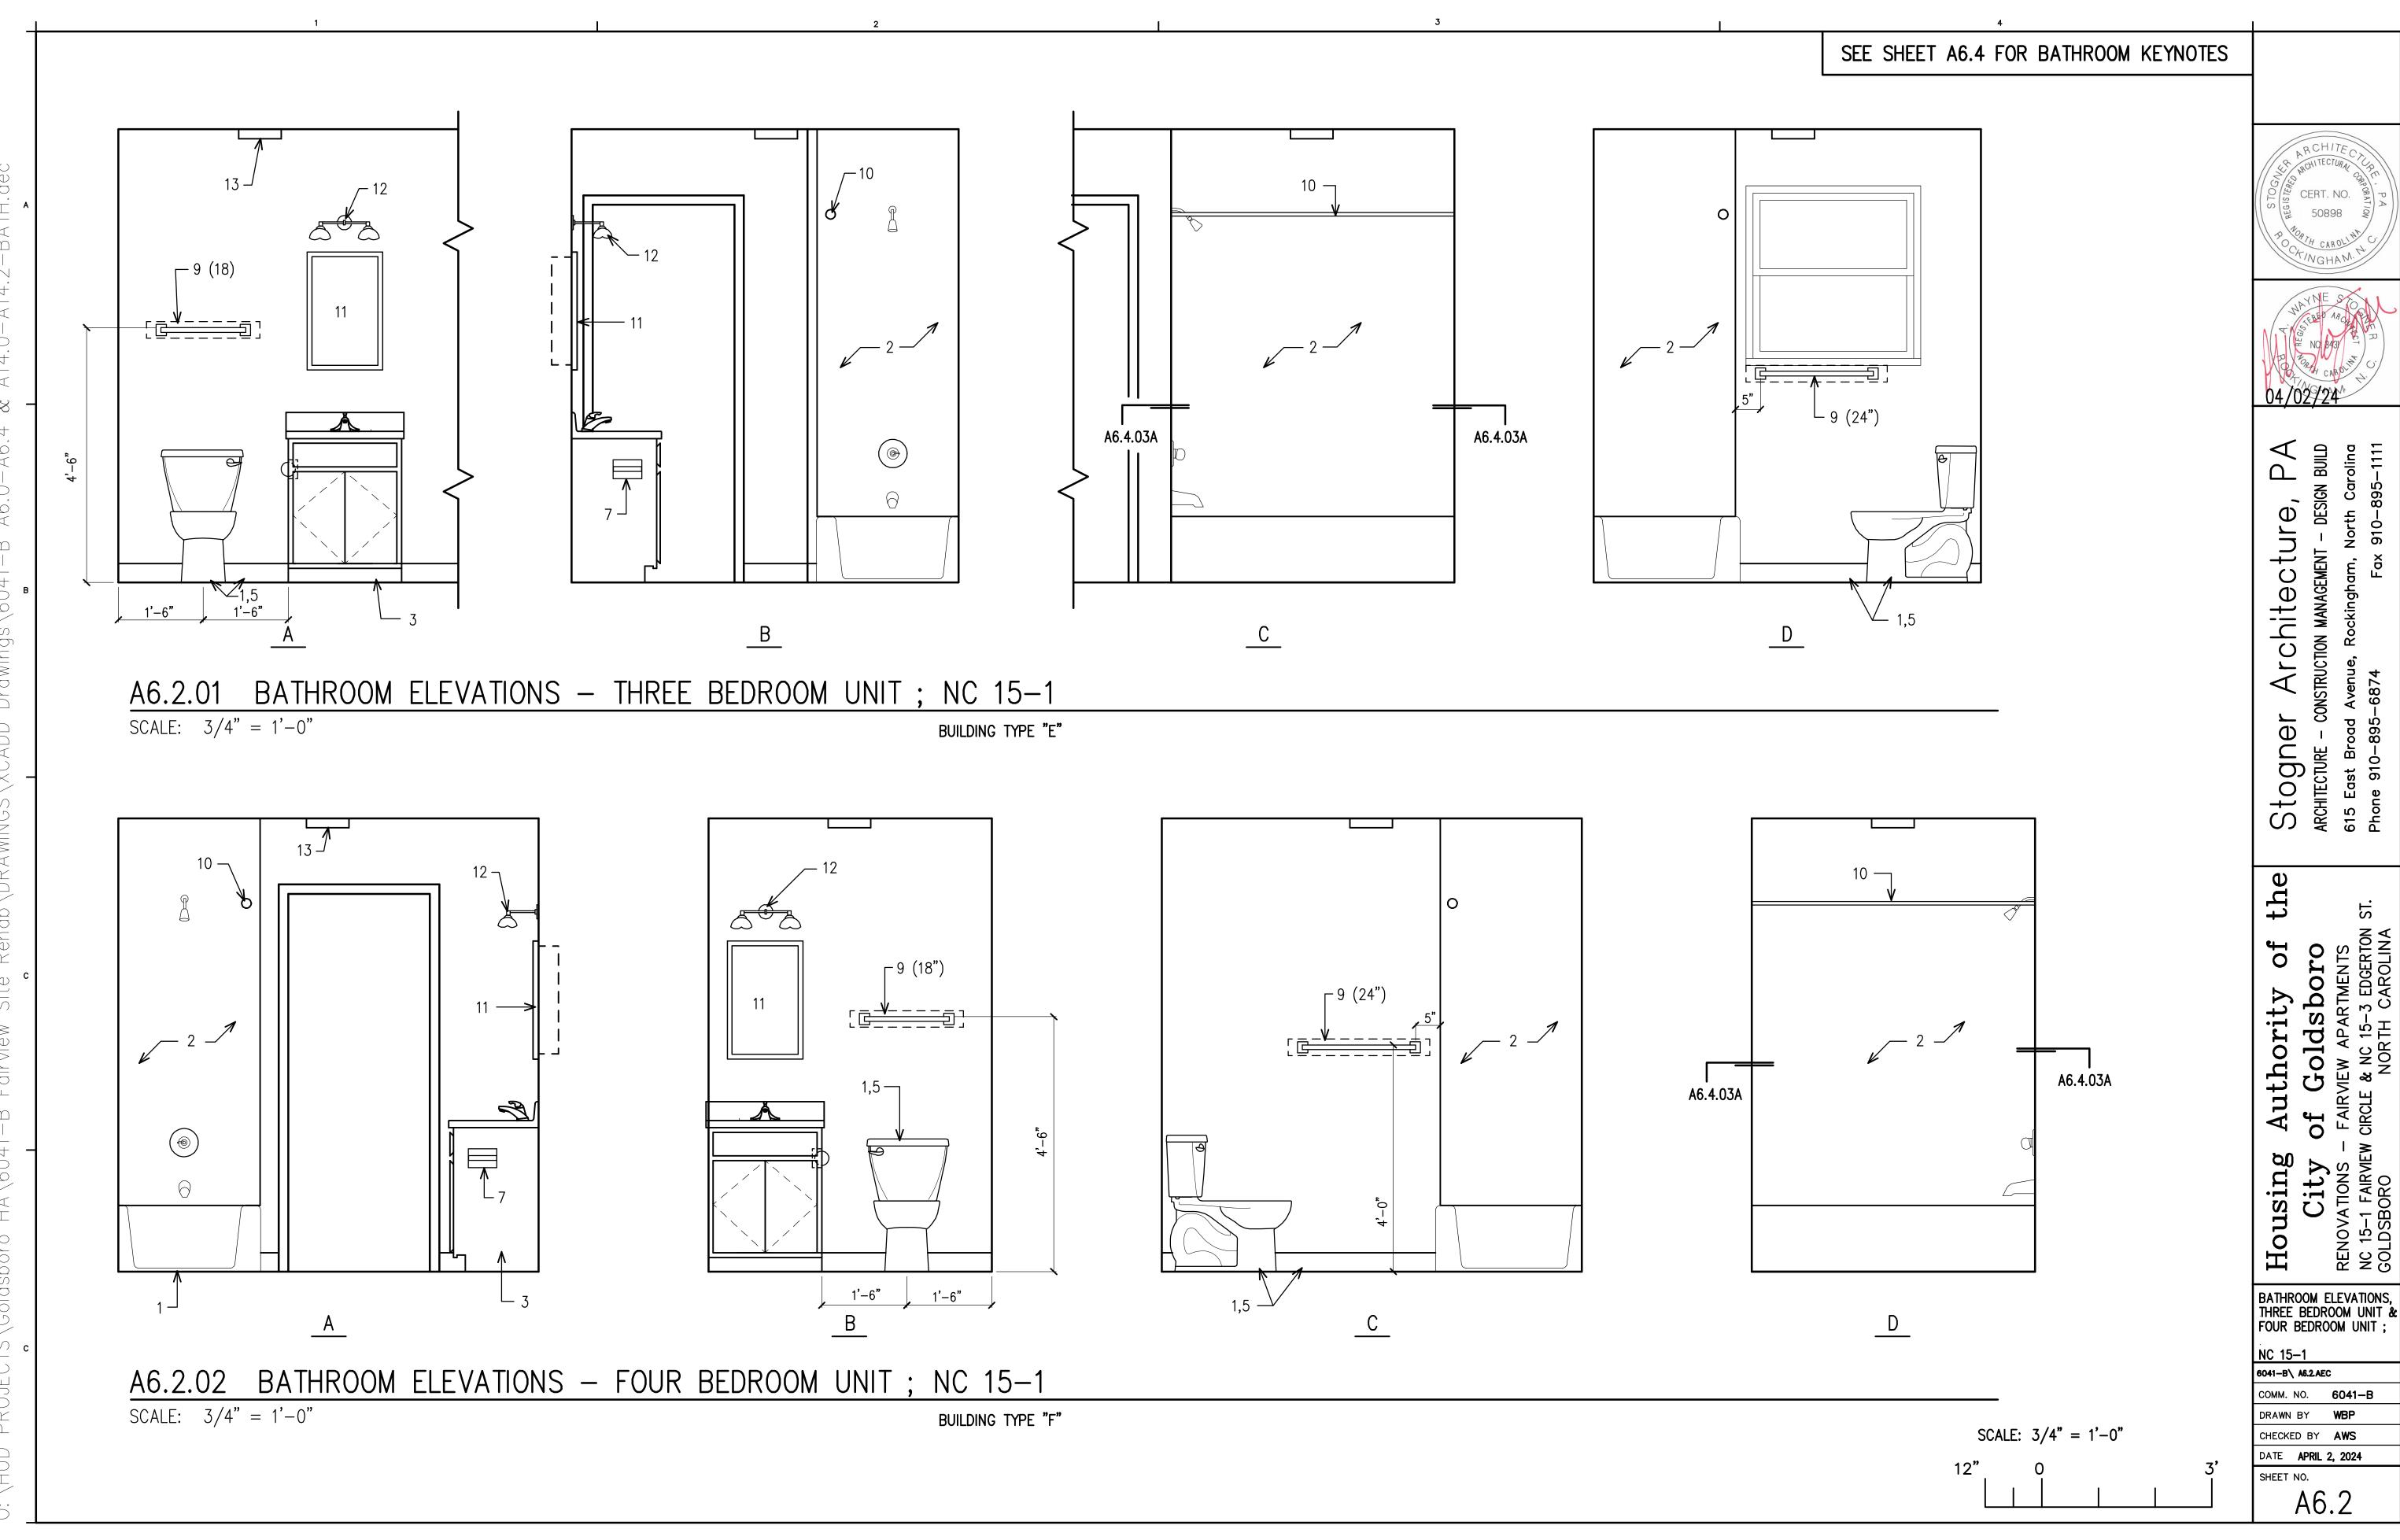
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CERT. NO.




#### BATHROOM KEYNOTES

- REMOVE EXISTING CERAMIC TILE FLOOR & BASE. REMOVE EXISTING MARBLE THRESHOLD. REPLACE UNDERSLAB SEWER PIPING. PROVIDE NEW CERAMIC TILE FLOOR & BASE, PROVIDE NEW THRESHOLD.
- 2. REMOVE EXISTING TUB & TUB SURROUND COMPLETE. PROVIDE NEW TUB, FAUCET & SPOUT. PROVIDE NEW RISER PIPE, NEW SHOWER HEAD AT 6'-6" A.F.F. PROVIDE NEW WATER RESISTANT GYP. BD. AT TUB WALL PROVIDE NEW SOLID SURFACE SURROUND. EXTEND TO CLG. PROVIDE WATERPROOF AT CORNERS & PROVIDE CORNER TRIM @ SURROUND. AT HANDICAP APT'S., PROVIDE DIVERTER VALVE, SHOWER CONTROLS, HANDHELD SHOWER W/SLIDE & 60" FLEXIBLE HOSE. PROVIDE WD. BLOCKING & GRAB BARS AT HANDICAP APT'S., AT (2) HANDICAP APT'S, PROVIDE ROLL-IN SHOWER

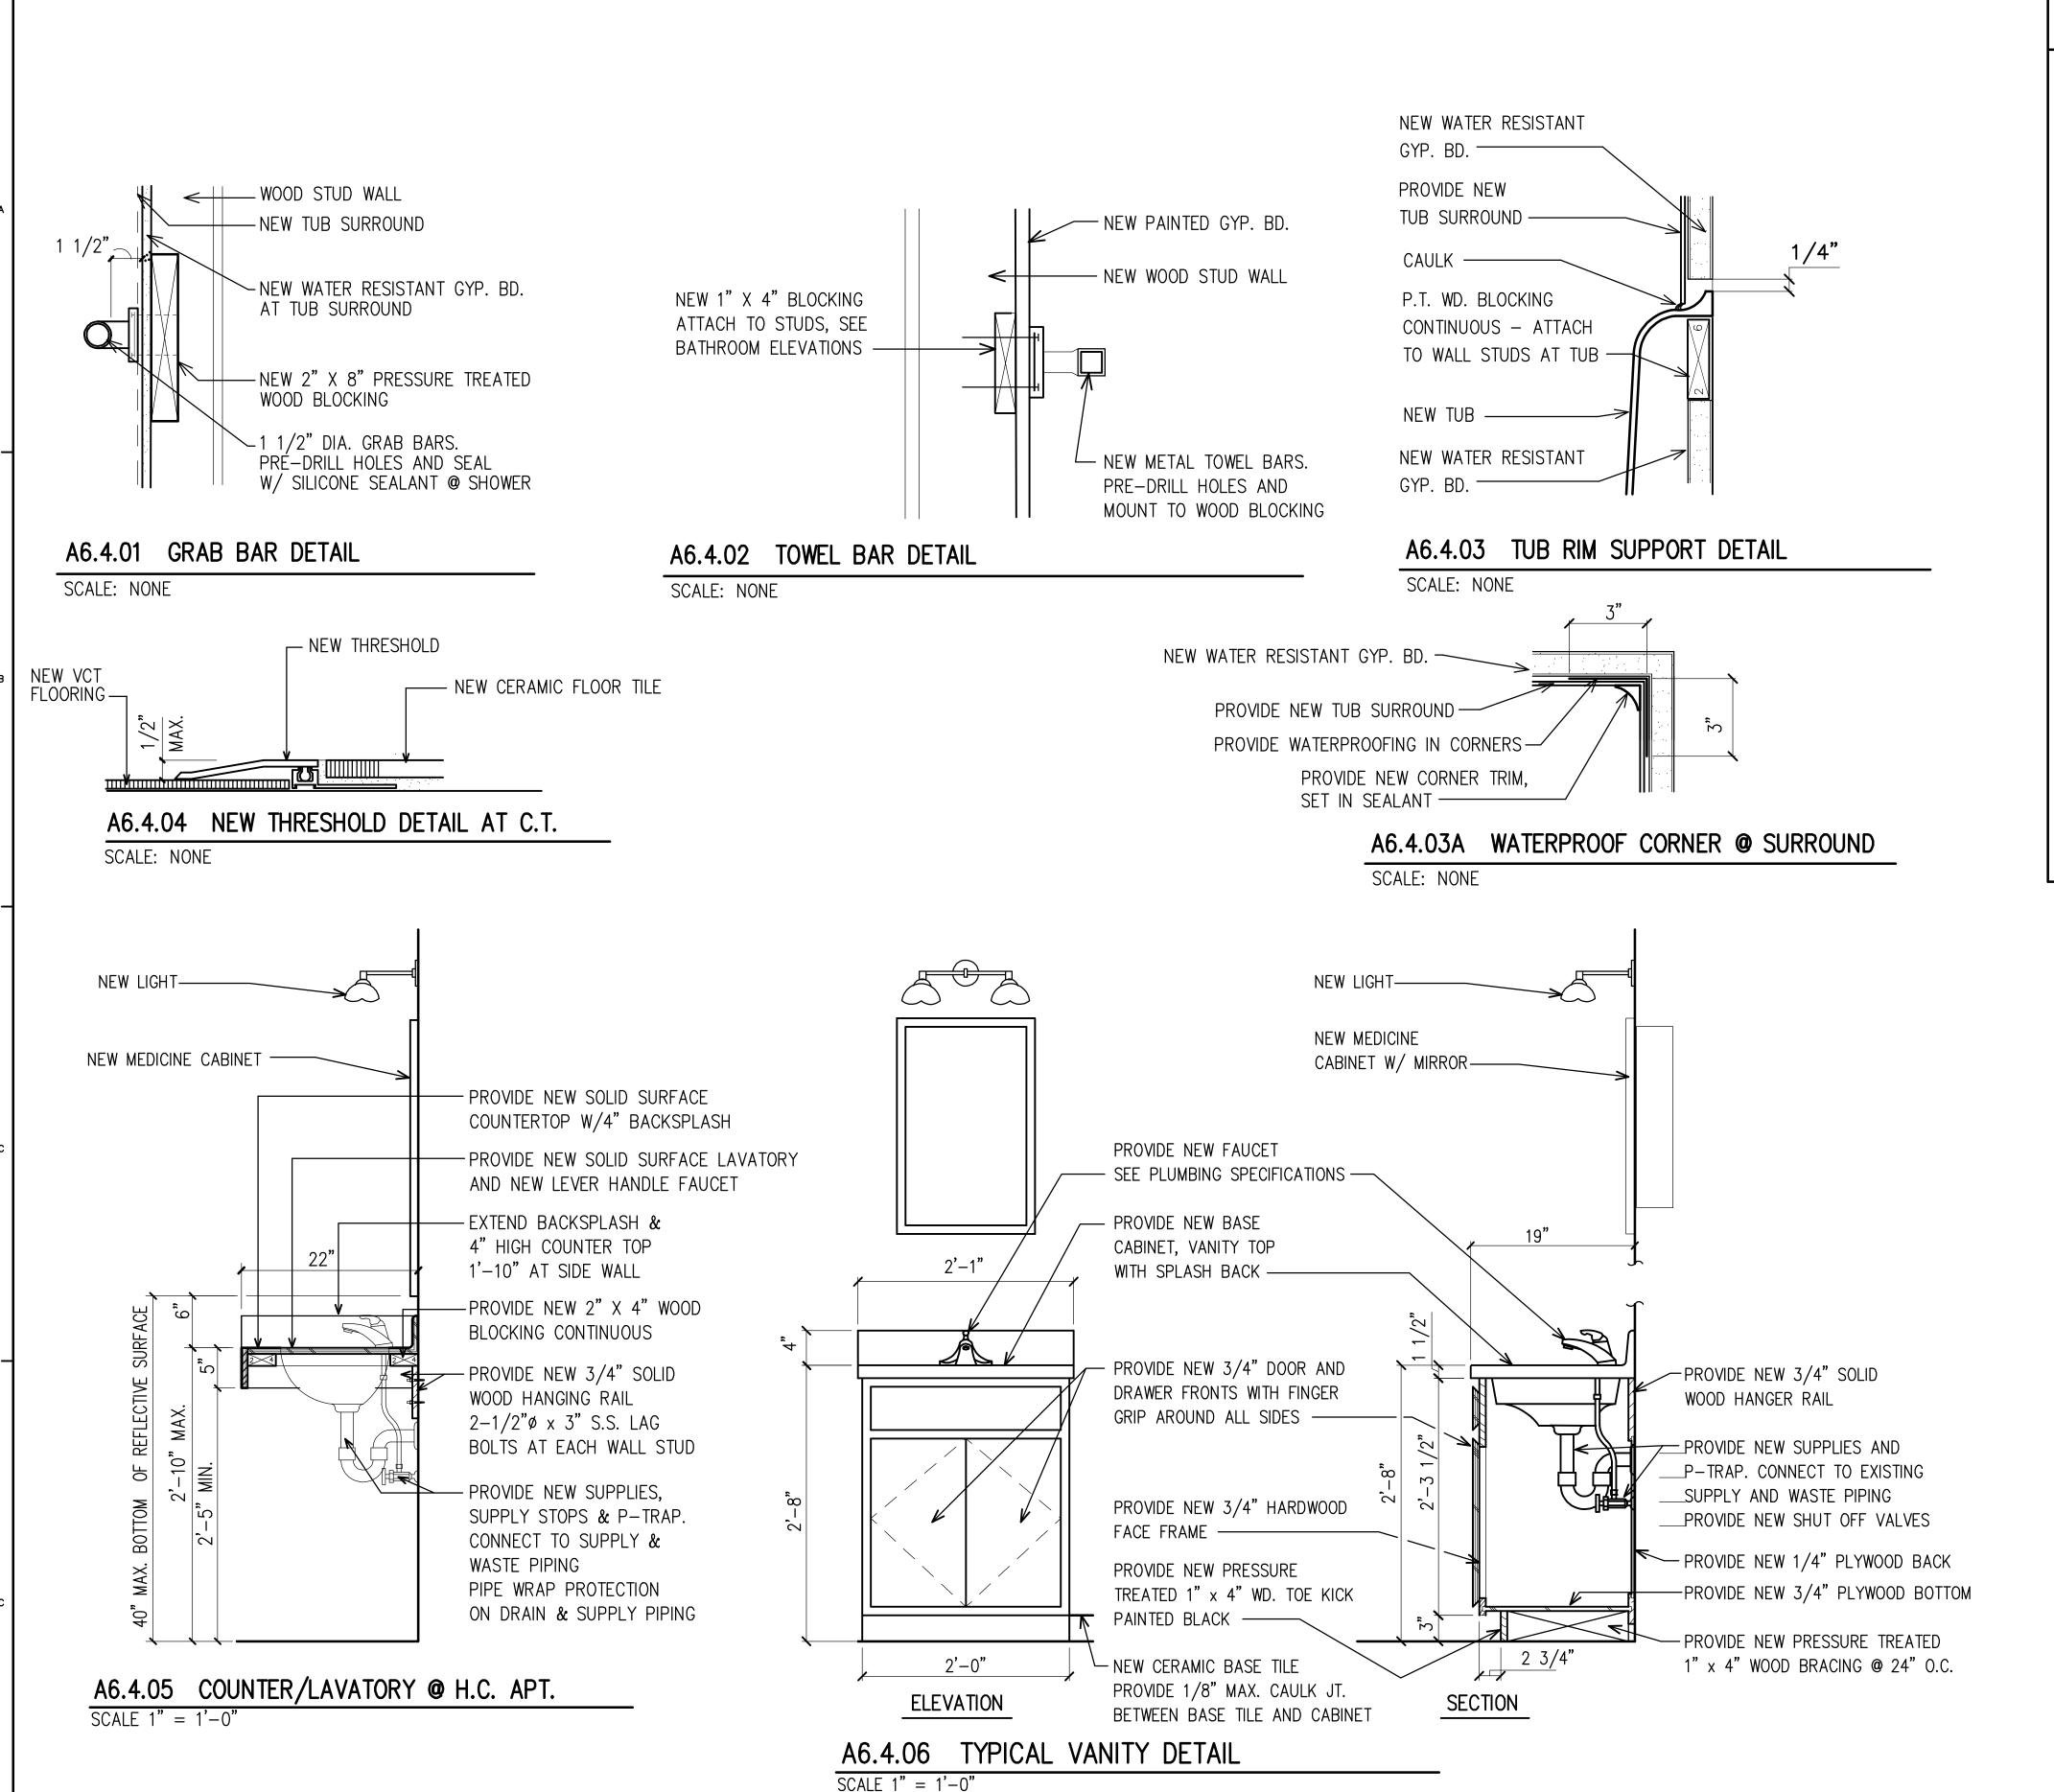

- 4. AT HANDICAP APT'S., REMOVE EXISTING WALL HUNG LAVATORY, WALL HANGER, SUPPLY & WASTE PIPING, PROVIDE NEW SOLID SURFACE COUNTER W/ LEVER HANDLE FAUCET. PROVIDE NEW SUPPLIES, STOPS & PVC DRAIN PIPING. PROVIDE PIPE PROTECTION WRAP ON SUPPLY & DRAIN PIPING.
- . REMOVE EXISTING WATER CLOSET, SUPPLY STOP, WASTE PIPING. PROVIDE NEW WASTE PIPE/TOILET FLANGE, WAX RING, WATER CLOSET, CLOSET BOLTS, SUPPLY & SUPPLY STOP. PROVIDE ESCUTCHEON PLATE ON SUPPLY PIPING.
- 6. PROVIDE WD. BLOCKING & GRAB BARS AT HANDICAP APT'S.
- 7. PROVIDE RECESSED TISSUE HOLDER, MOUNT IN SIDE OF VANITY CABINET.
- 8. AT HANDICAP APT'S., PROVIDE WD. BLOCKING & NEW TISSUE HOLDER.
- 9. PROVIDE 1"x4" WD. BLOCKING IN WALL & NEW TOWEL BAR, MOUNT TOWEL BAR TO WD. BLOCKING.
- 10. PROVIDE NEW SHOWER CURTAIN ROD. PROVIDE BLOCKING IN WALL FOR MOUNTING. AT HANDICAP APT'S., PROVIDE WEIGHTED SHOWER CURTAIN @ ROLL-IN SHOWER.
- 11. REMOVE EXISTING MEDICINE CABINET & PROVIDE NEW RECESSED MEDICINE CABINET W/ MIRROR. TPICAL MEDICINE CABINET IS 16" x 25", AT HANDICAP APT., MEDICINE CABINET IS 16" x 32".
- 12. REMOVE EXISTING WALL MOUNTED LIGHT, PROVIDE NEW WALL MOUNTED LIGHT & WIRE TO EXHAUST FAN/LIGHT TIMER SWITCH.
- 13. REMOVE EXISTING EXHAUST FAN, PROVIDE NEW HUMIDITY SENSING EXHAUST FAN/LIGHT, RIGID DUCT TO NEW ROOF CAP. WIRE FAN/LIGHT & LAV./ VANITY LIGHT TO SAME SWITCH. PROVIDE NEW COVER PLATE.



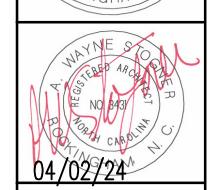

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BATHROOM KEYNOTES, BATHROOM DETAILS ;


Housing

NC 15-1 & NC 15-3 6041-B\ A6.4.AEC

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CHECKED BY AWS DATE **APRIL 2, 2024** SHEET NO.

A6.4

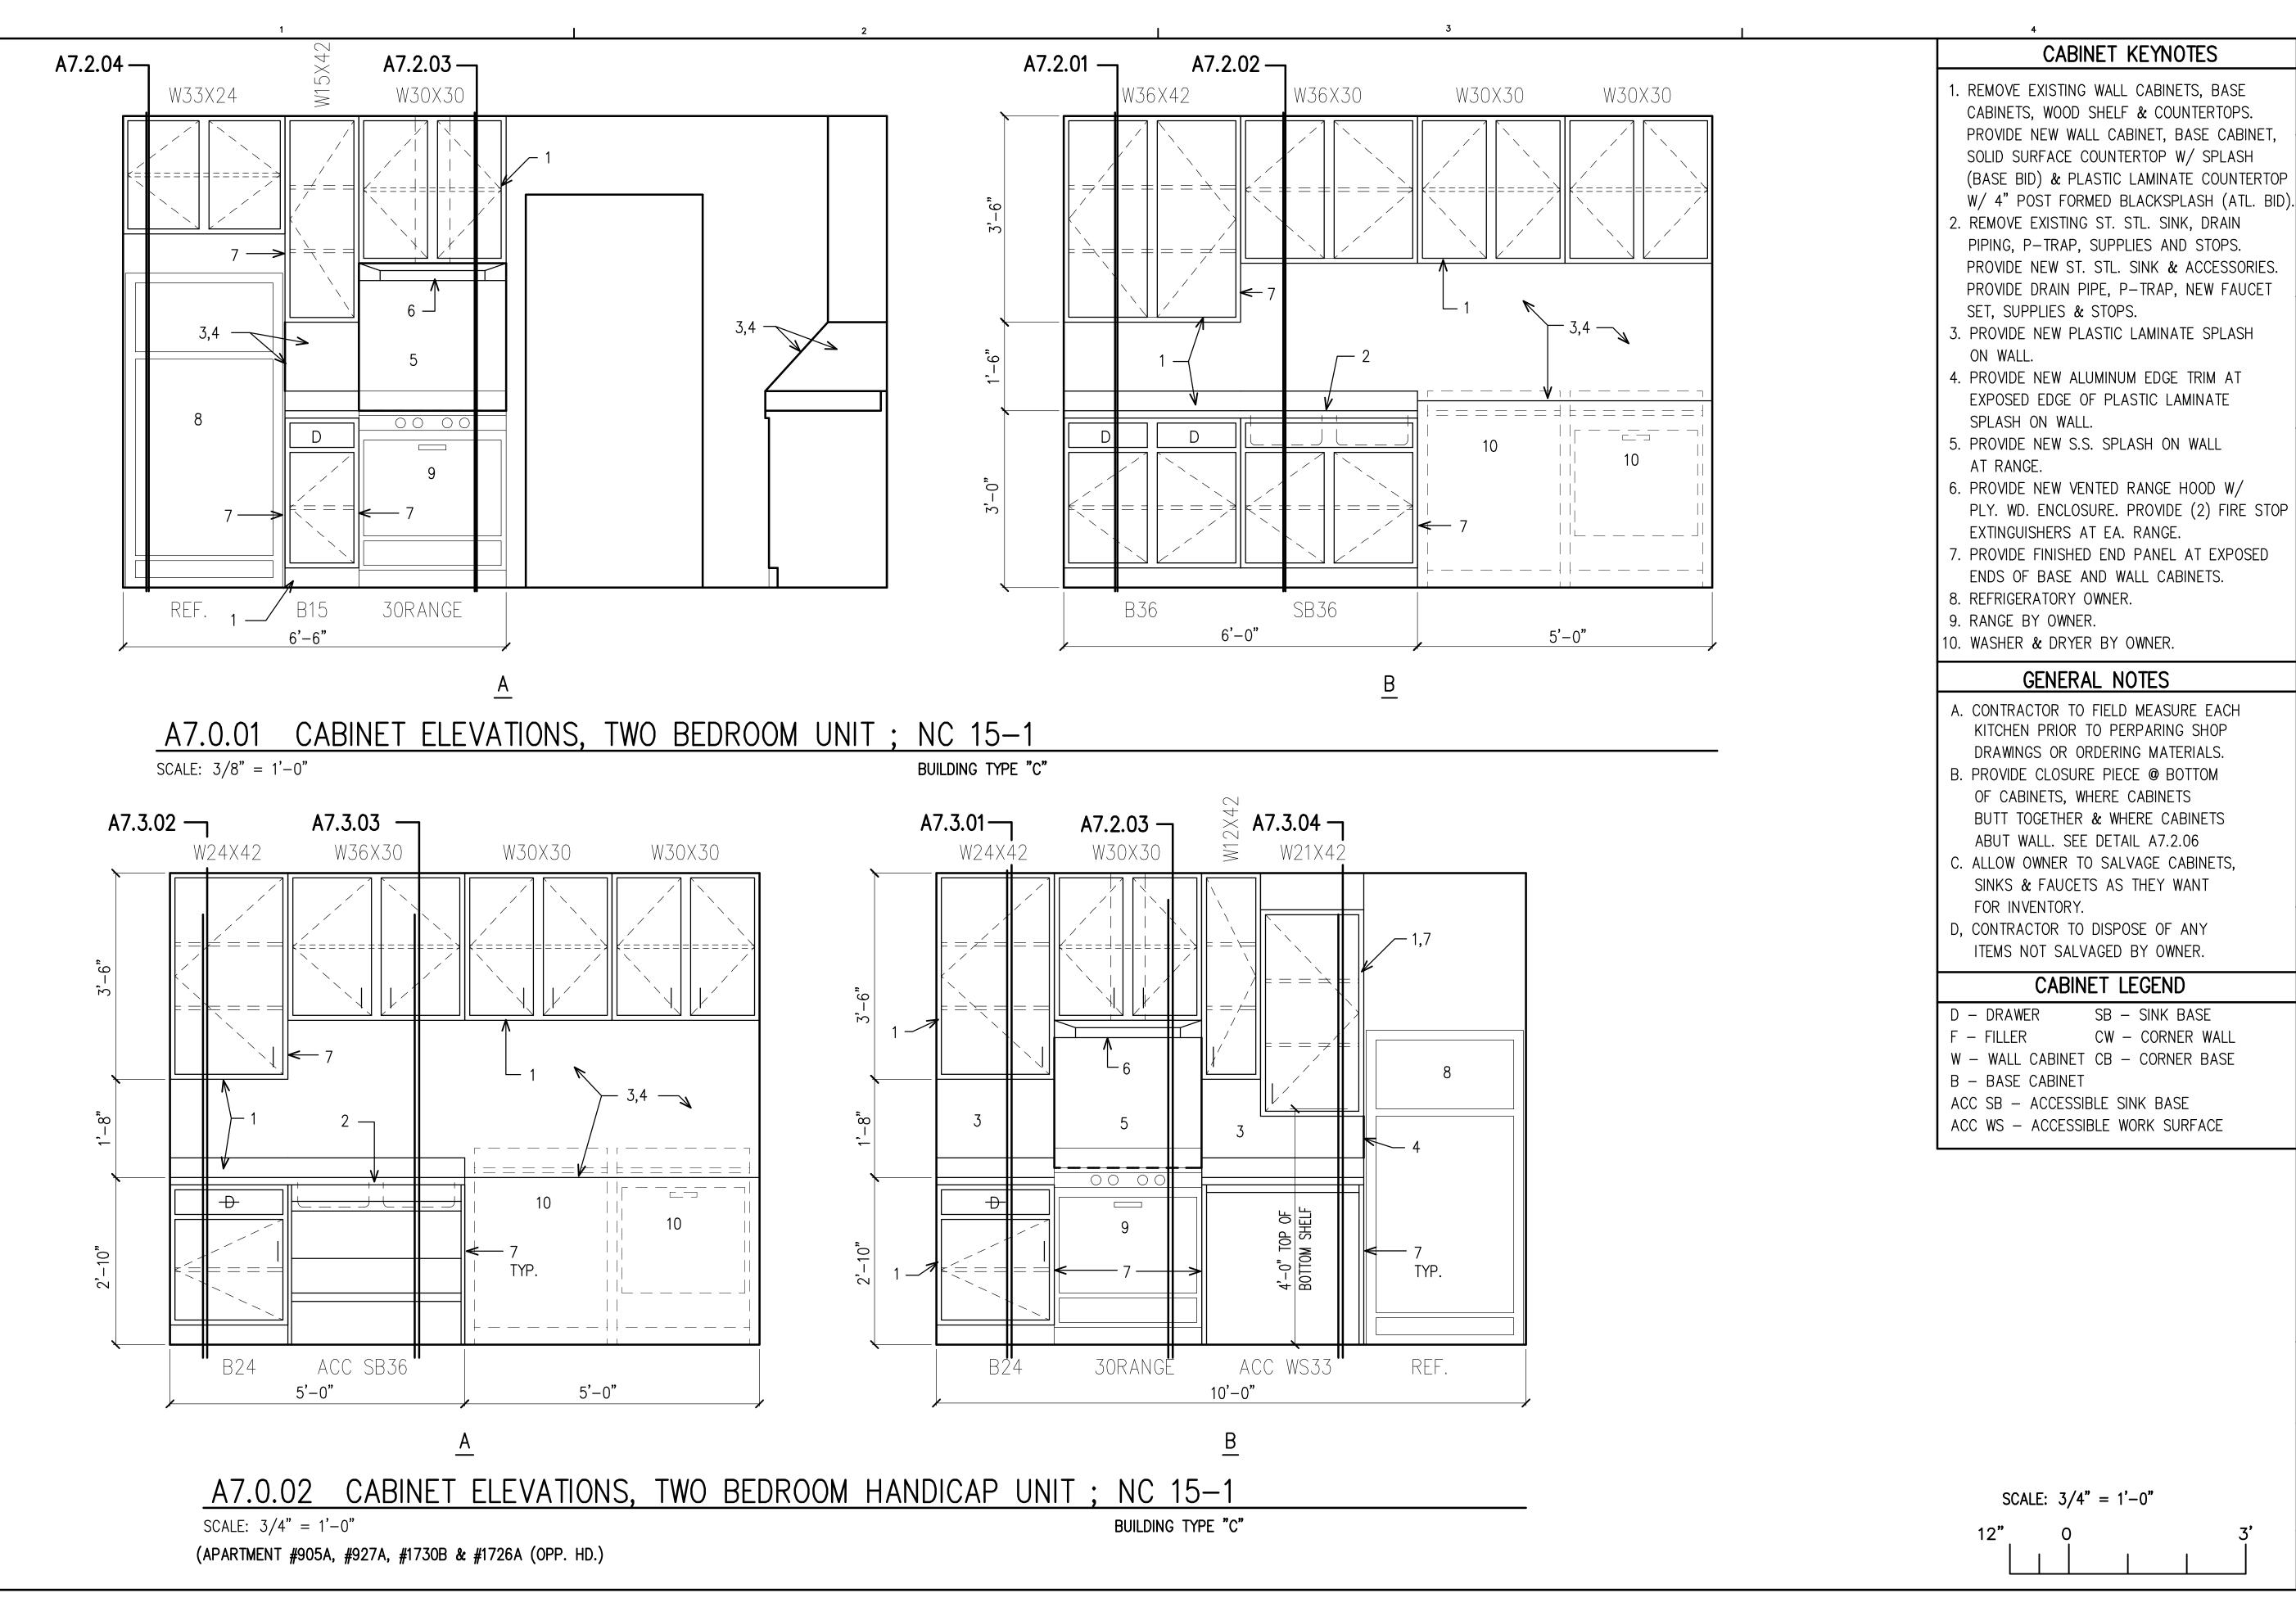

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6041B BID SET DRAWINGS - Page 61 of 142

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Authority of of Goldsboro FAIRVIEW APARTMENTS

CABINET KEYNOTES,
CABINET ELEVATIONS,
TWO BEDROOM UNIT &
TWO BEDROOM HANDICAP
UNIT; NC 15-1

COMM. NO. **6041-B** 

A7.0


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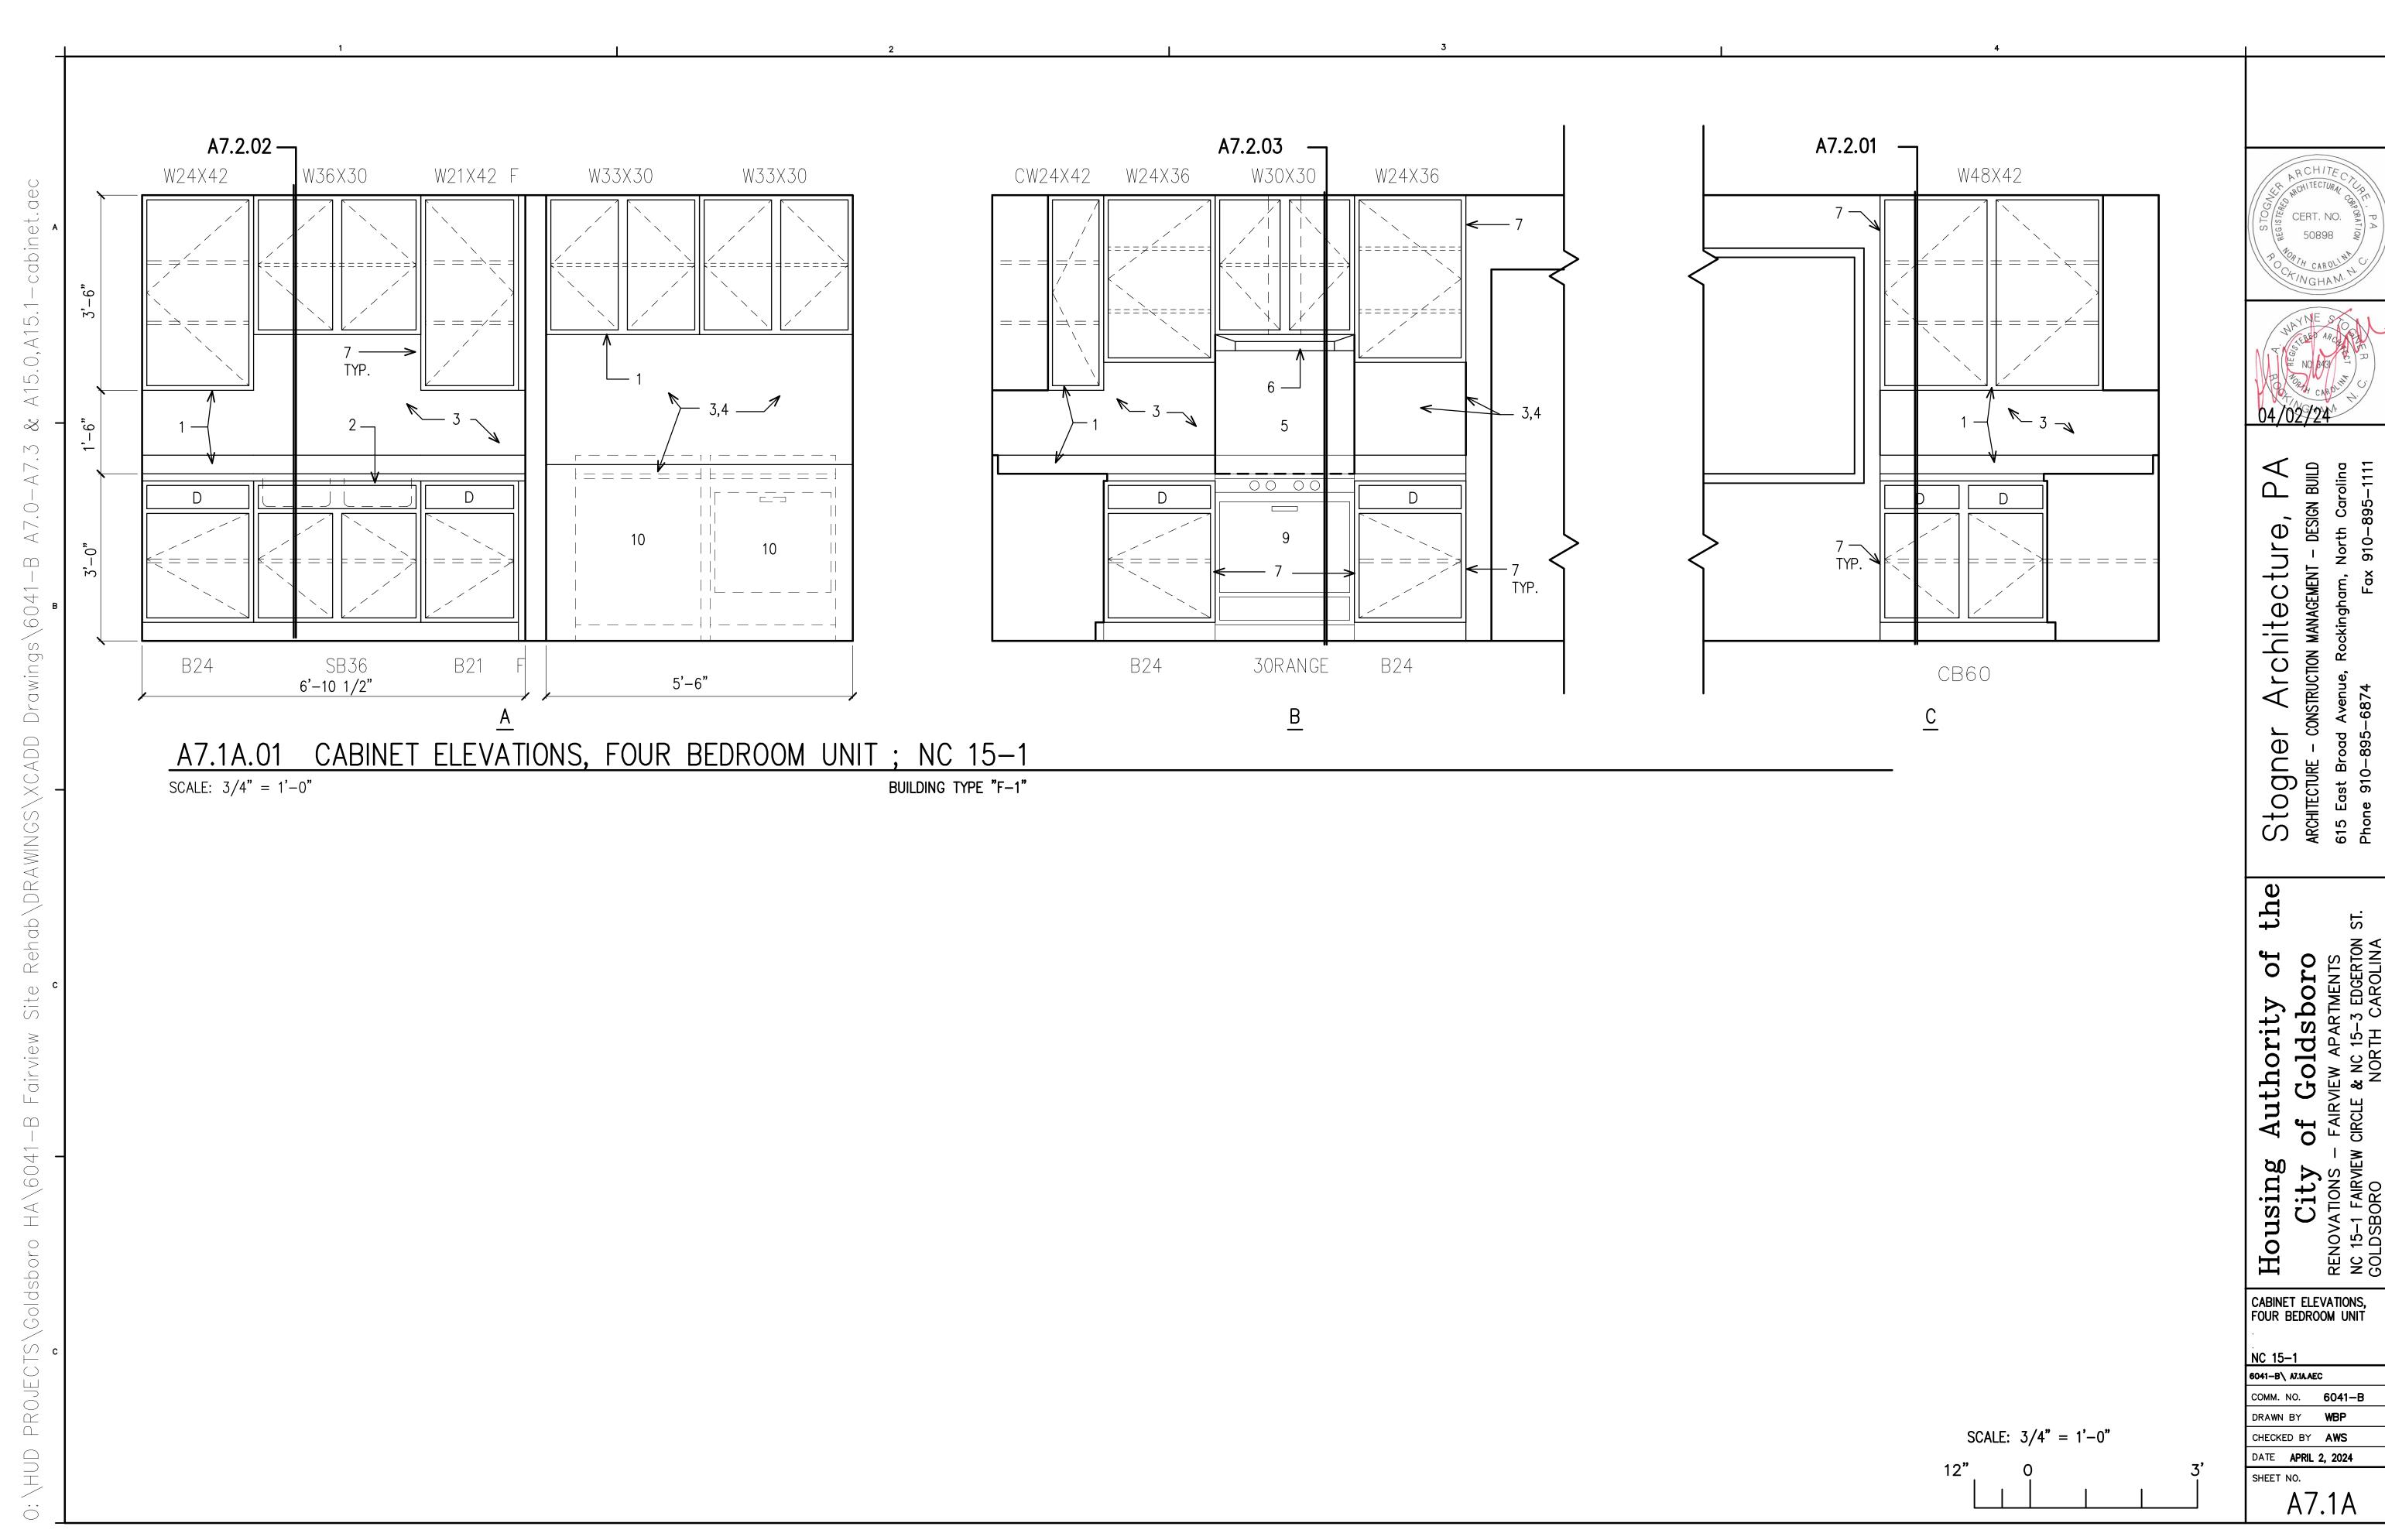
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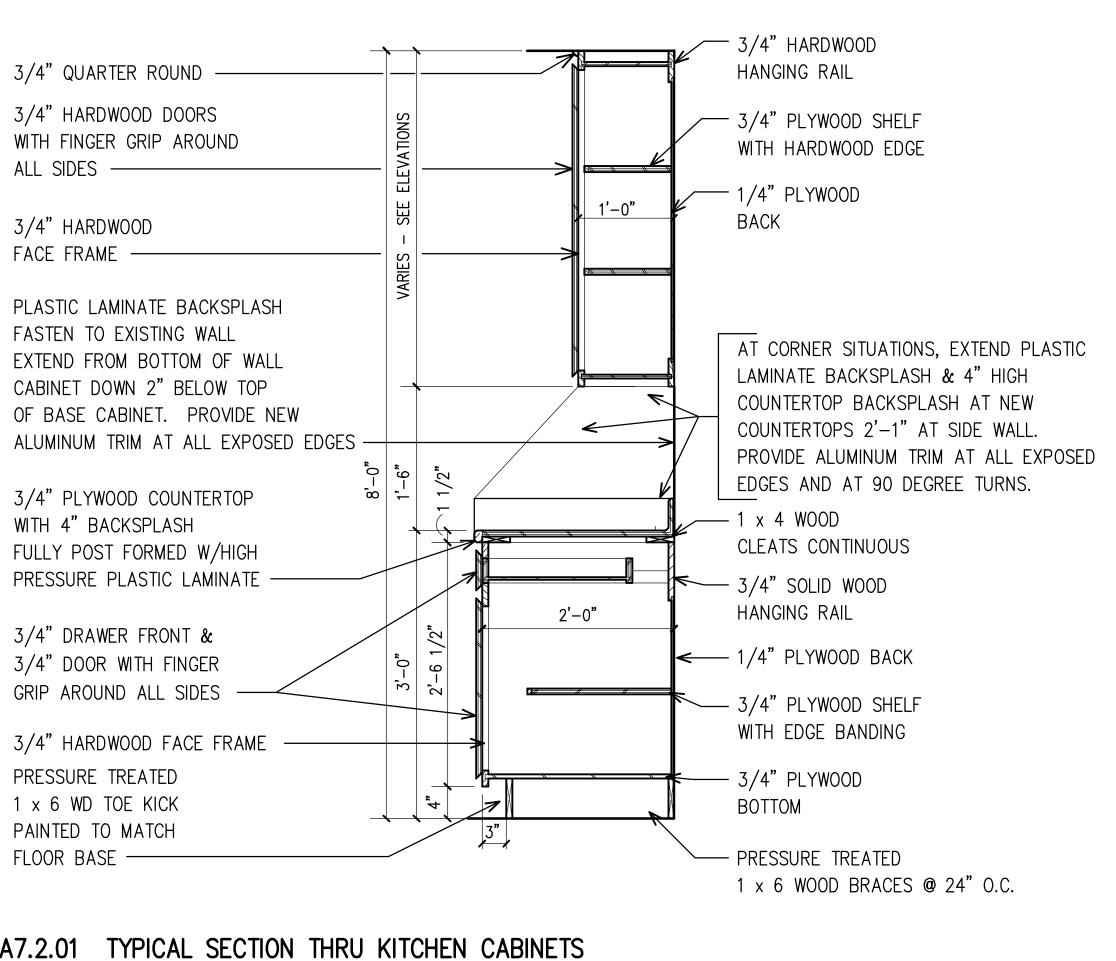
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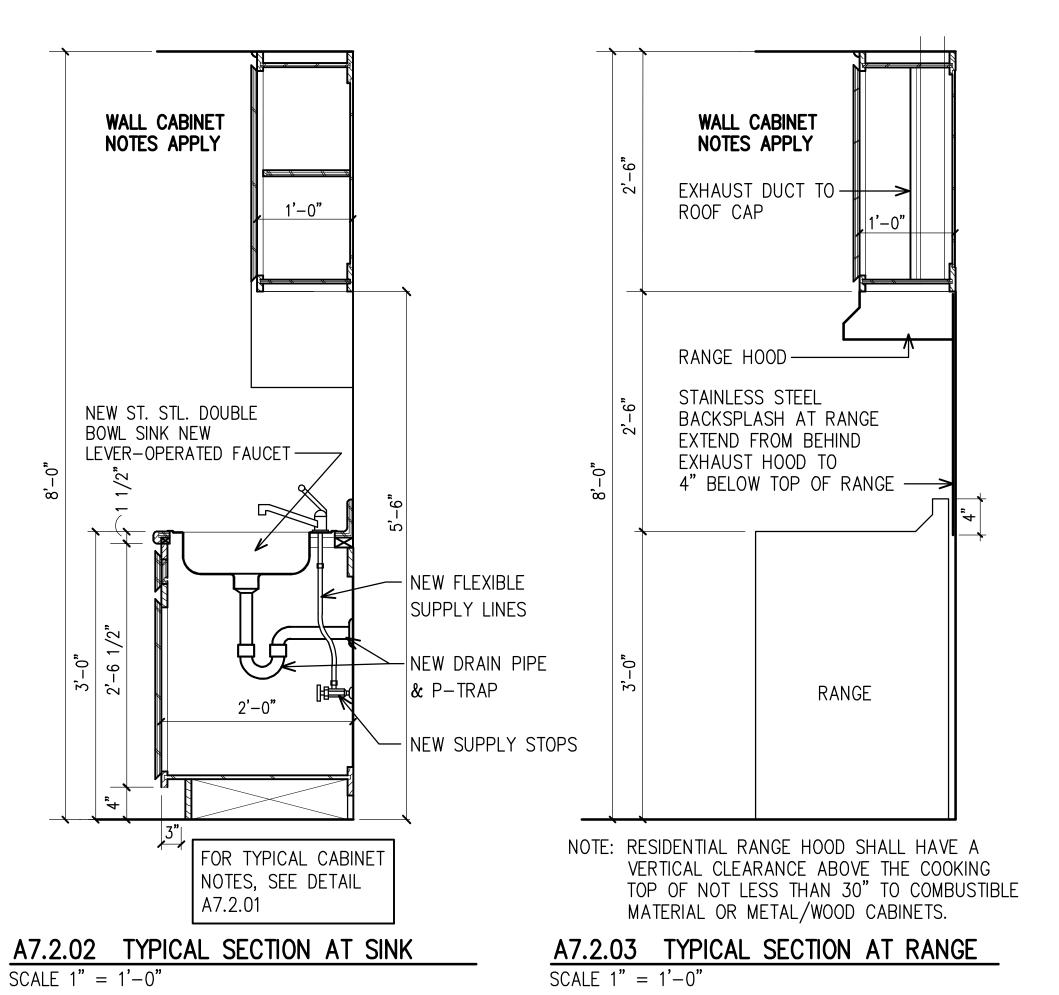
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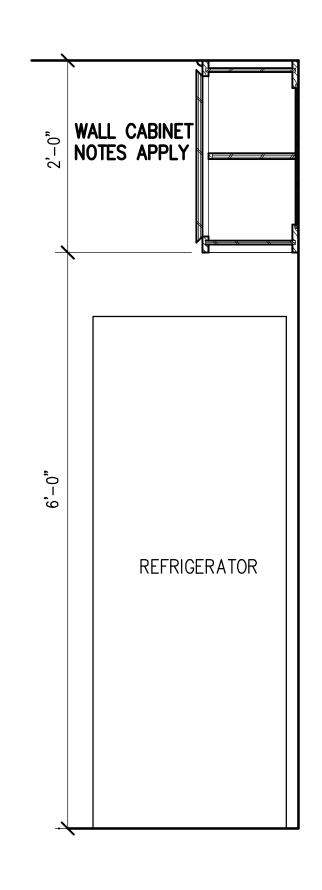
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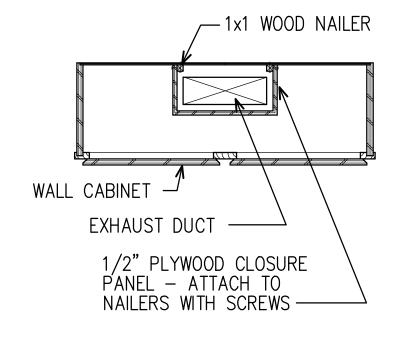


A7.2.04 TYP. SECT THRU CABINET AT REF.

SCALE: 1" = 1'-0"


## A7.2.01 TYPICAL SECTION THRU KITCHEN CABINETS

SCALE 1'' = 1'-0''

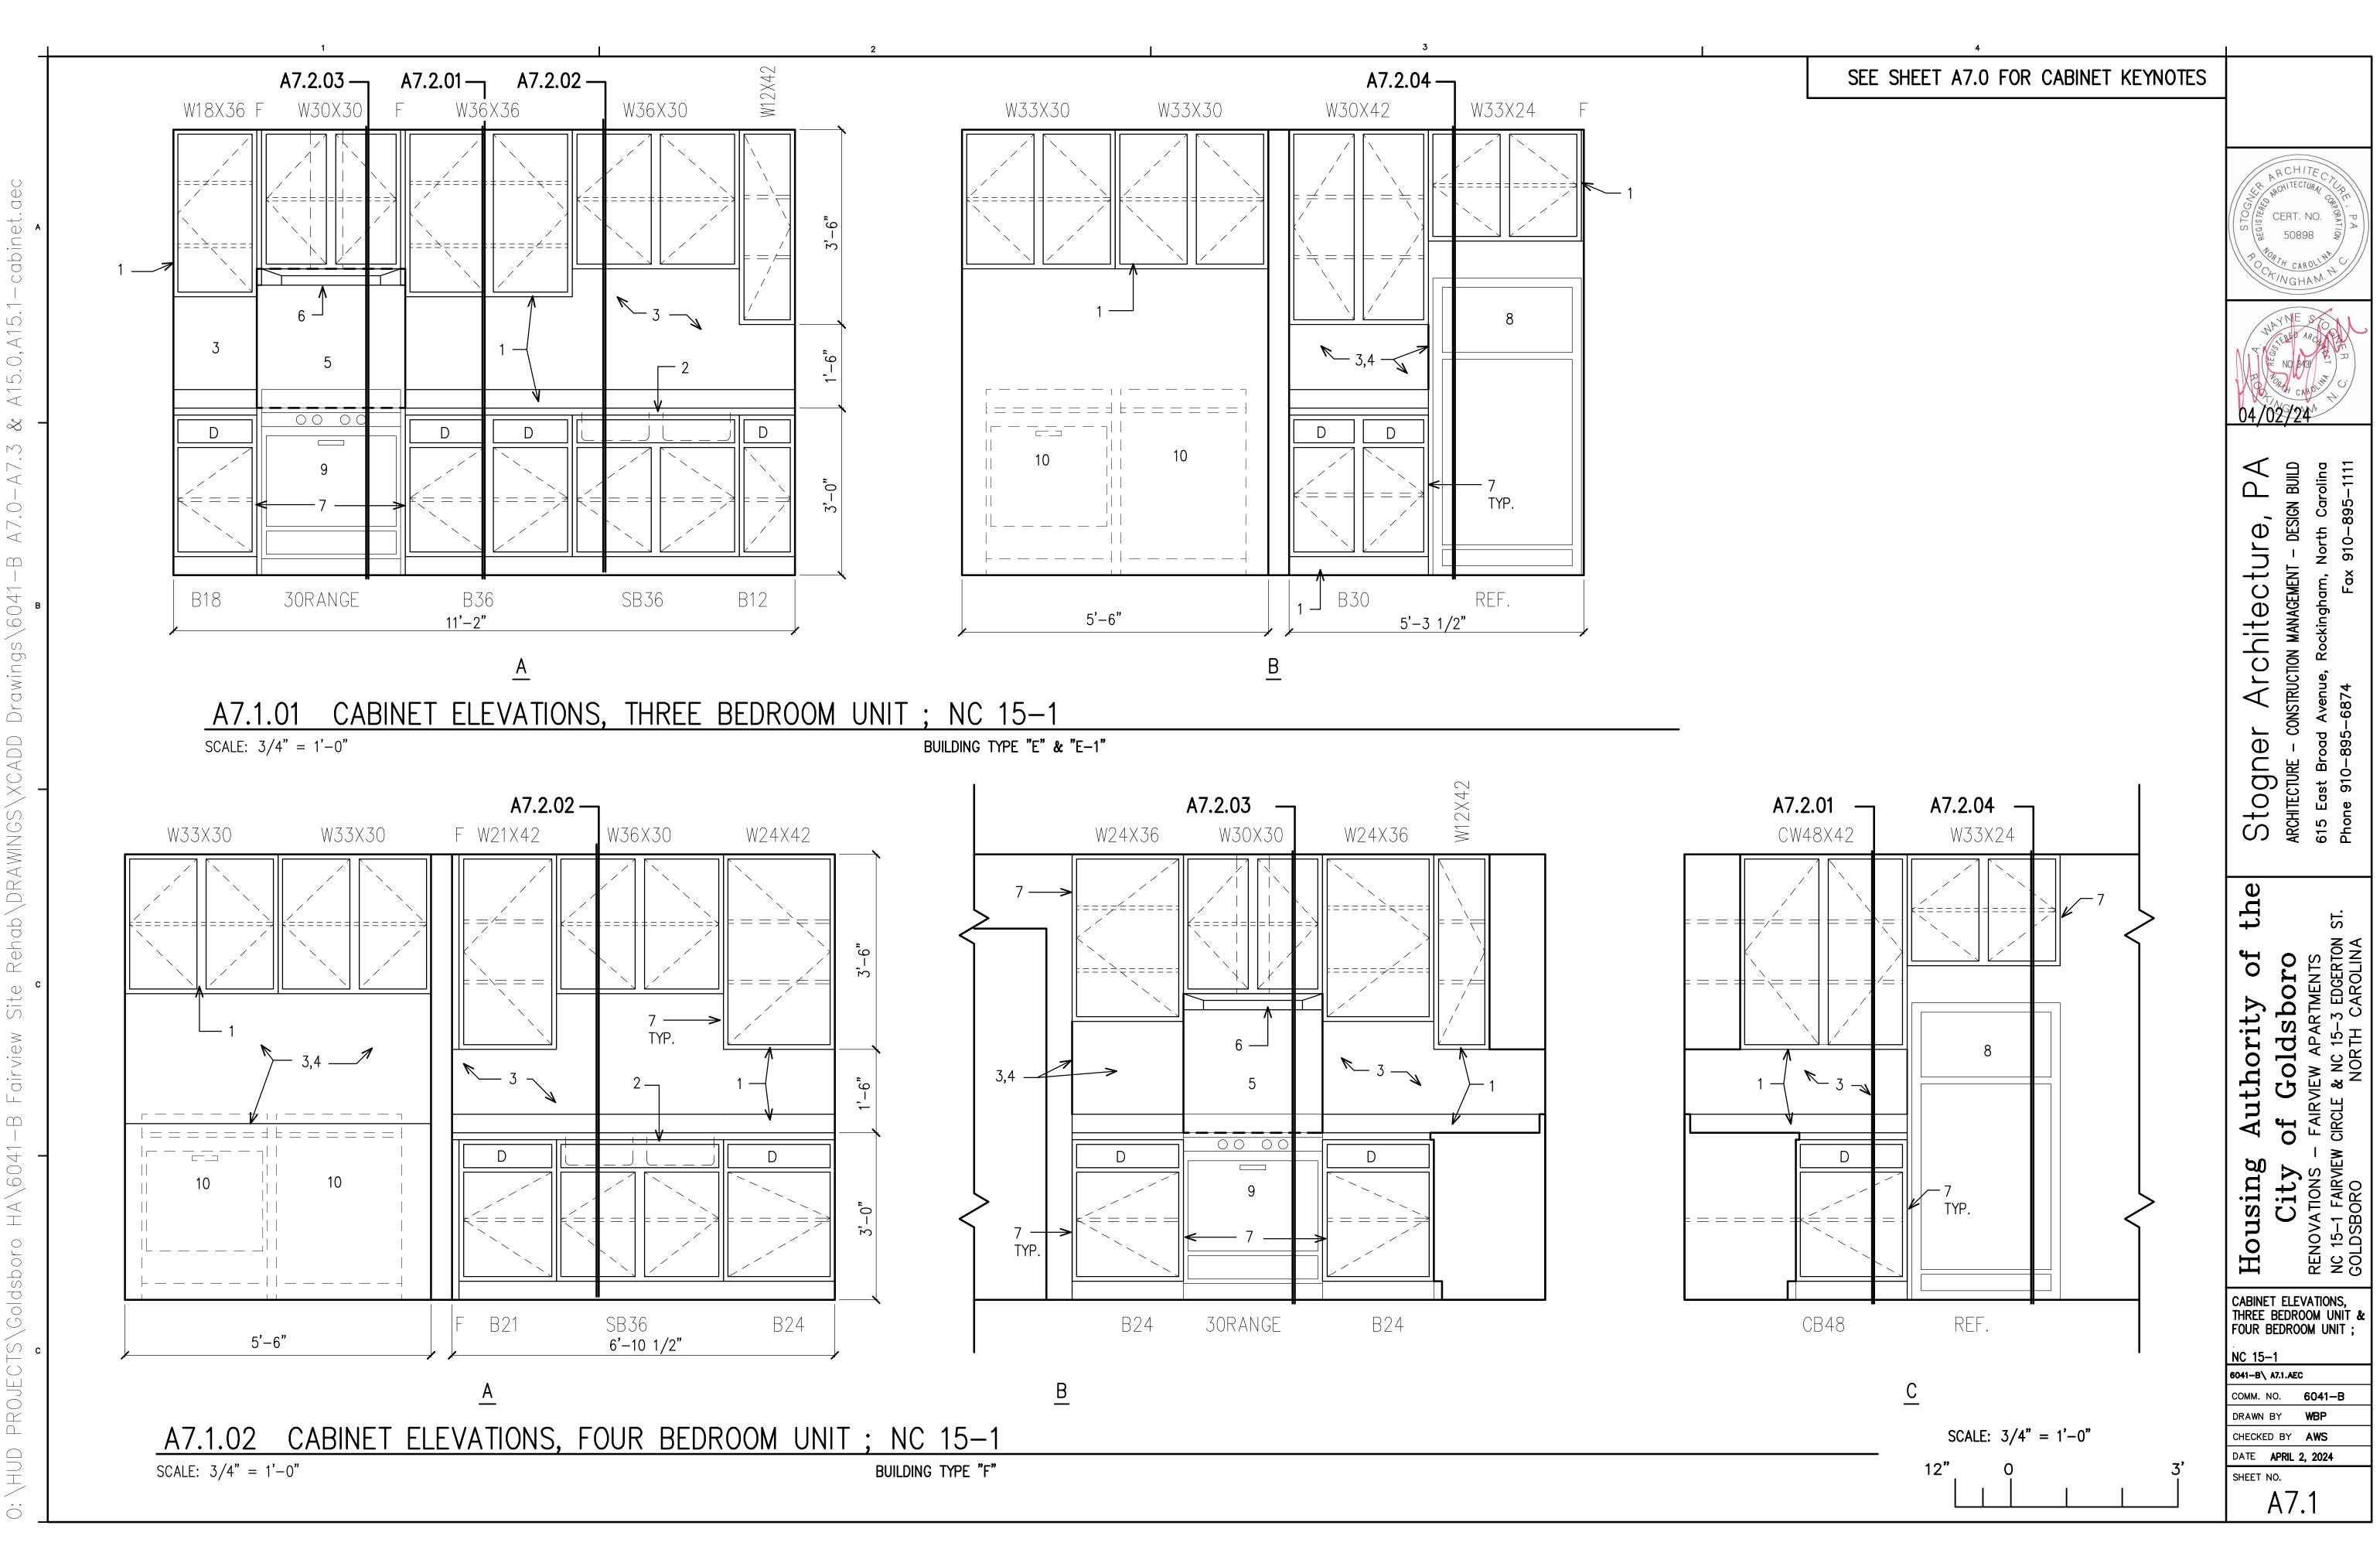

A7.2.05 SECTION AT RANGE VENT NO SCALE

SEAL TIGHT AT BOTTOM OF CABINETS AND WHERE THE CABINETS ABUT WALLS. STAIN TO MATCH CABINETS.

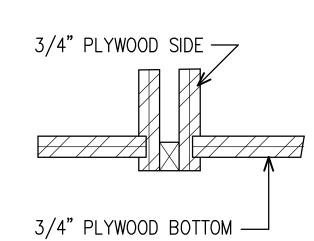

A7.2.06 CABINET CLOSURE DETAIL NO SCALE

SCALE 1'' = 1'-0''

NC 15-1 & NC 15-3

Housing

6041−B\ A7.2.AEC COMM. NO. **6041-B** DRAWN BY WBP

CABINET DETAILS;

CHECKED BY AWS DATE APRIL 2, 2024 SHEET NO.

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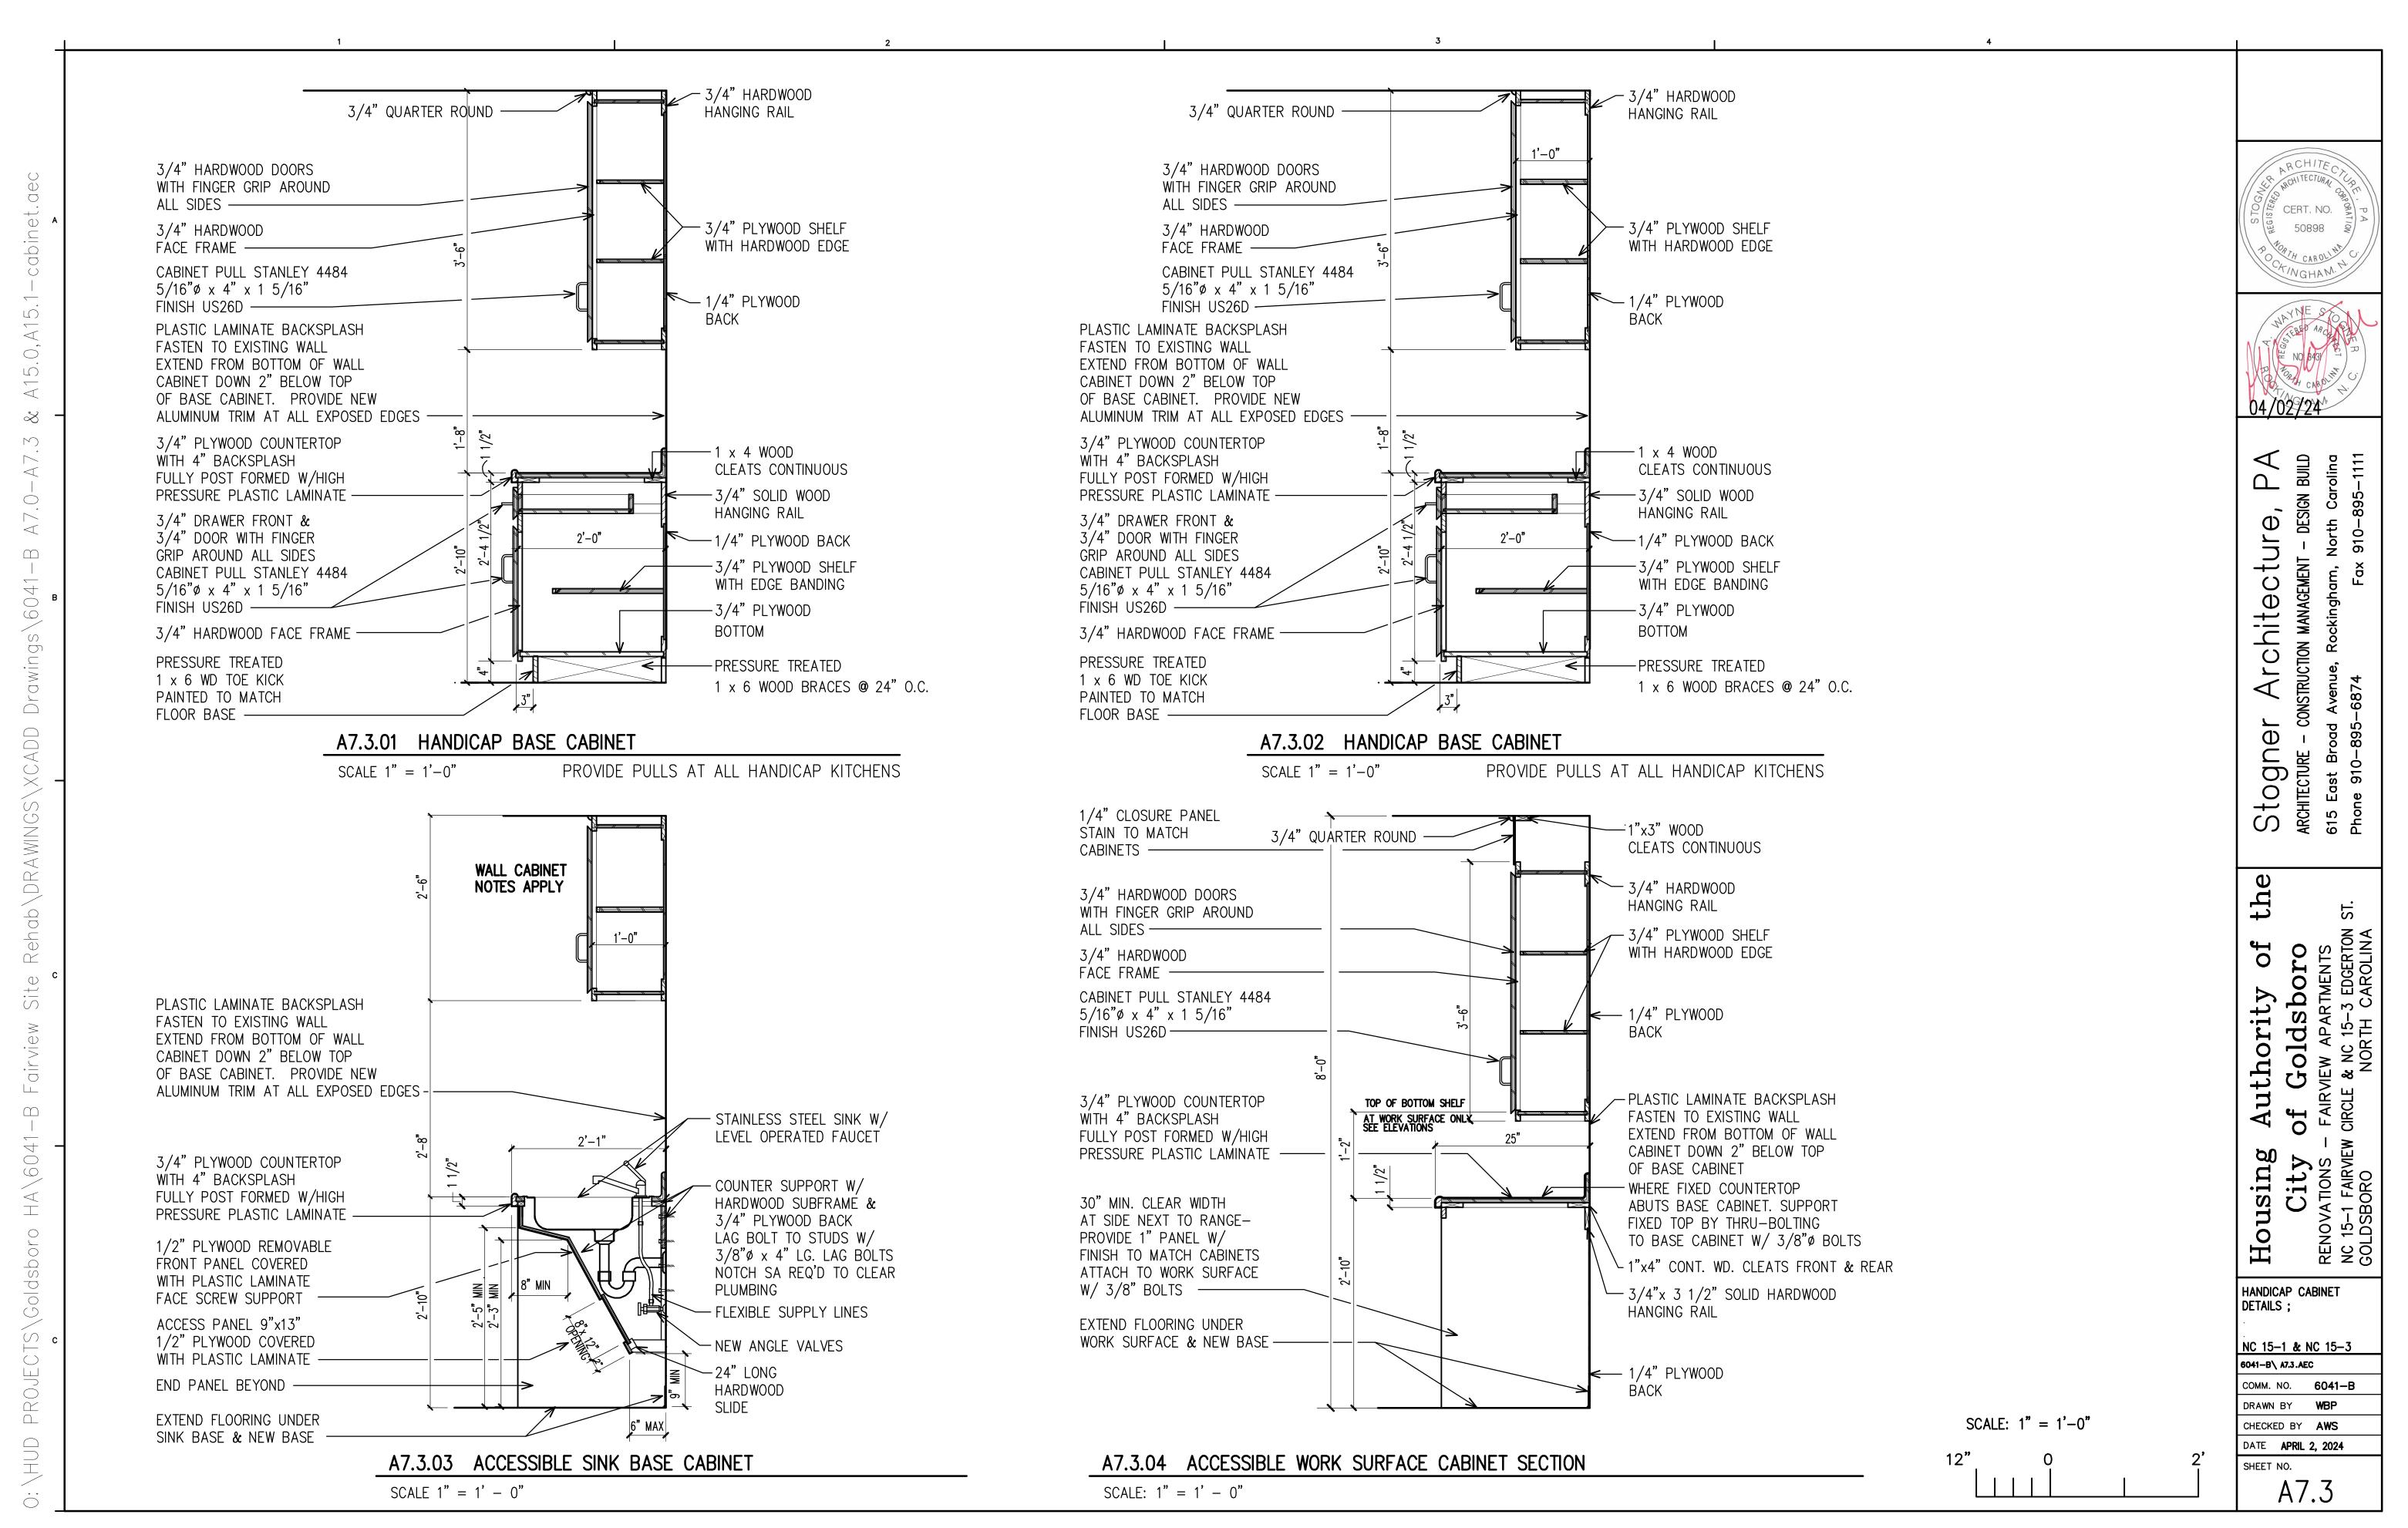
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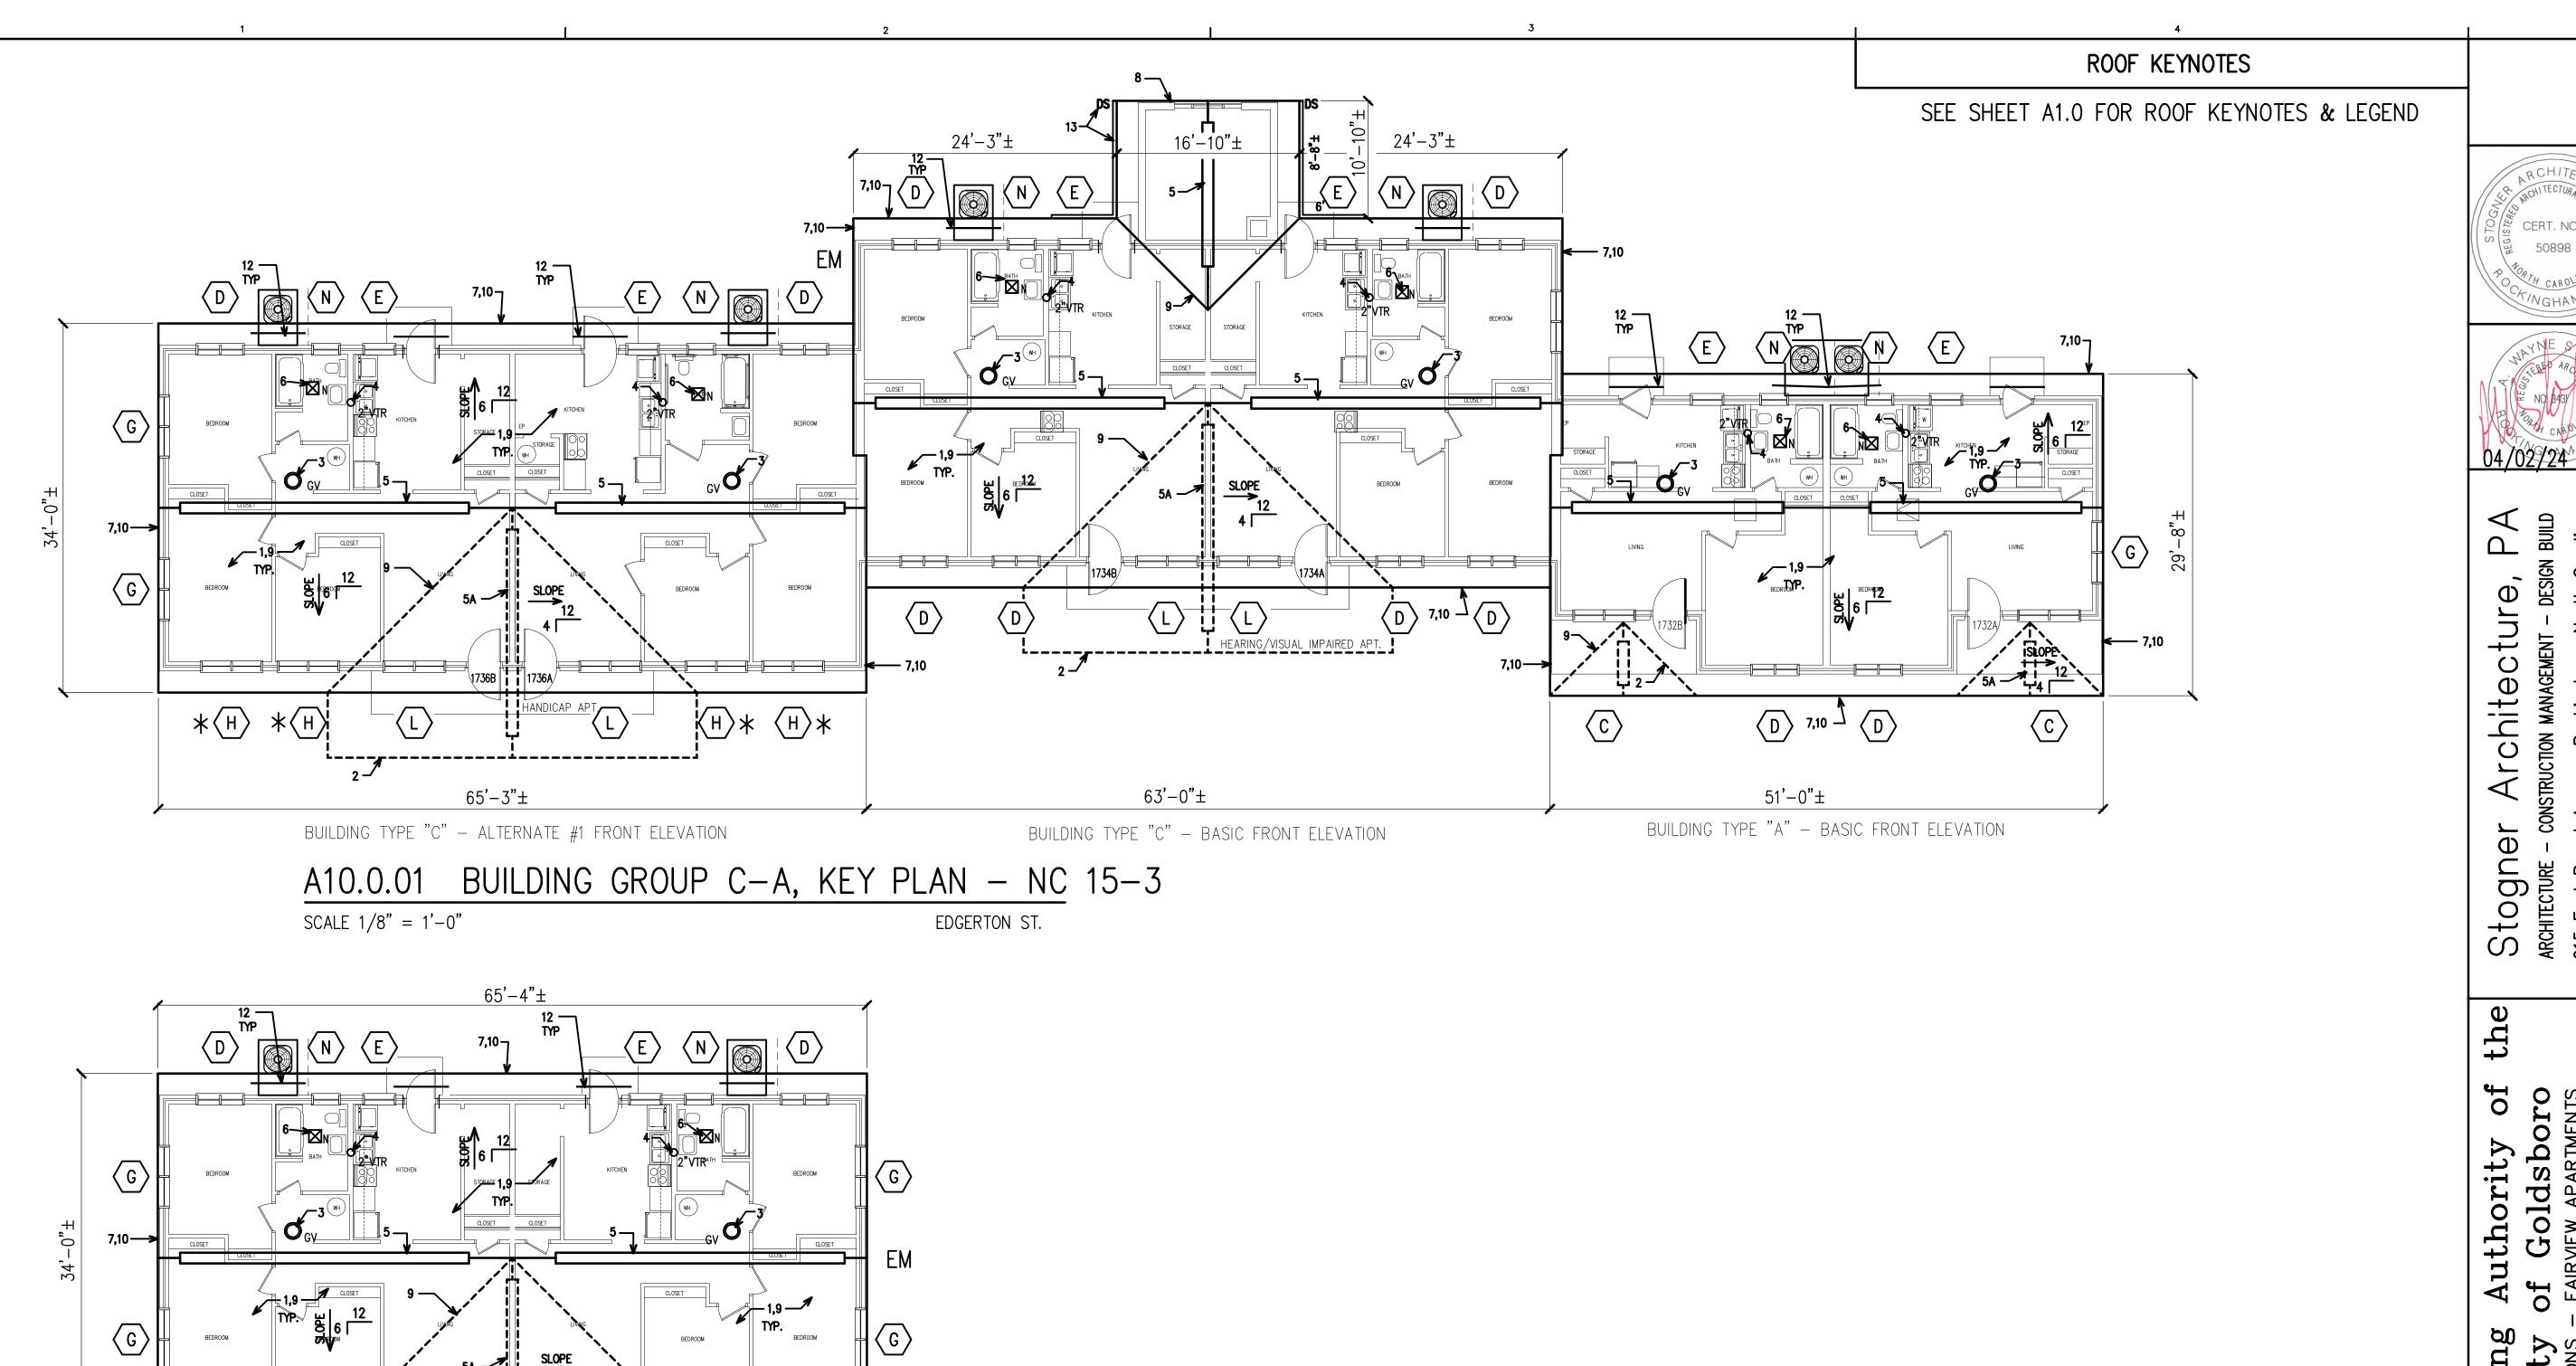
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A7.2

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BUILDING TYPE "C" - BASIC FRONT ELEVATION

BUILDING C, KEY PLAN - NC 15-3 A10.0.02 SCALE 1/8" = 1'-0"EDGERTON ST.

SCALE: 1/8" = 1'-0"

CERT. NO.

BLDG. GROUP "C-A" & "C", KEY PLAN - ROOF PLAN, WINDOW LOCATIONS;

6041-B\ A10.0.AEC


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SHEET NO. A10.0

#### **DEMOLITION KEYNOTES**

- D1. REMOVE EXISTING CONCRETE PORCH STOOP AT THREE BEDROOM APT.
- D2. EXISTING CONCRETE PORCH STOOP TO REMAIN.
- D3. CUT EXISTING FLOOR SLAB APPROX. 24" WIDE TO REPLACE UNDERSLAB SEWER PIPING & WATER SUPPLY PIPING.
- D4. REMOVE EXISTING PLASTER CEILING & ATTIC INSULATION COMPLETE. D5. REMOVE EXISTING ATTIC ACCESS.
- D6. REMOVE EXISTING PLASTER WALLS & FRAMING COMPLETE.
- D7. REMOVE EXISTING BASE, WALL CABINETS & COUNTERTOPS COMPLETE.
- D8. REMOVE EXISTING SHELVING & BRACKETS COMPLETE.
- D9. REMOVE EXISTING STORM DOORS, ENTRY DOORS, DOOR FRAMES & HARDWARE COMPLETE.
- D10. REMOVE EXISTING INTERIOR DOORS, DOOR FRAMES & HARDWARE.
- D11. REMOVE EXISTING PLUMBING FIXTURES, ASSOCIATED WASTE & SUPPLY PIPING. SEE PLUMBING DRAWINGS.
- D12. REMOVE EXISTING HEATER, DUCT WORK & SUPPLY GRILLS AS OCCURS. SEE MECHANICAL DRAWINGS.
- D13. REMOVE ALL VCT FLOOR TILE & WOOD BASE, ENTIRE APT..
- D14. REMOVE EXISTING CERAMIC TILE & BASE.
- D15. REMOVE EXISTING WINDOWS & TRIM COMPLETE. CUT EXISTING OPENING AS REQUIRED TO PROVIDE NEW WINDOW TO MEET EGRESS REQUIREMENTS. SEE WINDOW SCHEDULE & BUILDING ELEVATIONS FOR LOCATIONS THAT REQUIRE MODIFICATION OF EXISTING OPENINGS.
- D16. REMOVE EXISTING & PROVIDE NEW ROOF SHINGLES & NEW PORCH, SEE SHEETS A10.0 & A5.0.
- D17. EXISTING SLOPE ROOF AT OLD BOILER ROOM TO REMAIN. REMOVE EXISTING SHINGLES & UNDERLAYMNET. REMOVE EXISTING VINYL/PLY. WD. SHEATHING AT OPENING. SEE A12.0, A12.1 & A12.3.
- D18. REMOVE EXISTING WALL MT'D MAILBOX & FASTENERS, FILL HOLES W/ MORTAR TO MATCH BRICK.



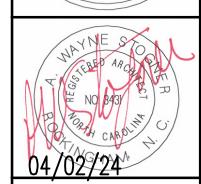

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DEMOLITION FLOOR PLAN ONE BEDROOM UNIT - BUILDING TYPE "A"; NC 15-3

6041-B\A11.0.AEC

COMM. NO. **6041-B** DRAWN BY WBP

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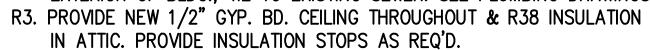
SHEET NO. A11.0

SCALE: 1/4" = 1'-0"

SCALE 1/4" = 1'-0"

#### RENOVATION KEYNOTES


- R1. PROVIDE NEW 4" THK., 3000 PSI CONCRETE PORCH SLAB. SEE A5.0 FOR REVISED PORCH/ROOF PLAN.
- R2. PROVIDE NEW SEWER DRAIN, WATER SUPPLY PIPING. BACKFILL AND COMPACT TO 98%, TREAT TRENCH & ENTIRE BLDG. FOR TERMITES. PROVIDE 4" STONE, VAPOR BARRIER, DRILL EXISTING SLAB @ 24" O.C., 6" DEEP & PROVIDE 12" LONG #5 BAR, POUR NEW 4" THK., 3000 PSI CONCRETE FLUSH W/ EXISTING SLAB. PROVIDE 4"ø CLEANOUT @ EXTERIOR OF BLDG., TIE TO EXISTING SEWER. SEE PLUMBING DRAWINGS.



- R4. PROVIDE NEW 20"X30" MIN. CLEAR ATTIC ACCESS. FIELD VERIFY EXACT LOCATION.
- R5. PROVIDE 1 1/2" RIGID INSULATION BOARD BETWEEN MTL. "Z" STRIPS MT'D VERTICAL @ 16" O.C. - TYPICAL AT OUTSIDE WALLS. PROVIDE FASTENERS TO EXTEND INTO BLOCK WALL BEYOND PLASTER. PROVIDE 1/2" GYP. BD. ON "Z" STRIPS, COORDINATE WORK W/ ELECTRICAL & PLUMBING CONTRACTOR.
- R5A. PROVIDE NEW 1HR. FIRE RATED SEPARATION WALL (1) LAYER 5/8" FIRE RATED GYP. BD. EA. SIDE ON 2X6 WD. STUDS @ 16" O.C., FASTEN GYP. BD. 8" O.C. PARTITION TO RUN FROM FRONT WALL TO REAR WALL CONTINUOUS & TOP OF FINISH FLOOR TO UNDERSIDE OF ROOF DECK. (DESIGN BASIS UL305) PROVIDE (1) LAYER OF 5" SOUND BATT INSULATION TO 2FT. ABOVE CEILING. CONTRACTOR SHALL PROVIDE UL RATED DEVICES FOR RATING REQUIRED STAGGER PENETRATIONS & FIRESTOP.
- R5B. PROVIDE 2X4 WD. FRAMING WALL W/ PRESSURE TREATED PLATE & 1/2" GYP. BD. EA. SIDE. PRIME & PAINT (2) COATS.
- R5C. PROVIDE 2X4 WD. FRAMING WALL W/ PRESSURE TREATED PLATE & 1/2" MOLD & MOISTURE RESISTANT GYP. BD. AT LAUNDRY & MECHANICAL ROOMS. PRIME & PAINT (2) COATS.
- R6. PROVIDE NEW WD. CLOSET SHELF, PRIME & PAINT. AT TYP. BEDROOM & HALL CLOSET (1) SHELF & ROD, AT STORAGE & LINEN CLOSET (4) SHELVES.
- R7. PROVIDE NEW WALL & BASE CABINETS, NEW SOLID SURFACE COUNTERTOPS W/ SPLASH.
- R8. PROVIDE NEW HOLLOW MTL. DOOR FRAME, INSULATED MTL. DOOR, HARDWARE & WEATHER STRIPPING. PROVIDE NEW STORM DOORS.
- R9. PROVIDE NEW WD. DOOR FRAME, SOLID CORE WD. DOOR & HARDWARE PROVIDE DOOR STOPS AT WALL WHEN OPEN 90° TO ADJACENT WALL.
- R10. PROVIDE NEW PLUMBING FIXTURES, WASTE & SUPPLY PIPING. SEE PLUMBING DRAWINGS. PROVIDE MOLD & MOISTURE RESISTANT GYP. BD. AT LAUNDRY & MECHANICAL ROOMS.
- R11. PROVIDE NEW HVAC & ASSOCIATED WORK. SEE MECHANICAL DRAWINGS. NEW PAD SIZE TO BE (42"x60") MIN. PROVIDE MOLD & MOISTURE
- RESISTANT GYP. BD. AT LAUNDRY & MECHANICAL ROOMS. R12. PROVIDE NEW LVT (BASE BID) & VCT (ALT BID), PAINTED WD. BASE & SHOE MOLD THROUGHOUT APARTMENT.
- R13. PROVIDE NEW CERAMIC TILE & BASE AT BATHROOMS.
- R14. PROVIDE NEW VINYL REPLACEMENT WINDOWS, SEE BLDG. KEY & ELEVATIONS FOR WINDOW SIZE & LOCATIONS.
- R15. PROVIDE NEW FULL PET SCREEN IN ALUMINUM FRAME W/ HARDWARE AT ALL WINDOWS.
- R16. PROVIDE NEW SHUTTERS AT WINDOWS SHOWN ON ELEVATIONS.
- R17. PROVIDE NEW PORCH, OVERHANG & ROOF. SEE SHEET A10.0, A11.3, A12.5, SEE PORCH DETAILS A5.0.
- R18. PROVIDE NEW PLY WD. OVERLAY, UNDERLAYMENT & SHINGLES. PROVIDE NEW SHEATHING, SIDING & TRIM AT OPENING, SEE ELEVATIONS. SEE SHEETS A10.0, A12.0, A12.1 & A12.3.

SCALE:  $1/4^{\circ} = 1'-0''$ 



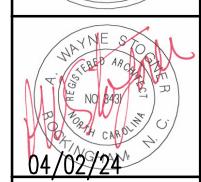

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RENOVATION FLOOR PLAN ONE BEDROOM UNIT -BUILDING TYPE "A"; NC 15-3

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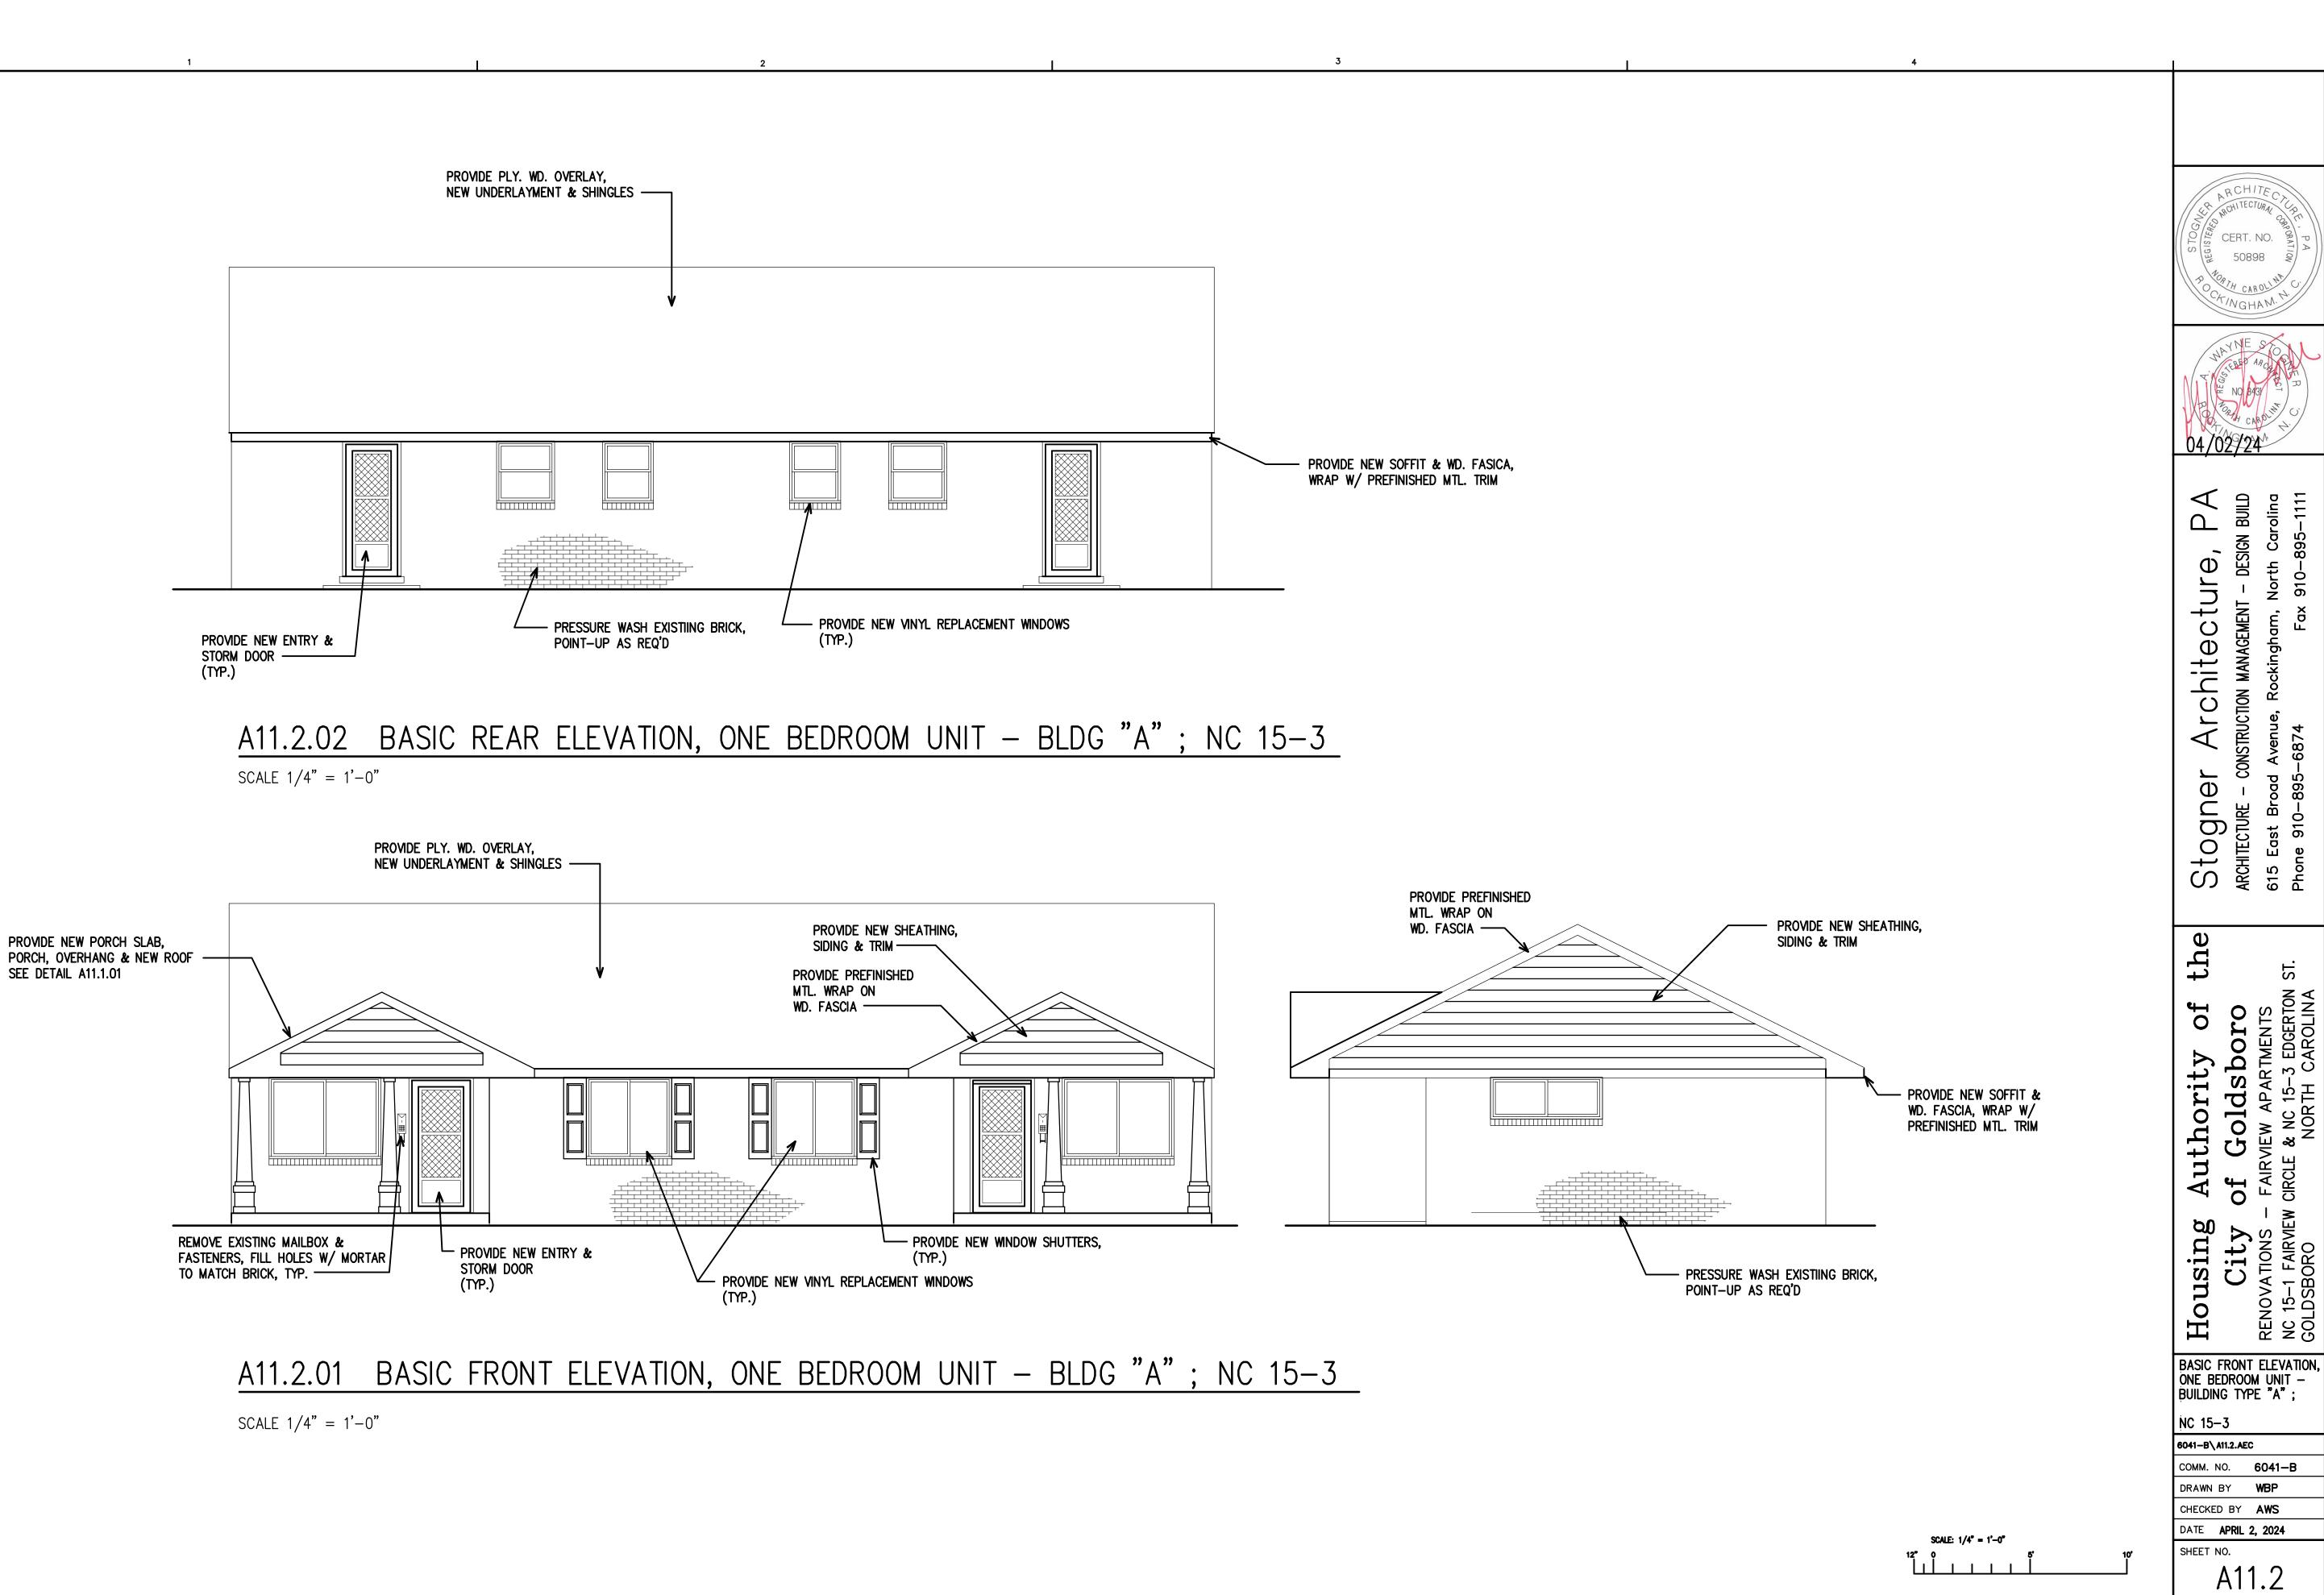
COMM. NO. **6041-B** DRAWN BY CHECKED BY AWS

DATE **APRIL 2, 2024** 


SHEET NO. A11.1

RENOVATION FLOOR PLAN, ONE BEDROOM UNIT; NC 15-3

BUILDING TYPE 'A'



# A11.3.01 REVISED PORCH/ROOF PLAN, ONE BEDROOM UNIT - BUILDING TYPE "A"; NC 15-3 SCALE: 1/4" = 1'-0"

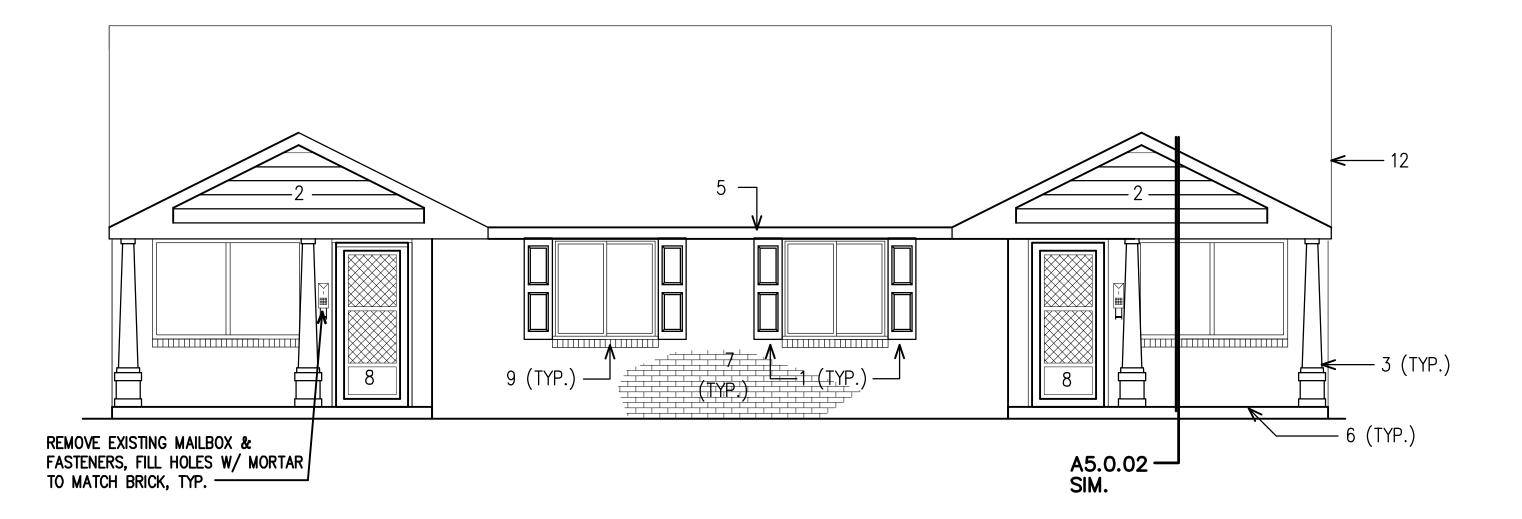

A11.3.02 REVISED ELEVATION, ONE BEDROOM UNIT — BUILDING TYPE "A"; NC 15-3

SCALE: 1/4" = 1'-0"

## KEYNOTES - REVISED PORCH/ROOF, FRONT ELEVATION

- 1. PROVIDE NEW WINDOW SHUTTERS.
- 2. PROVIDE NEW SIDING AND TRIM.
- 3. PROVIDE NEW PORCH COLUMN.
- 4. PROVIDE NEW FRONT PORCH SLAD. POUR WITH 3000PSI CONCRETE.
- 5. REMOVE EXISTING METAL WRAP FROM FREIZE BOARD AND EXISTING WOOD, VENTED SOFFIT.
- PROVIDE NEW 2x6 WOOD FASCIA AND SOFFIT CONTINUOUS. WRAP FASCIA WITH NEW PRE FINISHED METAL. SEE DETAIL A5.5.
- 6. NOT USED.
- 7. EXISTING BRICK. CLEAN, PATCH AND POINT-UP AS REQUIRED.
- 8. EXISTING ENTRY DOOR AND STORM DOOR TO REPLACED.
- 9. EXISTING WINDOWS TO BE REPLACED.
- 10. PROVIDE NEW PORCH, OVERHANG AND ROOF.
- 11. EXISTING ROOF, SEE SHEET A10.0 FOR WORK ASSOCIATED WITH ROOF.
- 12. REMOVE EXISTING SIDING, TRIM & SHEATHING COMPLETE. PROVIDE NEW SIDING AND TRIM.

CERT. NO.



Architecture,

REVISED PORCH/ROOF PLAN, FRONT ELEVATION, ONE BEDROOM UNIT — BUILDING TYPE "A"; NC 15-3


6041-B\A11.3.AEC

COMM. NO. **6041-B** DRAWN BY WBP CHECKED BY AWS

DATE APRIL 2, 2024

SHEET NO. A11.3

SCALE:  $1/4^{\circ} = 1'-0''$ 

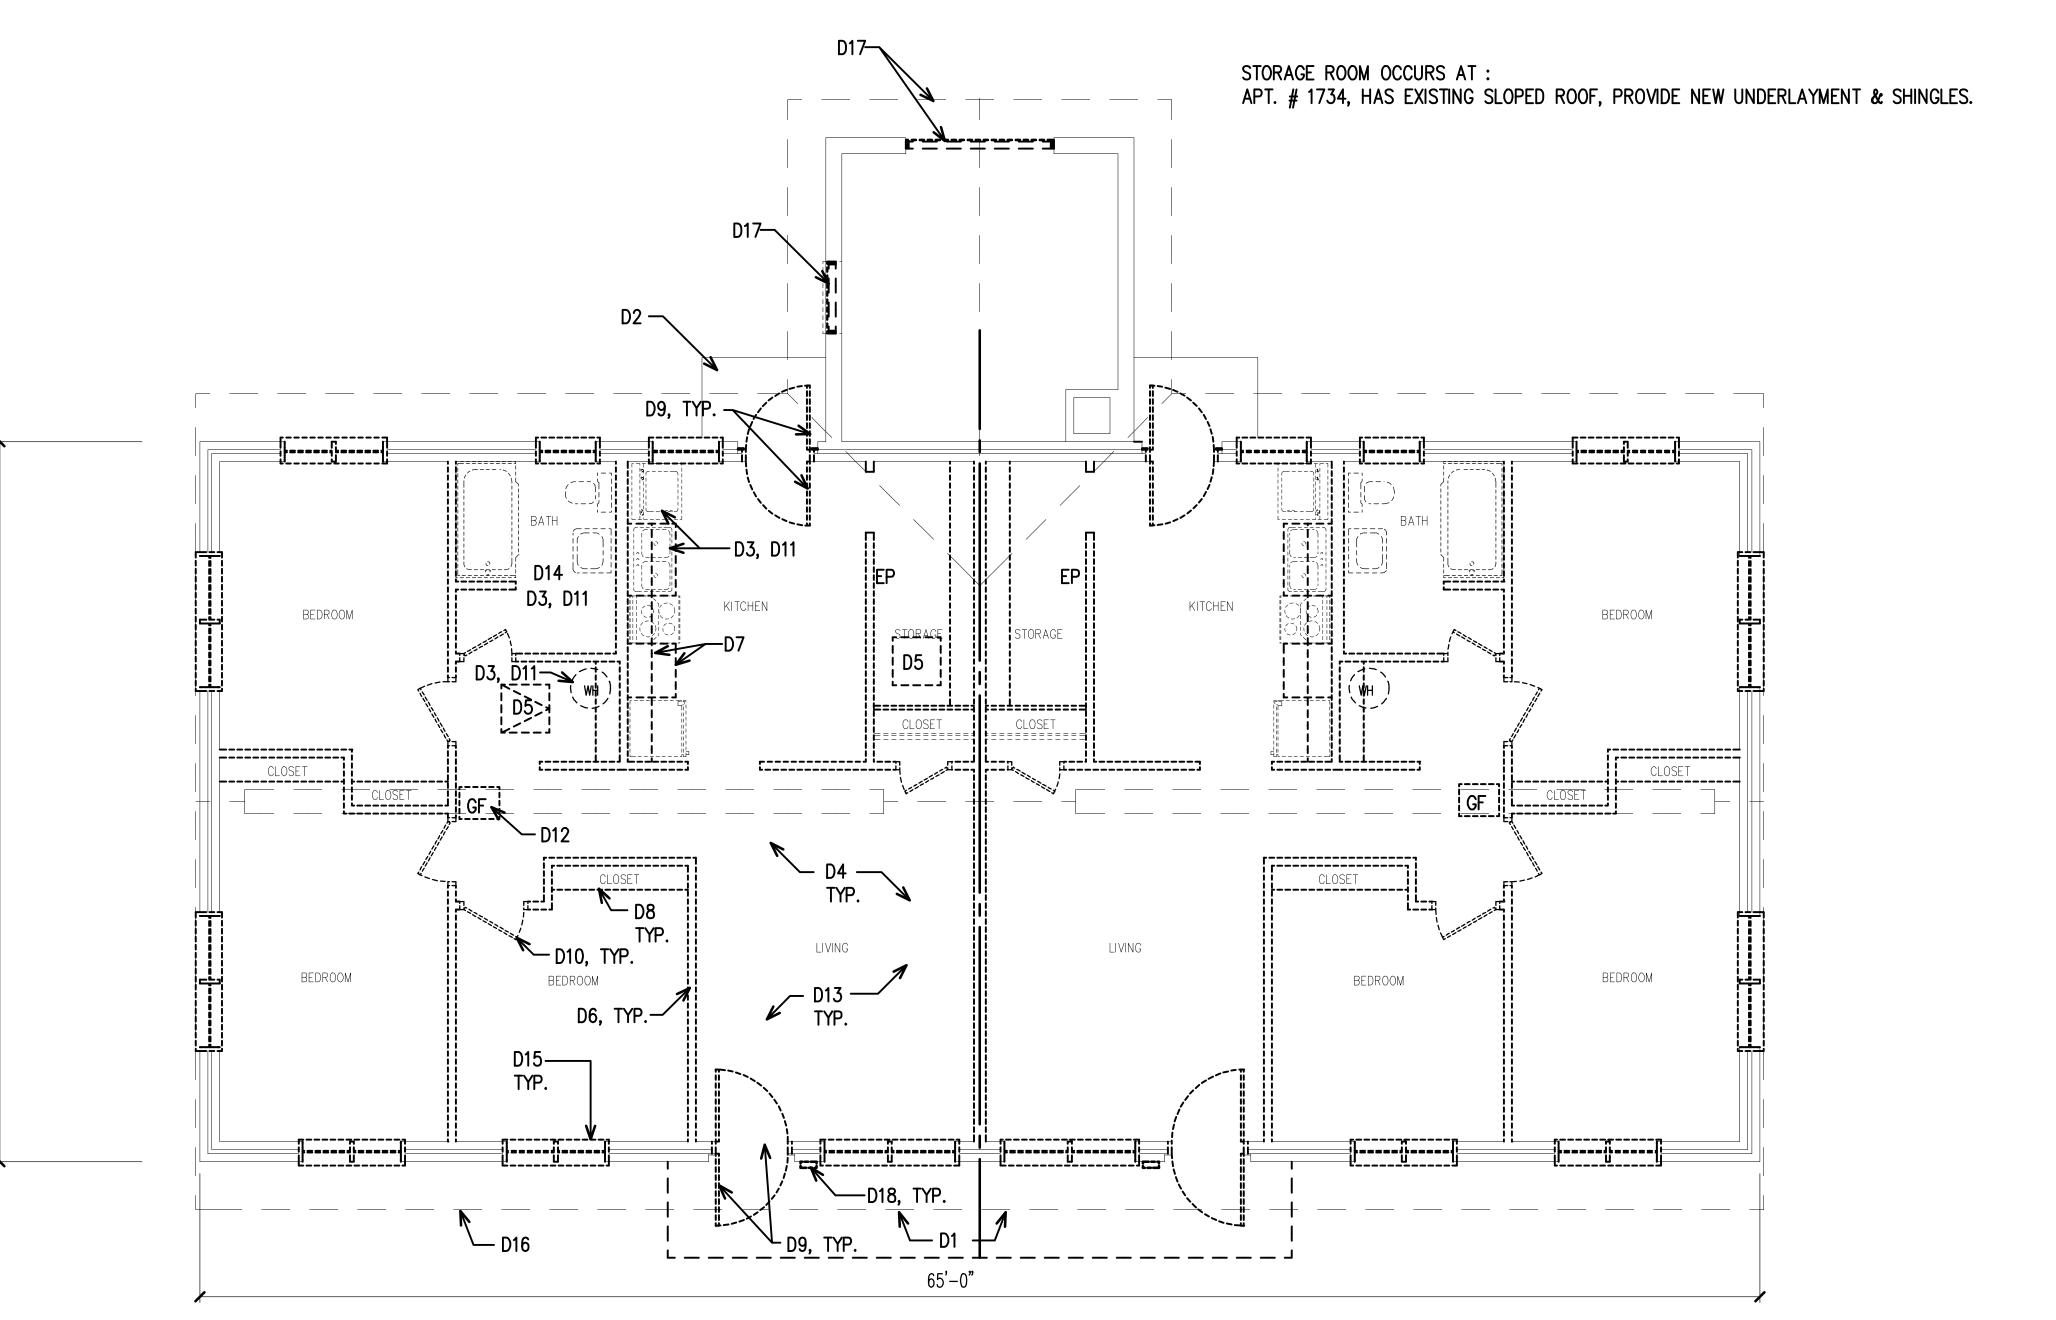

FRONT WINDOW SIZES VARY, SEE ELEVATIONS


BLDG C/1, APT #1734 - EDGERTON ST.; BASIC FRONT ELEVATION
BLDG C/1, APT #1736 - EDGERTON ST.; ALTERNATE #1 FRONT ELEVATION
NOTE: DOOR LOCATION VARIES DUE TO WINDOW LAYOUT
BLDG C/2, APT #1904 - EDGERTON ST.; BASIC FRONT ELEVATION

DEMOLITION FLOOR PLAN, THREE BEDROOM UNIT; NC 15-3

BUILDING TYPE 'C' SCALE 1/4" = 1'-0"

SCALE:  $1/4^{\circ} = 1'-0^{\circ}$ 

CERT. NO.

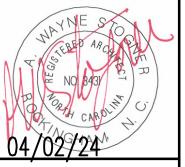

Architectur


Stogner

DEMOLITION FLOOR PLAN, THREE BEDROOM UNIT BUILDING TYPE "C"; NC 15-3

6041-B\A12.0.AEC

COMM. NO. **6041-B** DRAWN BY WBP CHECKED BY AWS DATE **APRIL 2, 2024** 

SHEET NO. A12.0

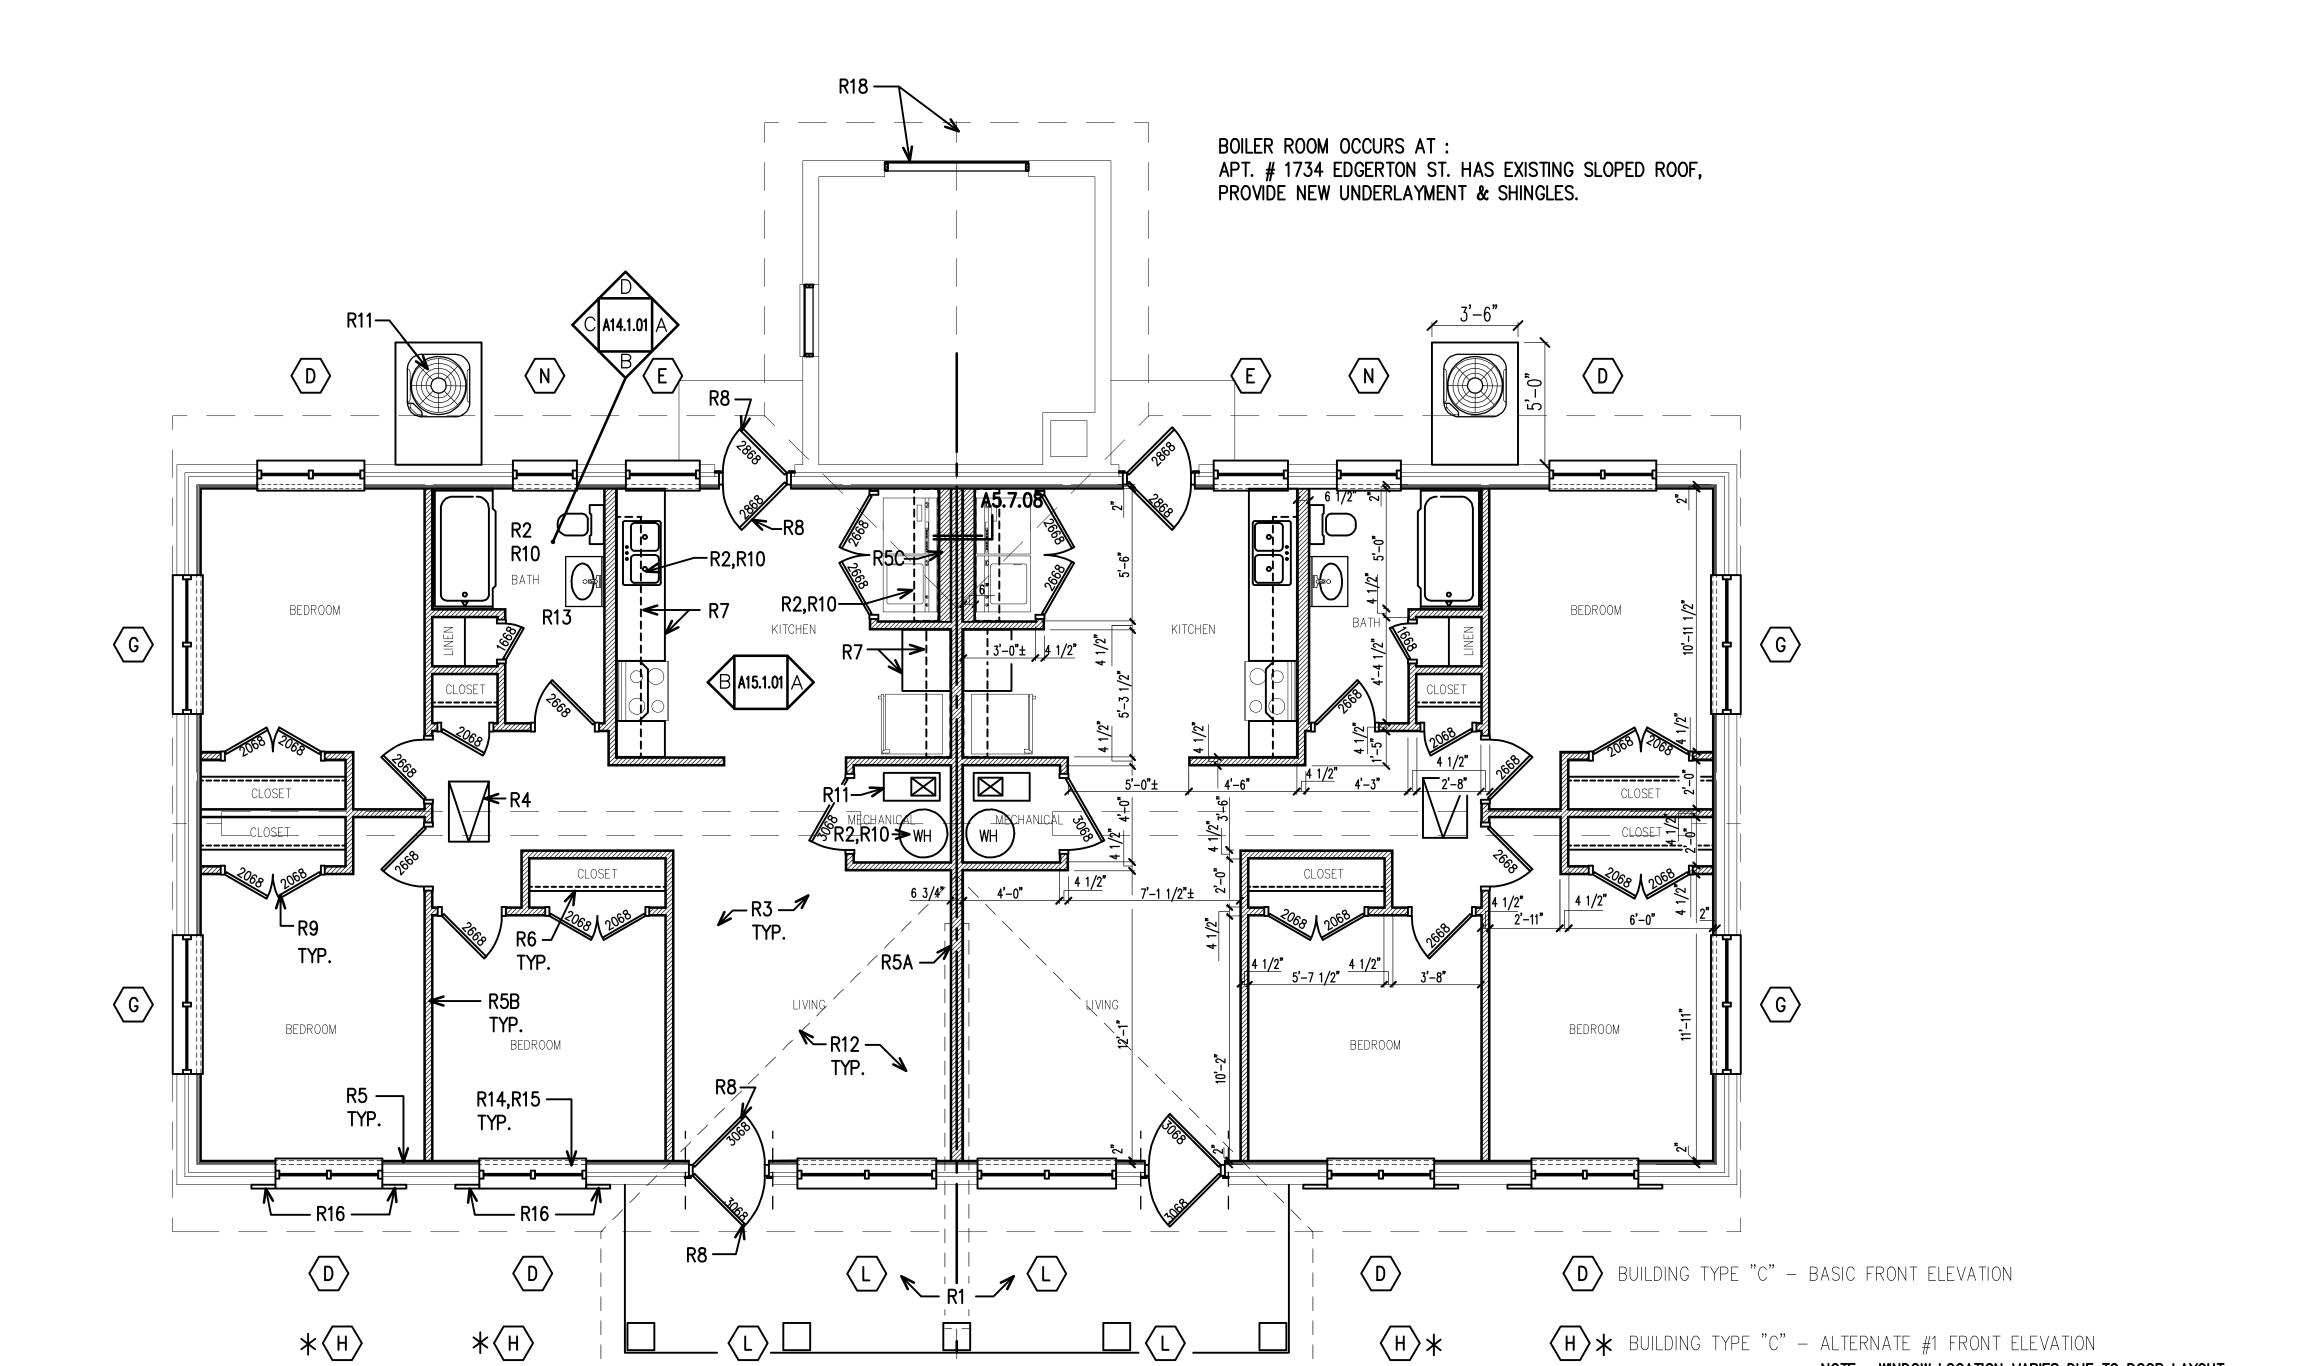


RENOVATION FLOOR PLAN, THREE BEDROOM UNIT; NC 15-3 BUILDING TYPE 'C' SCALE 1/4" = 1'-0"

SCALE: 1/4" = 1'-0"

H \* BUILDING TYPE "C" - ALTERNATE #1 FRONT ELEVATION

NOTE: WINDOW LOCATION VARIES DUE TO DOOR LAYOUT

CERT. NO.

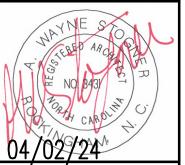

RENOVATION FLOOR PLAN, THREE BEDROOM UNIT —
BUILDING TYPE "C";
NC 15—3

6041-B\A12.1.AEC


COMM. NO. **6041-B** DRAWN BY WBP CHECKED BY AWS

DATE **APRIL 2, 2024** SHEET NO.

A12.1

SEE SHEET A11.0 FOR DEMOLITION KEYNOTES


SEE SHEET A11.1 FOR RENOVATION KEYNOTES

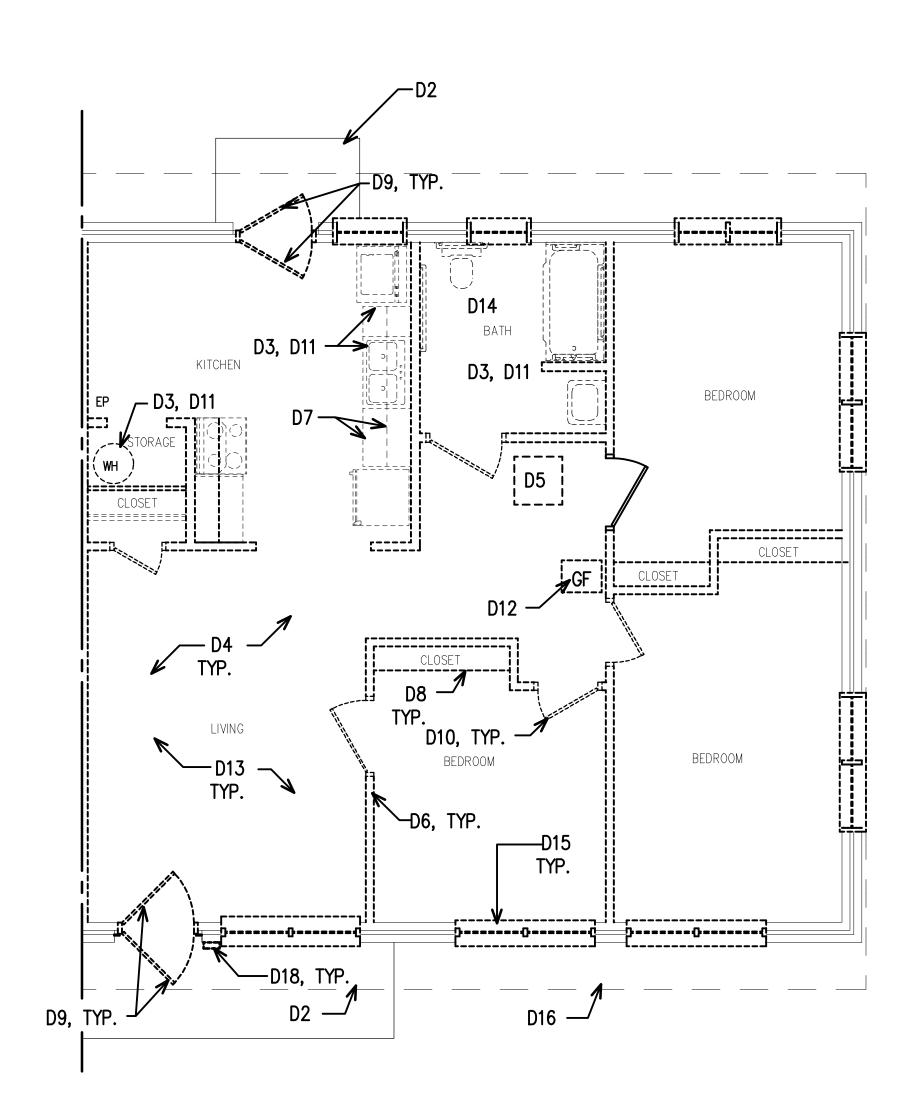

FRONT WINDOW SIZES VARY, SEE ELEVATIONS BLDG C/1, APT #1736A - EDGERTON ST.; ALTERNATE #1 FRONT ELEVATION

DEMOLITION FLOOR PLAN, THREE BEDROOM HANDICAP UNIT; NC 15-3

> BUILDING TYPE 'C' SCALE 1/4" = 1'-0"

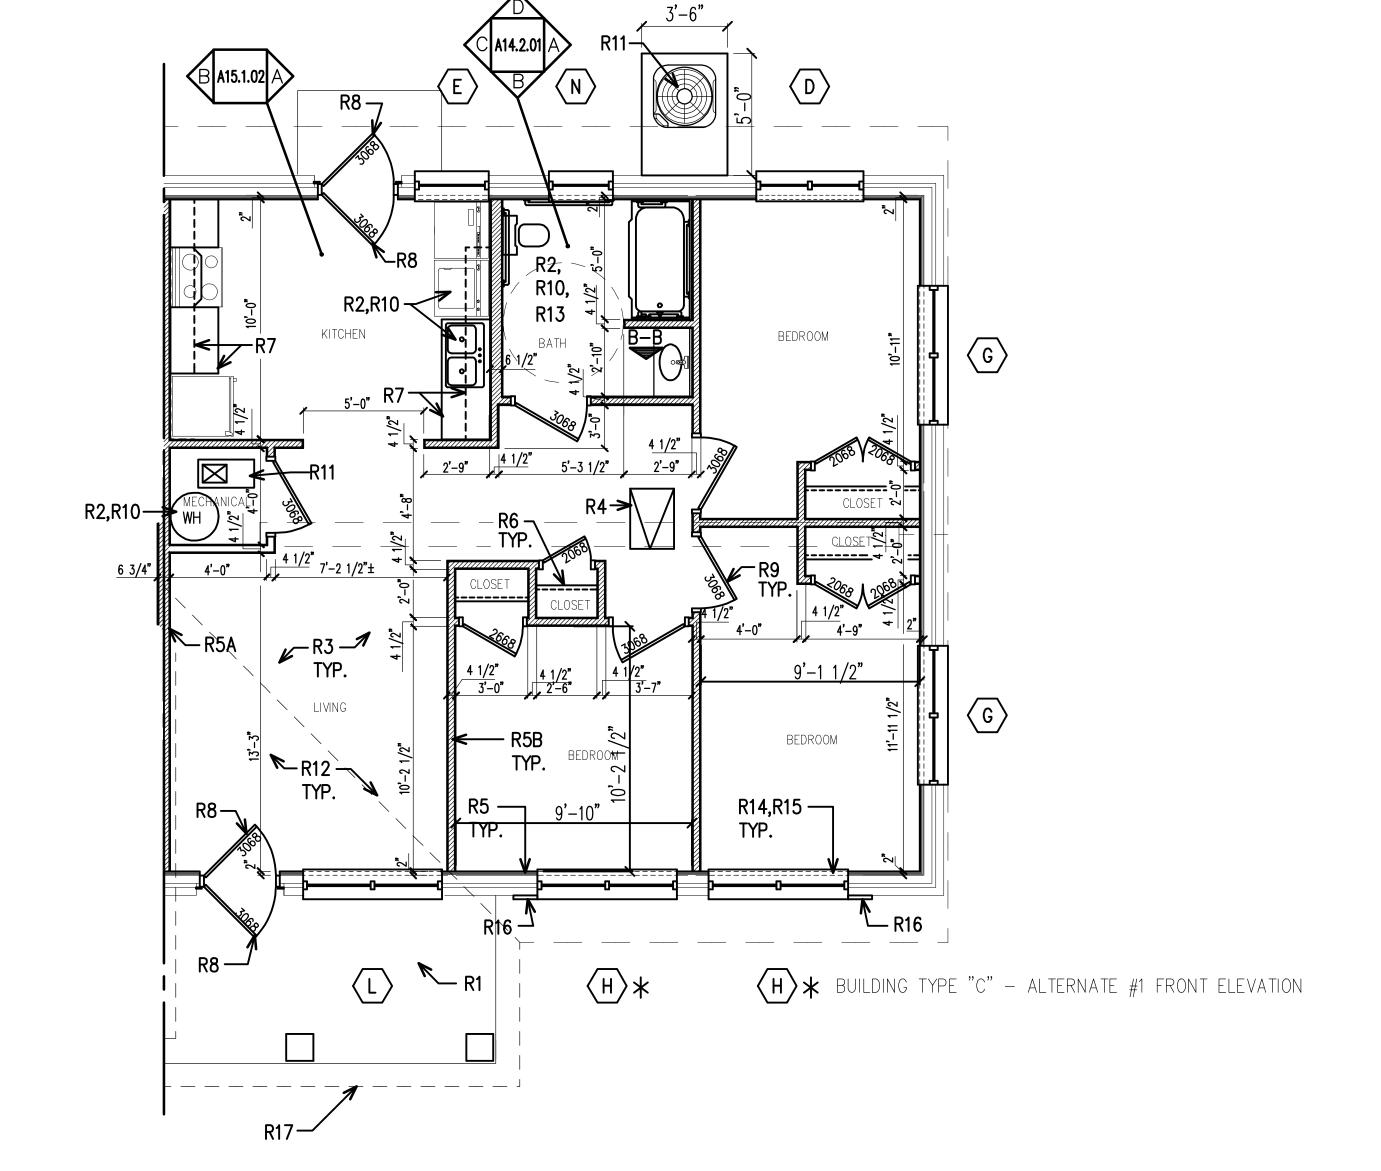


RENOVATION FLOOR PLAN, THREE BEDROOM HANDICAP UNIT; NC 15-3

BUILDING TYPE 'C' SCALE 1/4" = 1'-0"

SCALE:  $1/4^{\circ} = 1'-0^{\circ}$ 



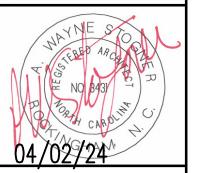


DEMOLITION/RENOVATION FLOOR PLAN, THREE BEDROOM HANDICAP UNIT -BUILDING TYPE "C"; NC 15-3

6041-B\A12.2.AEC

COMM. NO. **6041-B** DRAWN BY WBP CHECKED BY AWS DATE **APRIL 2, 2024** 

SHEET NO. A12.2



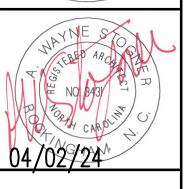

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ARCHITECTURE - COI
615 East Broad A
Phone 910-895-

BASIC FRONT ELEVATION, THREE BEDROOM UNIT — BUILDING TYPE "C";

NC 15-3 6041-B\A7.3 .AEC


COMM. NO. **6041-B** DRAWN BY WBP CHECKED BY AWS

DATE **APRIL 2, 2024** SHEET NO. A12.3

A12.4

CERT. NO.

A12.5.01 REVISED PORCH/ROOF PLAN, THREE BEDROOM UNIT - BUILDING TYPE "C"; NC 15-3

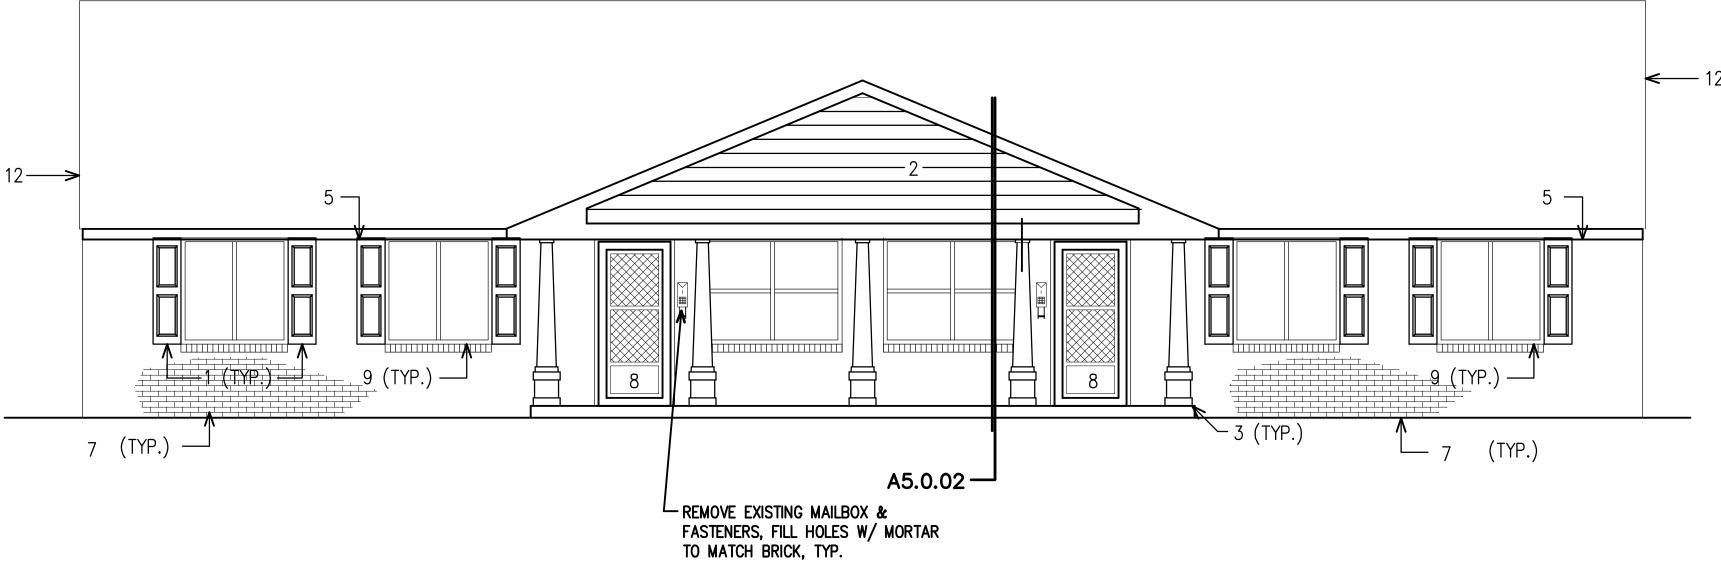

SCALE: 1/4" = 1'-0"

# KEYNOTES - REVISED PORCH/ROOF, FRONT ELEVATION

- 1. PROVIDE NEW WINDOW SHUTTERS.
- 2. PROVIDE NEW SIDING AND TRIM.
- 3. PROVIDE NEW PORCH COLUMN.
- 4. PROVIDE NEW FRONT PORCH SLAD. POUR WITH 3000PSI CONCRETE.
- 5. REMOVE EXISTING METAL WRAP FROM FREIZE BOARD AND EXISTING WOOD, VENTED SOFFIT.
- PROVIDE NEW 2x6 WOOD FASCIA AND SOFFIT CONTINUOUS. WRAP FASCIA WITH NEW PRE FINISHED METAL. SEE DETAIL A5.5.
- 6. NOT USED.
- 7. EXISTING BRICK. CLEAN, PATCH AND POINT-UP AS REQUIRED.
- 8. EXISTING ENTRY DOOR AND STORM DOOR TO REPLACED.
- 9. EXISTING WINDOWS TO BE REPLACED.
- 10. PROVIDE NEW PORCH, OVERHANG AND ROOF.
- 11. EXISTING ROOF, SEE SHEET A10.0 FOR WORK ASSOCIATED WITH ROOF.
- 12. REMOVE EXISTING SIDING, TRIM & SHEATHING COMPLETE. PROVIDE NEW SIDING AND TRIM.





REVISED PORCH/ROOF PLAN, FRONT ELEVATION, THREE BEDROOM UNIT — BUILDING TYPE "C"; NC 15-3


6041-B\A12.5.AEC

COMM. NO. **6041-B** DRAWN BY WBP CHECKED BY AWS

DATE APRIL 2, 2024 SHEET NO.

A12.5


SCALE: 1/4" = 1'-0"

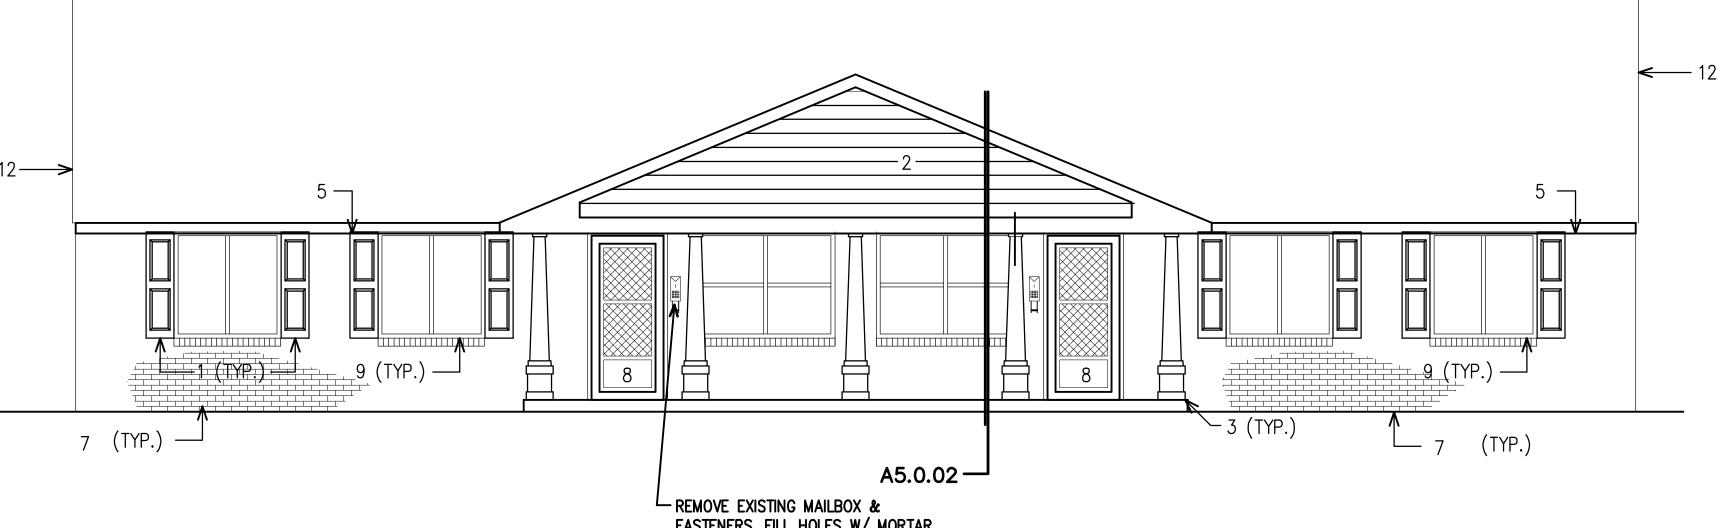

A12.5.02 REVISED ELEVATION, THREE BEDROOM UNIT - BUILDING TYPE "C"; NC 15-3


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SCALE:  $1/4^{\circ} = 1'-0''$ 

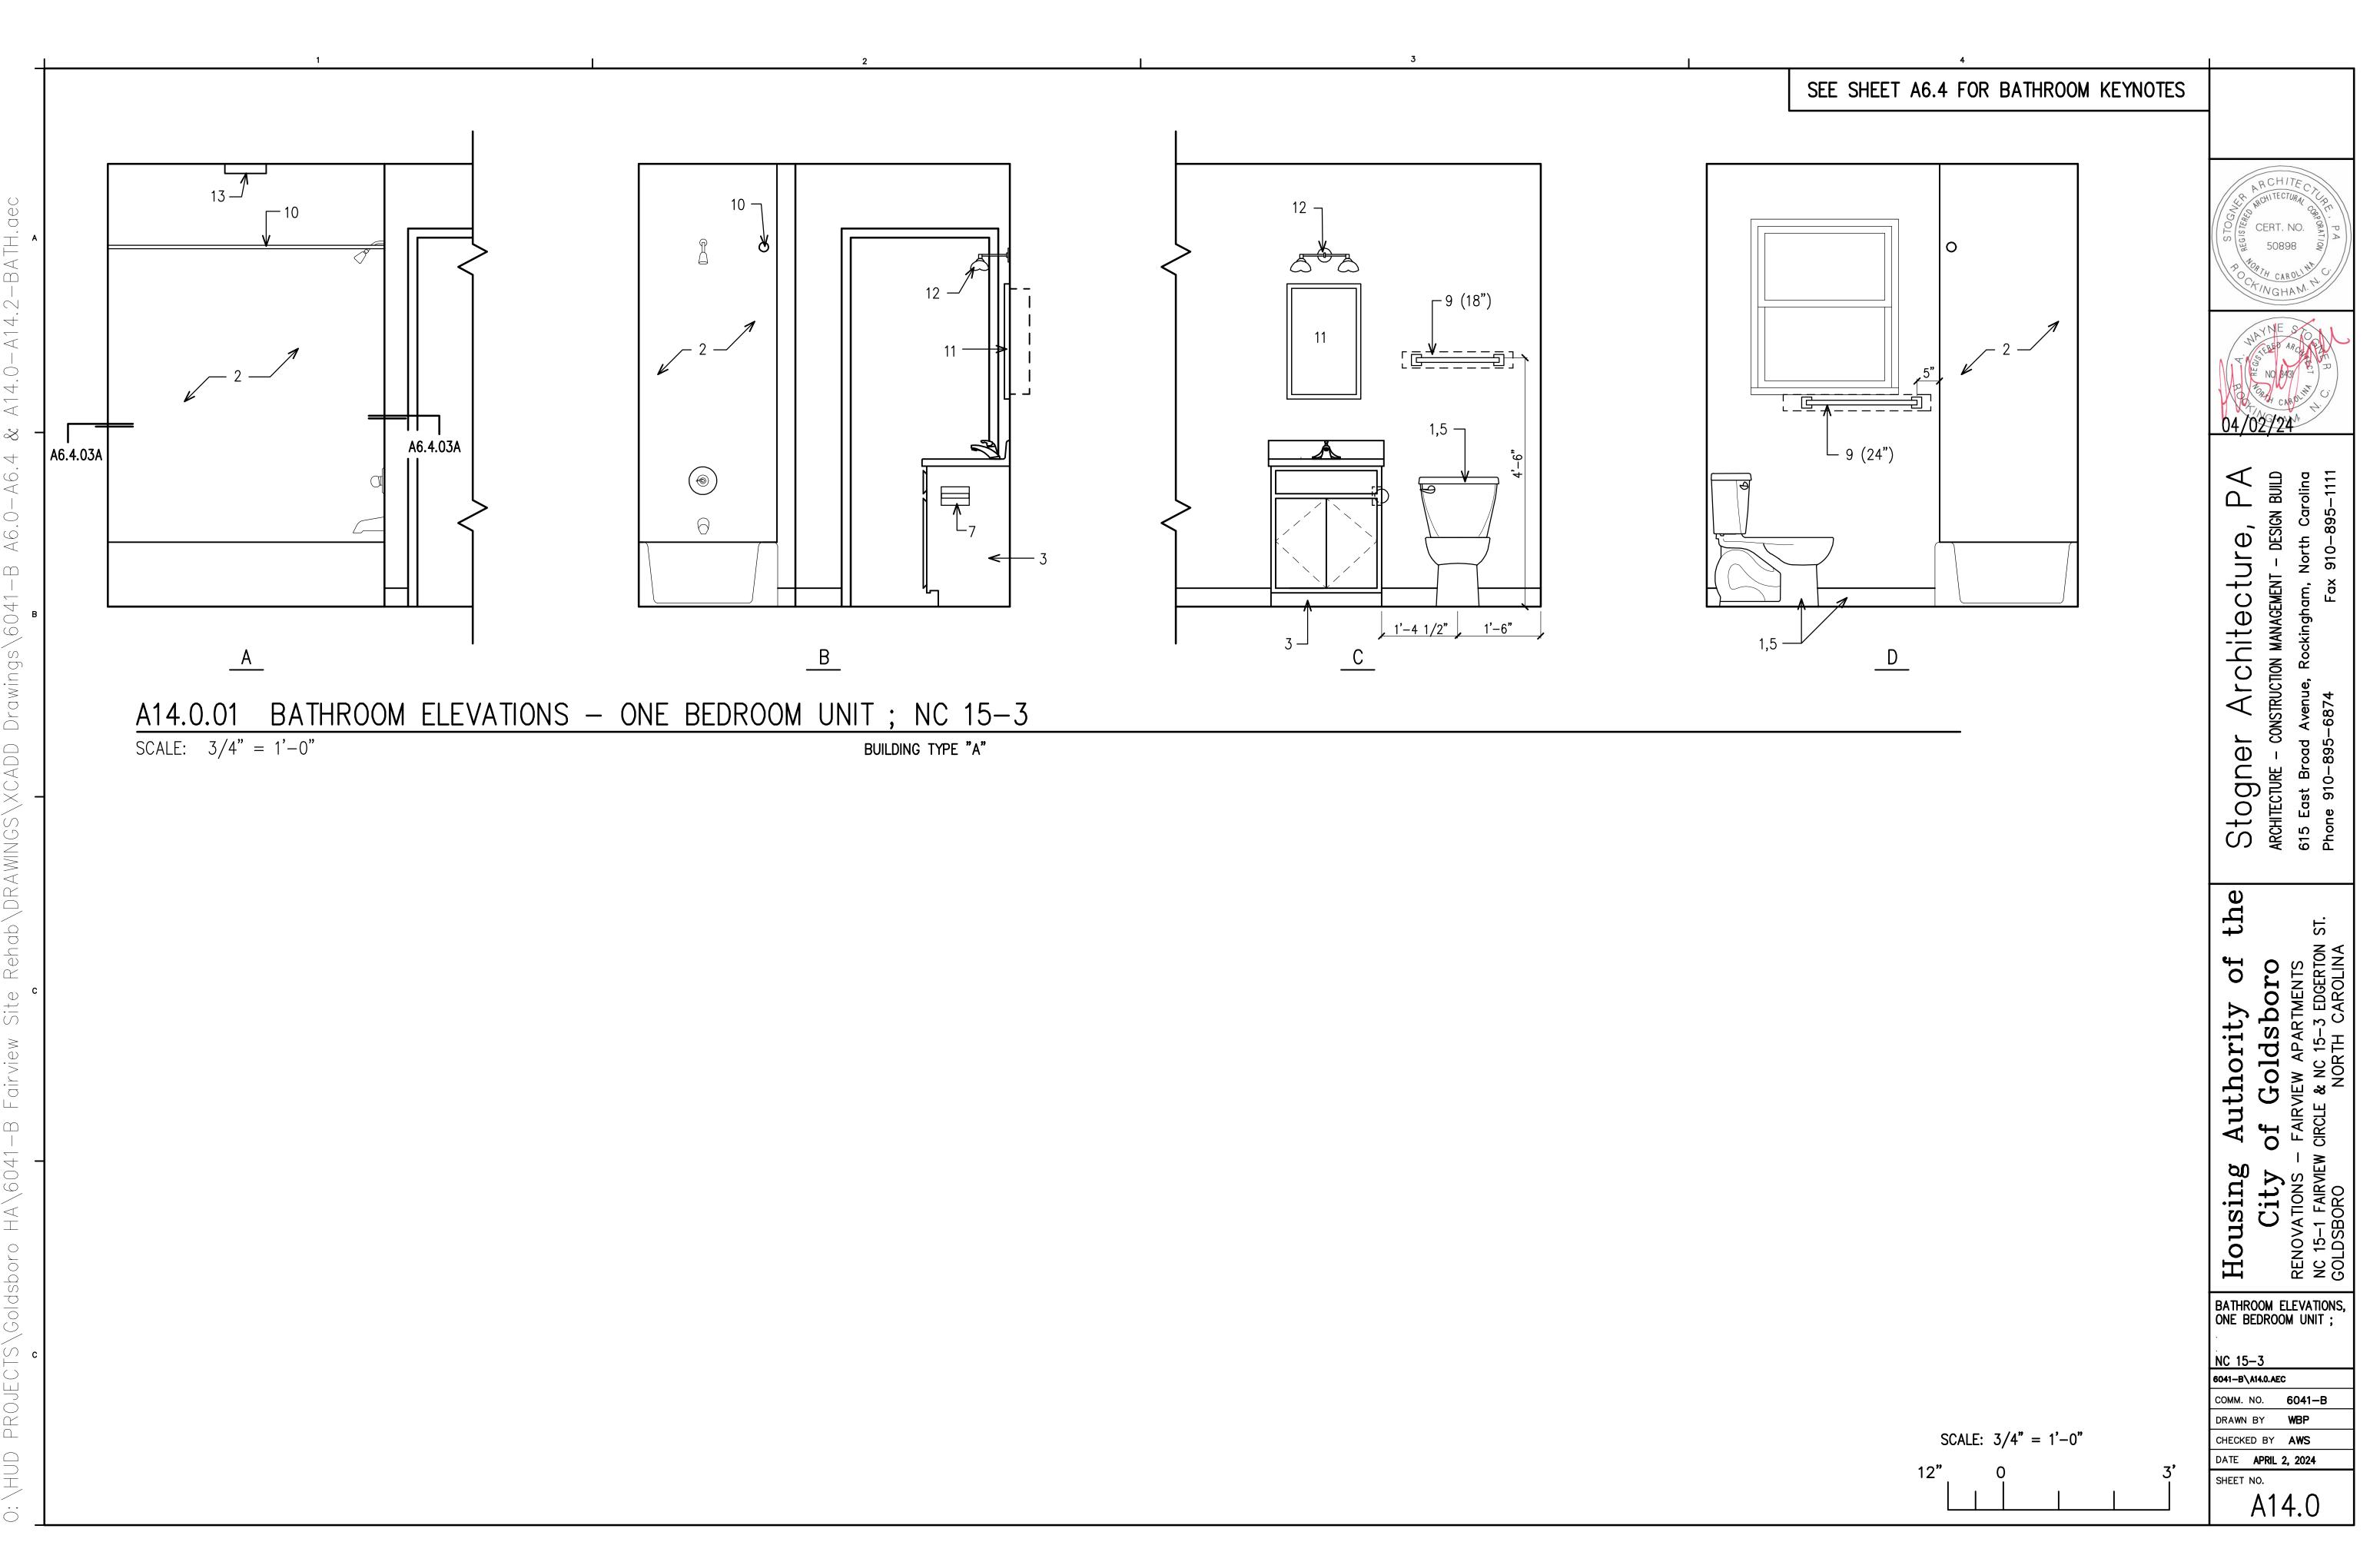

A14.2

CERT. NO.

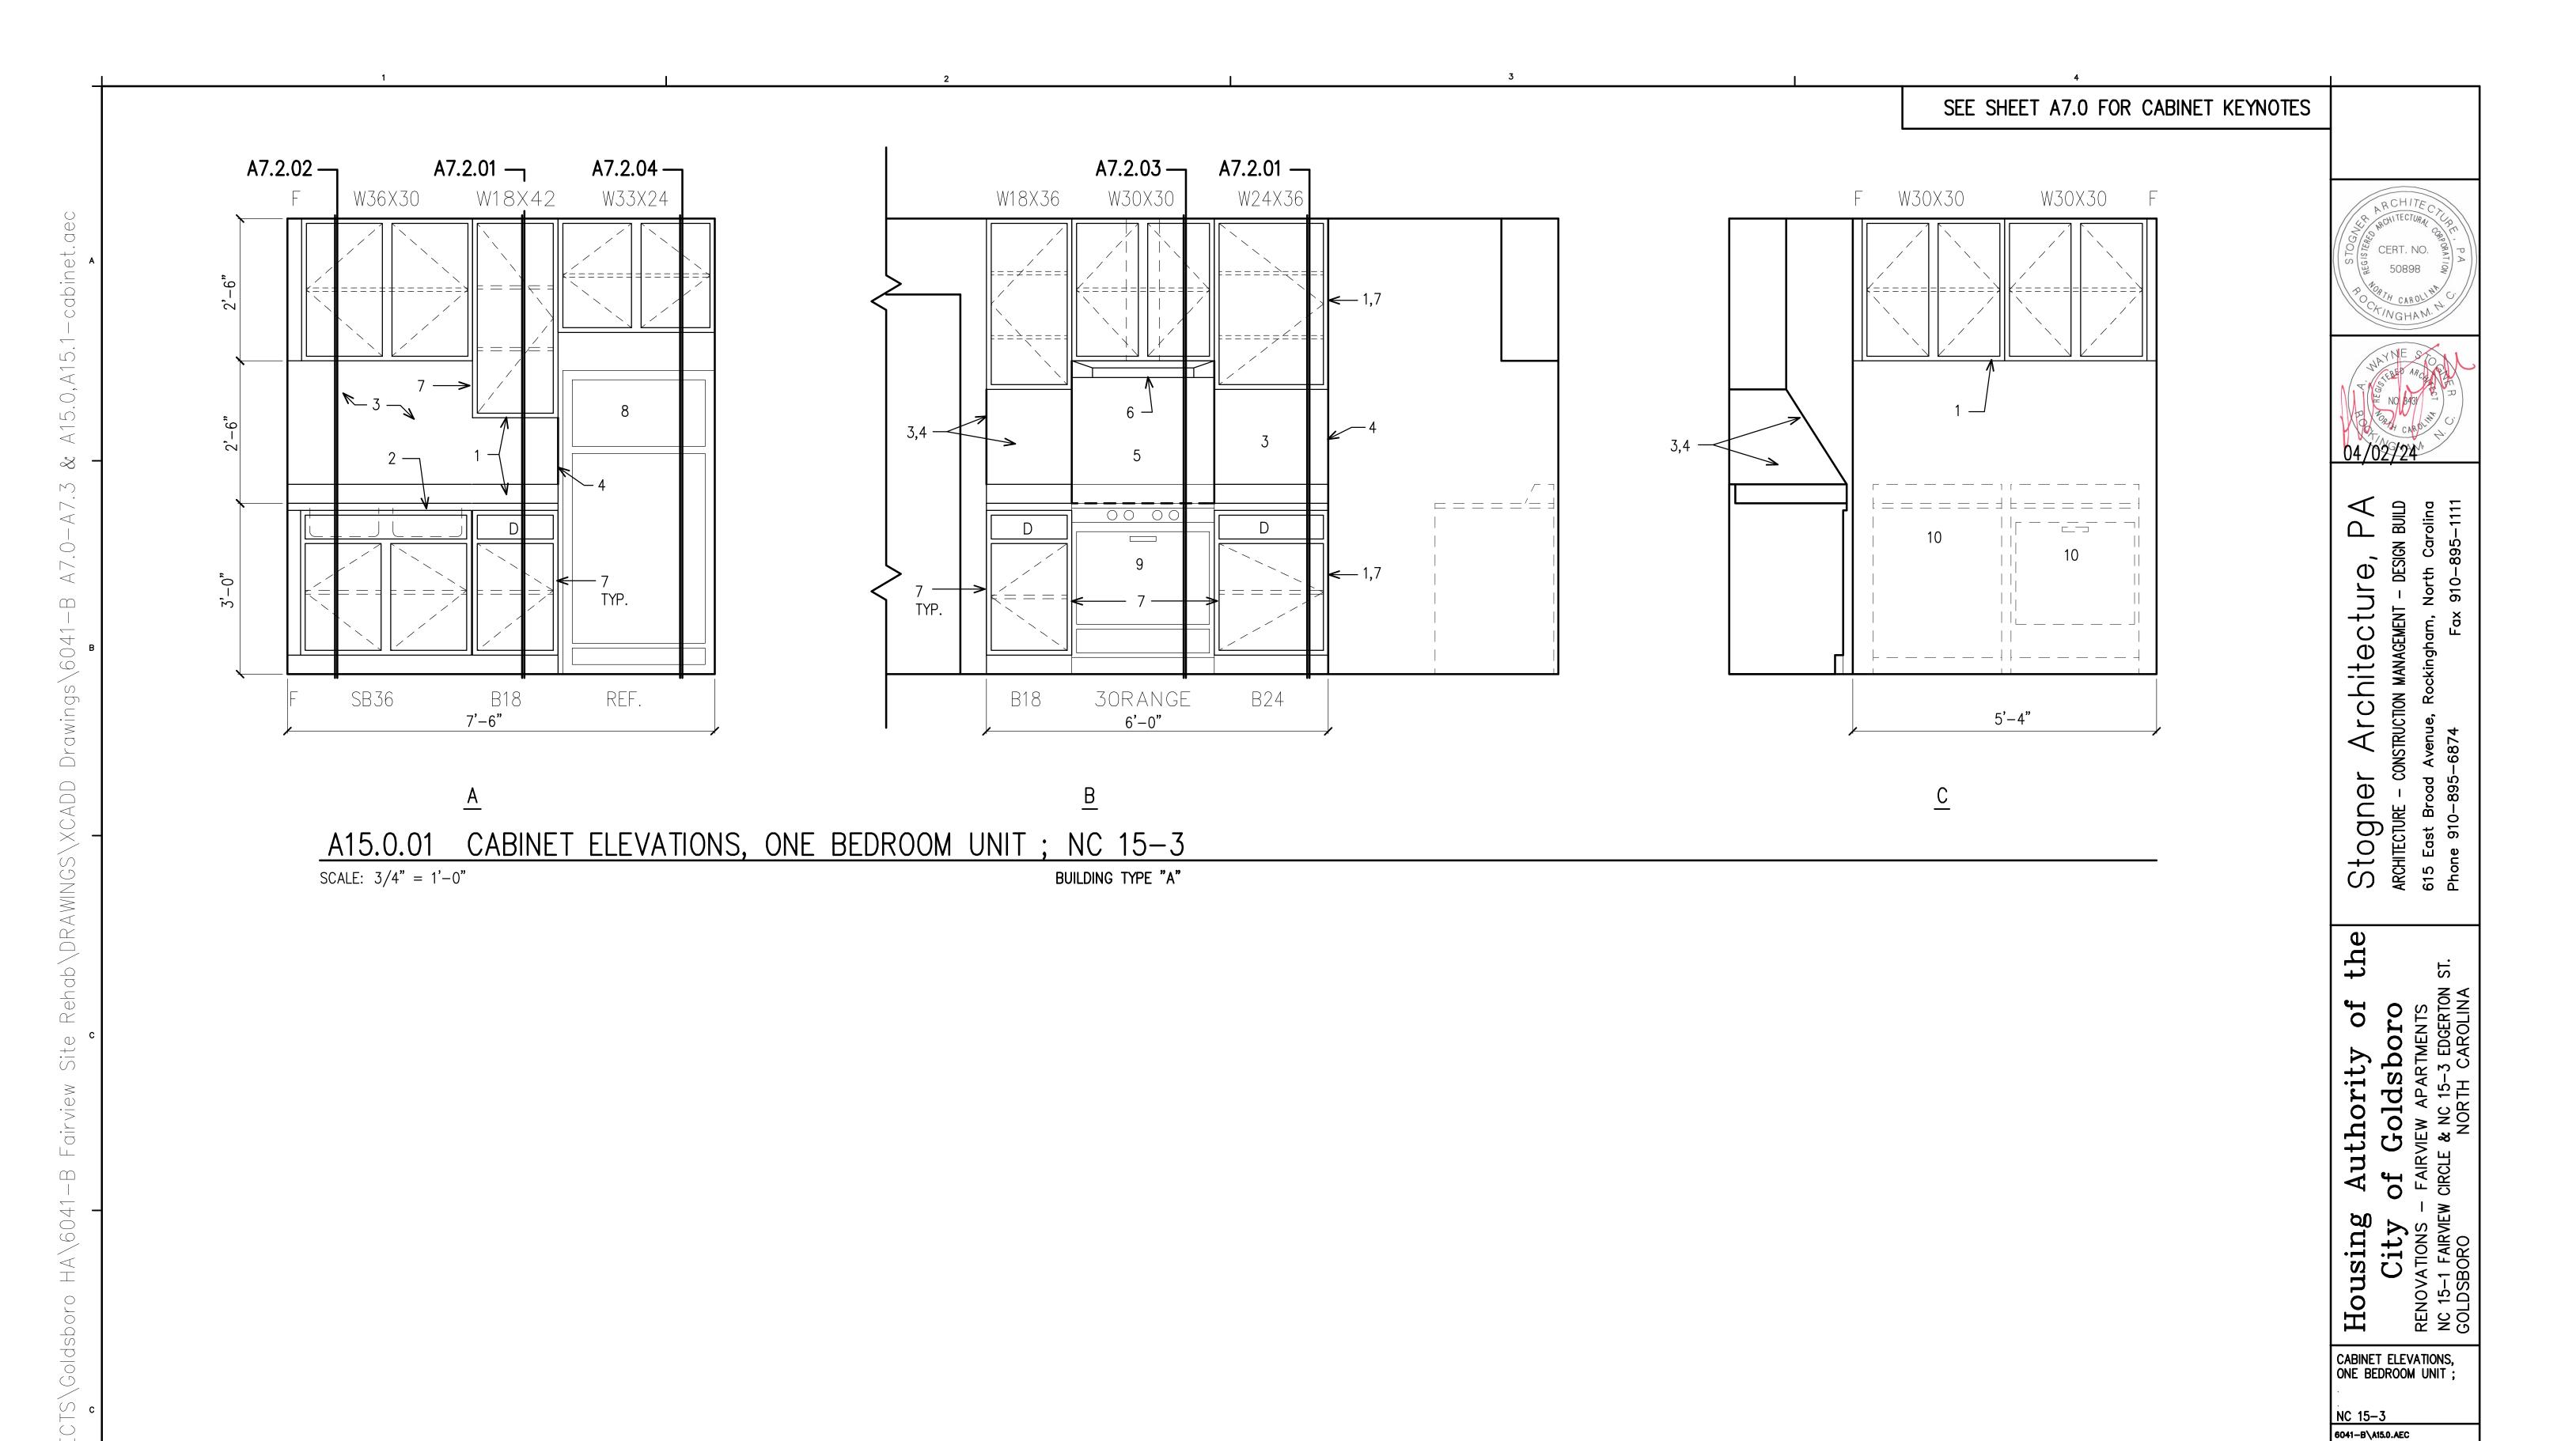

6041B BID SET DRAWINGS - Page 80 of 142

SCALE: 3/4" = 1'-0"


COMM. NO. **6041-B** 

A15.0

DRAWN BY WBP

CHECKED BY AWS
DATE APRIL 2, 2024

SHEET NO.

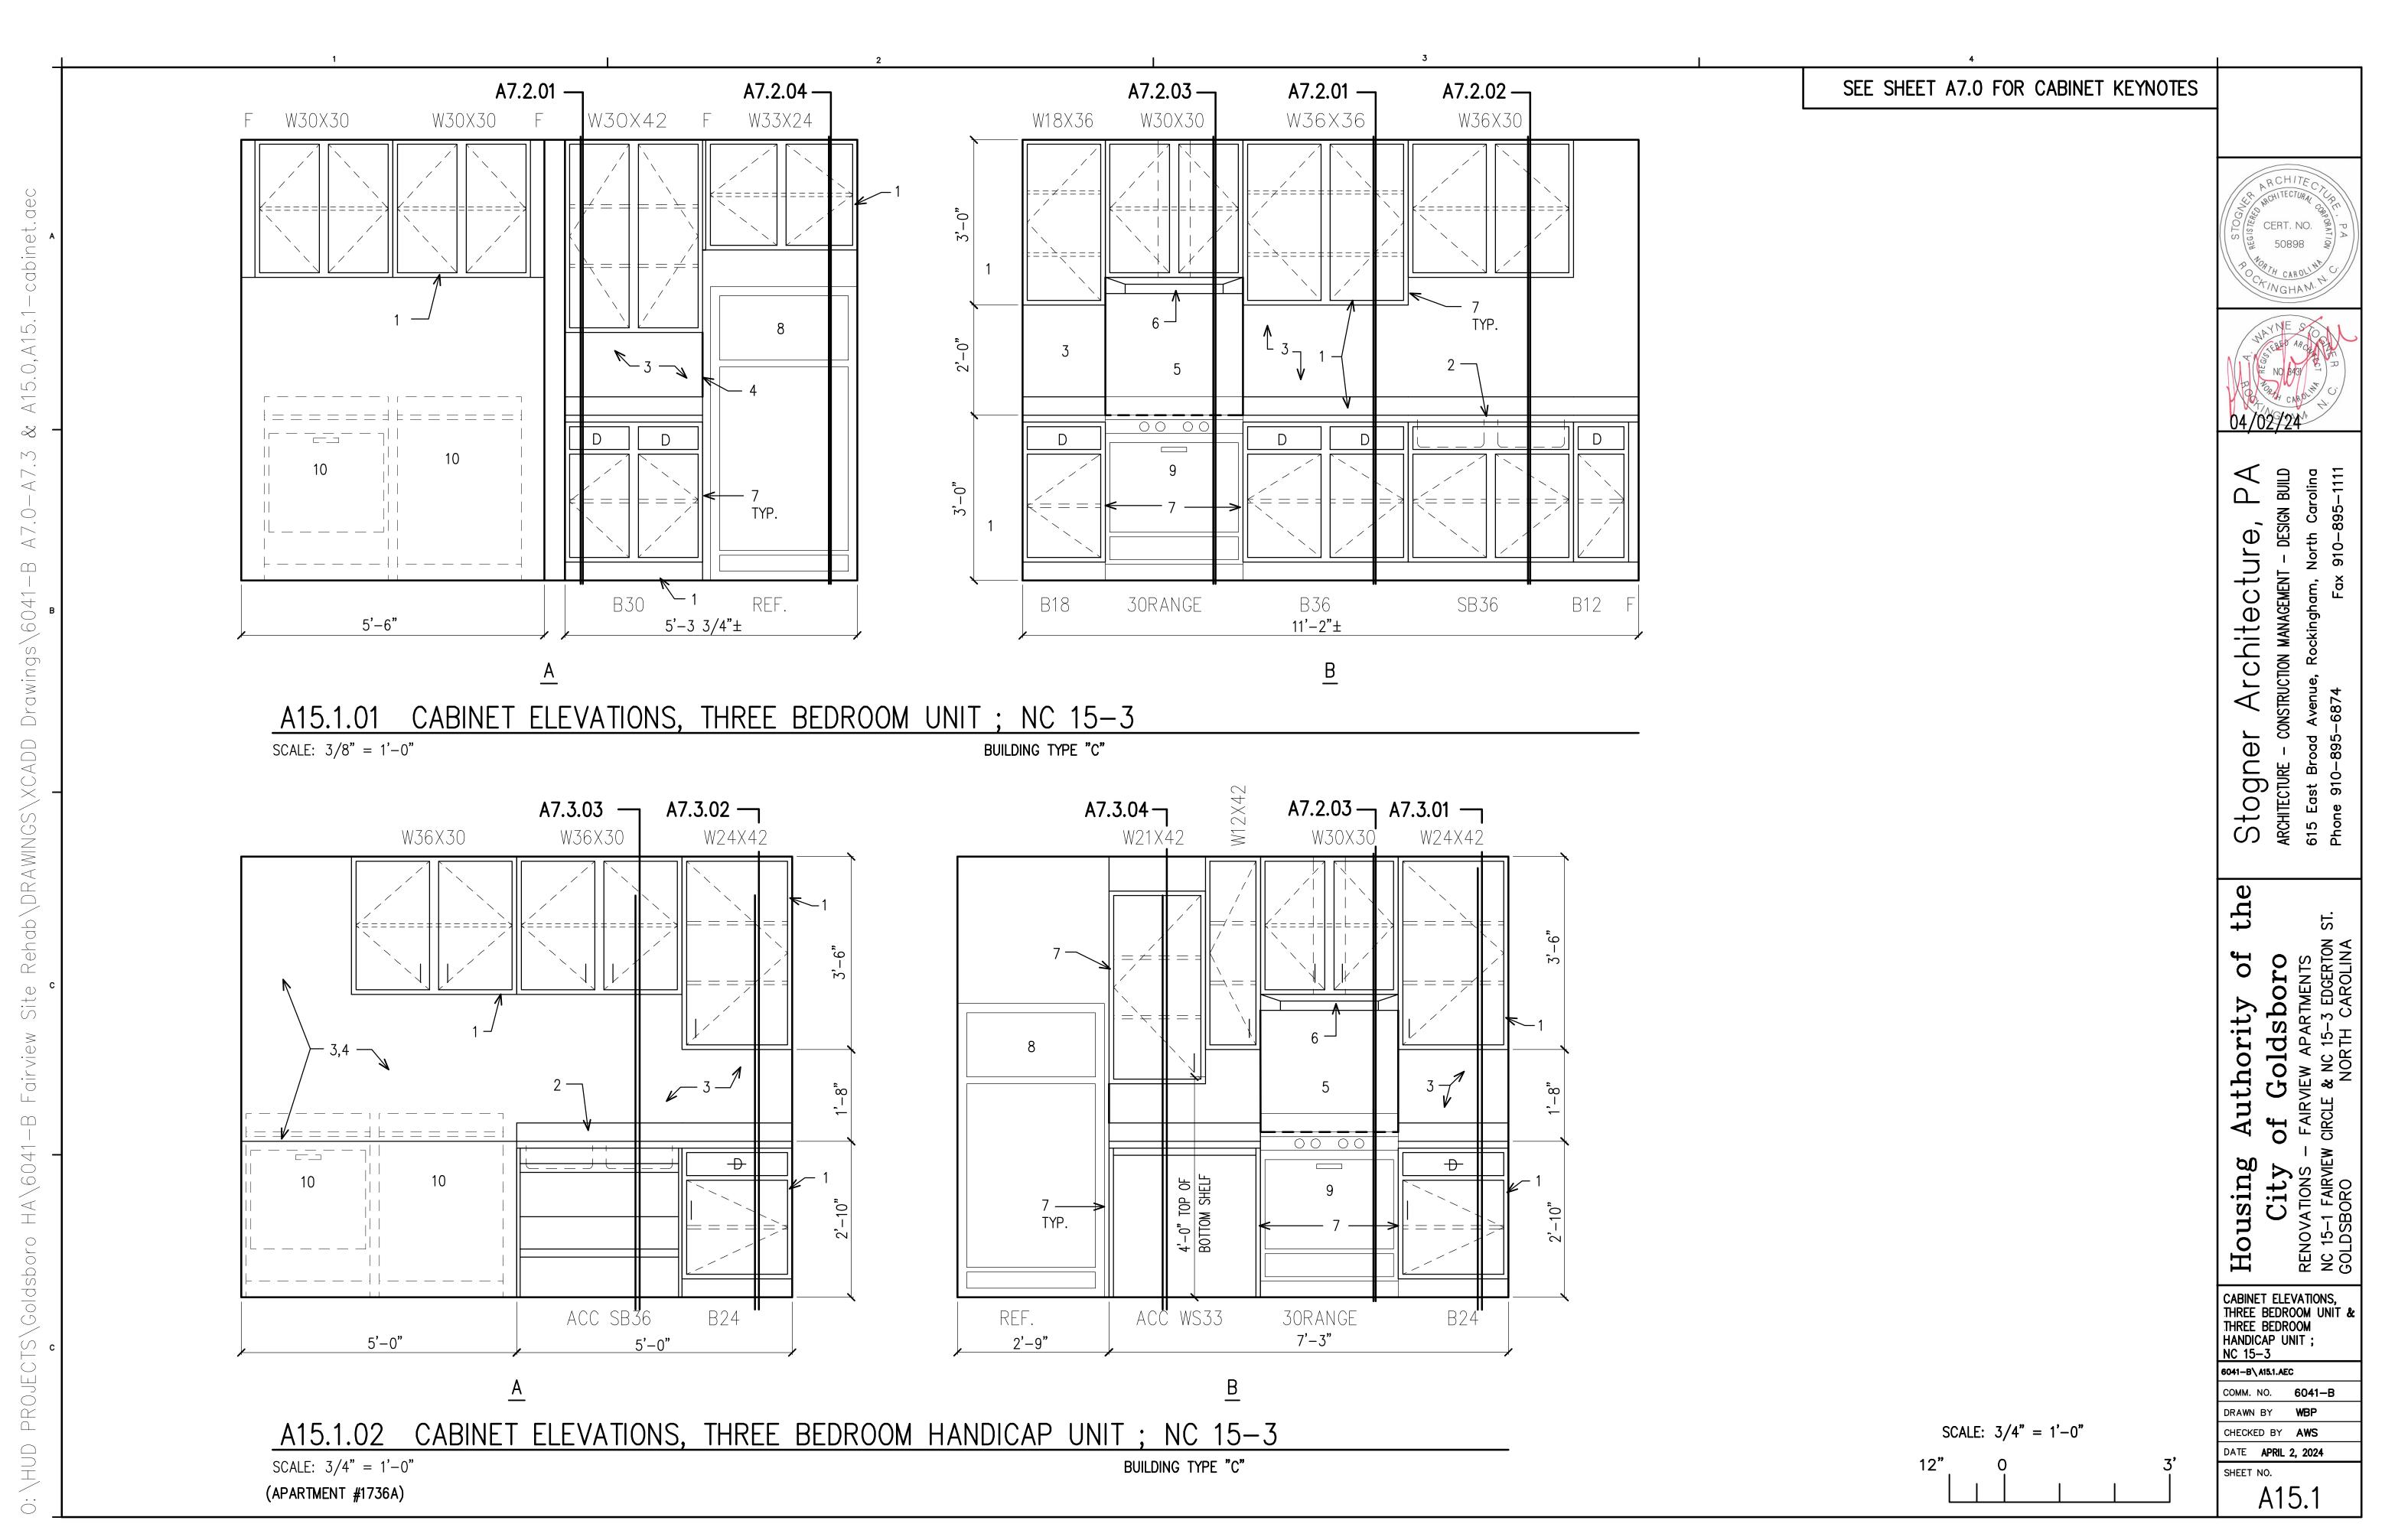

### PLUMBING GENERAL NOTES

- THE CONTRACTOR SHALL FURNISH AND INSTALL ALL MATERIAL AND EQUIPMENT IN STRICT ACCORDANCE WITH THE 2018 NORTH CAROLINA PLUMBING CODE AND ALL STATE AND LOCAL CODES, STANDARDS, AND PER MANUFACTURER'S DIRECTIONS.
- PIPING AND EQUIPMENT SUPPORTS SHALL BE DESIGNED AND INSTALLED FOR THE SEISMIC FORCES IN ACCORDANCE WITH THE NC BUILDING CODE.

### PIPING:

COLD AND HOT WATER SUPPLY

INSIDE BUILDING: SCHEDULE 40 CPVC WITH SOLVENT GLUED JOINTS. UNDERSLAB: SCHEDULE 40 CPVC WITH SOLVENT GLUED JOINTS. WASTE, VENT

INSIDE BUILDING: DWV, SCH. 40 SOLID WALL PVC PIPE WITH SOLVENT GLUED JOINTS. UNDERSLAB:

DWV, SCH. 40 SOLID WALL PVC PIPE WITH SOLVENT GLUED JOINTS.

INSULATION IS REQUIRED ON ALL ROOF DRAIN BODIES AND PIPING (ABOVE SLAB). 如 THICK RIGID MOLDED FIBERGLASS WITH FITTINGS INSERTS, PVC COVERS, AND VAPOR BARRIER JACKET.

- WATER AND WASTE PIPE SHALL BE KEPT A MINIMUM OF 5 FEET APART. WHEN PIPES CROSS OR THEY ARE CLOSER THAN 5 FEET, WATER PIPE SHALL BE 12 INCHES ABOVE CROWN OF SEWER PIPE.
- INVERT ELEVATIONS SHALL BE ESTABLISHED AND VERIFIED BEFORE WASTE PIPING IS INSTALLED SO THAT PROPER SLOPES WILL BE MAINTAINED.
- PIPING SHOULD BE COORDINATED WITH ALL STRUCTURAL FOOTINGS AND FOUNDATIONS. PIPE SHOULD BE OFFSET TO AVOID CONTACT WITH FOOTINGS AND FOUNDATION WALLS. IF PIPING MUST RUN UNDERNEATH A FOOTING OR THROUGH A FOUNDATION WALL, THE PIPE MUST BE INSTALLED WITH A RELIEVING ARCH OR IN A PIPE SLEEVE.
- ALL PLUMBING VENT LOCATIONS TO BE VERIFIED WITH ARCHITECT BEFORE INSTALLATION.
- 8. CEILING AREA HAS LIMITED SPACE. CONTRACTOR MUST COORDINATE WITH OTHER TRADES FOR ALL STRUCTURES, PIPING, CONDUIT, DUCTWORK, LIGHTING, ETC. TO PROPERLY BE INSTALLED.
- DRAWINGS AND RISERS ARE DIAGRAMMATIC AND ARE NOT INTENDED TO SHOW FITTINGS AND OFFSETS REQUIRED FOR ACTUAL INSTALLATION.
- 10. DIELECTRIC CONNECTIONS SHALL BE USED BETWEEN FERROUS AND NON-FERROUS PIPING.
- II. WATER HEATER SHALL BE FILLED WITH WATER AND PURGED AS SOON AS INSTALLED OR IN NO EVENT LATER THAN GAS/ELECTRIC HOOK-UP. FURNISH ONE YEAR MANUFACTURERS WARRANTY.
- 12. SLIP JOINTS SHALL NOT BE USED FOR DRAIN CONNECTIONS IN CONCEALED LOCATIONS. USE SOLDERED OR SCREWED JOINTS ONLY.
- 13. ALL FIXTURES SHALL BE COMPLETE AND INCLUDE ALL STOPS, SUPPLIES, VALVES, FAUCETS, DRAINS, TRAPS, TAIL PIECES, ESCUTCHEONS, ETC.
- 14. REFER TO ARCHITECTURAL DRAWINGS FOR MOUNTING HEIGHTS OF PLUMBING FIXTURES.
- 15. PROVIDE BALL VALVES IN ALL BRANCH LINES OF THE HOT AND COLD WATER DISTRIBUTION SYSTEM ON 3/ AND LARGER CW \$ HW AND AS SHOWN ON PLANS, RISERS, AND SCHEMATIC DETAILS. PROVIDE SHUT OFF VALVES ON THE FIXTURE SUPPLY TO EACH PLUMBING FIXTURE, APPLIANCE, OR MECHANICAL EQUIPMENT.
- 16. PROVIDE DRAIN VALVES IN THE HOT AND COLD WATER SYSTEM AT ALL LOW POINTS TO ALLOW FOR COMPLETE DRAINAGE. PROVIDE SHUT-OFF VALVES AT THE BASE OF ALL STACKS.
- 17. PROVIDE ACCESS DOORS FOR ALL VALVES AND DEVICES REQUIRING ACCESS WHEN LOCATED IN WALLS OR ABOVE INACCESSIBLE CEILING CONSTRUCTION. ACCESS DOORS TO BE RATED WHERE INSTALLED IN RATED ASSEMBLIES.
- 18. ALL HUB DRAINS MUST BE IN ACCESSIBLE AND VENTED LOCATIONS.
- 19. CLEANOUT PLUGS SHALL BE INSTALLED IN ACCORDANCE WITH PLUMBING CODE REQUIREMENTS. PROVIDE CLEANOUTS AT THE BASE OF ALL WASTE STACKS, AT EVERY FOUR 45 DEGREE TURNS, AND AT EVERY 100 FEET. CLEANOUTS SHALL BE PLACED IN READILY ACCESSIBLE LOCATIONS.
- 20. ALL PIPING SHALL BE TESTED IN ACCORDANCE WITH INDUSTRY STANDARDS AND DOMESTIC WATER SHALL BE STERILIZED IN COMPLIANCE WITH CITY STANDARDS.
- 21. ALL PIPING SHALL BE RUN IN AREAS NOT SUBJECT TO FREEZING TEMPERATURES. PIPING IN EXTERIOR WALLS SHALL BE INSULATED AND RUN ON THE CONDITIONED SIDE OF THE WALL INSULATION. IF ROUTED IN UNCONDITIONED AREAS PIPING MUST BE INSULATED WITH A MINIMUM OF R-6.5. ALL PIPE INSULATION SHALL RUN CONTINUOUSLY THROUGH FLOORS, WALLS, AND PARTITIONS.
- 22. PIPE PENETRATIONS OF RATED WALLS SHALL BE FIRE STOPPED AS NECESSARY TO MAINTAIN THE RATING OF THE WALL.
- 23. VENT PIPES SHALL BE ROUTED THROUGH ROOF PER UNIT STACK TO REDUCE ROOF PENETRATIONS.
- 24. PROVIDE PRESSURE REDUCING VALVE AT ALL BUILDINGS WHERE PRESSURE EXCEEDS 80 PSI.

P	LUMBING LEGEND
	DOMESTIC COLD LIATED DIDING
	DOMESTIC COLD WATER PIPING
	DOMESTIC COLD WATER PIPING (UNDRSLAB)
	DOMESTIC HOT WATER PIPING
	VENT PIPING
	WASTE (SANITARY SEWER)
——  <b>—</b>	BALL VALVE
	CHECK VALVE
<b></b>	PIPE UP
<del></del>	PIPE DOWN
AAV	AIR ADMITTANCE VALVE
	ABOVE
	ABOVE FINISHED FLOOR
	BALANCING VALVE
	COLD WATER
<del>-</del> · ·	DOWN
E.C.	
	FLOOR CLEAN OUT
FD FR	FLOOR DRAIN FROM
	FLOOR SINK
	GENERAL CONTRACTOR
HB	
HD	HUB DRAIN
HW	HOT WATER
M.C.	
	PLUMBING SUB-CONTRACTOR
SD	STORM DRAINAGE
٧	VENT
М	WASTE

<b>Drawing Sheet List</b>
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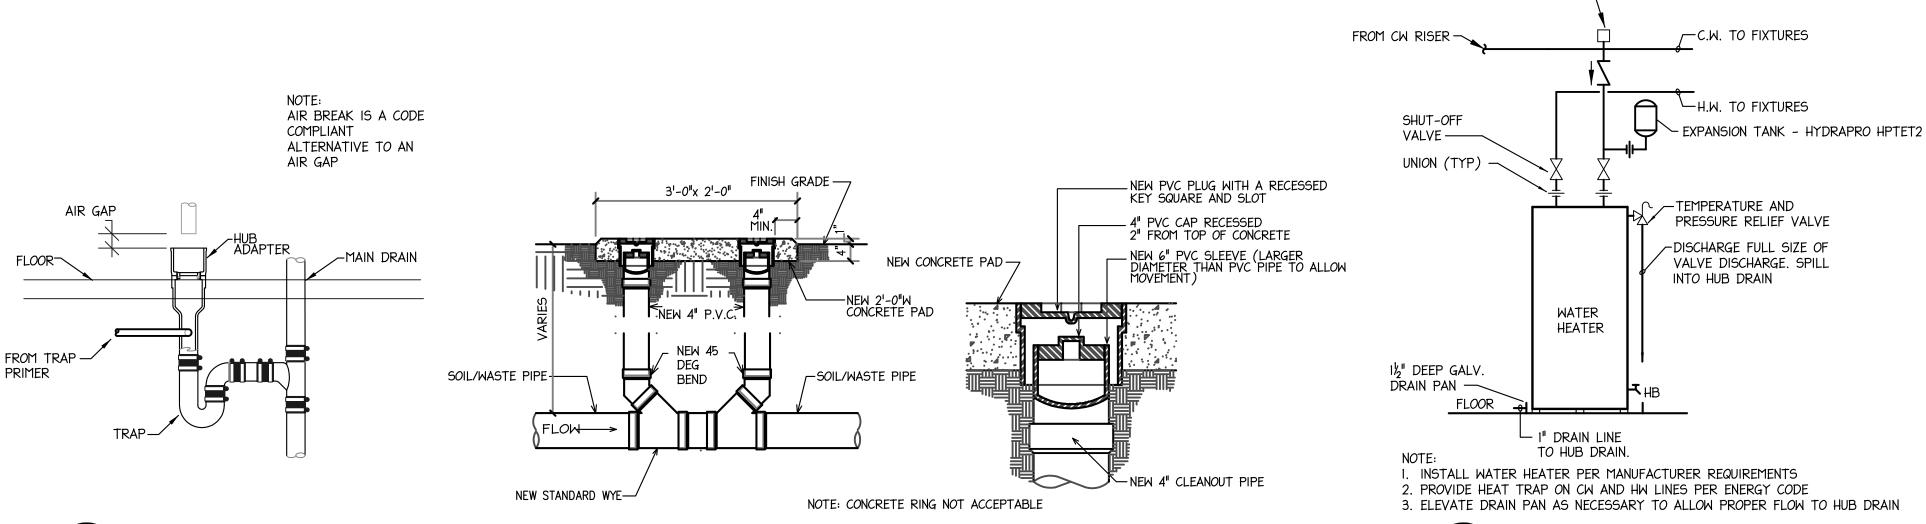
	<u> </u>
#	Title
P0.0	PLUMBING NOTES, LEGEND, AND SCHEDULE
P1.0	PLUMBING BUILDING 1 PLANS NC 15-1
P1.1	PLUMBING BUILDING 2 & 3 PLANS NC 15-1
P1.2	PLUMBING BUILDING 4 & 5 PLANS NC 15-1
P1.3	PLUMBING BUILDING 6 & 7 PLANS NC 15-1
P1.4	PLUMBING BUILDING 8 & 9 PLANS NC 15-1
P1.5	PLUMBING BUILDING 14 PLANS NC 15-1
P1.6	PLUMBING BUILDING 15 PLANS NC 15-1
P2.0	PLUMBING UNIT PLANS NC 15-1
P2.1	PLUMBING UNIT PLANS NC 15-1
P3.0	PLUMBING UNIT PLANS NC 15-1
P3.1	PLUMBING UNIT PLANS NC 15-1
P4.0	PLUMBING UNIT PLANS NC 15-1
P4.1	PLUMBING UNIT PLANS NC 15-1
P10.0	PLUMBING BUILDING C & C-A PLANS NC 15-3
P11.0	PLUMBING UNIT PLANS NC 15-3
P12.0	PLUMBING UNIT PLANS NC 15-3
P12.1	PLUMBING UNIT PLANS NC 15-3

FLOOR-

PRIMER

					PLUMBIN	G FIXTUF	RE SPECIFI	CATIONS	S AND	CONN	IECTIC	N S	CHEDUL	E					
MARK	FIXTURE	TYPE	MANUFACTURER	MODEL NO.	MATERIAL	STYLE	MANUTACT	FAUCET/VALV	E	1	DRA	IN	SUPPLIES		PIPE S	IZES		MOUNTING	REMARKS
IIAKK	TIAN TIATORE TITLE TIANOTACTORER		TIODEL NO.	IIAILKIAL	JIILL	MANUFACT. MODEL NO.	SPOUT	HANDLES	CENTERS	TYPE	SIZE	AND STOPS	WASTE	WASTE VENT CW HW		TIOUNTING	NLI IANA		
P-I	WATER CLOSET	FLUSH TANK	AMERICAN STANDARD	2I5AA.I04	VITREOUS CHINA	RIGHT HEIGHT	-	-	-	_	-	-	McGUIRE 185	3"	2"	ارا 2	-	FL00R	PROVIDE WITH CLOSED FRONT SEAT WITH LID 5257A.65MT I.28 GPF, WATERSENSE
P-IA	WATER CLOSET	FLUSH TANK	AMERICAN STANDARD	2I5AA.I04	VITREOUS CHINA	ADA ELONGATED	-	-	-	-	-	-	McGUIRE 185	3"	2"	½"	-	FL00R	PROVIDE WITH CLOSED FRONT SEAT WITH LID 5257A.65MT I.28 GPF, WATERSENSE
P-2	LAVAT <i>O</i> RY	SINGLE COMP'T	SWANSTONE	VTIBI925	SWANSTONE	ADA OVAL	CFG 794CZ2	CENTERSET	SINGLE LEVER	4"	POP-UP	1½"	McGUIRE 175	2"	1½"	<u>у</u> "	1/2"	COUNTER TOP	MOUNT AT ADA HEIGHT
P-2A	LAVAT <i>O</i> RY	SINGLE COMP'T	SWANSTONE	VTIB2237	SWANST <i>O</i> NE	ADA COMPLIANT	CFG 794CZ2	CENTERSET	SINGLE LEVER	4"	GRID	1½"	McGUIRE 175	2"	1½"	½"	1/2"	COUNTER TOP	MOUNT AT ADA HEIGHT
P-3	BATHTUB SHOWER	PREFAB	AMERICAN STANDARD	2390.202/2391.202	PORCELAIN	STANDARD 60" x 30"	CFG 40311CBN/45312	-	SINGLE LEVER	-	INTEGRAL	2"	-	2"	1½"	½" 2	ا <sub>گ</sub> ا"	FL00R	PRESSURE BALANCE VALVE, SHOWER HEAD, ARM, FLANGE, DIVERTER, & TUB SPOUT.
P-3A	BATHTUB SHOWER	PREFAB	AMERICAN STANDARD	2390.202/2391.202	PORCELAIN	ADA 60" x 30"	MOEN T8342CBN CFG 45312	-	SINGLE LEVER	-	INTEGRAL	2"	-	2"	1½"	½"	1/2"	FL00R	SEE NOTE #2
P-4	KITCHEN SINK	DOUBLE COMP'T	DAYTON	LR332I	STAINLESS STEEL	7%" DEEP 3-HOLE	CFG 7425SRS	8" SWING	SINGLE LEVER	8"	CRUMB CUP	1½"	McGUIRE 165	1½"	1½"	у II 2	1/2"	COUNTER TOP	
P-4A	KITCHEN SINK	DOUBLE COMP'T	DAYTON	GE233213	STAINLESS STEEL	5¾" DEEP 3-HOLE HANDICAPPED	CFG 7425SRS	8" SWING	SINGLE LEVER	8"	CRUMB CUP	1½"	McGUIRE 165	1½"	1½"	<u>ነ</u> "	ا <sub>ل</sub> ا ا	COUNTER TOP	
P-5	WASHER	BOTTOM	SPECIALTY	<i>O</i> B-351	PVC	RECESSED	_	_	_	_		_	_	211	11/11	1/ 11	ا <sub>2</sub> "	WALL	SHUT-OFF VALVES \$ HOSE
P-9	WALL BOX	SUPPLY	PRODUCTS	OBFS-2020	FIRE-RESISTANT	BOX	_		_	_	_	-		3"	1½"	½"	/2	MALL	CONNECTION FOR WASTE. PROVIDE F.R. MODEL WHEN IN RATED WALL
P-6	ROLL-IN SHOWER	PREFAB	MUSTEE	360	FIBERGLASS	BARRIER FREE 60" x 30"	MOEN T8342CBN CFG 45312	-	SINGLE LEVER	-	INTEGRAL	2"	-	2"	1½"	<u>ነ</u> "	1/2"	FL00R	SEE NOTE #2
WH-I	WATER HEATER	ELECTRIC	RHEEM	PROE40 T2 RH95	GLASS LINED	TALL	-	-	-	-	-	-	-	-	-	3y II 4	3/ II 4	FL00R	40 GALLONS, HEATING ELEMENT LISTED FOR 4.5KW @ 240V, IØ PROVIDE DRAIN PAN
FPHB	HOSE BIBB	FREEZE PROOF	WOODFORD	25	CAST BRASS	WALL FAUCET	-	-	-	_	-	-	-	-	-	<i>y</i> <sub>2</sub> "	-	WALL	
DGCO	DBL GRADE CLEAN-OUT	ROUND TOP	J.R. SMITH	4240	CAST IRON	CAST IRON TOP	-	-	-	-	-	-	-	-	-	1	-	GRADE	PROVIDE WITH 24"x24"x8" THK CONCRETE PAD AT GRADE.

- I. CATALOG NUMBERS AND MANUFACTURERS ARE TO INDICATE TYPE AND QUALITY OF FIXTURE DESIRED. SUBMIT CUTSHEETS OF THESE AND ALTERNATE MANUFACTURERS FOR ARCHITECT AND OWNER APPROVAL PRIOR TO PURCHASE OF ANY FIXTURES. INFORMATION ON ALTERNATE FIXTURES PROPOSED BY THE CONTRACTOR SHALL INCLUDE THE ADD/DEDUCT ASSOCIATED WITH ACCEPTANCE OF THAT FIXTURE (OR THE ALTERNATE PACKAGE AS A WHOLE).
- 2. SEAT, GRAB BAR, PRESS. BAL. VALVE, DIVERTER, HAND SPRAY, HOSE, SLIDE BAR, & DRAIN. CONFIRM ORENTATION OF TUBS AND SHOWERS PRIOR TO INSTALLATION. PROVIDE WITH SWANSTONE SURROUND SK-366296.




HUB DRAIN DETAIL

EXTERIOR DOUBLE CLEANOUT DETAIL

WATER HEATER DETAIL NO SCALE

VACUUM BREAKER

LIGHTHOUSE ENGINEERING,PA No. C-2714

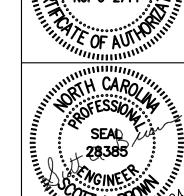

• —  $\bigcirc$ S-ARCHARCH B15

oro 0 Authority of Goldsbc

0fHousing

PLUMBING NOTES, LEGEND, AND SCHEDULE COMM. NO.: 6041-B

CHECKED BY: SAB DATE: APR. 2, 2024 SHEET NO.

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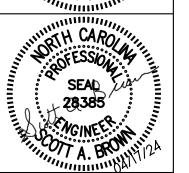
2 4"W TO EXISTING WASTE LINE AT 5' FROM BUILDING. FIELD VERIFY LOCATION OF EXISTING WASTE LINE PRIOR TO CONNECTION.

3 3/CW FR EXISTING WATER LINE AT 5' FROM BUILDING. FIELD VERIFY LOCATION OF EXISTING WATER LINE PRIOR TO CONNECTION. PROVIDE WATER SUPPLY SHUT-OFF IN ACCESSIBLE BOX.

4 COORDINATE WITH OWNERSHIP/GC FOR DEMOLITION OF EXISTING WATER MANIFOLD.







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Authority of of Goldsboro


Housing City PLUMBING BUILDING 1 PLANS NC 15-1

COMM. NO.: 6041-B

DRAWN BY: CHECKED BY: SAB DATE: APR. 2, 2024


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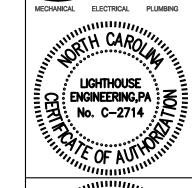
6041B BID SET DRAWINGS - Page 83 of 142

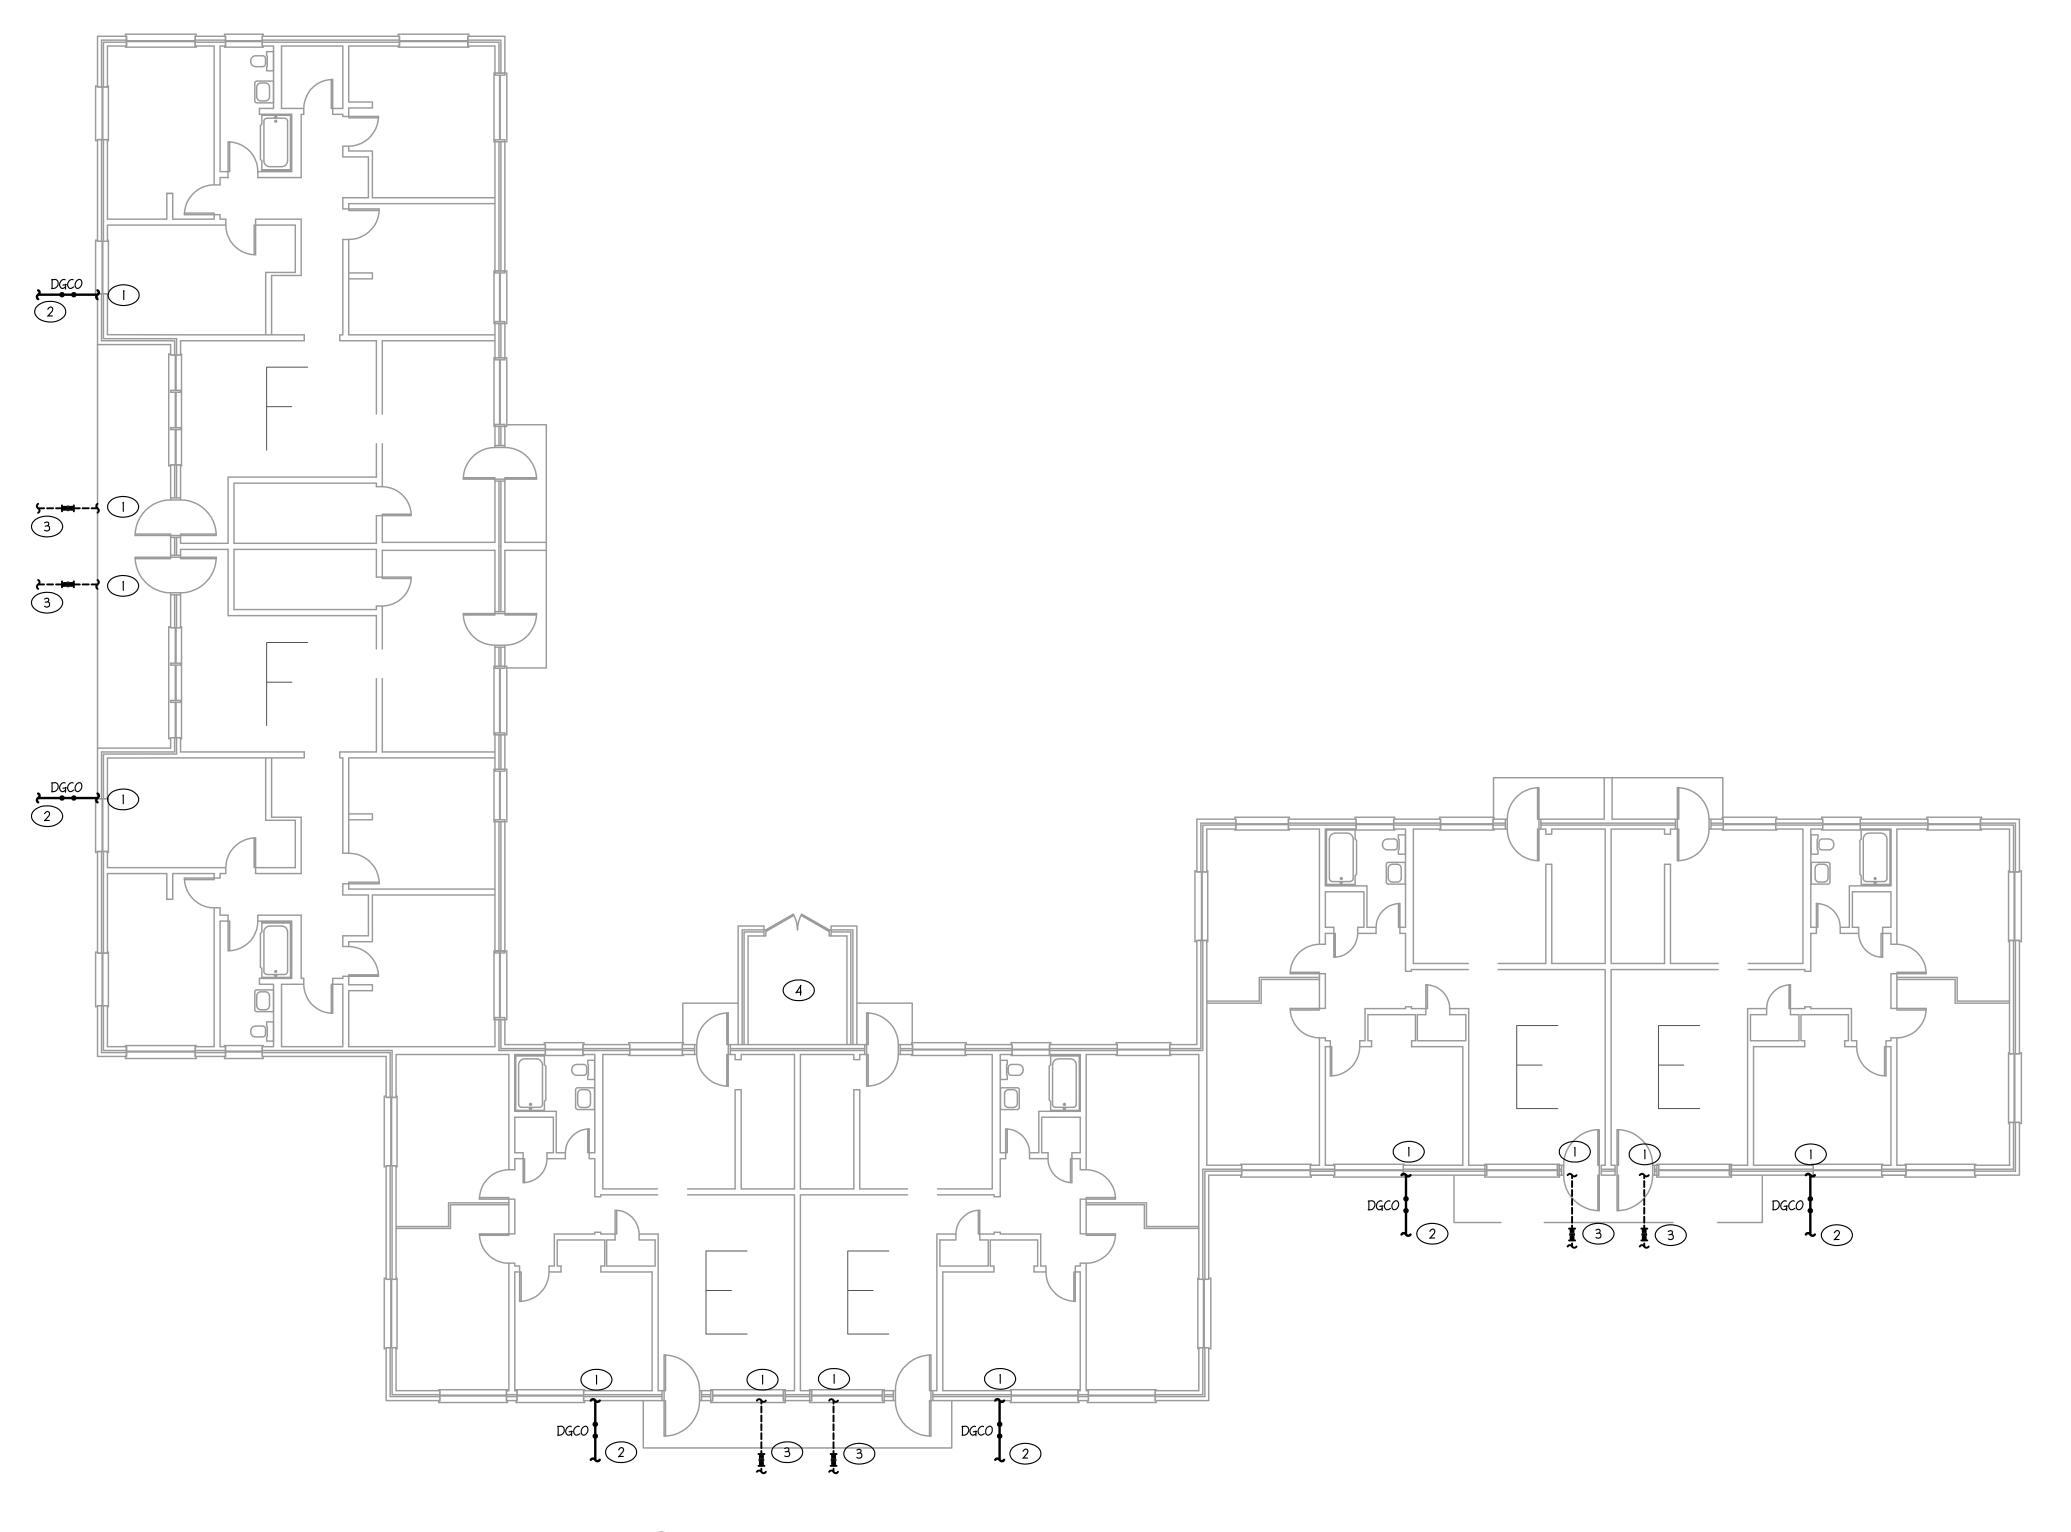


## TAGGED NOTES - THIS SHEET

- REFER TO PLUMBING UNIT PLANS FOR CONTINUATION.
- 2 4"W TO EXISTING WASTE LINE AT 5' FROM BUILDING. FIELD VERIFY LOCATION OF EXISTING WASTE LINE PRIOR TO CONNECTION.
- 3 3/CW FR EXISTING WATER LINE AT 5' FROM BUILDING. FIELD VERIFY LOCATION OF EXISTING WATER LINE PRIOR TO CONNECTION. PROVIDE WATER SUPPLY SHUT-OFF IN ACCESSIBLE BOX.
- 4 COORDINATE WITH OWNERSHIP/GC FOR DEMOLITION OF EXISTING WATER MANIFOLD.



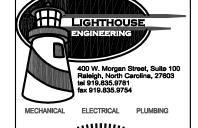

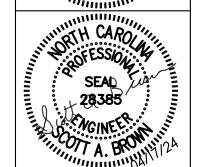

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Authority of of Goldsboro Housing City

PLUMBING BUILDING 2 & 3 PLANS NC 15-1

COMM. NO.: 6041-B DRAWN BY: CHECKED BY: SAB DATE: APR. 2, 2024

SHEET NO.

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4 DGCO DGCO 3 12 1 3 BUILDING 3 - NC 15-1


1/8"=1'-0" FAIRVIEW CIRCLE DGC0 DGCO 2 3 3

6041B BID SET DRAWINGS - Page 84 of 142°


2 4"W TO EXISTING WASTE LINE AT 5' FROM BUILDING. FIELD VERIFY LOCATION OF EXISTING WASTE LINE PRIOR TO CONNECTION.

3 3/CW FR EXISTING WATER LINE AT 5' FROM BUILDING. FIELD VERIFY LOCATION OF EXISTING WATER LINE PRIOR TO CONNECTION. PROVIDE WATER SUPPLY SHUT-OFF IN ACCESSIBLE BOX.


4) COORDINATE WITH OWNERSHIP/GC FOR DEMOLITION OF EXISTING WATER MANIFOLD.

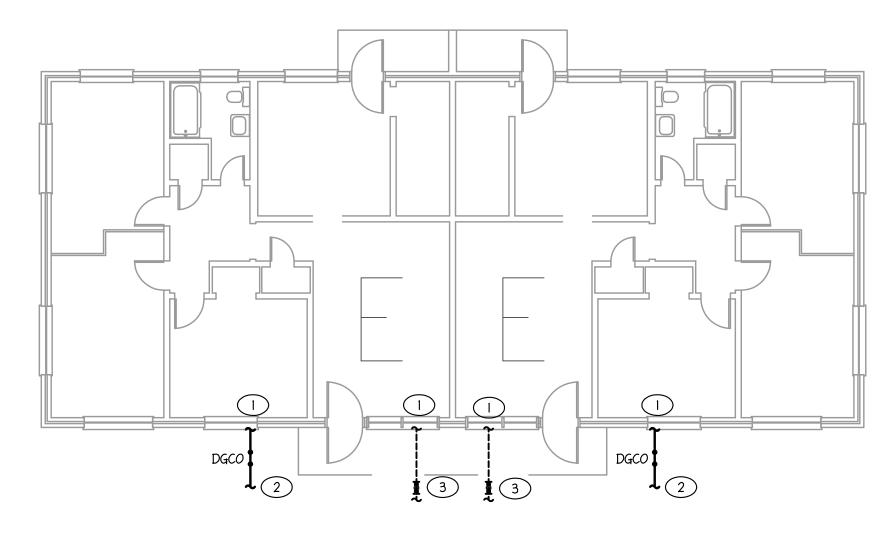


BUILDING 4 - NC 15-1 1/8"=1'-0" FAIRVIEW CIRCLE

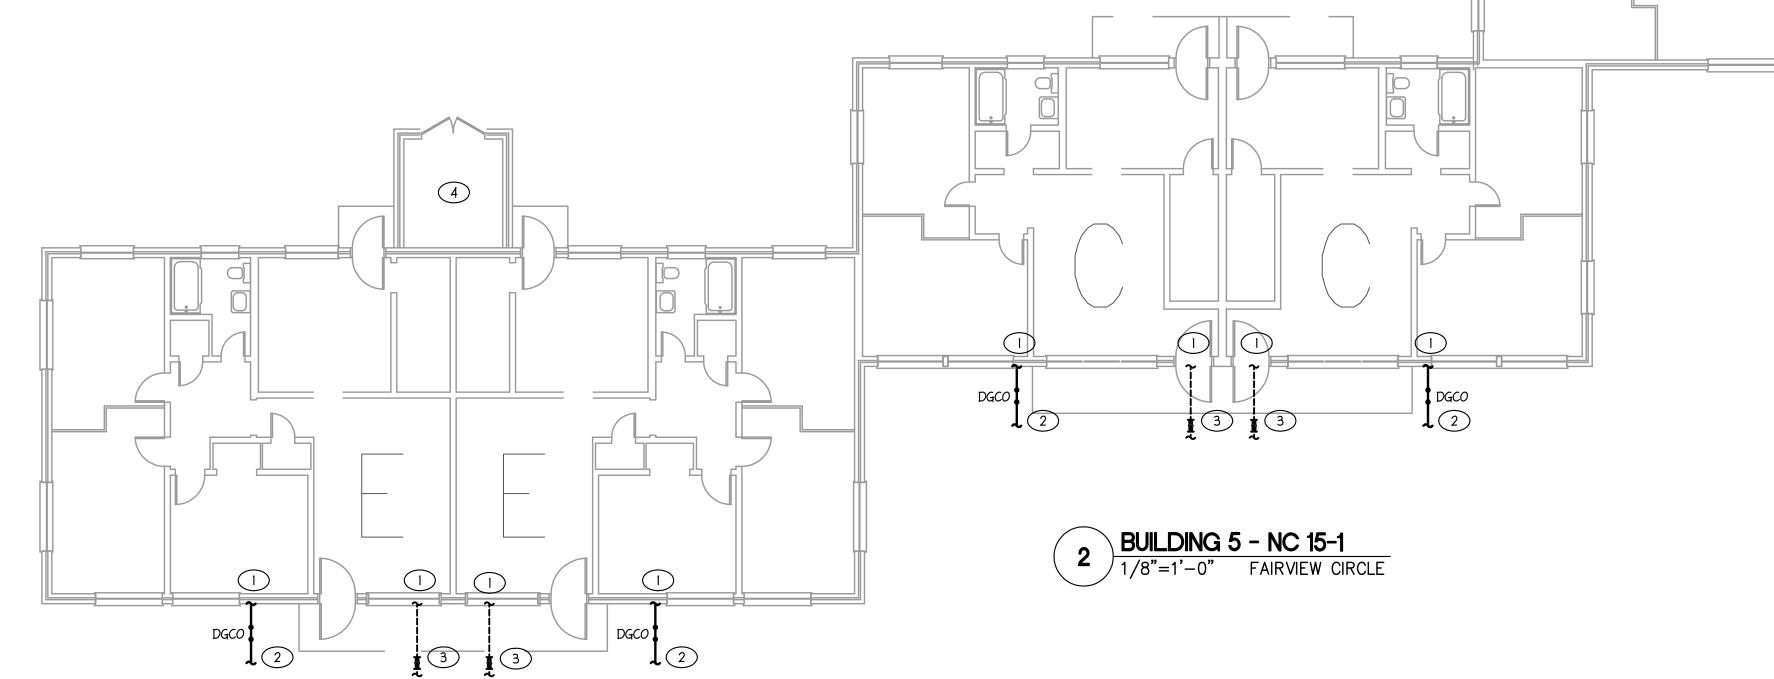



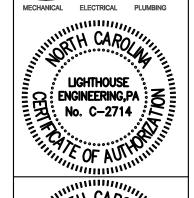

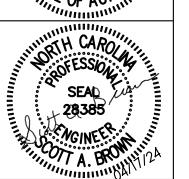

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Housing City PLUMBING BUILDING 4 & 5 PLANS NC 15-1

COMM. NO.: 6041-B DRAWN BY: CHECKED BY: SAB


DATE: APR. 2, 2024


SHEET NO.

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6041B BID SET DRAWINGS - Page 85 of 142


- REFER TO PLUMBING UNIT PLANS FOR CONTINUATION.
- 2 4"W TO EXISTING WASTE LINE AT 5' FROM BUILDING. FIELD VERIFY LOCATION OF EXISTING WASTE LINE PRIOR TO CONNECTION.
- 3 3/1 CW FR EXISTING WATER LINE AT 5' FROM BUILDING. FIELD VERIFY LOCATION OF EXISTING WATER LINE PRIOR TO CONNECTION. PROVIDE WATER SUPPLY SHUT-OFF IN ACCESSIBLE BOX.
- 4) COORDINATE WITH OWNERSHIP/GC FOR DEMOLITION OF EXISTING WATER MANIFOLD.




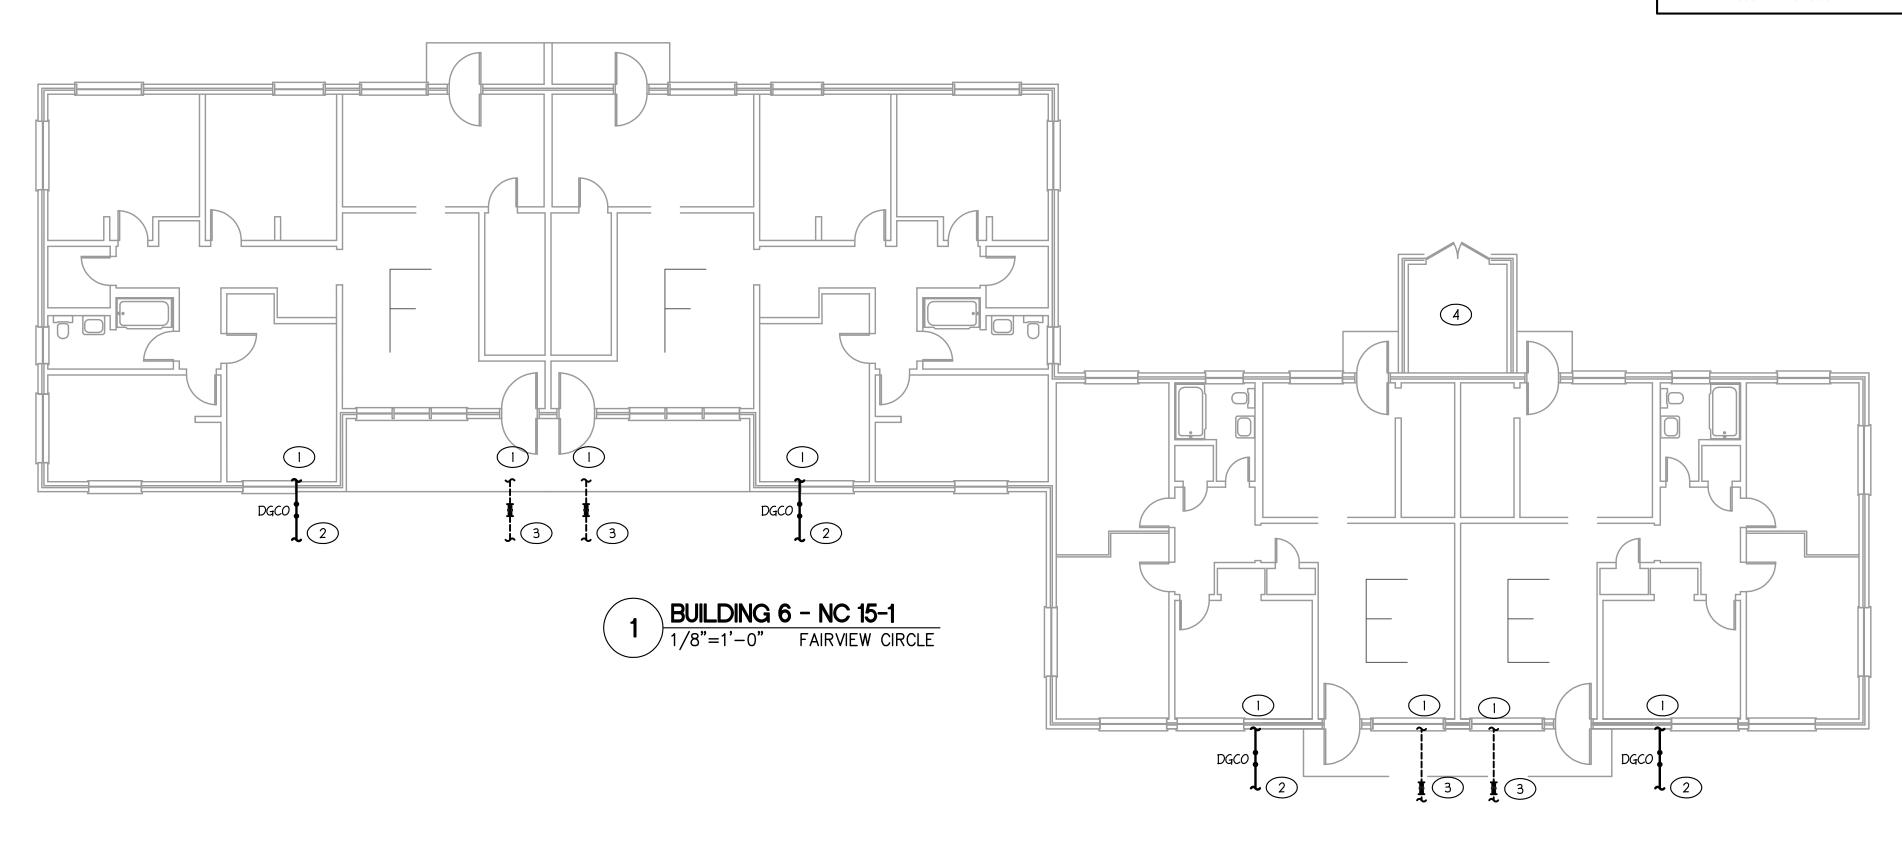

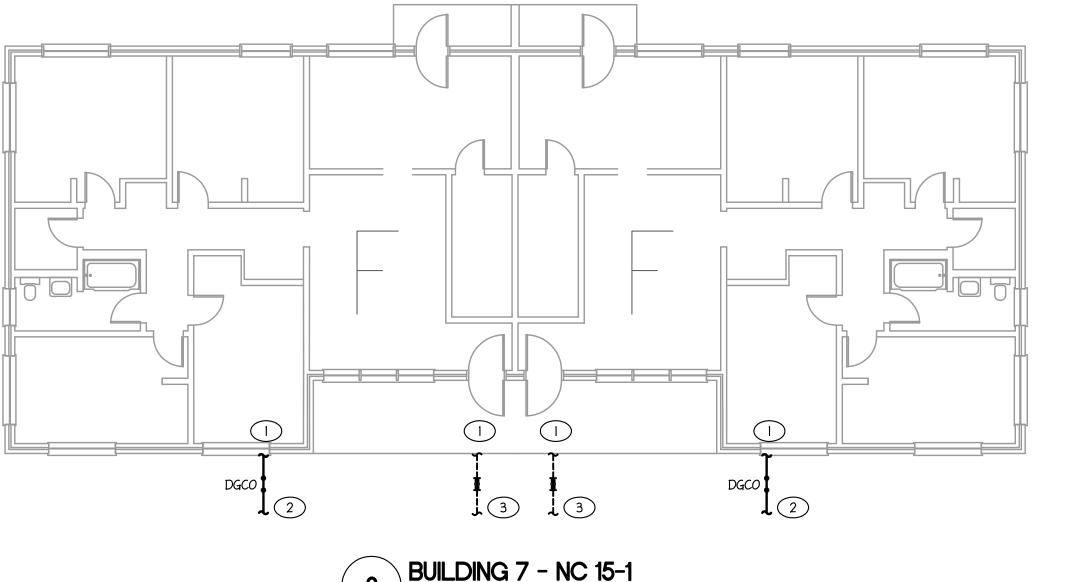BUILDING 7 - NC 15-1 1/8"=1'-0" FAIRVIEW CIRCLE



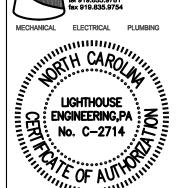

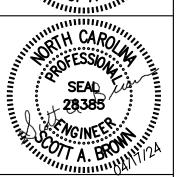

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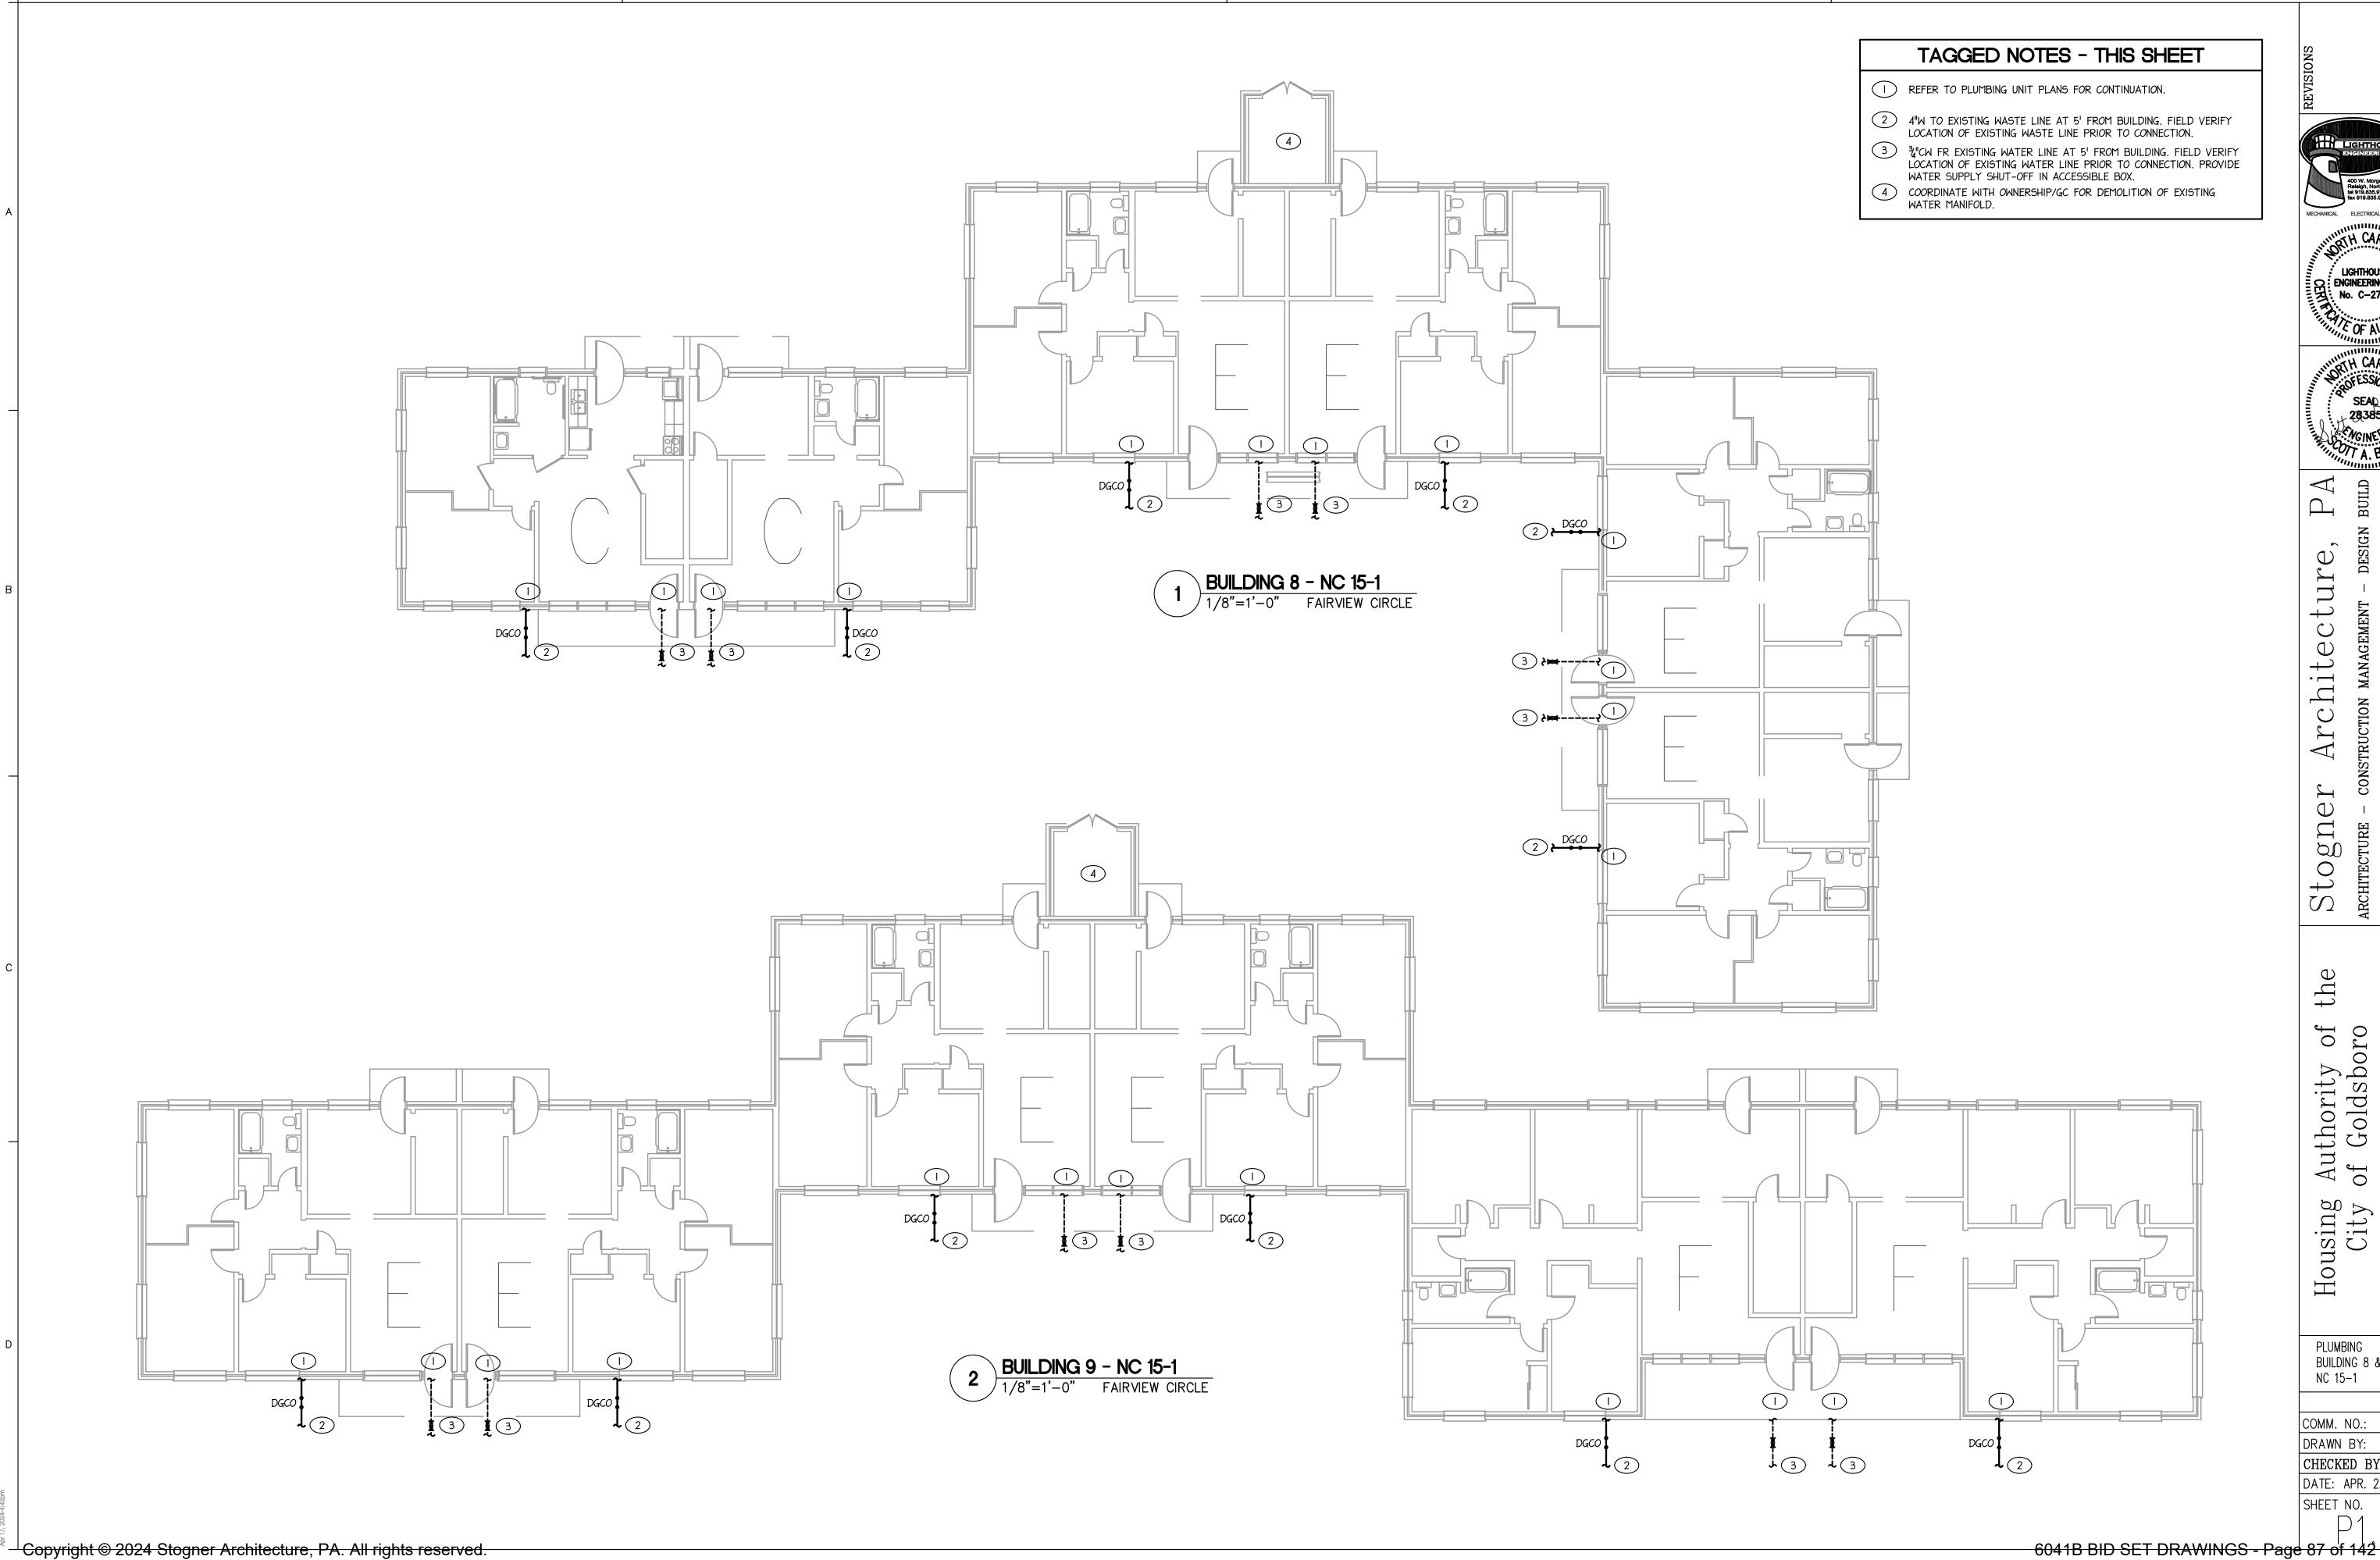
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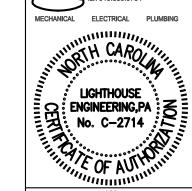
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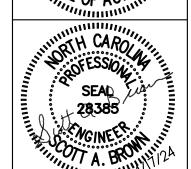
 $\int$ Housing City

PLUMBING BUILDING 6 & 7 PLANS NC 15-1

COMM. NO.: 6041-B DRAWN BY: CHECKED BY: SAB DATE: APR. 2, 2024







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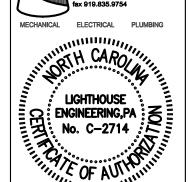
PLUMBING BUILDING 8 & 9 PLANS NC 15-1


COMM. NO.: 6041-B

DRAWN BY: CHECKED BY: SAB DATE: APR. 2, 2024 SHEET NO.

6041B BID SET DRAWINGS - Page 87 of 142

- REFER TO PLUMBING UNIT PLANS FOR CONTINUATION.
- 2 4"W TO EXISTING WASTE LINE AT 5' FROM BUILDING. FIELD VERIFY LOCATION OF EXISTING WASTE LINE PRIOR TO CONNECTION.
- 3 3/CW FR EXISTING WATER LINE AT 5' FROM BUILDING. FIELD VERIFY LOCATION OF EXISTING WATER LINE PRIOR TO CONNECTION. PROVIDE WATER SUPPLY SHUT-OFF IN ACCESSIBLE BOX.
- 4) COORDINATE WITH OWNERSHIP/GC FOR DEMOLITION OF EXISTING WATER MANIFOLD.



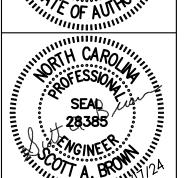

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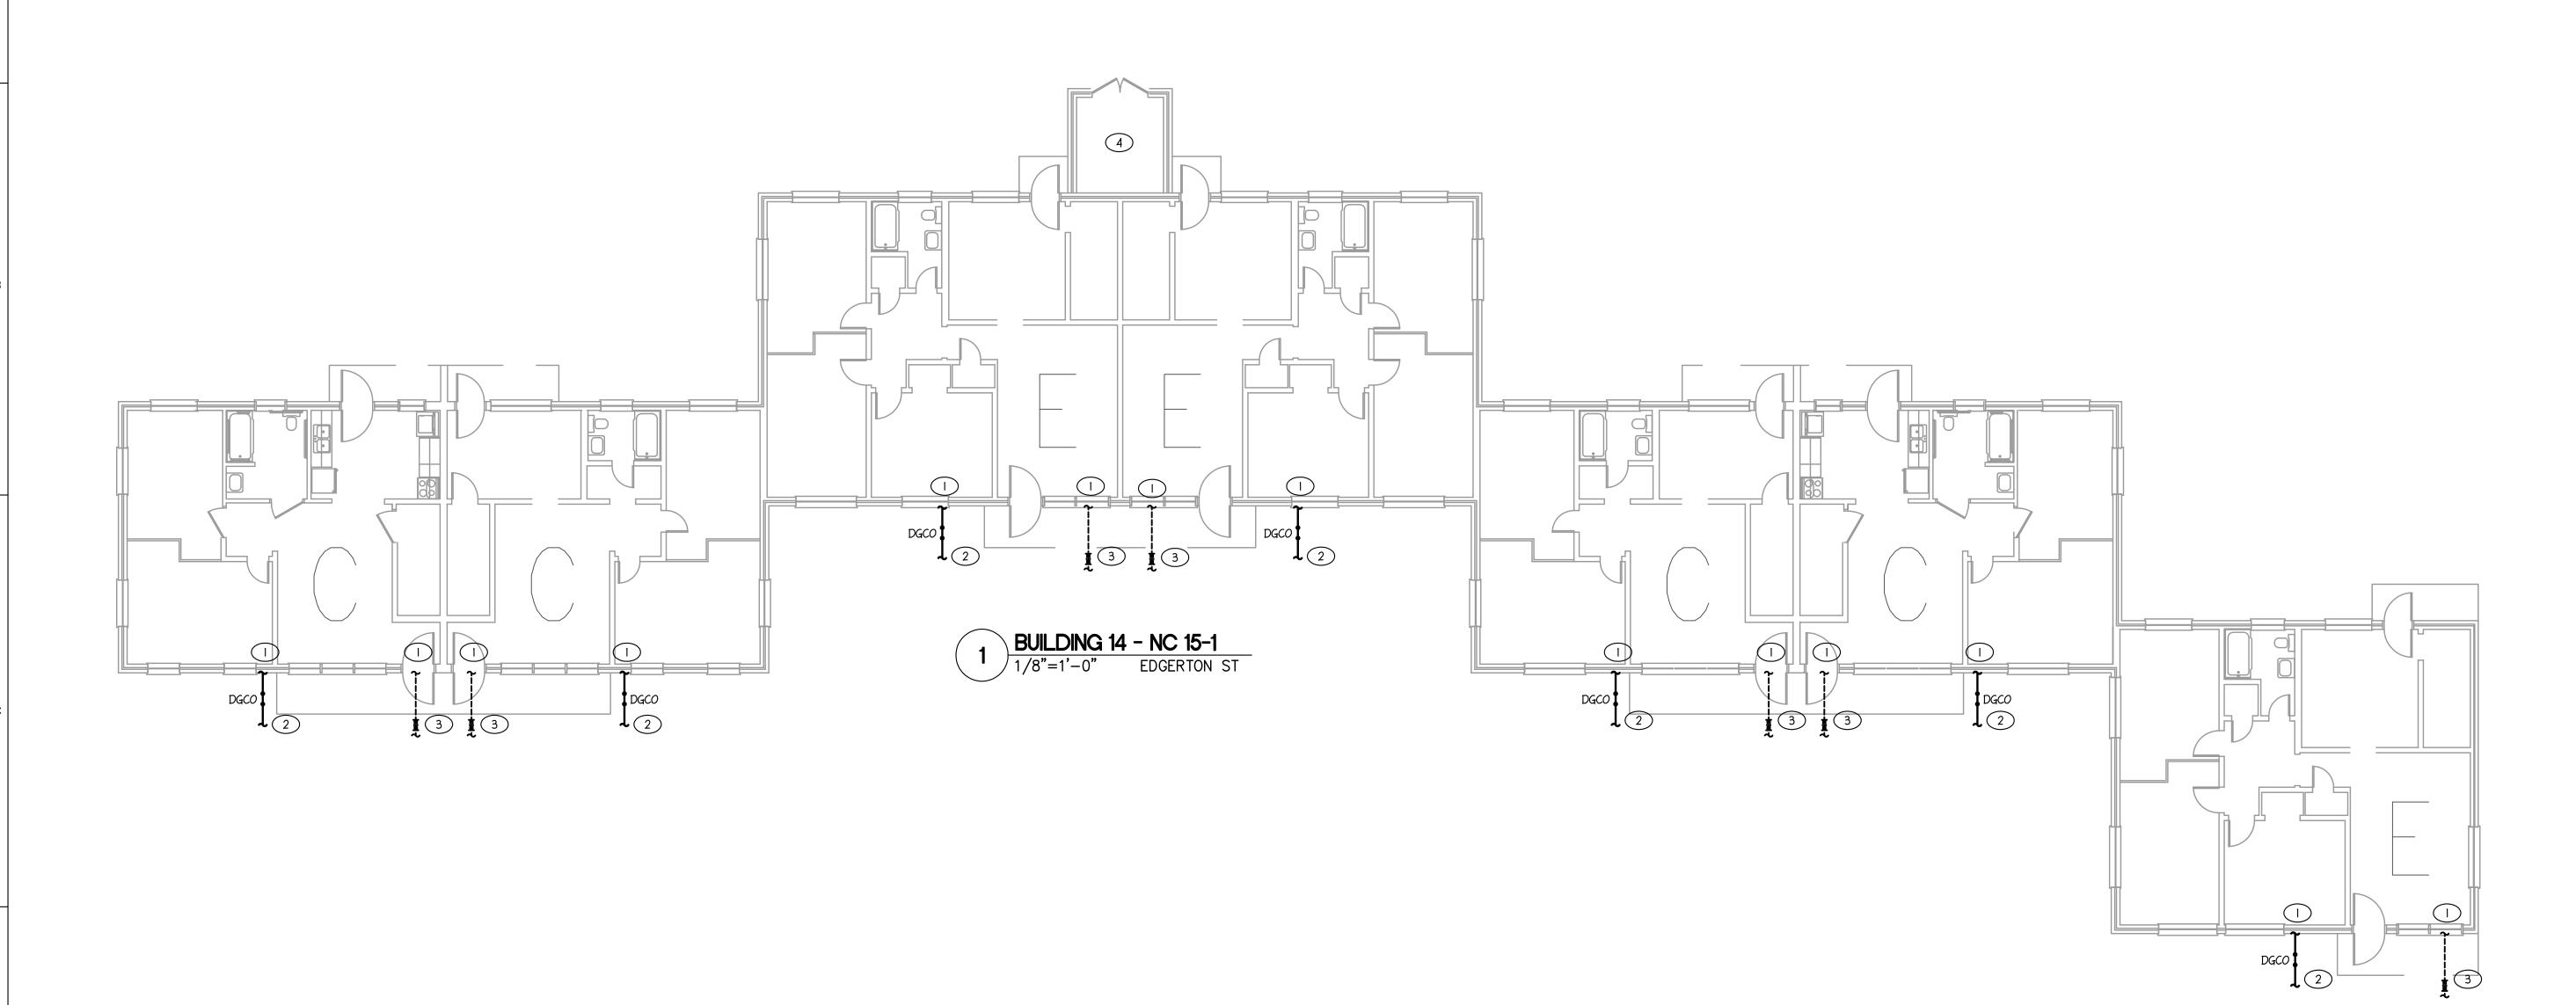
Housing City


PLUMBING BUILDING 14 PLANS NC 15-1


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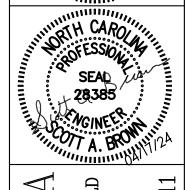
SHEET NO.

6041B BID SET DRAWINGS - Page 88 of 142





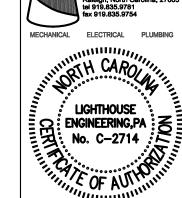

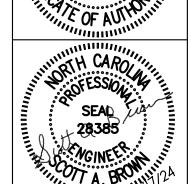

Architecture

TAGGED NOTES - THIS SHEET

REFER TO PLUMBING UNIT PLANS FOR CONTINUATION.

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2 4"W TO EXISTING WASTE LINE AT 5' FROM BUILDING. FIELD VERIFY LOCATION OF EXISTING WASTE LINE PRIOR TO CONNECTION.

3 3/4"CW FR EXISTING WATER LINE AT 5' FROM BUILDING, FIELD VERIFY LOCATION OF EXISTING WATER LINE PRIOR TO CONNECTION. PROVIDE WATER SUPPLY SHUT-OFF IN ACCESSIBLE BOX.

4) COORDINATE WITH OWNERSHIP/GC FOR DEMOLITION OF EXISTING WATER MANIFOLD.

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Stogne
ARCHITECTURE
615 East Broad
Phone 910-

PLUMBING BUILDING 15 PLANS NC 15-1


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6041B BID SET DRAWINGS - Page 89 of 142

PROVIDE HD IN WALL WITH 12"X12" ACCESS PANEL. COORDINATE HUB DRAIN VENT LOCATION WITH MC TO ENSURE SPACE IS MAINTAINED FOR DUCTWORK TO FACILITATE RETURN AIR.


TWO BEDROOM UNIT - NC 15-1 WATER RISER
NO SCALE
BUILDING TYPE 'C'



TWO BEDROOM UNIT - NC 15-1 WASTE RISER

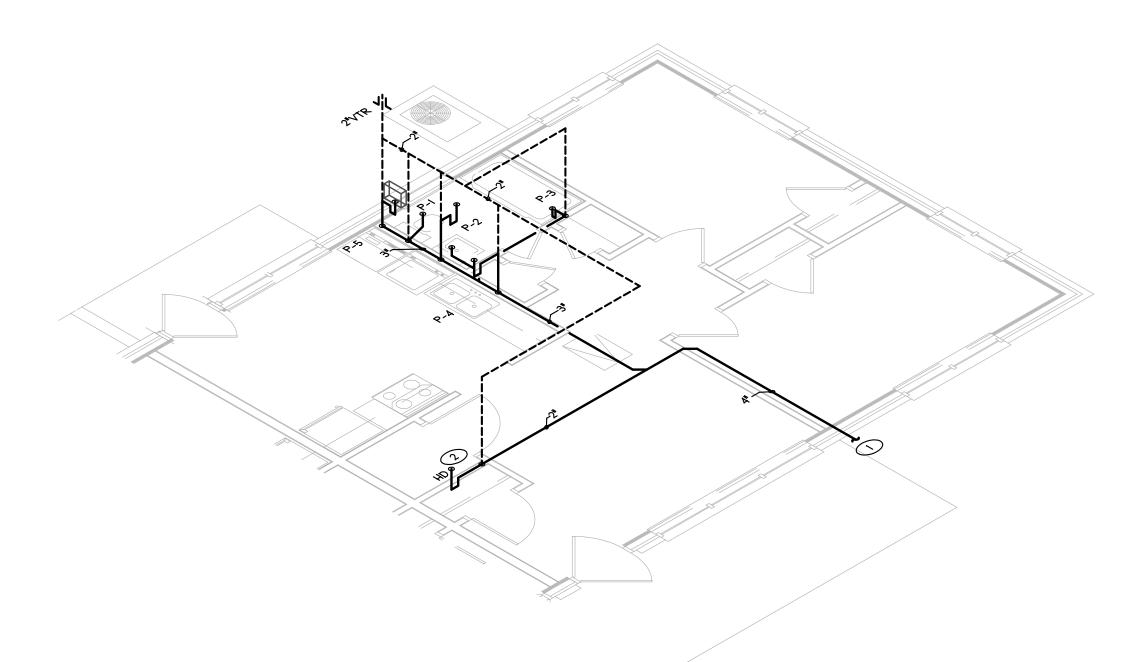NO SCALE

BUILDING TYPE 'C'

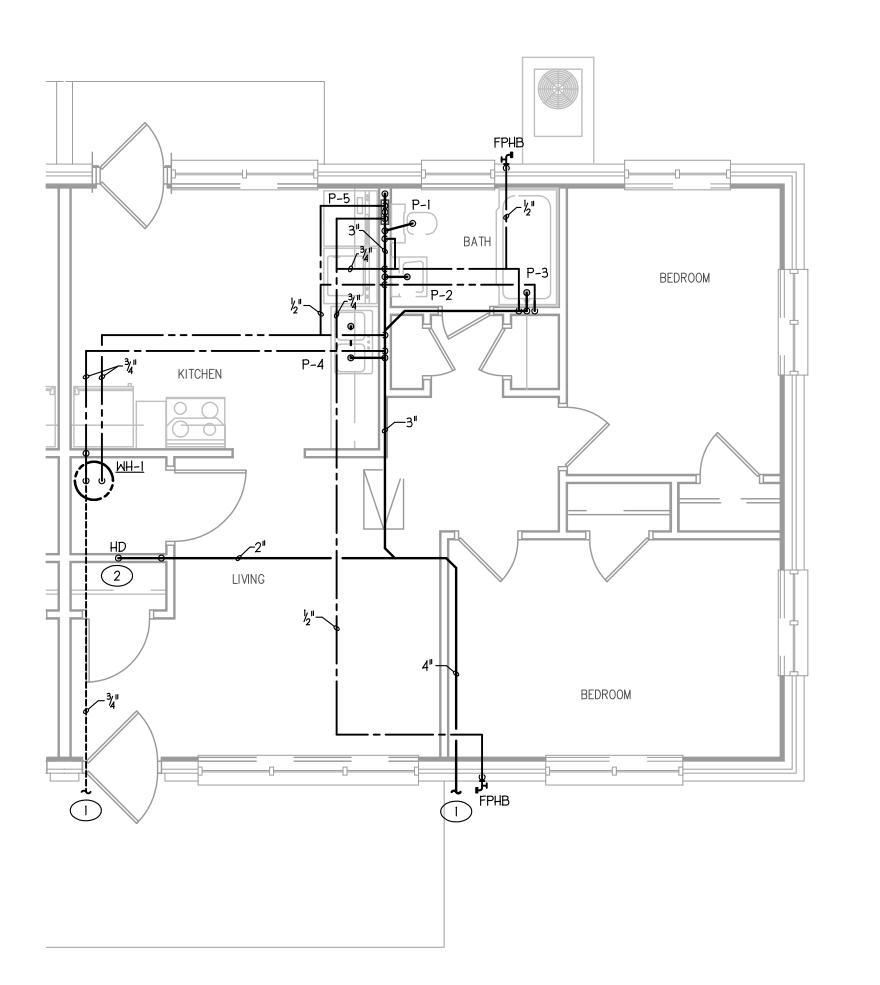


TWO BEDROOM UNIT - NC 15-1

1/4"=1'-0"

BUILDING TYPE 'C'





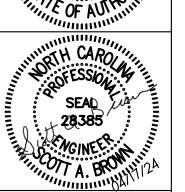

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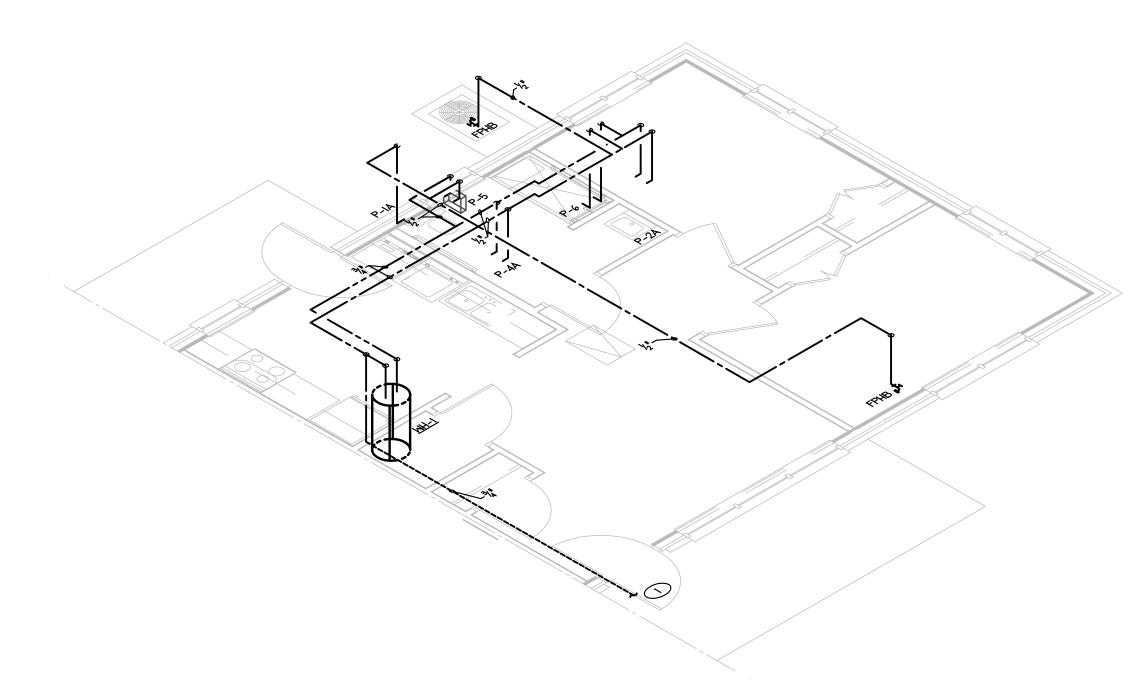
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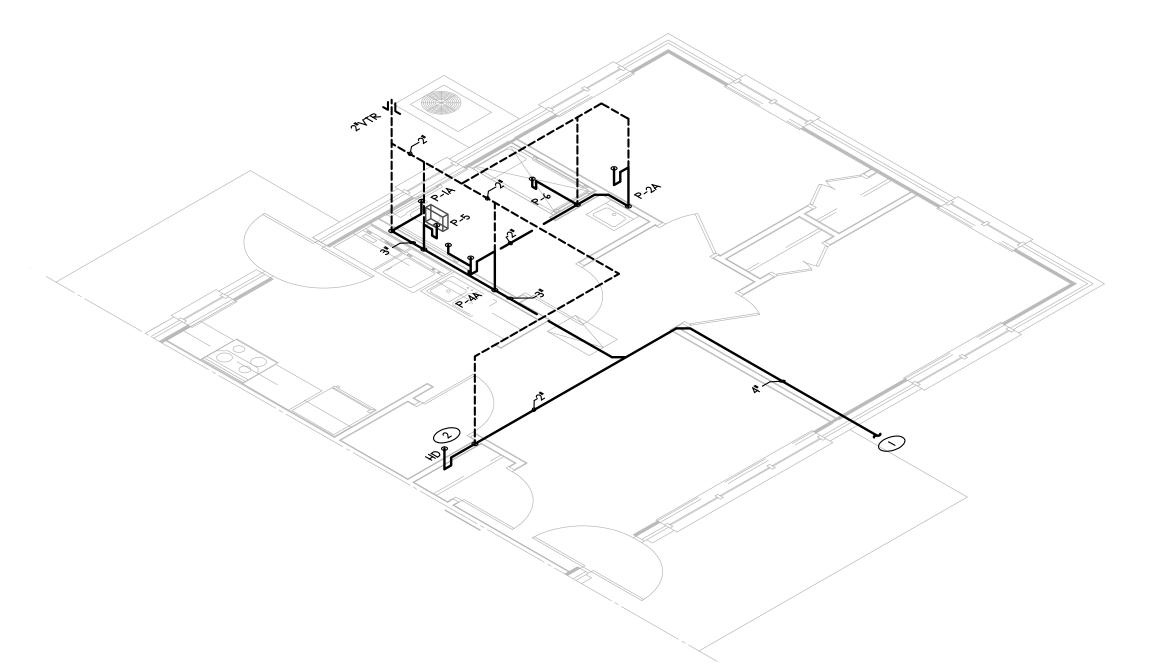
PLUMBING UNIT PLANS NC 15-1 COMM. NO.: 6041-B

DRAWN BY: CHECKED BY: SAB DATE: APR. 2, 2024 SHEET NO.

PROVIDE HD IN WALL WITH 12"X12" ACCESS PANEL. COORDINATE HUB DRAIN VENT LOCATION WITH MC TO ENSURE SPACE IS MAINTAINED FOR DUCTWORK TO FACILITATE RETURN AIR.




TWO BEDROOM HANDICAP UNIT - NC 15-1 WATER RISER



TWO BEDROOM HANDICAP UNIT - NC 15-1 WASTE RISER


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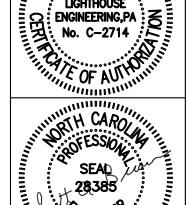


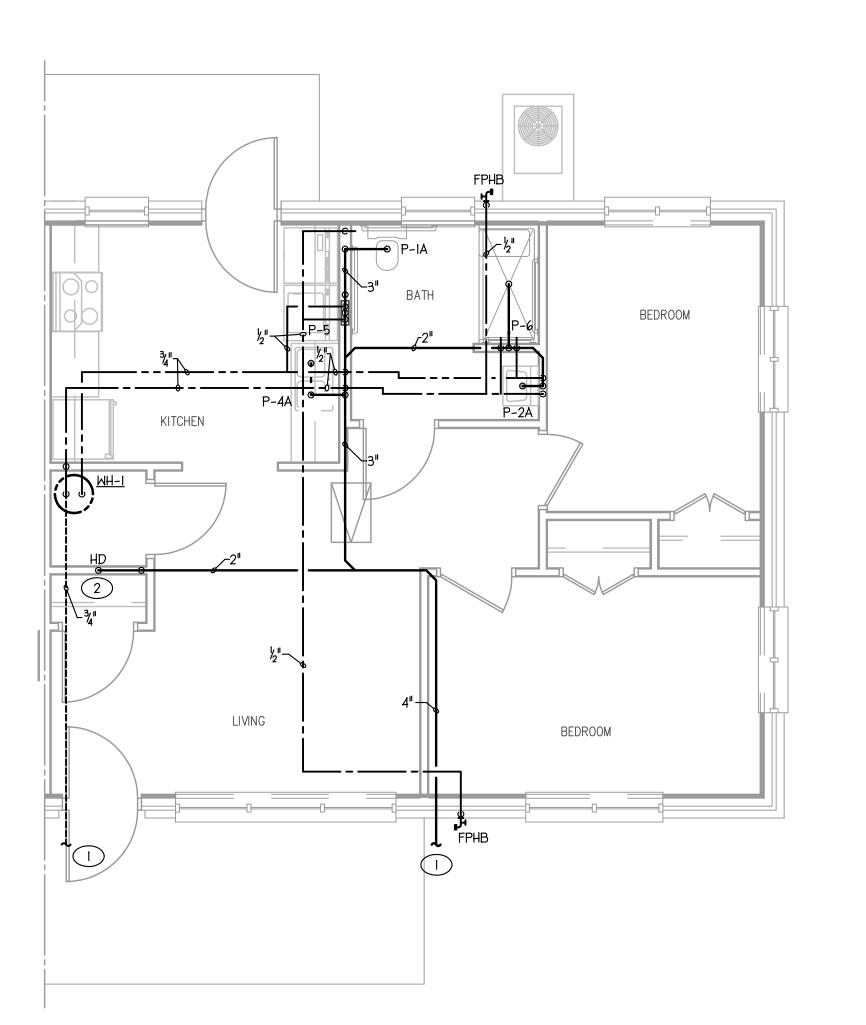TWO BEDROOM HANDICAP UNIT - NC 15-1

1/4"=1'-0"

BUILDING TYPE 'C' BUILDING TYPE 'C'



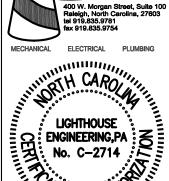

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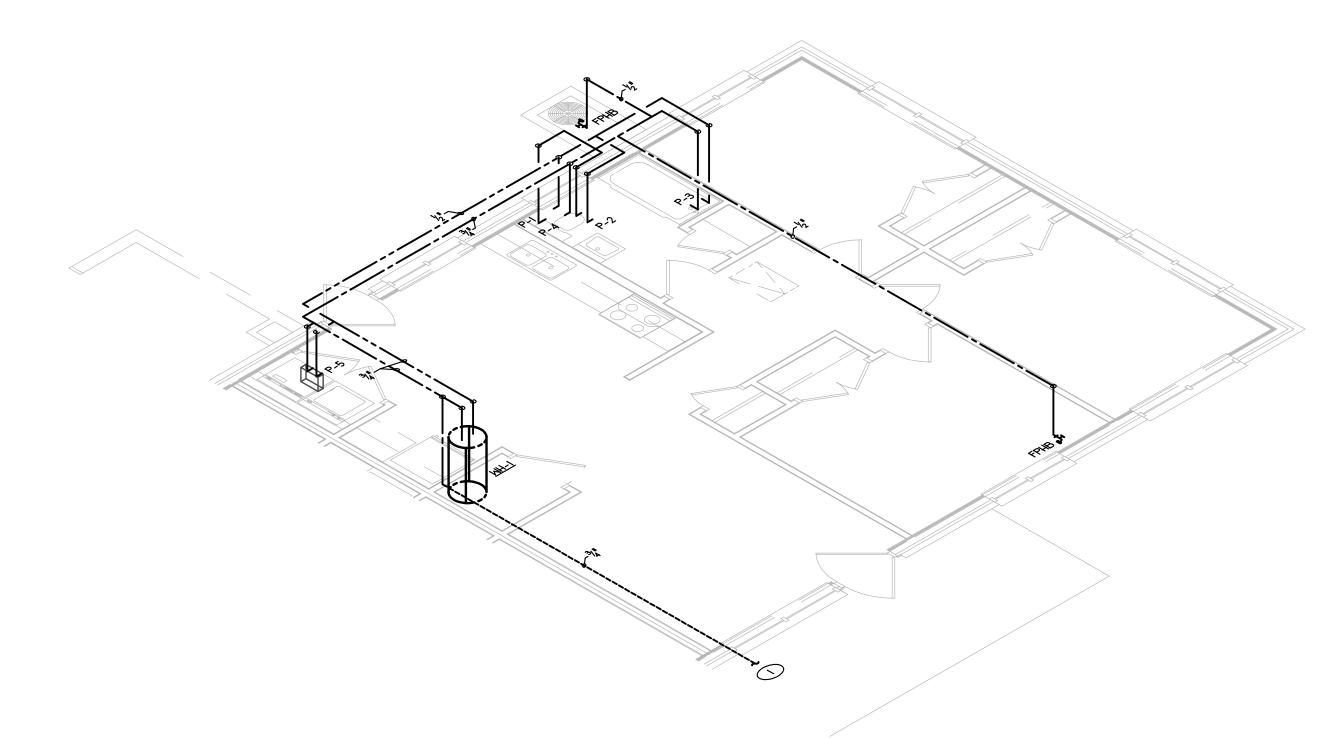
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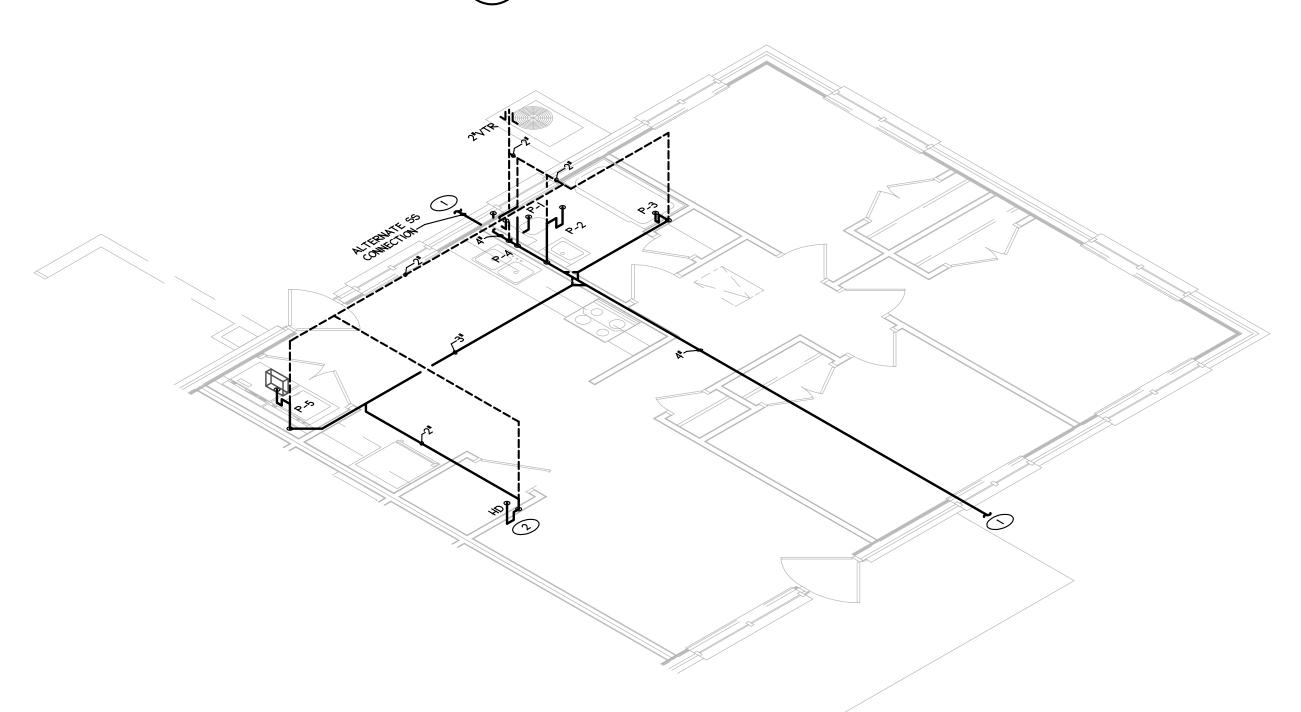
PLUMBING UNIT PLANS NC 15-1

COMM. NO.: 6041-B DRAWN BY: CHECKED BY: SAB DATE: APR. 2, 2024 SHEET NO.


2 PROVIDE HD IN WALL WITH 12"X12" ACCESS PANEL.



THREE BEDROOM UNIT - NC 15-1 WATER RISER





THREE BEDROOM UNIT - NC 15-1 WASTE RISER
NO SCALE
BUILDING TYPE 'E'

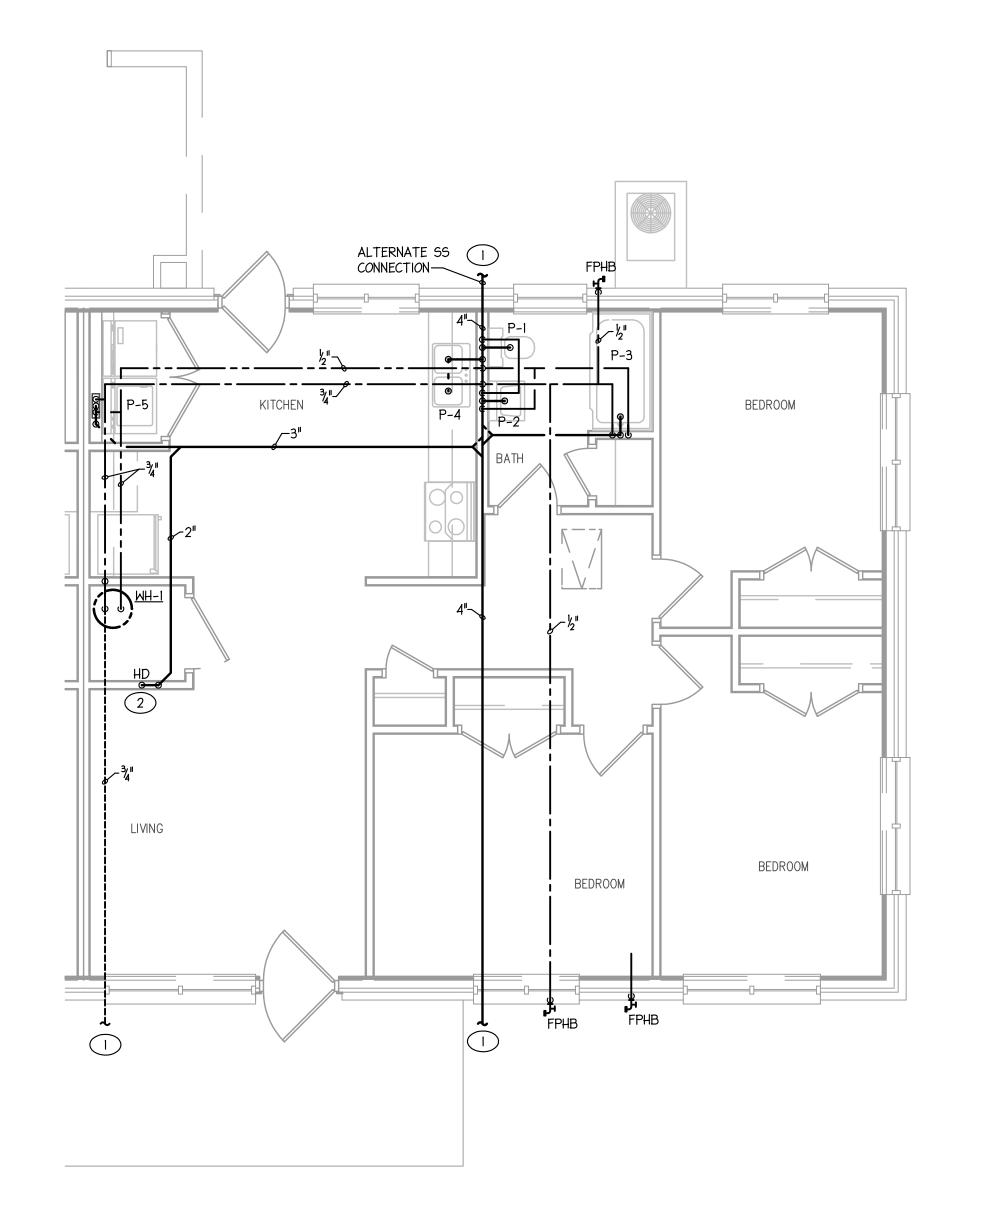

THREE BEDROOM UNIT - NC 15-1 BUILDING TYPE 'E'



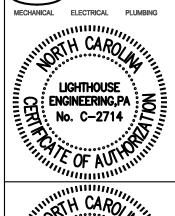

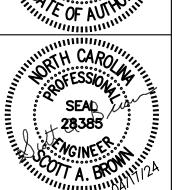

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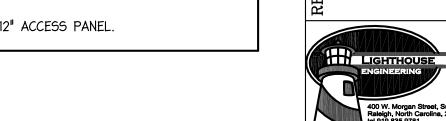
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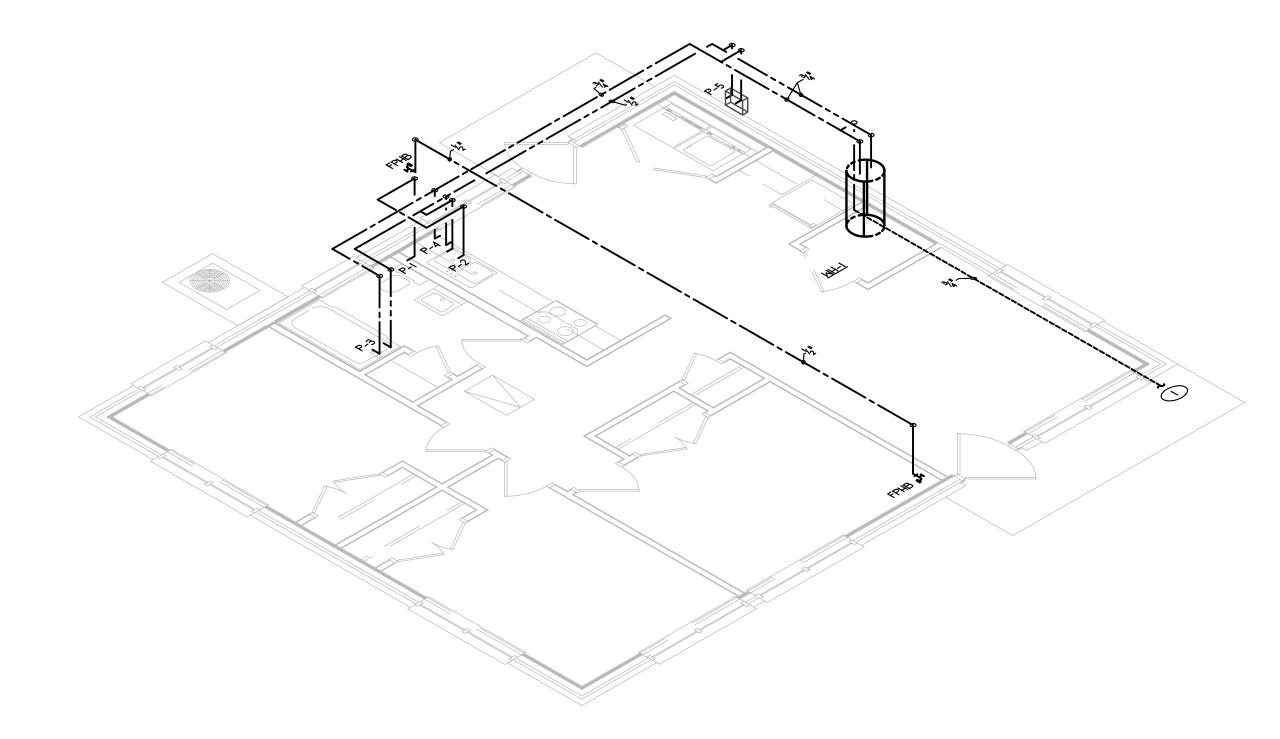
Housing City

PLUMBING UNIT PLANS NC 15-1

COMM. NO.: 6041-B DRAWN BY: CHECKED BY: SAB DATE: APR. 2, 2024 SHEET NO.

- REFER TO PLUMBING BUILDING PLANS FOR CONTINUATION.
- 2 PROVIDE HD IN WALL WITH 12"X12" ACCESS PANEL.







THREE BEDROOM UNIT - NC 15-1 WATER RISER

NO SCALE

BUILDING TYPE 'E-1'

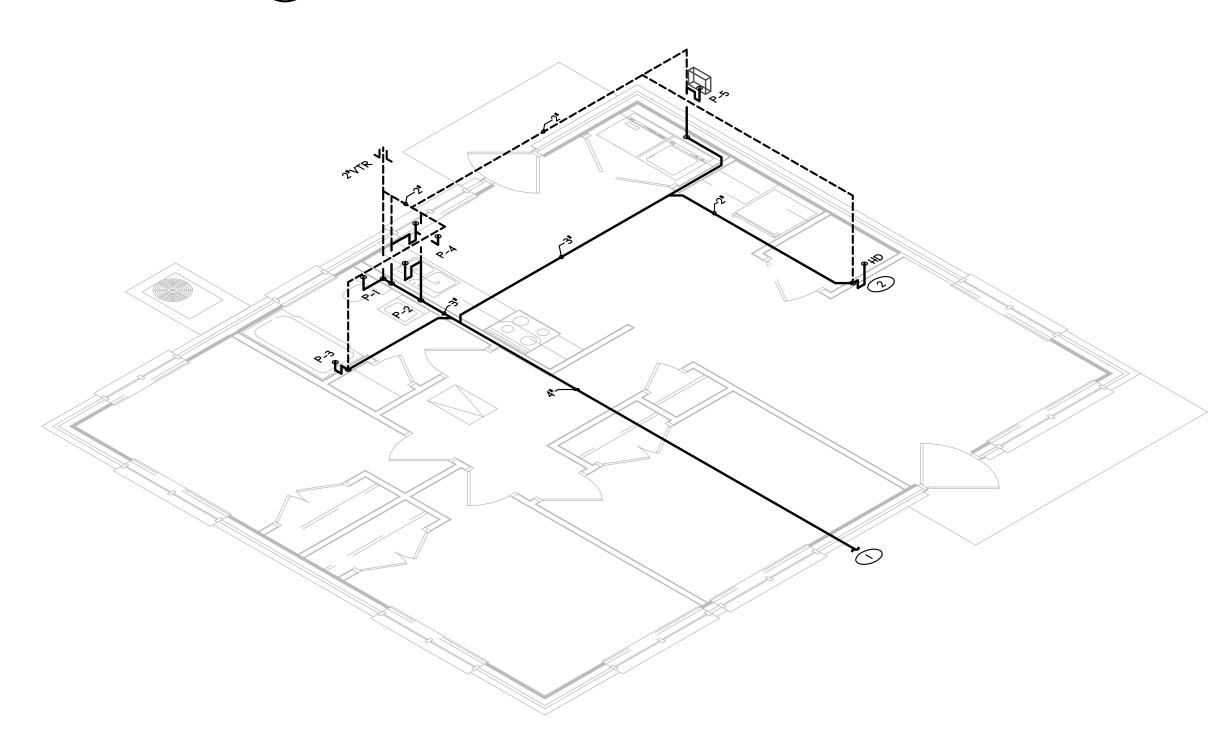

THREE BEDROOM UNIT - NC 15-1 WASTE RISER
NO SCALE
BUILDING TYPE 'E-1'

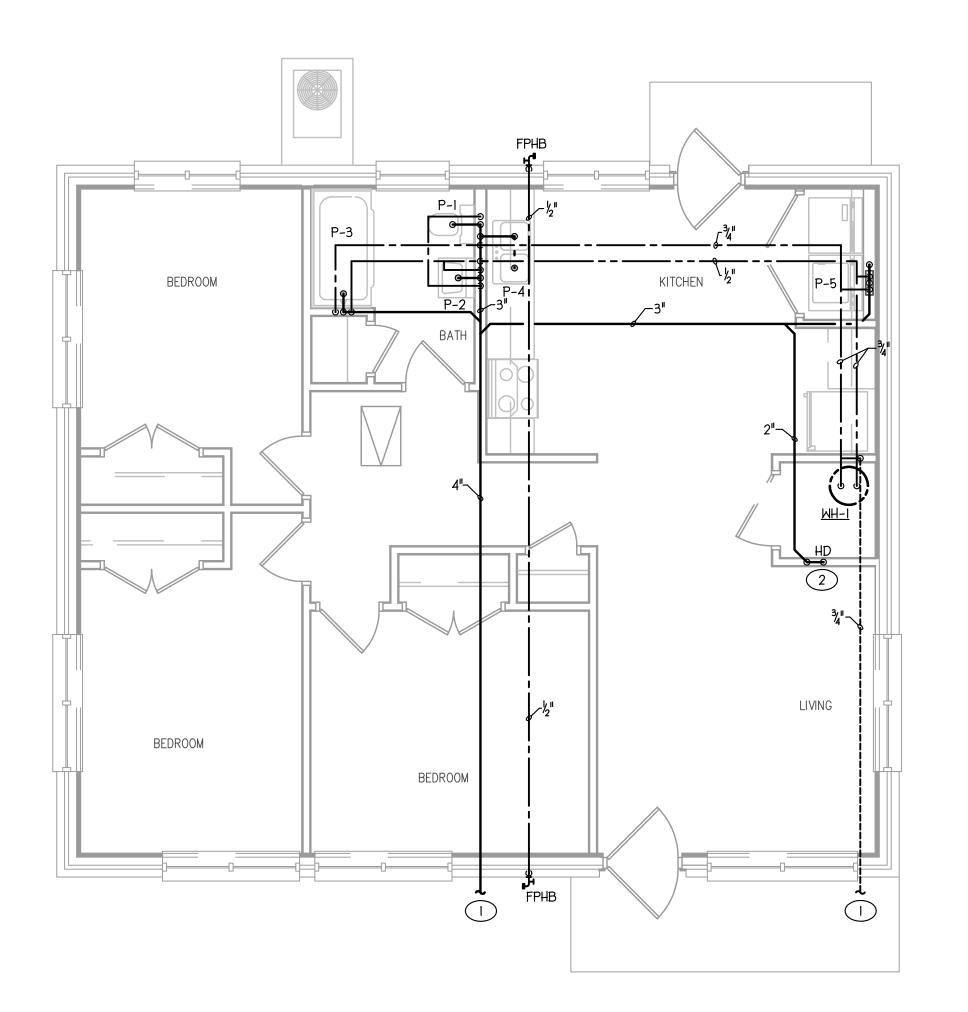



1 THREE BEDROOM UNIT - NC 15-1

1/4"=1'-0" BUILDING TYPE 'E-1'

MECHANICAL ELECTRICAL PLUMBING

LIGHTHOUSE

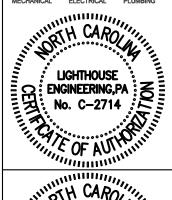

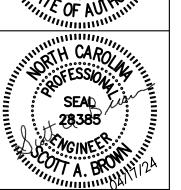

NT – DESIGN BUILD FOR SERVING AND SERVING SERV

Stogner Architecture, East Broad Avenue, Rockingham, North Carolina, 283

Phone 910-895-6874 Fax 910-895-

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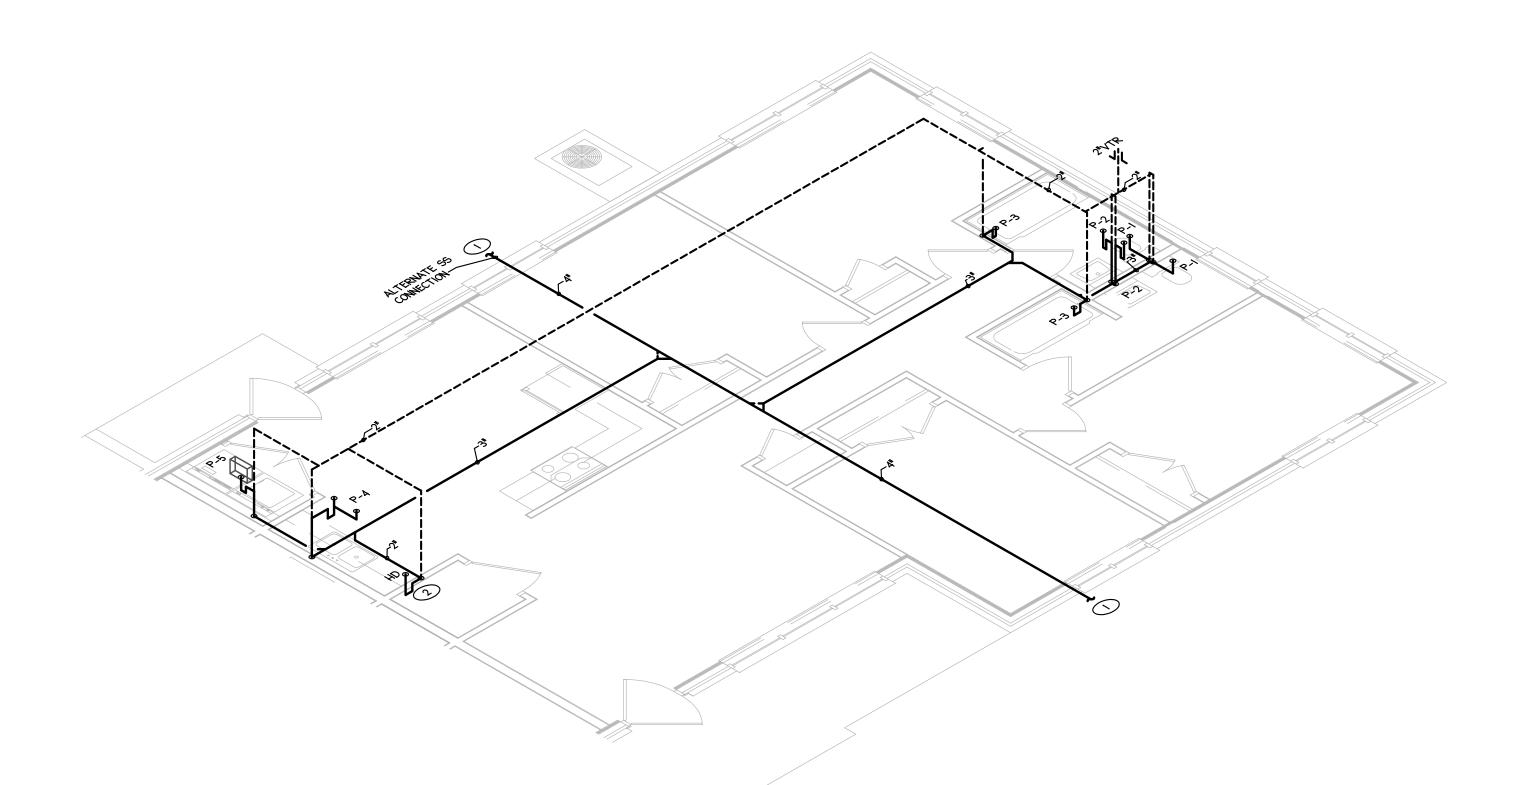
Housing Authority
City of Goldsb.
ENOVATIONS - FAIRVIEW APARTMENT
C 15-1 FAIRVIEW CIRCLE
DLDSBORO,

PLUMBING
UNIT PLANS
NC 15–1


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CHECKED BY: SAB
DATE: APR. 2, 2024
SHEET NO.

2 PROVIDE HD IN WALL WITH 12"X12" ACCESS PANEL.

3 FOUR BEDROOM UNIT - NC 15-1 WATER RISER
NO SCALE BUILDING TYPE 'F'




POUR BEDROOM UNIT - NC 15-1 WASTE RISER
NO SCALE
BUILDING TYPE 'F'

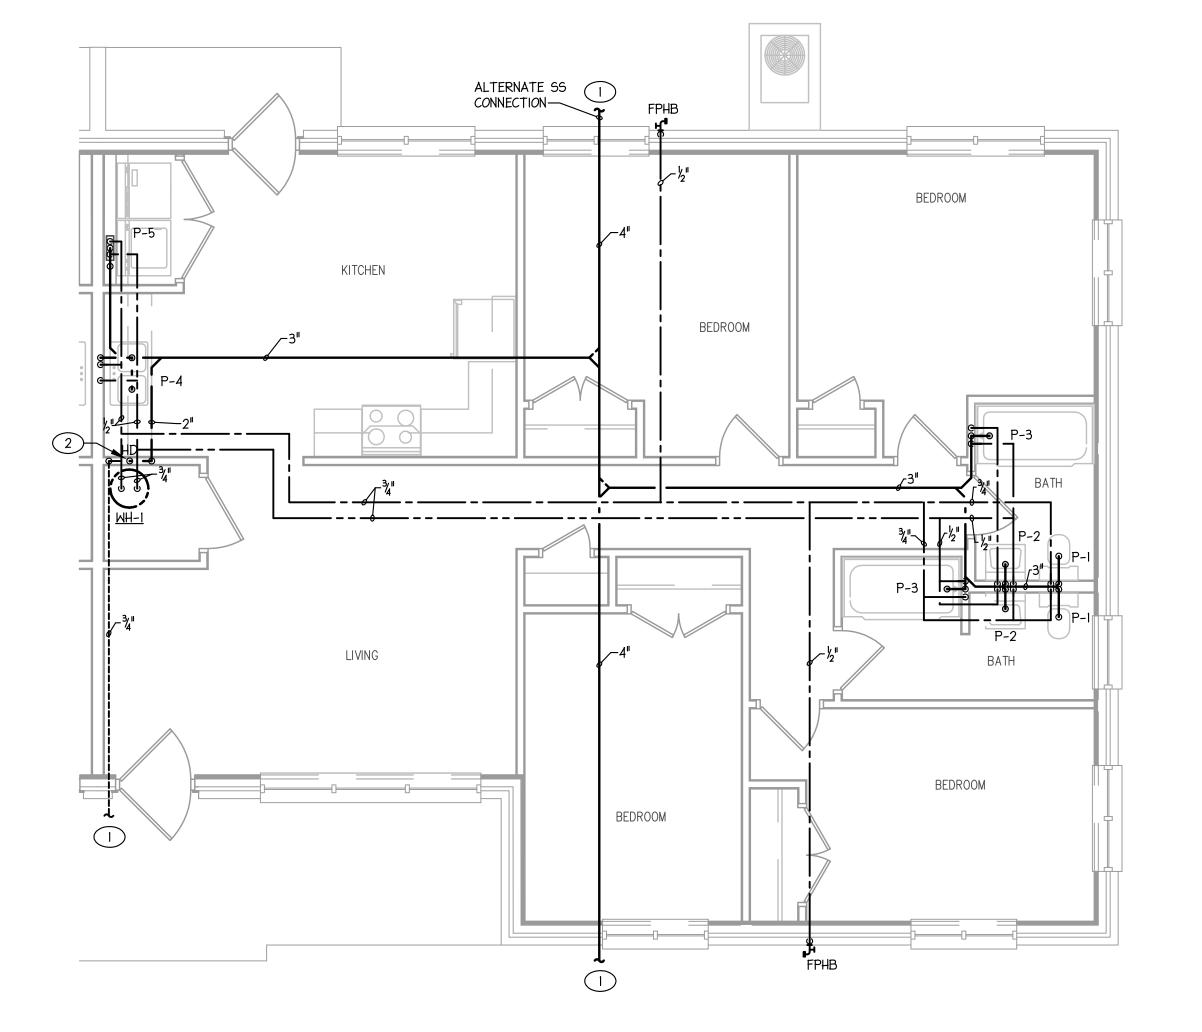


FOUR BEDROOM UNIT - NC 15-1

1/4"=1'-0" BUILDING TYPE 'F'



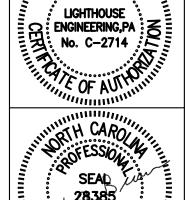

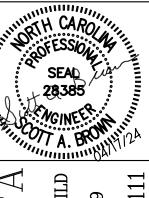

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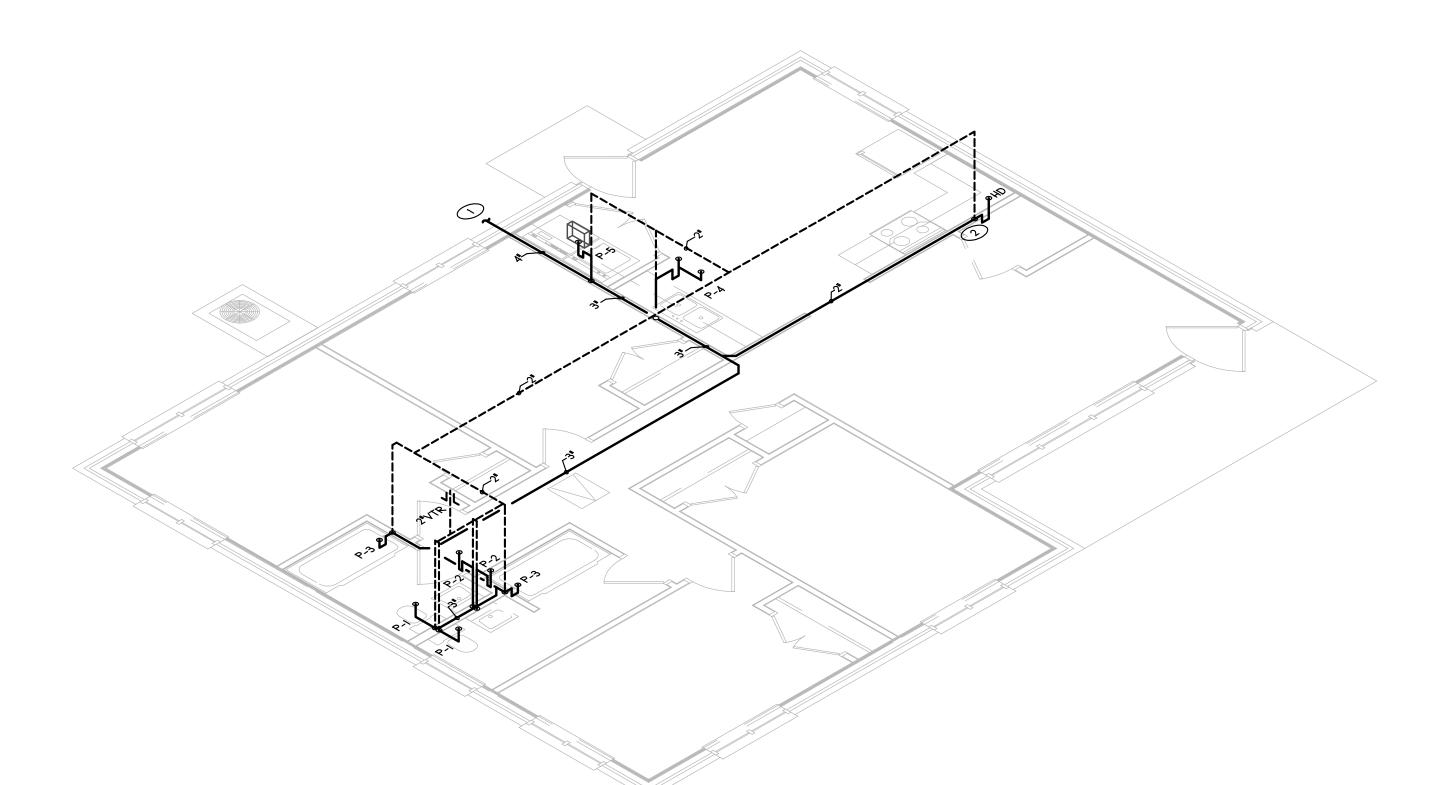
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PLUMBING UNIT PLANS NC 15-1

COMM. NO.: 6041-B DRAWN BY: CHECKED BY: SAB DATE: APR. 2, 2024 SHEET NO.

2 PROVIDE HD IN WALL WITH 12"X12" ACCESS PANEL.


TOUR BEDROOM UNIT - NC 15-1 WATER RISER



FOUR BEDROOM UNIT - NC 15-1 WASTE RISER


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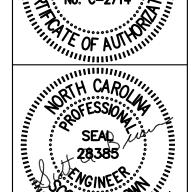
BUILDING TYPE 'F-1'

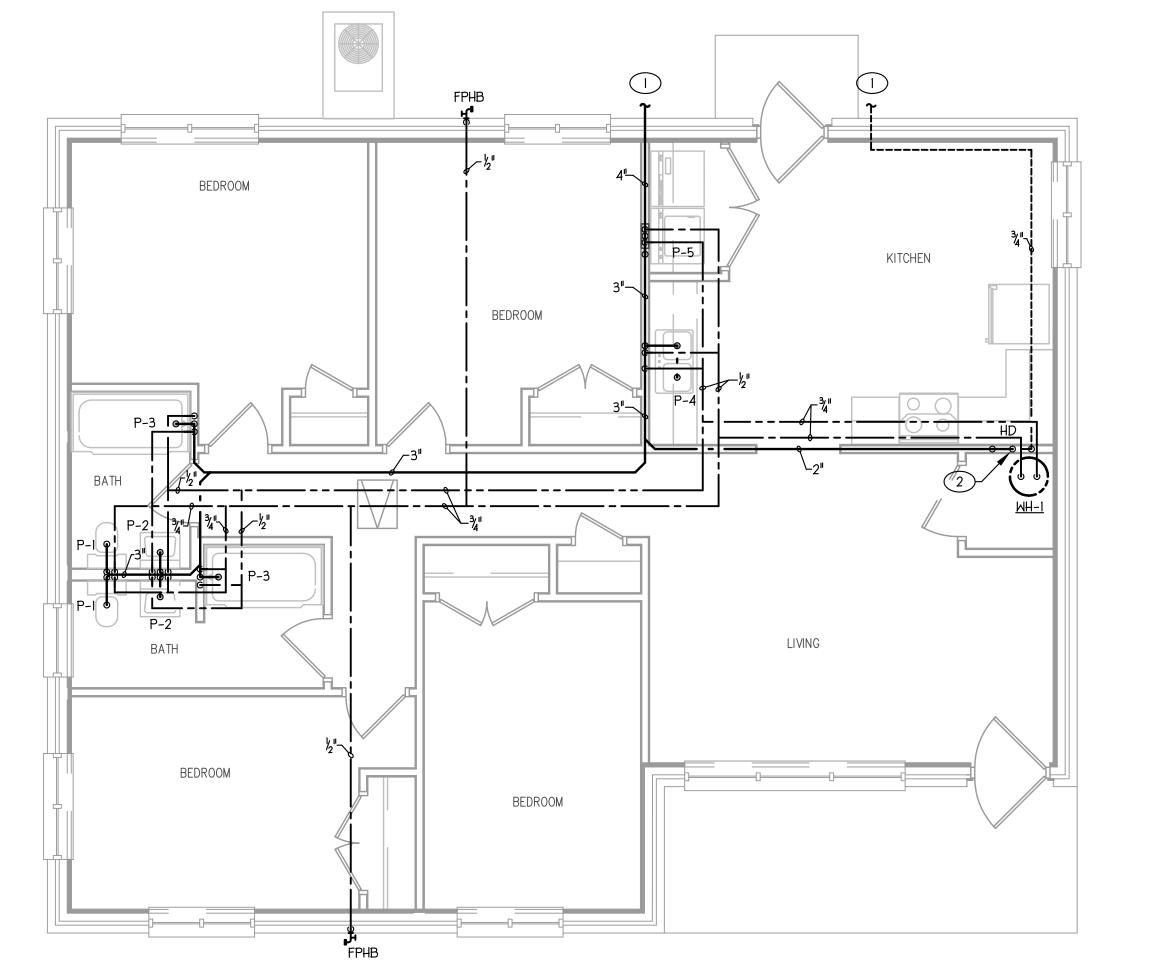

FOUR BEDROOM UNIT - NC 15-1

1/4"=1'-0" BUILDING TYPE 'F-1'



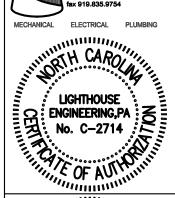

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PLUMBING UNIT PLANS NC 15-1

COMM. NO.: 6041-B DRAWN BY: CHECKED BY: SAB DATE: APR. 2, 2024 SHEET NO.


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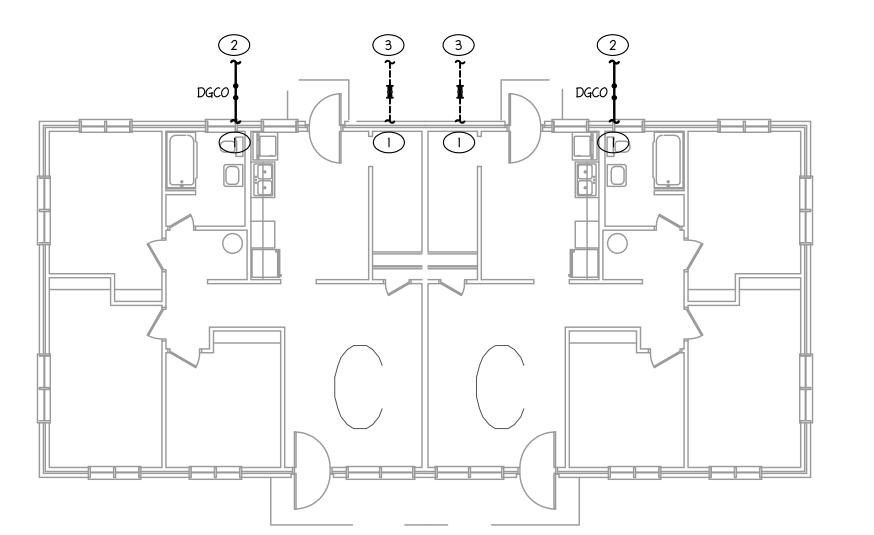
6041B BID SET DRAWINGS - Page 95 of 142°

2 4"W TO EXISTING WASTE LINE AT 5' FROM BUILDING. FIELD VERIFY LOCATION OF EXISTING WASTE LINE PRIOR TO CONNECTION.

3 3/CW FR EXISTING WATER LINE AT 5' FROM BUILDING. FIELD VERIFY LOCATION OF EXISTING WATER LINE PRIOR TO CONNECTION. PROVIDE WATER SUPPLY SHUT-OFF IN ACCESSIBLE BOX.

4) COORDINATE WITH OWNERSHIP/GC FOR DEMOLITION OF EXISTING WATER MANIFOLD.




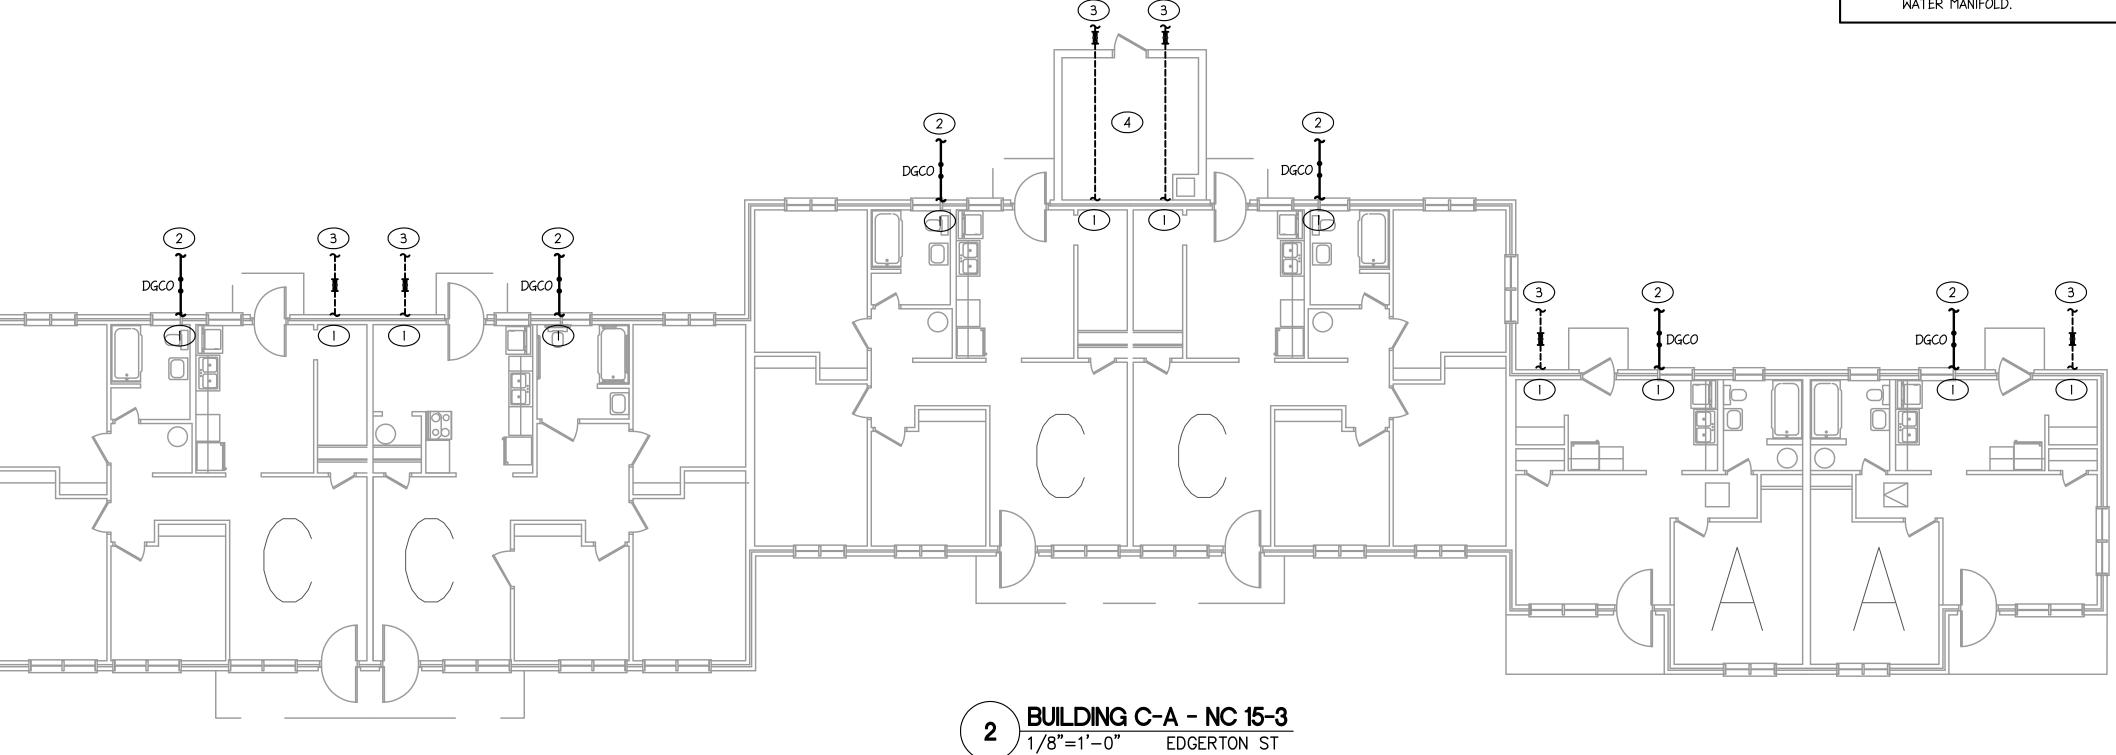







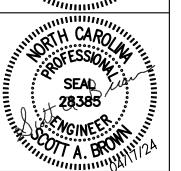

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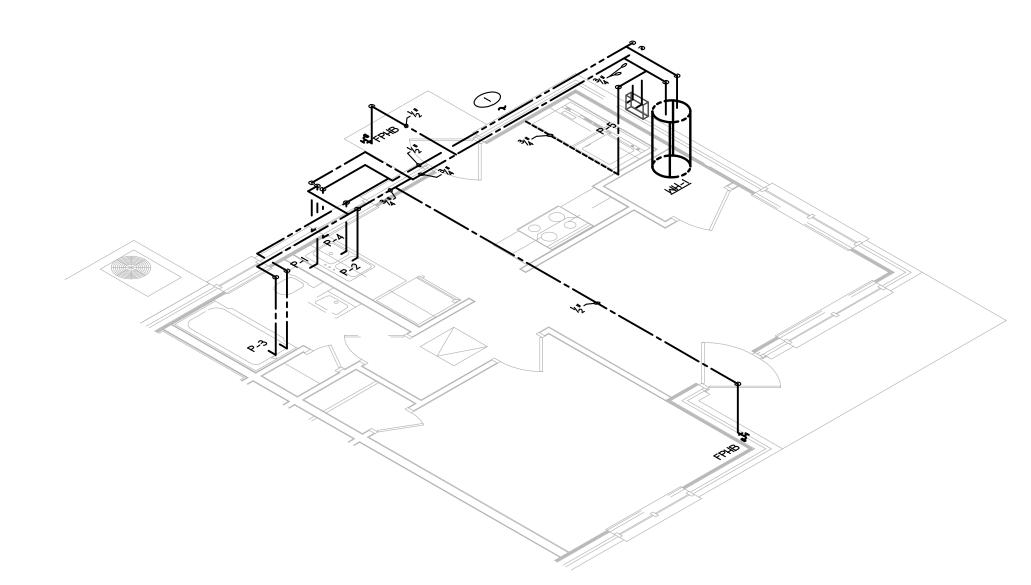
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PLUMBING BUILDING C & C-A PLANS NC 15-3


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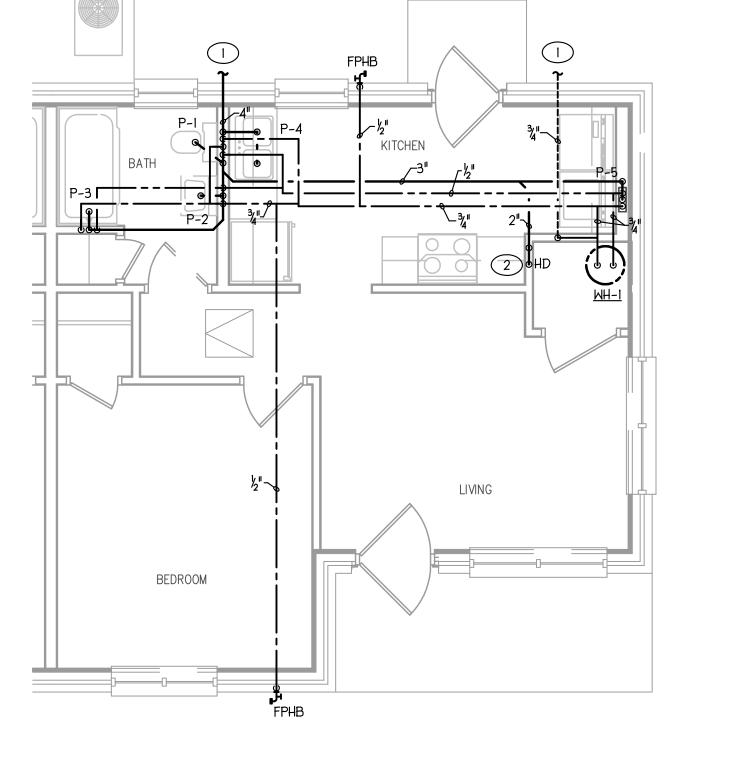
2 PROVIDE HD IN WALL WITH 12"X12" ACCESS PANEL.



ONE BEDROOM UNIT - NC 15-3 WATER RISER
NO SCALE
BUILDING TYPE 'A'





ONE BEDROOM UNIT - NC 15-3 WASTE RISER
NO SCALE
BUILDING TYPE 'A'

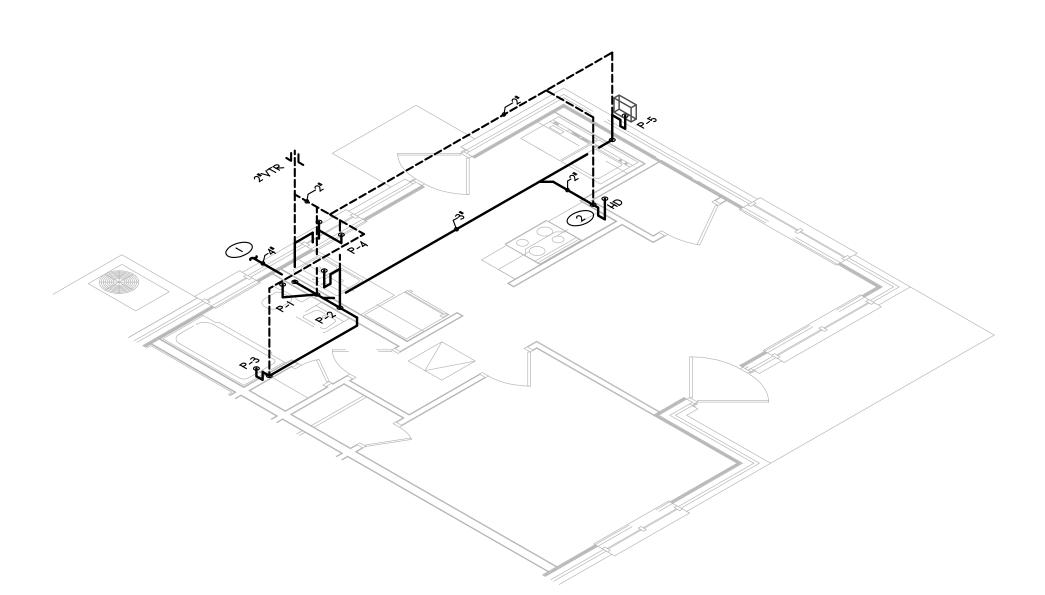

ONE BEDROOM UNIT - NC 15-3
1/4"=1'-0" BUILDING TYPE 'A'



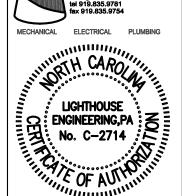

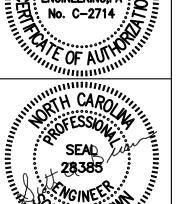



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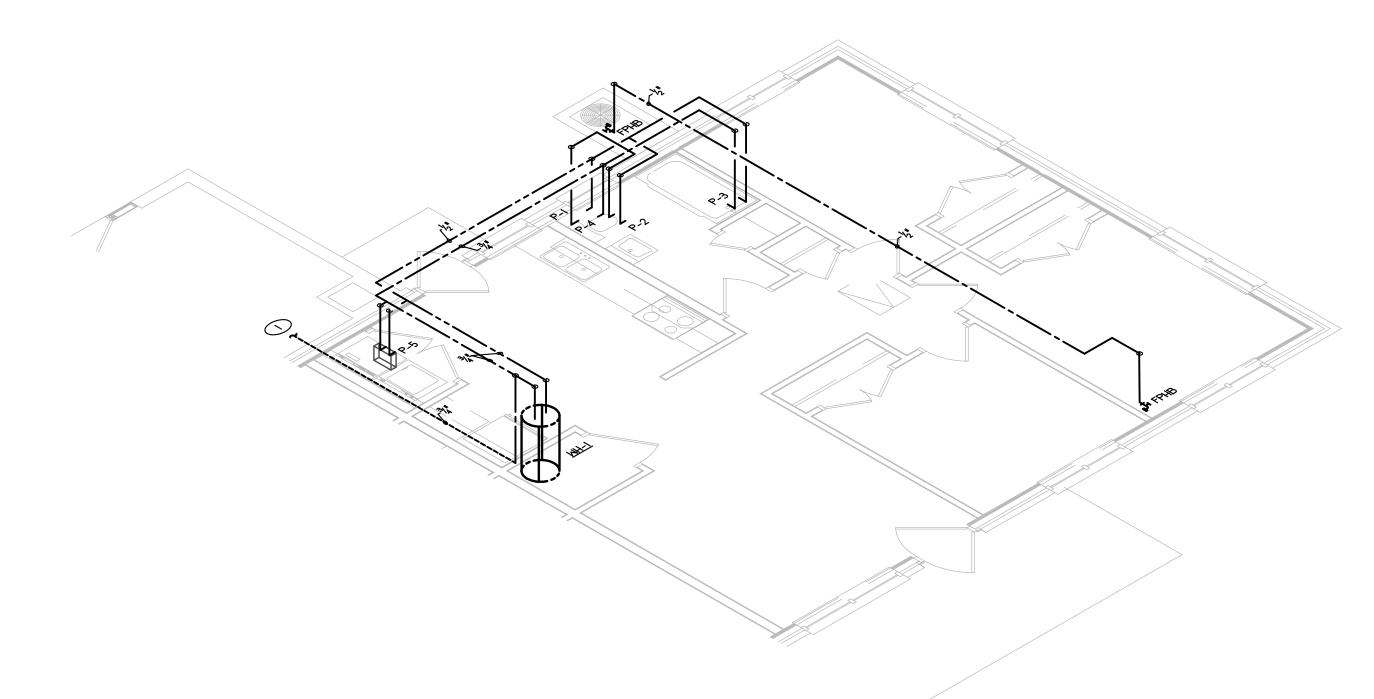
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Housing City

PLUMBING UNIT PLANS NC 15-3


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2 PROVIDE HD IN WALL WITH 12"X12" ACCESS PANEL.




THREE BEDROOM UNIT - NC 15-3 WATER RISER
NO SCALE

BUILDING TYPE 'C'

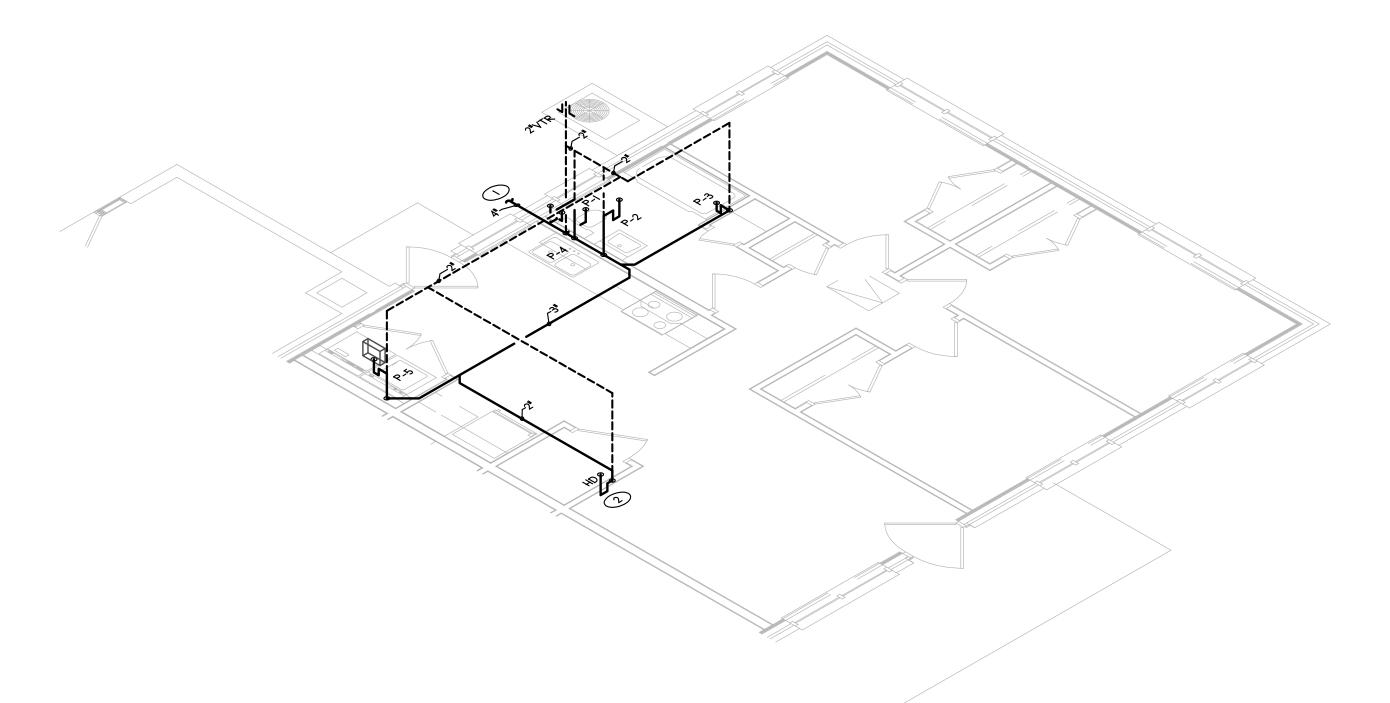

THREE BEDROOM UNIT - NC 15-3 WASTE RISER
NO SCALE
BUILDING TYPE 'C'

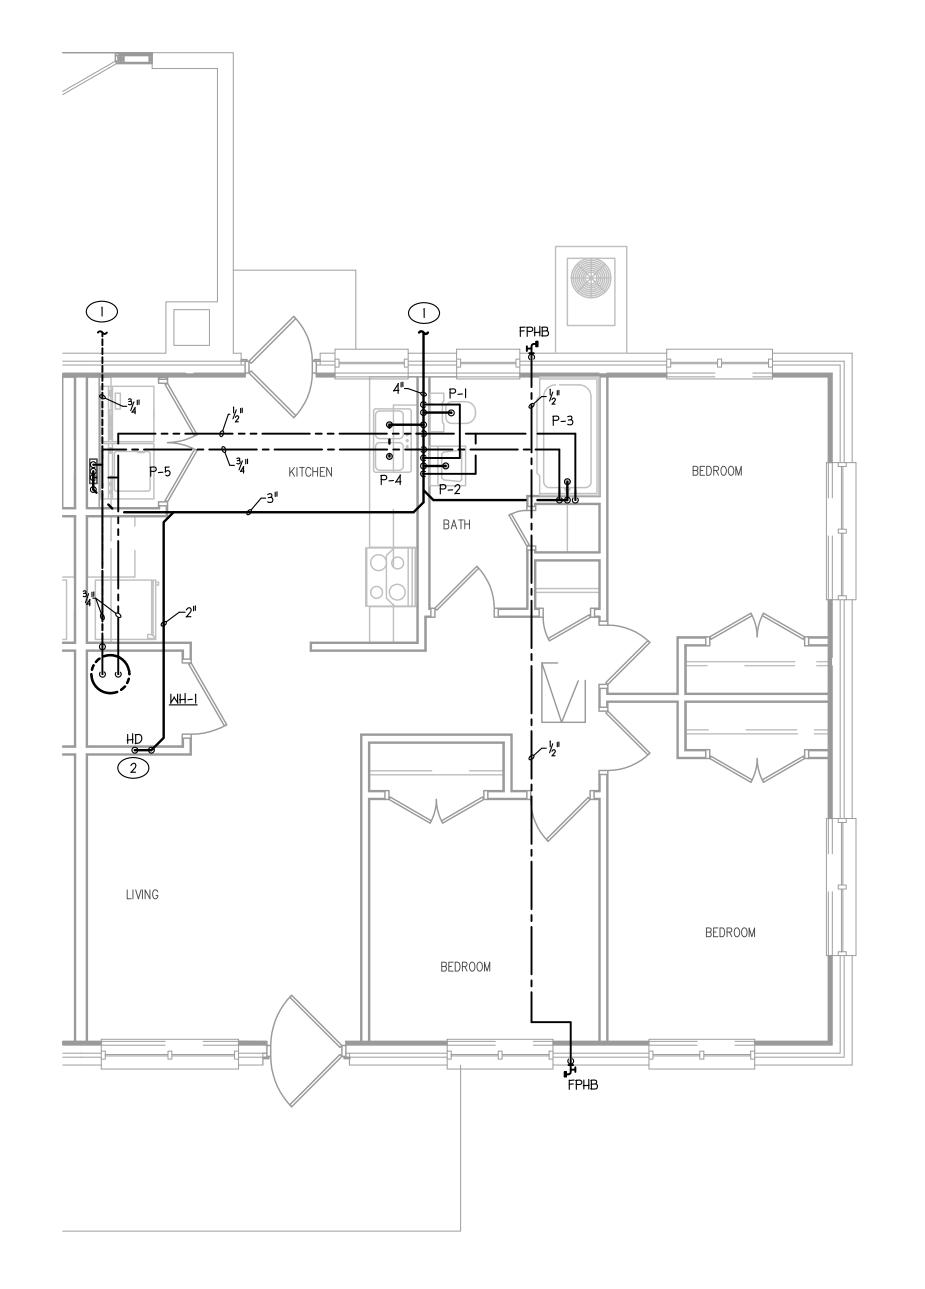



THREE BEDROOM UNIT - NC 15-3


1/4"=1'-0"

BUILDING TYPE 'C'



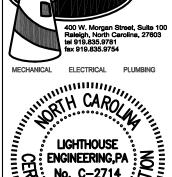

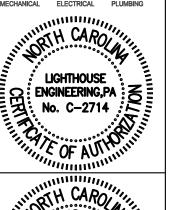

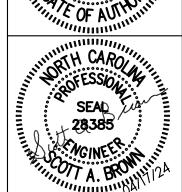

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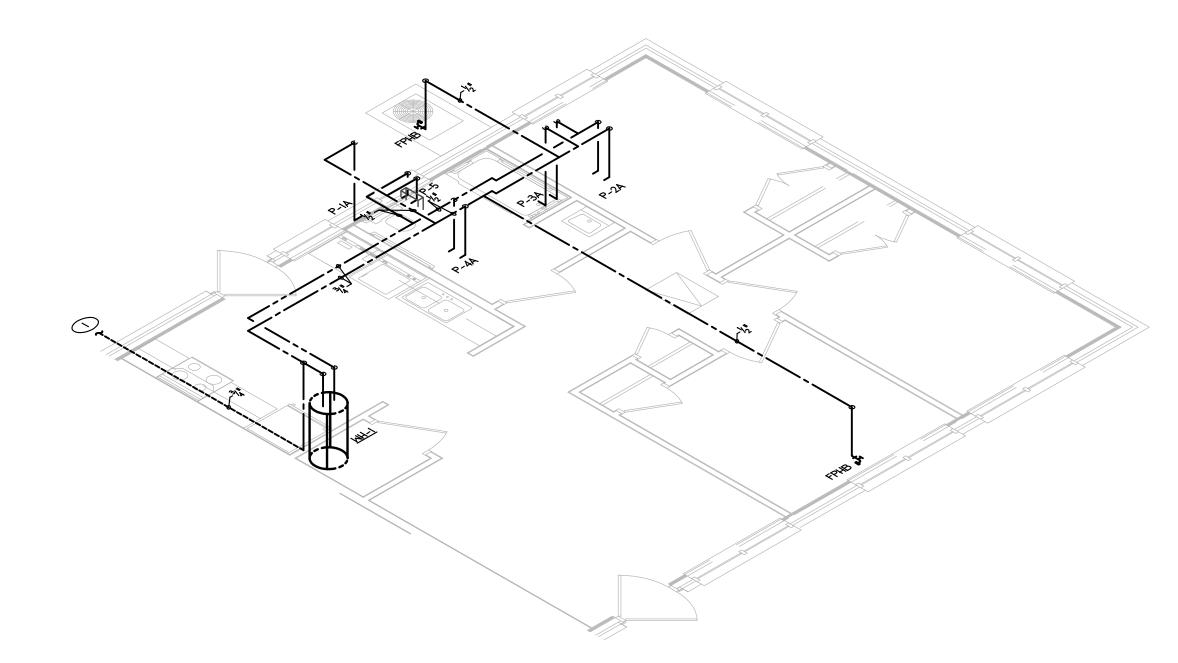
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Housing City


PLUMBING UNIT PLANS NC 15-3

COMM. NO.: 6041-B DRAWN BY: CHECKED BY: SAB DATE: APR. 2, 2024 SHEET NO.

2 PROVIDE HD IN WALL WITH 12"X12" ACCESS PANEL.




THREE BEDROOM HANDICAP UNIT - NC 15-3 WATER RISER

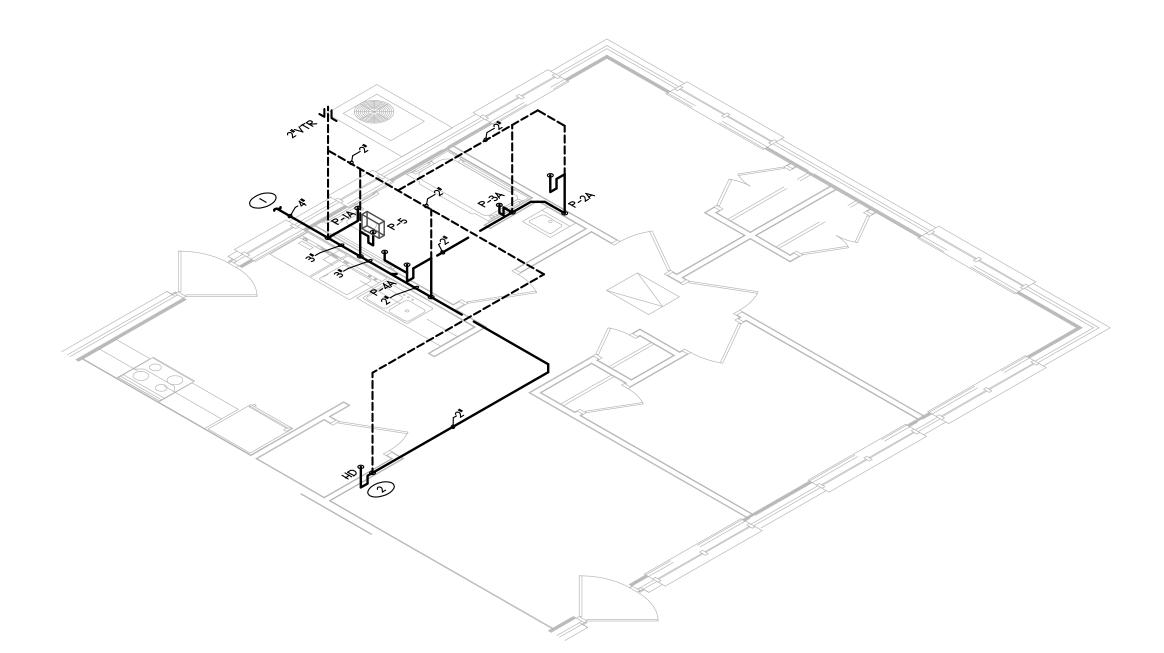


THREE BEDROOM HANDICAP UNIT - NC 15-3 WASTE RISER
NO SCALE


BUILDING TYPE 'C'

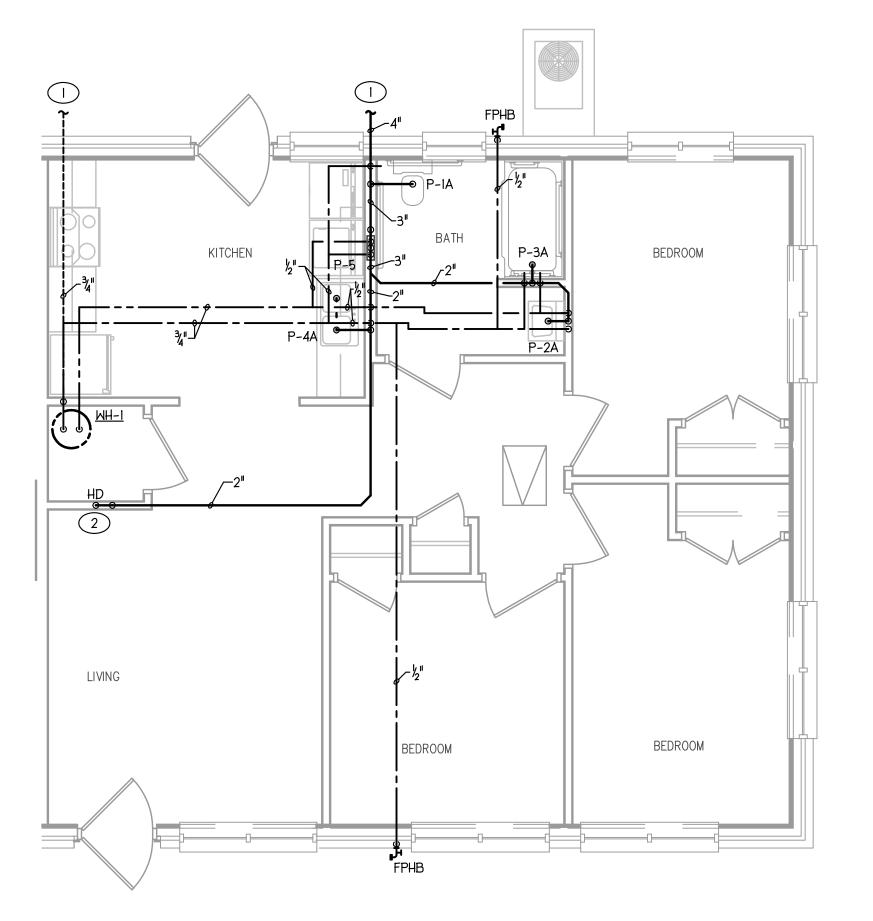

THREE BEDROOM HANDICAP UNIT - NC 15-3 BUILDING TYPE 'C' 1/4"=1'-0"



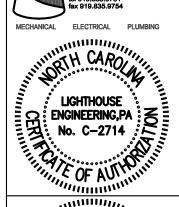

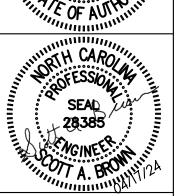



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Housing City

PLUMBING UNIT PLANS NC 15-3

COMM. NO.: 6041-B DRAWN BY: CHECKED BY: SAB DATE: APR. 2, 2024

SHEET NO. 6041B BID SET DRAWINGS - Page 99 of 142 °

- 2. THE CONTRACTOR SHALL SECURE AND PAY FOR ALL NECESSARY PERMITS, LICENSE, INSPECTIONS, APPROVALS, AND FEES.
- THE CONTRACTOR SHALL COORDINATE HIS WORK WITH ALL OTHER TRADES BEFORE INSTALLATION OF ANY MATERIALS OR EQUIPMENT.
- THESE DRAWINGS ARE DIAGRAMMATIC AND SHOW GENERAL LOCATION AND ARRANGEMENT OF ALL MATERIALS AND EQUIPMENT. THE DRAWINGS SHALL BE FOLLOWED AS CLOSELY AS BUILDING CONSTRUCTION AND ALL OTHER WORK WILL PERMIT.
- 5. DO NOT SCALE DRAWINGS FOR MEASUREMENTS.
- 6. ALL DUCT DIMENSIONS SHOWN ARE INTERIOR DUCT DIMENSIONS.
- ALL PENETRATIONS THROUGH EXTERIOR WALLS & ROOF SHALL BE FLASHED & COUNTERFLASHED IN A WATERPROOF MANNER (COLOR TO MATCH EXTERIOR).
- SEAL ALL PENETRATIONS OF RATED WALLS WITH FIRE DAMPER OR SEALANT MATERIAL APPROVED BY LOCAL CODE. TO BE INSTALLED PER MFG. INSTRUCTIONS.
- 9. ALL SUSPENDED MATERIALS AND EQUIPMENT SHALL BE INDIVIDUALLY SUPPORTED FROM THE BUILDING STRUCTURE. DO NOT SUSPEND ITEMS FROM THE CEILING OR ITS SUPPORT SYSTEM.
- 10. INSTALL ALL CONTROL DEVICES, INCLUDING THERMOSTATS AND SWITCHES, 4'-0" ABOVE FINISHED FLOOR FROM TOP OF DEVICE. PROVIDE THE REQUIRED DEVICE(S) FOR ALL SYSTEMS WHETHER LOCATED ON THE PLANS OR NOT.
- II. LOCATE CEILING DIFFUSERS IN ACCORDANCE WITH ARCHITECTURAL REFLECTED CEILING PLANS (IF PROVIDED).
- 12. PROVIDE MANUFACTURER'S RECOMMENDED CLEARANCES AROUND MECHANICAL UNITS FOR MAINTENANCE AND FILTER REMOVAL.
- 13. ALL PIPING AND DUCTWORK LOCATIONS SHALL BE COORDINATED W/ WORK UNDER OTHER DIVISIONS OF THE SPECIFICATIONS, TO AVOID INTERFERENCE.
- 14. ALL SUPPLY, RETURN AND OUTSIDE AIR DUCTS SHALL BE INSULATED AS FOLLOWS:

CONDITIONED SPACES R-6 MINIMUM NON-CONDITIONED SPACES R-8 MINIMUM

CONCEALED SHEET METAL DUCT MAY BE EXTERNALLY INSULATED WITH MINERAL FIBER BOARD OR BLANKET OR MAY BE INTERNALLY INSULATED WITH DUCT LINER. THE FIRST 15' FROM THE AIR HANDLER SHALL BE INTERNALLY

15. CERTIFIED TEST AND BALANCE CONTRACTOR SHALL BALANCE SYSTEM TO AIR QUANTITIES INDICATED ON PLANS AND PROVIDE OWNER'S REPRESENTATIVE WITH COMPLETE BALANCE REPORT. IF BALANCING DAMPERS ARE NOT PROVIDED IN RETURN DUCTWORK, CONTRACTOR SHALL BALANCE SUPPLY SIDE TO AIR QUANTITIES INDICATED ON PLANS AND SHALL BALANCE OUTSIDE AIR AND RETURN AIR FLOWS AT THE AIR HANDLER TO AIR QUANTITIES INDICATED IN THE SCHEDULE. PROVIDE NEW AIR FILTERS FOR EACH UNIT.

- 16. AS REQUIRED BY LOCAL CODES, MECHANICAL CONTRACTOR SHALL PROVIDE U.L. LISTED FIRE DAMPERS WHERE REQUIRED FOR FIRE PROTECTION REQUIREMENTS OF THE HVAC SYSTEM & THE UL ASSEMBLY.
- 17. PROVIDE I YEAR WARRANTY ON ALL EQUIPMENT AND 5 YEAR WARRANTY ON ALL COMPRESSORS.
- 18. ALL INTAKE OPENINGS SHALL BE LOCATED A MINIMUM OF 10'-0" FROM ALL EXHAUST LOCATIONS.
- CONDENSATE DRAIN PIPING AND FITTINGS SHALL BE SCHEDULE 40 PVC WHEN LOCATED IN NON-PLENUM LOCATIONS. PIPING TO BE SCHEDULE 40 CPVC RATED FOR PLENUM INSTALLATION OR PVC WRAPPED WITH PLENUM RATED INSULATION WHEN LOCATED IN PLENUM LOCATIONS. DRAINS FROM AIR HANDLING UNITS SHALL BE TRAPPED.
- 20. A COMPLETE SYSTEM OF SEISMIC RESTRAINTS SHALL BE DESIGNED BY MASON INDUSTRIES & SEALED BY THEIR REGISTERED ENGINEER & INSTALLED BY THIS CONTRACTOR, AS REQ'D BY APPLICABLE CODES FOR THE LOCALE OF THIS PROJECT.
- 21. ALL MAIN DUCTWORK SHALL BE GALVANIZED SHEET METAL OR I" FIBERBOARD CONSTRUCTED IN ACCORDANCE WITH SMACNA STANDARDS. RUN OUTS FOR THE MAIN/BRANCH DUCTS MAY BE FLEX DUCT CONFORMING TO THE REQUIREMENTS OF UL 181 FOR CLASS I FLEXIBLE AIR DUCTS.
- 22. THE MECHANICAL CONTRACTOR SHALL PROVIDE REFRIGERANT AND LOW VOLTAGE CONTROL LINES FROM THE CONDENSER(S) TO THE AIR HANDLING UNIT(S). COORDINATE ROUTING AND INSTALLATION WITH THE GENERAL CONTRACTOR. SIZE REFRIGERANT LINES PER MANUFACTURER'S REQUIREMENTS.
- 23. ELECTRICAL CONTRACTOR TO PROVIDE ALL HIGH VOLTAGE ELECTRICAL WIRING, CONDUIT, DISCONNECT SWITCHES, FUSES, ETC. TO SPLIT SYSTEM UNIT(S). ALL FINAL ELECTRICAL CONNECTIONS ARE BY ELECTRICAL CONTRACTOR.
- 24. OUTSIDE AIR DUCTWORK SHALL BE WRAPPED WITH 12" FIBERGLASS DUCT WRAP WITH VAPOR BARRIER.
- 25. REFRIGERANT PIPING, NOT SHOWN ON PLANS, SHALL BE SIZED \$ INSTALLED IN ACCORDANCE WITH THE MANUFACTURER'S RECOMMENDATIONS, INSTALLATION INSTRUCTIONS AND LOCAL CODES.
- 26. MECHANICAL CONTRACTOR SHALL VERIFY LOCATION OF ALL PENETRATIONS FOR RELIEF HOODS, OUTSIDE AIR HOODS, LOUVERS, AND WALL CAPS WITH ARCHITECT & OWNER PRIOR TO INSTALLATION.
- 27. MECHANICAL CONTRACTOR SHALL PAINT ALL RELIEF HOODS, INTAKE HOODS, LOUVERS, AND VENT CAPS. CONFIRM COLOR WITH ARCHITECT & OWNER PRIOR TO INSTALLATION.
- 28. PENETRATIONS OF RATED WALLS, PARTITIONS AND FLOORS OF NON-COMBUSTIBLE CONSTRUCTION SHALL BE FIRESTOPPED WITH NONCOMBUSTIBLE MATERIALS. PENETRATIONS OF NONRATED WALLS, PARTITIONS AND FLOOR OF COMBUSTIBLE CONSTRUCTION SHALL BE FIRESTOPPED WITH MATERIALS EQUIVALENT TO TWO INCHES OF WOOD. FIRESTOPPING SHALL COMPLY WITH ASTM E-814.
- 29. ALL CUTTING AND PATCHING OF WALLS AND FLOORS FOR MECHANICAL EQUIPMENT SHALL BE THE RESPONSIBILITY OF THE MECHANICAL CONTRACTOR.

SPLIT SYSTEM HEAT PUMP UNIT SCHEDUL	E
-------------------------------------	---

	AIR HANDLING UNIT DATA											HEAT PUMP										
			FAN DATA			COOLING HEAT AUX.			ELECTRICAL DATA				GE	NERAL DAT	Ä		ELECTRICAL DATA					
UNIT TAG	AREA SERVED	MANUF. MODEL	FAN CFM	ESP (" OF WG)	MOTOR (HP)	OA (CFM)	TOTAL (MBH)	SENS. (MBH)	TOTAL (MBH)	HEAT (KW@240)	VOLTAGE (V/PH)	MCA (A)	MOCP (A)	UNIT TAG	MANUF. MODEL	TONNAGE	SEER 2	HSPF 2	VOLTAGE (V/PH)	MCA (A)	MOCP (A)	NOTES
AH-I	UNITS	CARRIER FMA4XI800	500-700	0.50 <sup>II</sup>	1/3	NOTE II	18.0	14.4	10.2	5	240/1¢	28.5	30	HP-1	CARRIER GH5SAN418	1.5	15.2	7.8	240/1¢	13.4	20	1–14
AH-2	UNITS	CARRIER FMA4X2400	800	0.52 <sup>II</sup>	1/3	NOTE II	24.0	19.2	14.4	5	240/1¢	28.5	30	HP-2	CARRIER GH5SAN424	2.0	15.2	7.5	240/1¢	14.5	25	1–14
AH-3	UNITS	CARRIER FMA4X3000	950	0.53 <sup>II</sup>	1/2	NOTE II	30.0	24.0	17.2	7.5	240/1¢	42.5	50	HP-3	CARRIER GH5SAN430	2.5	15.2	8.1	240/1¢	18.2	30	1-14

- 1. COOLING CAPACITIES ARE RATED IN ACCORDANCE WITH ARI STANDARD 210/240 AT 95°F AMBIENT OUTDOOR AIR TEMP. 80°F DRY BULB, 67°F WET BULB ENTERING AIR TEMP., AND AIR QUANTITY LISTED BY MFG. UNITS ABOVE 5 TONS ARE RATED IN ACCORDANCE WITH ARI STANDARD 340.
- 2. REFRIG. PIPING TO BE SIZED PER TOTAL INSTALL. EQUIV. LENGTH. LONG-LINE APP.TO BE PROVIDED PER MFG. GUIDELINES WHEN REQUIRED. MC TO CONFIRM ALL LENGTHS WILL MEET MFG. REQUIREMENTS BEFORE INSTALLATION.
- 3. PROVIDE SINGLE POINT ELECTRICAL CONNECTION FOR AIR HANDLING UNIT.
- 4. PROVIDE NEW FILTER IN EACH UNIT AT TURNOVER TO OWNER.
- 5. SYSTEMS SHALL HAVE A MINIMUM 14.3 SEER2 AND 7.5 HSPF2 RATING.
- 6. PROVIDE HONEYWELL FOCUSPRO 5000 TH5220DI003 THERMOSTAT OR EQUAL.
- 7. PROVIDE BI-FLOW TXV FOR HEAT PUMP OPERATION.
- 8. AHU TO USE UPFLOW APPLICATION.

- 9. RETURN AIR THROUGH GRILLE.
- 10. DRAIN CONDENSATE TO HUB DRAIN.
- II. OUTSIDE AIR PROVIDED BY NATURAL VENTILATION AND INFILTRATION.
- 12. OUTDOOR THERMOSTAT TO LOCK-OUT ELECTRIC HEAT WHEN TEMPERATURE IS 40°F OR HIGHER. PROVIDE UNIT WITH EMERGENCY HEAT OVERRIDE OPTION.
- 13. LOW AMBIENT KIT DOWN TO 0°F.
- 14. CATALOG NUMBERS AND MANUFACTURERS ARE TO INDICATE TYPE AND QUALITY OF UNIT DESIRED. SUBMIT CUTSHEETS OF THESE AND ALTERNATE MANUFACTURERS FOR ARCHITECT AND OWNER APPROVAL PRIOR TO PURCHASE OF ANY UNITS. INFORMATION ON ALTERNATE UNITS PROPOSED BY THE CONTRACTOR SHALL INCLUDE THE ADD/DEDUCT ASSOCIATED WITH ACCEPTANCE OF THAT UNIT (OR THE ALTERNATE PACKAGE AS A WHOLE).

FAN SCHEDULE											
UNIT NO.	SERVICE	AREA SERVED	CFM	S.P.	RPM	TYPE \$ ARRANGEMENT	MIN. MOTOR HP \$ VOLTAGE	MANUFACTURER \$ MODEL NO.	DRIVE	CONTROL SCHEME	REMARKS
EF-I	EXHAUST	UNITS	80	0.10"	MFG	CEILING	26.9 WATTS/0.5 A 120/1¢	BROAN MODEL AE80SL	DIRECT	А	1-6

- 4. INTEGRAL DISCONNECT SWITCH SCREEN
- 2. BACKDRAFT DAMPER 5. HUMIDITY SENSING
- 3. COLOR BY ARCHITECT 6. INTEGRAL LIGHT

CONTROL OPTIONS:

A. CONTROL W/ ROOM LIGHTS AND

HUMIDITY SENSORS.


DIFFUSER SCHEDULE MODULE FRAME MANUFACTURER SYMBOL CFM PATTERN DAMPER MATERIAL SERVICE FINISH NOTES SIZE SIZE TYPE # MODEL NO. AS NOTED | AS NOTED | AS NOTED | SURFACE | 2-WAY YES |ALUMINUM| SUPPLY HART & COOLEY A682 1-3 TRANSFER/ AS NOTED | AS NOTED | AS NOTED | SURFACE | FIX BLD. |ALUMINUM| HART & COOLEY A650 1-3 RETURN STEEL HART & COOLEY 659 AS NOTED | AS NOTED | 12x12 SURFACE | FIX BLD. NO ACCESS NOTE 2


- I. DIFFUSER DESIGNATIONS ON PLANS AS FOLLOWS: DIFFUSER OR
  - NECK SIZE. 8x4 — DIFFUSER TYPE AS NOTED ABOVE AIR QUANTITY
- 2. FINISH TO MATCH / BE ABLE MATCH CEILING OR WALL OR DOOR.
- 3. FACTORY INSULATION BACKING ON GRILLES EXPOSED TO NON-CONDITIONED AREAS. ALTERNATELY, FIELD SUPPLY AND INSTALL.
- 4. HINGED ACCESS GRILLE TO BE ALUMINUM IF PREFERRED BY OWNERSHIP.

MECI	HANICAL LEGEND
18x14	RECTANGULAR DUCT
60	ROUND METAL DUCT
+ 60 +	FLEXIBLE ROUND DUCT
LANCE TO THE PARTY OF THE PARTY	ELBOW WITH TURNING VANES
	SUPPLY TAP
	SUPPLY DIFFUSER/GRILLE OR RISER
	RETURN REGISTER/GRILLE OR RISER
<b>—</b>	SIDEWALL DIFFUSER/GRILLE
	CEILING EXHAUST FAN
T	T-STAT
<del>∐-</del>	I" DOOR UNDER CUT

	Drawing Sheet List
#	Title
M0.0	MECHANICAL NOTES, SCHEDULES, & LEGEND
M0.1	MECHANICAL DETAILS
M1.0	MECHANICAL BUILDING 1 PLANS NC 15-1
M1.1	MECHANICAL BUILDING 2 & 3 PLANS NC 15-1
M1.2	MECHANICAL BUILDING 4 & 5 PLANS NC 15-1
M1.3	MECHANICAL BUILDING 6 & 7 PLANS NC 15-1
M1.4	MECHANICAL BUILDING 8 & 9 PLANS NC 15-1
M1.5	MECHANICAL BUILDING 14 PLANS NC 15-1
M1.6	MECHANICAL BUILDING 15 PLANS NC 15-1
M2.0	MECHANICAL UNIT PLANS NC 15-1
M2.1	MECHANICAL UNIT PLANS NC 15-1
M3.0	MECHANICAL UNIT PLANS NC 15-1
M3.1	MECHANICAL UNIT PLANS NC 15-1
M4.0	MECHANICAL UNIT PLANS NC 15-1
M4.1	MECHANICAL UNIT PLANS NC 15-1
M10.0	MECHANICAL BUILDING C & C-A PLANS NC 15-3
M11.0	MECHANICAL UNIT PLANS NC 15-3
M12.0	MECHANICAL UNIT PLANS NC 15-3
M12.1	MECHANICAL UNIT PLANS NC 15-3



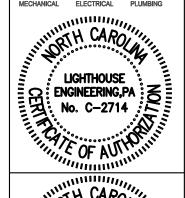

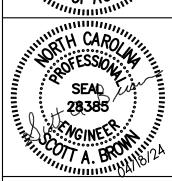

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MECHANICAL NOTES, SCHEDULES, & LEGEND

COMM. NO.: 6041-B DRAWN BY: CHECKED BY: SAB DATE: APR. 2, 2024

SHEET NO.

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. Floor-Ceiling Assembly -- The 1 hr fire-rated solid or trussed lumber joist floor-ceiling assembly shall be constructed of the materials and in the manner specified in the individual L500 Series Floor-Ceiling Designs in the UL Fire Resistance Directory. The general construction features of the floor-ceiling assembly are summarized below:

A. Flooring System -- Lumber or plywood subfloor with finish floor of lumber, plywood or Floor Topping Mixture\* as specified in the individual Floor-Ceiling Design. Max diam of opening shall be 5 in.

B. Wood Joists\* -- Nom 10 in. deep (or deeper) lumber, steel or combination lumber and steel joists, trusses or Structural Wood Members\* with bridging as required and with ends firestopped.

C. Gypsum Board\* -- Nom 4 ft wide by 5/8 in. thick as specified in the individual Floor-Ceiling Design. Gypsum board secured to wood joists or furring channels as specified in the individual Floor-Ceiling Design.

A. Chase Wall -- (Optional, Not Shown) - The through penetrants (Item 2) may be routed through a 1 hr fire rated single, double or staggered wood stud/gypsum board chase wall. Depth of chase wall stud cavity to be min 1/2 in. greater than diameter of opening cut in sole and top plates to accommodate the through penetrant (Item 2). The chase wall shall be constructed of the materials and in the manner specified in the individual U300 Series Wall and Partition Designs in the UL Fire Resistance Directory and shall include the following construction features: A. Studs -- Nom 2 by 4 in., 2 by 6 in. or double nom 2 by 4 in. lumber studs.

B. Sole Plate -- Nom 2 by 4 in., 2 by 6 in. or parallel 2 by 4 in. lumber plates, tightly butted. Max diam of opening is 5 in.

C. Top Plate -- The double top plate shall consist of two nom 2 by 4 in., two nom 2 by 6 in. or two sets of parallel 2 by 4 in. lumber plates, tightly butted. Max diam of opening is 5 in.

D. Gypsum Board\* -- Thickness, type, number of layers and fasteners shall be as specified in the individual Wall and Partition Design.

2. Through Penetrants -- One or more pipes, conduits, tubing and cables to be installed concentrically or eccentrically within the opening. The space between any penetrant, except nonmetallic pipes and uninsulated metallic pipes to be min 0 in. (point contact) to max 1 in. The space between any penetrants and the periphery of the opening shall be min 0 in. (point contact) to max 1 in. Pipes, conduits, tubing and cables to be rigidly

supported on both sides of floor-ceiling assembly. A. Metallic Penetrants -- One or more metallic pipes, conduits or tubing to be installed within the firestop system. The following types and sizes

of metallic pipes, conduits or tubing may be used: A1. Steel Pipe -- Nom 3/4 in. diam (or smaller) Schedule 10 (or heavier) steel pipe.

A2. Conduit -- Nom 3/4 in. diam (or smaller) steel electrical metallic tubing (EMT) or 3/4 in. diam galv steel conduit.

A3. Copper Tube -- Nom 3/4 in. diam (or smaller) Type L (or heavier) copper tube. A4. Copper Pipe -- Nom 3/4 in. diam (or smaller) Regular (or heavier) copper pipe.

B. Tube Insulation - Plastics+ -- Nom 3/4 in. thick acrylonitrile butadiene/polyvinyl chloride (AB/PVC) flexible foam furnished in the form of

tubing. Tube insulation to be installed on one or more of the metallic pipes or tubes (Item 2A).

See Plastics+ (QMFZ2) category in the Plastics Recognized Component Directory for names of manufacturers. Any Recognized Component tube insulation material meeting the above specifications and having a UL 94 Flammability Classification of 94-5VA may be

C. Nonmetallic Through Penetrants -- One nonmetallic pipe to be installed within the firestop system. Pipe shall be spaced a min 1-1/2 in. from

non-uninsulated metallic through penetrants. The following types and sizes of metallic pipes may be used: C1. Polyvinyl Chloride (PVC) Pipe -- Nom 1-1/4 in. diam (or smaller) Schedule 40 solid core PVC pipe for use in closed (process or supply)

or vented (drain, waste or vent) piping system. C2. Chlorinated Polyvinyl Chloride (CPVC) Pipe -- Nom 1-1/4 in. diam (or smaller) SDR13.5 CPVC pipe for use in closed (process or

D. Cables -- Max of two 4 pair No. 18 AWG (or smaller) cable with PVC insulation and jacket materials.

3. Fill, Void or Cavity Materials\* - Sealant -- Min ¾ in. thickness of sealant applied within the annulus flush with the top surface of the floor or sole plate and min 5/8 in. thickness of sealant applied within the annulus flush with the bottom surface of gypsum board or top plate. A min ¼ in. diameter bead of sealant applied at the bundle/subflooring or sole plate interface and the bundle/gypsum board or top plate interface at point contact locations.

HILTI CONSTRUCTION CHEMICALS, DIV OF

HILTI INC -- FS-ONE Sealant

\*Bearing the UL Classification Mark +Bearing the UL Recognized Component Mark


FIRESTOP SYSTEMS

Reproduced by HILTI, Inc. Courtesy of Underwriters Laboratories, Inc. October 9, 2002



**SECTION A-A** 



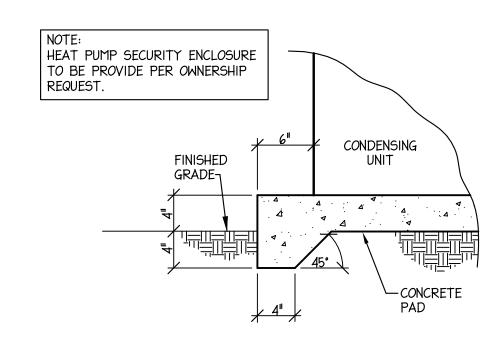

HEAT PUMP UNIT PAD DETAIL

- RECTANGULAR MAIN

SUPPLY AIR DUCT.

FLARED SHOULDER \$

- SPIN IN COLLAR W/

INTEGRAL SCOOP.

- FLEX DUCT DIAMETER "D"

CIRCULAR CLAMP

FINISHED - CEILING SURFACE

SUPPLY AIR DIFFUSER WITH ROUND

FOR FRAME TYPE. CONFIRM CEILING

SUPPLY AIR DIFFUSER DETAIL


NECK. SEE DIFFUSER SCHEDULE

TYPE ON ARCHITECTURAL PLANS.

I. SEE HVAC GENERAL NOTES FOR DUCT INSULATION REQUIREMENTS.

ROUND SHEET

METAL DUCT.

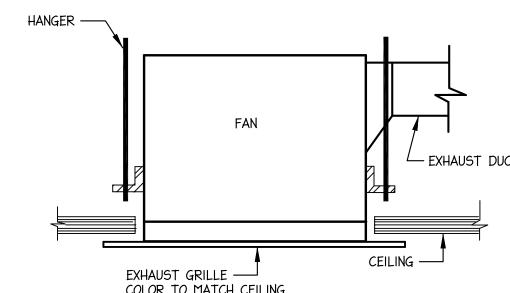

EXHAUST FAN DETAIL - NON-RATED CEILING NO SCALE

-REDUCER OR

NECESSARY)


VOLUME

DAMPER IN


DIFFUSER NECK.

SQUARE TO ROUND

TRANSITION (IF

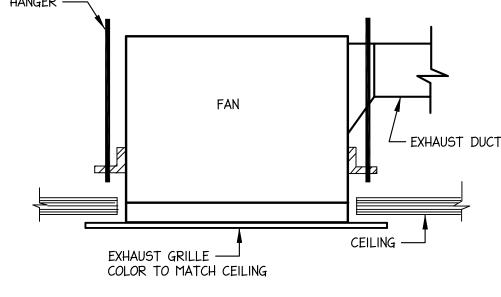

5. ONE 2x6 BLOCK ON BOTTOM PLATE 6. 2x4 BLOCKING RECESSED METAL BOX FOR DRYER EXHAUST

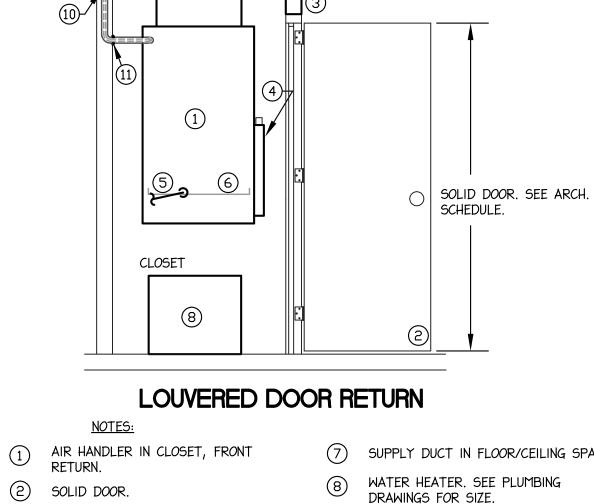

RESIDENTIAL DRYER

4" DRYER VENT

4. DRYER FLEX HOSE

RECESSED METAL BOX (18"x14"x51/2")

3 RA GRILLE HIGH ON SIDEWALL

FILTER RACK FOR I" THROW-AWAY (PROVIDE FILTER)

5 3/4" DRAIN FROM AH CONDENSATE TO HUB DRAIN. (THIS CONNECTION MUST BE IN A VISIBLE LOCATION.)

MICROFLOAT SWITCH LOCATED IN PRIMARY DRAIN DRAIN PAN AT A POINT HIGHER THAN PRIMARY DRAIN LOCATION. INTERLOCK FLOAT SWITCH W/ A.H.

(7) SUPPLY DUCT IN FLOOR/CEILING SPACE.

WATER HEATER. SEE PLUMBING

(9) REFRIGERANT LINE SET

APPROVED FIRE STOP SEALANT (RATED

FLOOR/CEIL. ASSEMBLIES ONLY) NON-HARDENING SEALANT AROUND ALL

CLOSET PENETRATIONS

, UNIT AIR HANDLER DETAIL







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MECHANICAL

COMM. NO.: 6041-B DRAWN BY: CHECKED BY: SAB DATE: APR. 2, 2024 SHEET NO.

DETAILS

HP-3

Stogner
ARCHITECTURE - CON
615 East Broad Aven
Phone 910-895-


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MECHANICAL BUILDING 1 PLANS NC 15-1

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BUILDING 1 - NC 15-1 1/8"=1'-0" FAIRVIEW CIRCLE



Stogner
ARCHITECTURE - CON
615 East Broad Aven
Phone 910-895-

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MECHANICAL BUILDING 2 & 3 PLANS NC 15-1
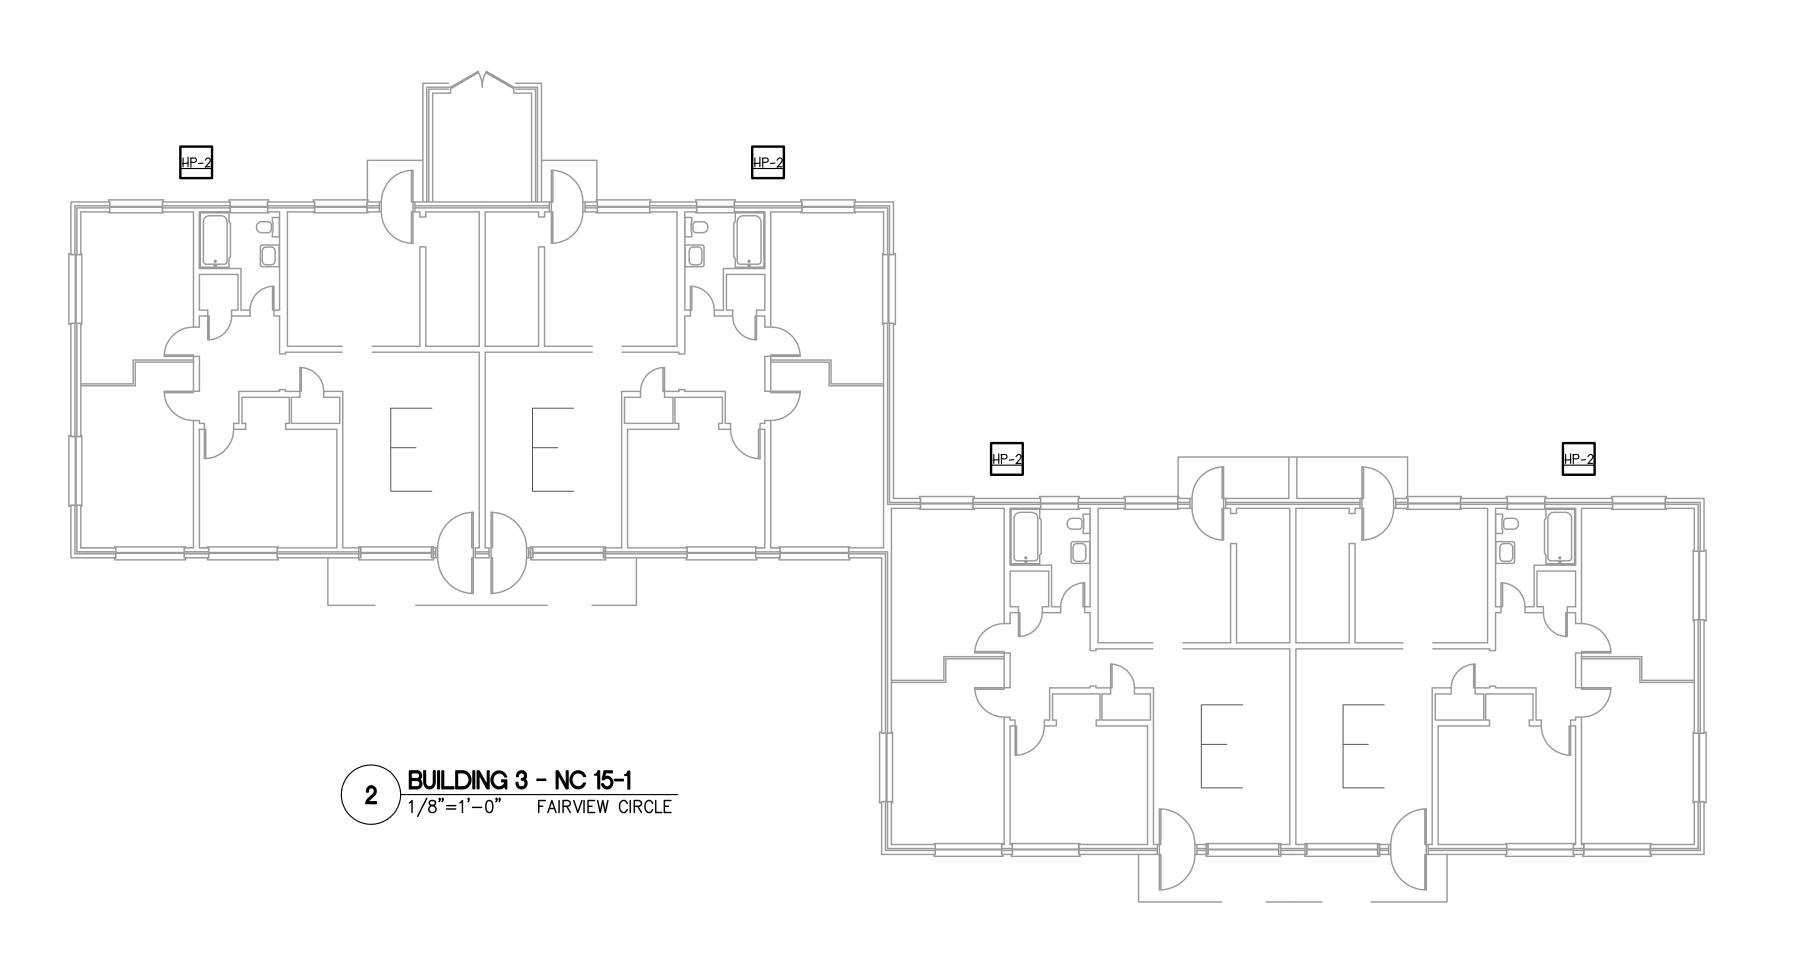
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St ARCH: 615 1 Pho

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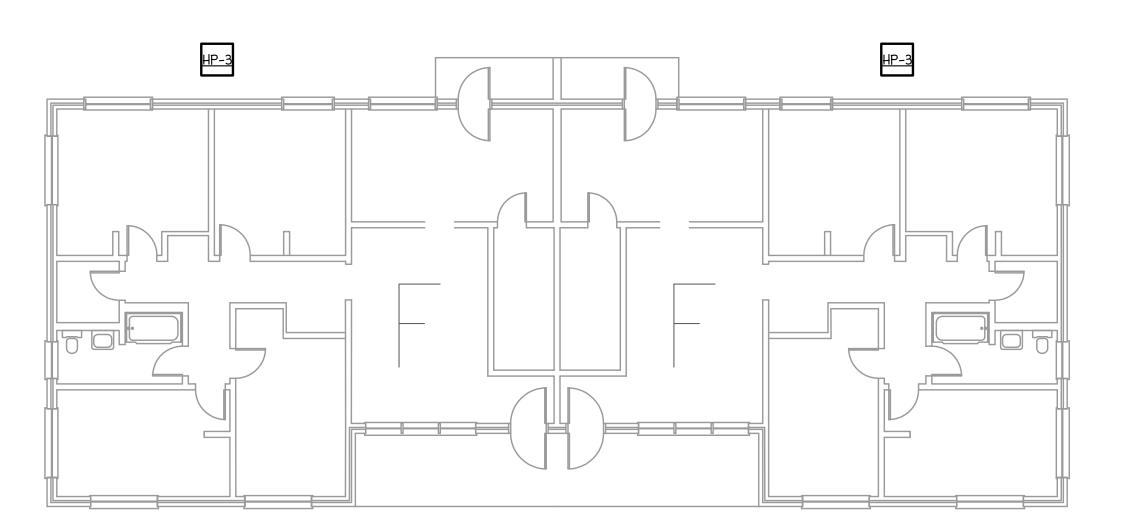
Housing City

MECHANICAL BUILDING 4 & 5 PLANS NC 15-1

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BUILDING 7 - NC 15-1 1/8"=1'-0" FAIRVIEW CIRCLE

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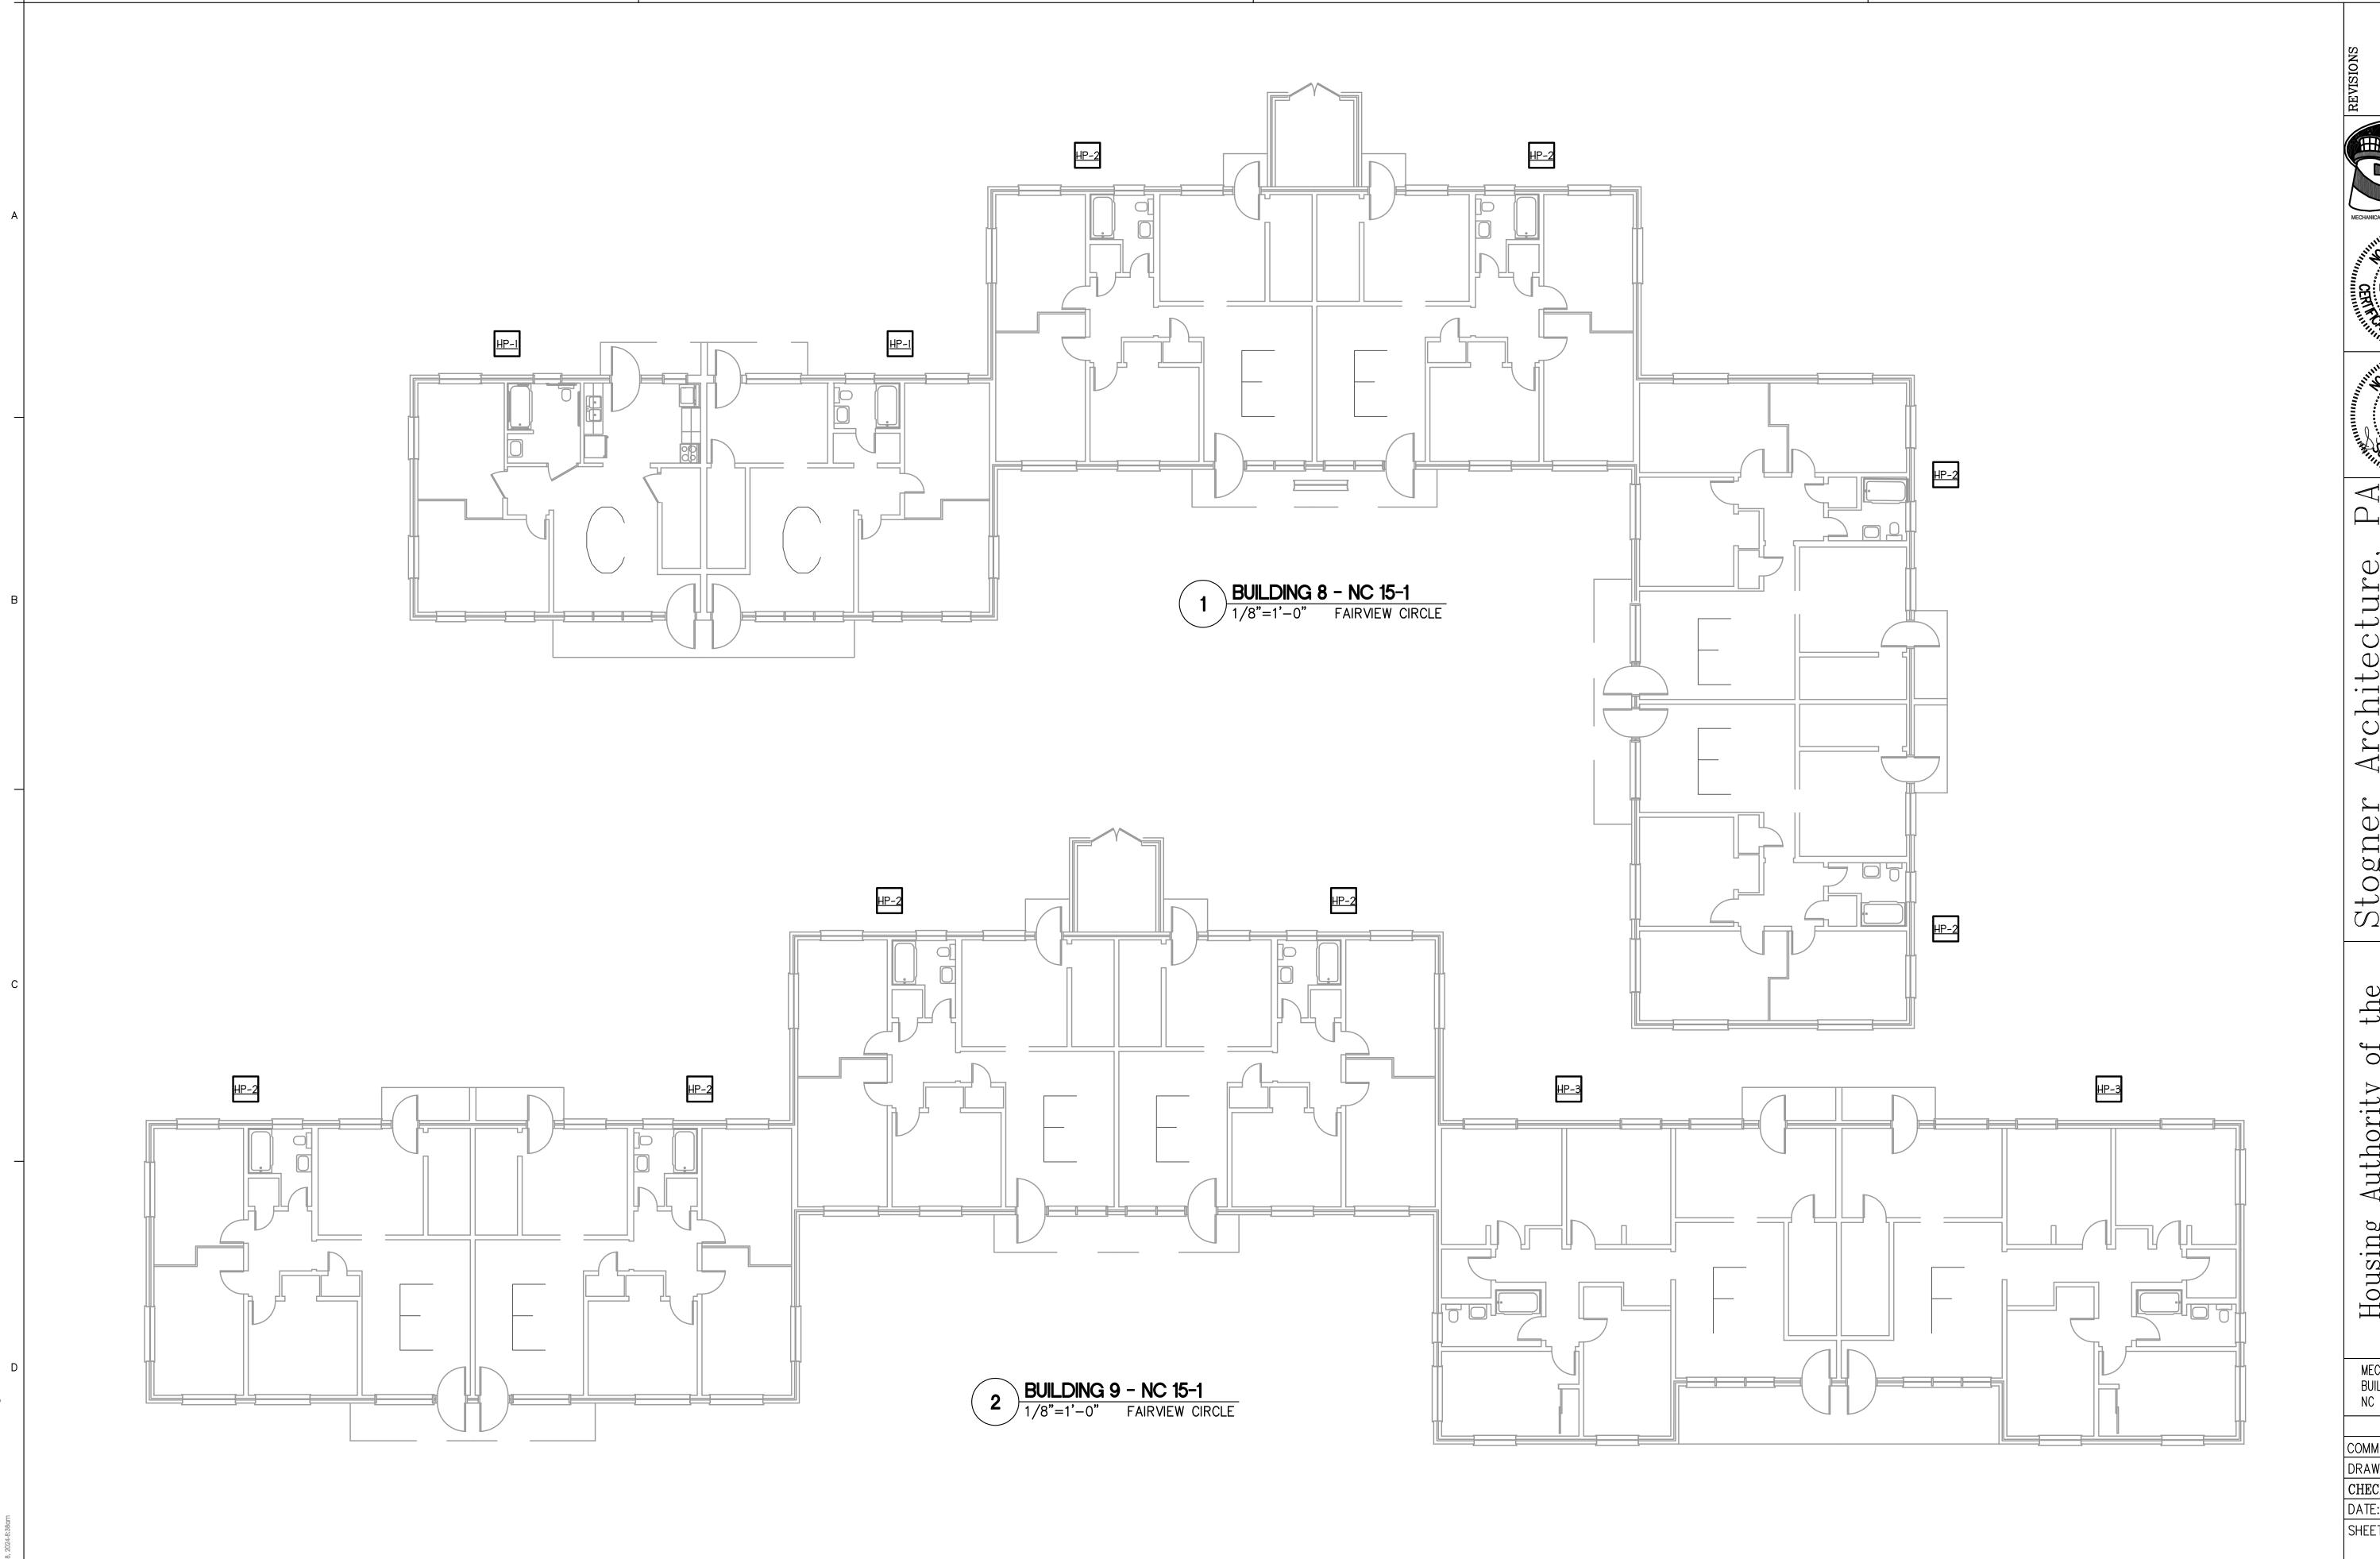
St ARCH: 615 1 Pho Authority of of Goldsboro

Housing City

MECHANICAL BUILDING 6 & 7 PLANS NC 15-1

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MECHANICAL BUILDING 8 & 9 PLANS NC 15-1

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MECHANICAL BUILDING 14 PLANS NC 15-1

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MECHANICAL BUILDING 15 PLANS NC 15-1

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SHEET NO. 6041B BID SET DRAWINGS - Page 108 of 142 2. AIR HANDLER RETURN THROUGH LOUVER ABOVE DOOR. INSTALL GRILLE ON WALL ABOVE DOOR CLOSE TO CEILING. CONFIRM WITH ARCHITECT WHICH DIRECTION BLADES ARE FACING BEFORE INSTALLATION. GRILLE MAY ALSO BUT USED AS ACCESS TO DAMPER IN DUCT IF REQUIRED. GRILLE NOT TO EXCEED A VELOCITY OF 500 FPM. TYPICAL SIZING GUIDLINES ARE AS FOLLOWS BUT SHOULD BE CONFIRMED WITH MFG PERFORMANCE DATA BEFORE INSTALLATION.

> 1.5 TON UNIT = 30x122.0 TON UNIT = 30x122.5 TON UNIT = 30x14

- 3.  $\frac{3}{4}$  CONDENSATE DRAIN ROUTED TO HUB DRAIN (HD BY PC) IN MECH. CLOSET. REFER TO PLUMBING RISERS. COORDINATE W/ DUCTS, G.C., FRAMING CONTR., STRUCTURE, ETC.
- 4. SUPPLY AIR PLENUM OFF AIR HANDLING UNIT SHALL BE MIN. 4 LONG. TYPICAL ALL UNITS.
- 5. SUPPLY AIR DUCT TRUNK TO RUN BETWEEN JOISTS. CONFIRM DIRECTION OF JOISTS DURING CONSTRUCTION AND ROTATE TRUNK 90° IF REQUIRED.
- 6. M.C. TO PROVIDE RECESSED BOX FOR DRYER VENT CONNECTION (BOX MUST BE APPROPRIATELY FIRE RATED IF INSTALLED IN A RATED WALL). MOUNT DRYER BOX AT 6" A.F.F FOR FLOOR MOUNTED DRYER. 40 DRYER VENT TO RUN FROM TOP OF DRYER BOX UP INTO FLOOR/CEILING ASSEMBLY ABOVE.
- 7. DRYER VENT PIPE SHALL BE 40 SINGLE WALL RIGID SHEETMETAL PER MECH. CODE. AT ROOF TERMINATION, M.C. TO PROVIDE 40 DRYER VENT ROOF CAP WITH BACKDRAFT DAMPER \$ TO CAULK BEHIND CAP WITH 100% SILICONE.
- 8. BATHROOM EXHAUST DUCT SHALL BE 40 SINGLE WALL RIGID SHEETMETAL. AT ROOF TERMINATION, M.C. TO PROVIDE 40 VENT CAP WITH BACKDRAFT DAMPER & INSECT SCREEN & TO CAULK BEHIND CAP WITH 100% SILICONE.
- 9. ALL BATHROOM DOORS TO HAVE UNDERCUTS FOR AIR TRANSFER.
- 10. ALL ROOMS WITH SUPPLY AIR TO HAVE I" DOOR UNDERCUTS FOR RETURN.
- II. AN APPROVED RECIRCULATING RANGE HOOD IS TO BE INSTALLED ABOVE KITCHEN RANGE.
- 12. PROVIDE TRANSFER GRILLES FOR MAKE-UP AIR TO DRYER CLOSET AS SHOWN. MIN. FREE AREA OF 120 SQIN IS REQUIRED. INSTALL GRILLES HIGH ON WALL.
- 13. CEILINGS IN DWELLING UNITS ARE NOT RATED. LIFE SAFETY DAMPERS ARE NOT REQUIRED AT NON-RATED CEILING PENETRATIONS.

#### NATURAL VENTILATION CALCULATIONS TWO BEDROOM UNIT - NC 15-1 **BUILDING TYPE 'C'**

570 SQFT 114 SQFT FLOOR AREA OPERABLE EXTERIOR OPENINGS

OPERABLE OPENING AREA % 20.0% > 4%

#### **DRYER VENT CALCULATIONS** TWO BEDROOM UNIT - NC 15-1 **BUILDING TYPE 'C'** LOWER FLOOR Vertical Run ( Horizontal Run (1 TOTAL LINEAR LENGTH (ft) # of 45° Elbows (2.5ft each

Equiv. Length (ft) Per 2018 NCMC 504.8.4.1 NOTE: M.C. IS TO PROVIDE AND INSTALL PERMANENT SIGNS WITHIN 6 FT OF EACH EXHAUST DUCT CONNECTION WHICH STATE THE LINEAR DUCT LENGTH AND NUMBER OF ELBOWS FOR THE

DUCT FITTING EQUIVALENT LENGTH (ft)

DRYER VENT RUN AS INSTALLED. EQUIVALENT LENGTH CALCULATIONS ARE BASED ON 2018 NCMC SECTION 504.8.4.1 AND ARE PROVIDED FOR CODE COMPLIANCE ONLY. WHEN USING ALTERNATE COMPLIANCE OF MFG INSTRUCTIONS, CALCULATIONS SHOULD BE BASED ON MFG EQUIVALENT LENGTH CALCULATIONS AND NOT THIS TABLE.

#### TAGGED NOTES


( ) CLOSET CEILING TO BE DROPPED TO FACILITATE RETURN AIR GRILLE AND ASSOCIATED DUCT BACK INTO CLOSET HIGH ON WALL. PROVIDE MINIMUM 20x8 DUCT OFF OF BACK OF GRILLE FOR RETURN

(2) PROVIDE 12x12 GRILLE TYPE 'C' WITHOUT A FILTER, FOR ACCESS TO HUB DRAIN IN WALL.


3 AIR HANDLER AND WATER HEATER TO BE LOCATED AT OPPOSITE ENDS OF MECHANICAL CLOSET PER OWNER REQUEST.


#### HATCH LEGEND

INDICATES DROPPED CEILING THIS AREA.

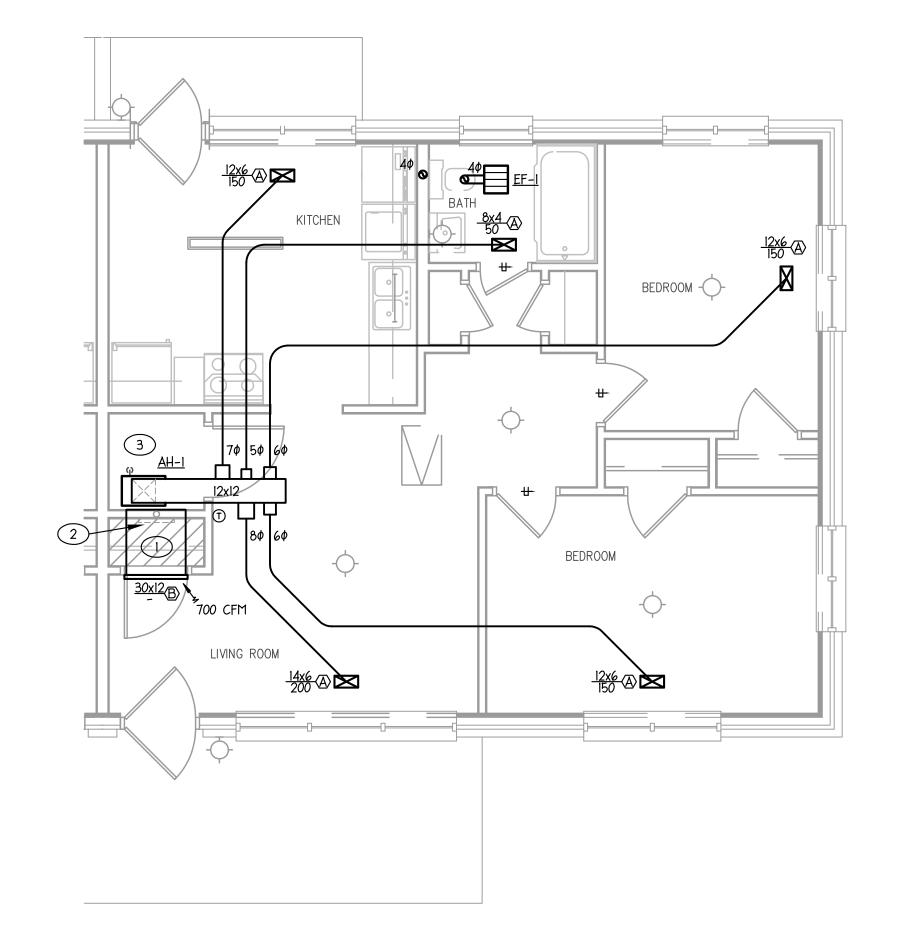



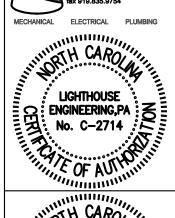

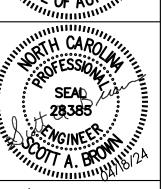

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MECHANICAL UNIT PLANS NC 15-1

COMM. NO.: 6041-B DRAWN BY: CHECKED BY: SAB DATE: APR. 2, 2024 SHEET NO.

6041B BID SET DRAWINGS - Page 109 of 142°

2. AIR HANDLER RETURN THROUGH LOUVER ABOVE DOOR. INSTALL GRILLE ON WALL ABOVE DOOR CLOSE TO CEILING. CONFIRM WITH ARCHITECT WHICH DIRECTION BLADES ARE FACING BEFORE INSTALLATION. GRILLE MAY ALSO BUT USED AS ACCESS TO DAMPER IN DUCT IF REQUIRED. GRILLE NOT TO EXCEED A VELOCITY OF 500 FPM. TYPICAL SIZING GUIDLINES ARE AS FOLLOWS BUT SHOULD BE CONFIRMED WITH MFG PERFORMANCE DATA BEFORE INSTALLATION.

1.5 TON UNIT = 30x12 2.0 TON UNIT = 30x12 2.5 TON UNIT = 30x14

- 3. 3/4 CONDENSATE DRAIN ROUTED TO HUB DRAIN (HD BY PC) IN MECH. CLOSET. REFER TO PLUMBING RISERS. COORDINATE W/DUCTS, G.C., FRAMING CONTR., STRUCTURE, ETC.
- 4. SUPPLY AIR PLENUM OFF AIR HANDLING UNIT SHALL BE MIN. 4' LONG. TYPICAL ALL UNITS.
- 5. SUPPLY AIR DUCT TRUNK TO RUN BETWEEN JOISTS. CONFIRM DIRECTION OF JOISTS DURING CONSTRUCTION AND ROTATE TRUNK 90° IF REQUIRED.
- 6. M.C. TO PROVIDE RECESSED BOX FOR DRYER VENT CONNECTION (BOX MUST BE APPROPRIATELY FIRE RATED IF INSTALLED IN A RATED WALL). MOUNT DRYER BOX AT 6" A.F.F FOR FLOOR MOUNTED DRYER. 40 DRYER VENT TO RUN FROM TOP OF DRYER BOX UP INTO FLOOR/CEILING ASSEMBLY ABOVE.
- 7. DRYER VENT PIPE SHALL BE 4¢ SINGLE WALL RIGID SHEETMETAL PER MECH. CODE. AT ROOF TERMINATION, M.C. TO PROVIDE 4¢ DRYER VENT ROOF CAP WITH BACKDRAFT DAMPER ¢ TO CAULK BEHIND CAP WITH 100% SILICONE.
- 8. BATHROOM EXHAUST DUCT SHALL BE 4Φ SINGLE WALL RIGID SHEETMETAL. AT ROOF TERMINATION, M.C. TO PROVIDE 4Φ VENT CAP WITH BACKDRAFT DAMPER ¢ INSECT SCREEN ¢ TO CAULK BEHIND CAP WITH 100% SILICONE.
- 9. ALL BATHROOM DOORS TO HAVE UNDERCUTS FOR AIR TRANSFER.
- 10. ALL ROOMS WITH SUPPLY AIR TO HAVE I" DOOR UNDERCUTS FOR RETURN.
- II. AN APPROVED RECIRCULATING RANGE HOOD IS TO BE INSTALLED ABOVE KITCHEN RANGE.
- 12. PROVIDE TRANSFER GRILLES FOR MAKE-UP AIR TO DRYER CLOSET AS SHOWN. MIN. FREE AREA OF 120 SQIN IS REQUIRED. INSTALL GRILLES HIGH ON WALL.
- 13. CEILINGS IN DWELLING UNITS ARE NOT RATED. LIFE SAFETY DAMPERS ARE NOT REQUIRED AT NON-RATED CEILING PENETRATIONS.

## NATURAL VENTILATION CALCULATIONS TWO BEDROOM HC UNIT - NC 15-1

BUILDING TYPE 'C'

FLOOR AREA 534 SQFT
OPERABLE EXTERIOR OPENINGS 110 SQFT

OPERABLE OPENING AREA % 20.6% > 4%

# DRYER VENT CALCULATIONS TWO BEDROOM HC UNIT - NC 15-1 BUILDING TYPE 'C' Vertical Run (ft) 10 Horizontal Run (ft) 0 TOTAL LINEAR LENGTH (ft) 10 # of 90° Elbows (5ft each) 0 # of 45° Elbows (2.5ft each) 0 DUCT FITTING EQUIVALENT LENGTH (ft) 0 Equiv. Length (ft) Per 2018 NCMC 504.8.4.1 10

NOTE: M.C. IS TO PROVIDE AND INSTALL PERMANENT SIGNS
WITHIN 6 FT OF EACH EXHAUST DUCT CONNECTION WHICH STATE
THE LINEAR DUCT LENGTH AND NUMBER OF ELBOWS FOR THE
DRYER VENT RUN AS INSTALLED.
FOLIVALENT LENGTH CALCULATIONS ARE BASED ON 2018 NOME

EQUIVALENT LENGTH CALCULATIONS ARE BASED ON 2018 NCMC SECTION 504.8.4.1 AND ARE PROVIDED FOR CODE COMPLIANCE ONLY. WHEN USING ALTERNATE COMPLIANCE OF MFG INSTRUCTIONS, CALCULATIONS SHOULD BE BASED ON MFG EQUIVALENT LENGTH CALCULATIONS AND NOT THIS TABLE.

#### TAGGED NOTES


CLOSET CEILING TO BE DROPPED TO FACILITATE
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20x8 DUCT OFF OF BACK OF GRILLE FOR RETURN
AIR

PROVIDE 12x12 GRILLE TYPE 'C' WITHOUT A FILTER, FOR ACCESS TO HUB DRAIN IN WALL.

3 AIR HANDLER AND WATER HEATER TO BE LOCATED AT OPPOSITE ENDS OF MECHANICAL CLOSET PER OWNER REQUEST.

#### HATCH LEGEND

INDICATES DROPPED CEILING THIS AREA.

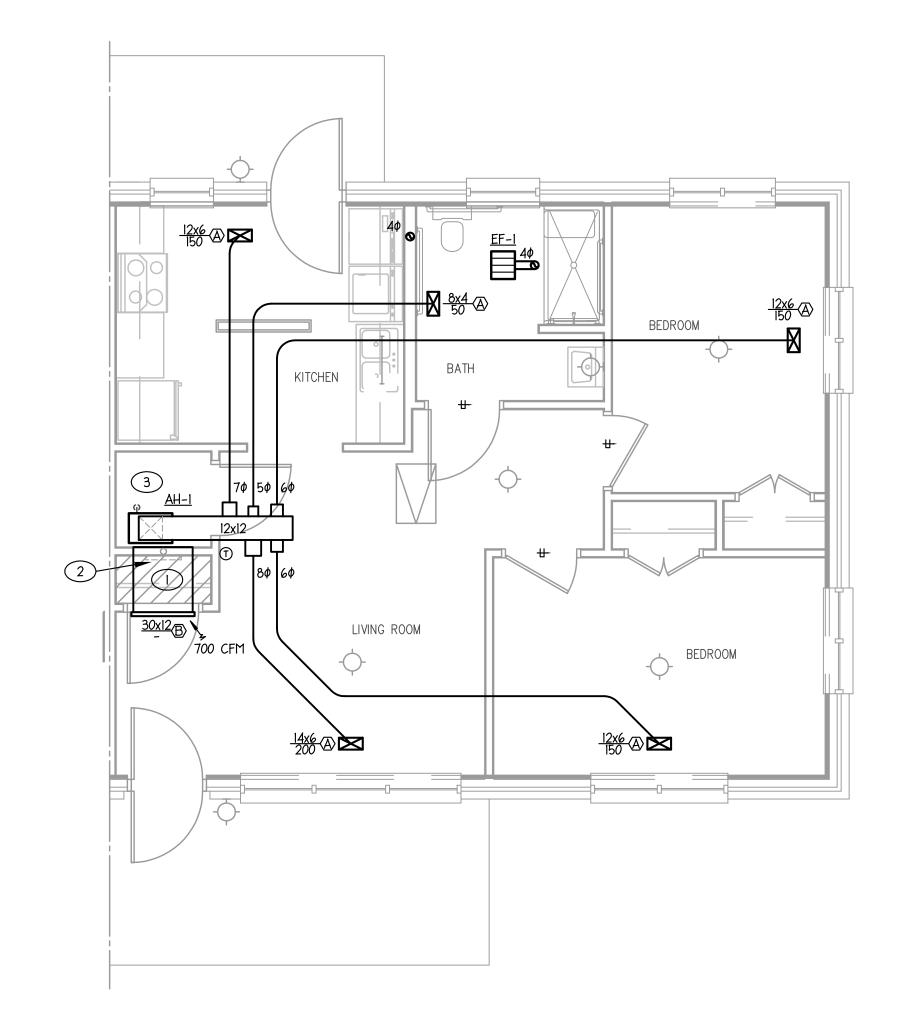




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tel 919.835.9761
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MECHANICAL ELECTRICAL PLUMBING





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ENOVATIONS - FAIRVIEW APARTMER
C 15-1 FAIRVIEW CIRCLE

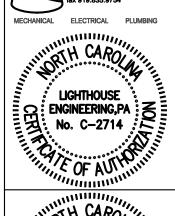MECHANICAL UNIT PLANS NC 15-1

COMM. NO.: 6041-B
DRAWN BY: WER
CHECKED BY: SAB
DATE: APR. 2, 2024
SHEET NO.

<del>- 6041B BID SET DRAWINGS - Page \110 of \142 `</del>

#### GENERAL NOTES - THIS SHEET

- 1. HVAC UNIT \$ SUPPORTS FURNISHED \$ INSTALLED BY MECH. CONTRACTOR. UNIT SIZE, INSTALLATION, ETC., TO BE COORDINATED WITH GC & FRAMING CONTRACTOR.
- 2. AIR HANDLER RETURN THROUGH LOUVER ABOVE DOOR. INSTALL GRILLE ON WALL ABOVE DOOR CLOSE TO CEILING. CONFIRM WITH ARCHITECT WHICH DIRECTION BLADES ARE FACING BEFORE INSTALLATION. GRILLE MAY ALSO BUT USED AS ACCESS TO DAMPER IN DUCT IF REQUIRED. GRILLE NOT TO EXCEED A VELOCITY OF 500 FPM. TYPICAL SIZING GUIDLINES ARE AS FOLLOWS BUT SHOULD BE CONFIRMED WITH MFG PERFORMANCE DATA BEFORE INSTALLATION.

1.5 TON UNIT = 30x122.0 TON UNIT = 30x122.5 TON UNIT = 30x14

- 3.  $\frac{3}{4}$  CONDENSATE DRAIN ROUTED TO HUB DRAIN (HD BY PC) IN MECH. CLOSET. REFER TO PLUMBING RISERS. COORDINATE W/ DUCTS, G.C., FRAMING CONTR., STRUCTURE, ETC.
- 4. SUPPLY AIR PLENUM OFF AIR HANDLING UNIT SHALL BE MIN. 4 LONG. TYPICAL ALL UNITS.
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- 7. DRYER VENT PIPE SHALL BE 40 SINGLE WALL RIGID SHEETMETAL PER MECH. CODE. AT ROOF TERMINATION, M.C. TO PROVIDE 40 DRYER VENT ROOF CAP WITH BACKDRAFT DAMPER \$ TO CAULK BEHIND CAP WITH 100% SILICONE.
- 8. BATHROOM EXHAUST DUCT SHALL BE 40 SINGLE WALL RIGID SHEETMETAL. AT ROOF TERMINATION, M.C. TO PROVIDE 40 VENT CAP WITH BACKDRAFT DAMPER & INSECT SCREEN & TO CAULK BEHIND CAP WITH 100% SILICONE.
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#### NATURAL VENTILATION CALCULATIONS **THREE BEDROOM UNIT - NC 15-1**

**BUILDING TYPE 'E'** 

FLOOR AREA 725 SQFT
OPERABLE EXTERIOR OPENINGS 105 SQFT OPERABLE OPENING AREA % 14.5% > 4%

### **DRYER VENT CALCULATIONS** THREE BEDROOM UNIT - NC 15-1


<b>BUILDING TYPE 'E'</b>		
	LOWER	FLOOR
Vertical Run (ft)		
Horizontal Run (ft)	0	
TOTAL LINEAR LENGTH (ft)		10
# of 90° Elbows (5ft each)		
# of 45° Elbows (2.5ft each)	0	
<b>DUCT FITTING EQUIVALENT LENGTH (ft)</b>		0
Equiv. Length (ft) Per 2018 NCMC 504.8.4.1		10

NOTE: M.C. IS TO PROVIDE AND INSTALL PERMANENT SIGNS WITHIN 6 FT OF EACH EXHAUST DUCT CONNECTION WHICH STATE THE LINEAR DUCT LENGTH AND NUMBER OF ELBOWS FOR THE DRYER VENT RUN AS INSTALLED.


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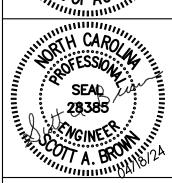
#### TAGGED NOTES

- PROVIDE 12x12 GRILLE TYPE 'C' WITHOUT A FILTER, FOR ACCESS TO HUB DRAIN IN WALL.
- (2) AIR HANDLER AND WATER HEATER TO BE LOCATED AT OPPOSITE ENDS OF MECHANICAL CLOSET PER OWNER REQUEST.



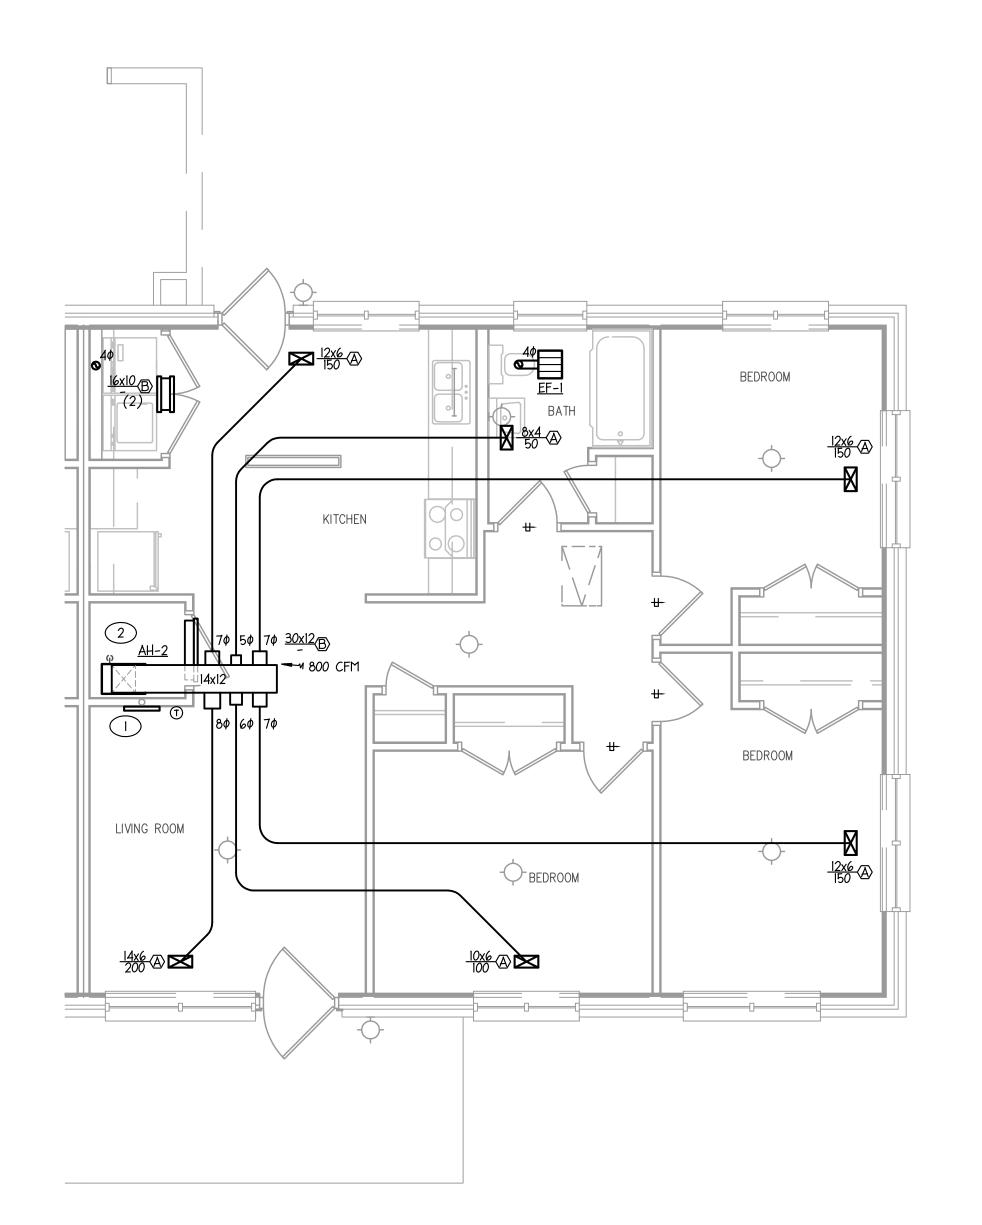



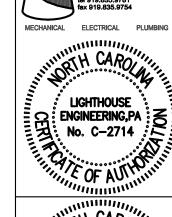

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COMM. NO.: 6041-B DRAWN BY: CHECKED BY: SAB DATE: APR. 2, 2024

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2. AIR HANDLER RETURN THROUGH LOUVER ABOVE DOOR. INSTALL GRILLE ON WALL ABOVE DOOR CLOSE TO CEILING. CONFIRM WITH ARCHITECT WHICH DIRECTION BLADES ARE FACING BEFORE INSTALLATION. GRILLE MAY ALSO BUT USED AS ACCESS TO DAMPER IN DUCT IF REQUIRED. GRILLE NOT TO EXCEED A VELOCITY OF 500 FPM. TYPICAL SIZING GUIDLINES ARE AS FOLLOWS BUT SHOULD BE CONFIRMED WITH MFG PERFORMANCE DATA BEFORE INSTALLATION.

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4. SUPPLY AIR PLENUM OFF AIR HANDLING UNIT SHALL BE MIN. 4' LONG. TYPICAL ALL UNITS.

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8. BATHROOM EXHAUST DUCT SHALL BE 4¢ SINGLE WALL RIGID SHEETMETAL. AT ROOF TERMINATION, M.C. TO PROVIDE 4¢ VENT CAP WITH BACKDRAFT DAMPER ¢ INSECT SCREEN ¢ TO CAULK BEHIND CAP WITH 100% SILICONE.

9. ALL BATHROOM DOORS TO HAVE UNDERCUTS FOR AIR TRANSFER.

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13. CEILINGS IN DWELLING UNITS ARE NOT RATED. LIFE SAFETY DAMPERS ARE NOT REQUIRED AT NON-RATED CEILING PENETRATIONS.

## NATURAL VENTILATION CALCULATIONS THREE BEDROOM UNIT - NC 15-1

BUILDING TYPE 'E-1'

FLOOR AREA 720 SQFT
OPERABLE EXTERIOR OPENINGS 118 SQFT

OPERABLE OPENING AREA % 16.4% > 4%

## DRYER VENT CALCULATIONS THREE BEDROOM UNIT - NC 15-1

LOWER	FLOOR
0	
1	
	1
0	
0	
	0
	1
	0 1 0 0

NOTE: M.C. IS TO PROVIDE AND INSTALL PERMANENT SIGNS
WITHIN 6 FT OF EACH EXHAUST DUCT CONNECTION WHICH STATE
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DRYER VENT RUN AS INSTALLED.
EQUIVALENT LENGTH CALCULATIONS ARE BASED ON 2018 NCMC


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#### TAGGED NOTES

DRYER VENT TO STUB IN WALL AT A MAX OF 12"

2 PROVIDE 12x12 GRILLE TYPE 'C' WITHOUT A FILTER, FOR ACCESS TO HUB DRAIN IN WALL.


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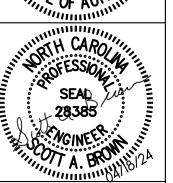


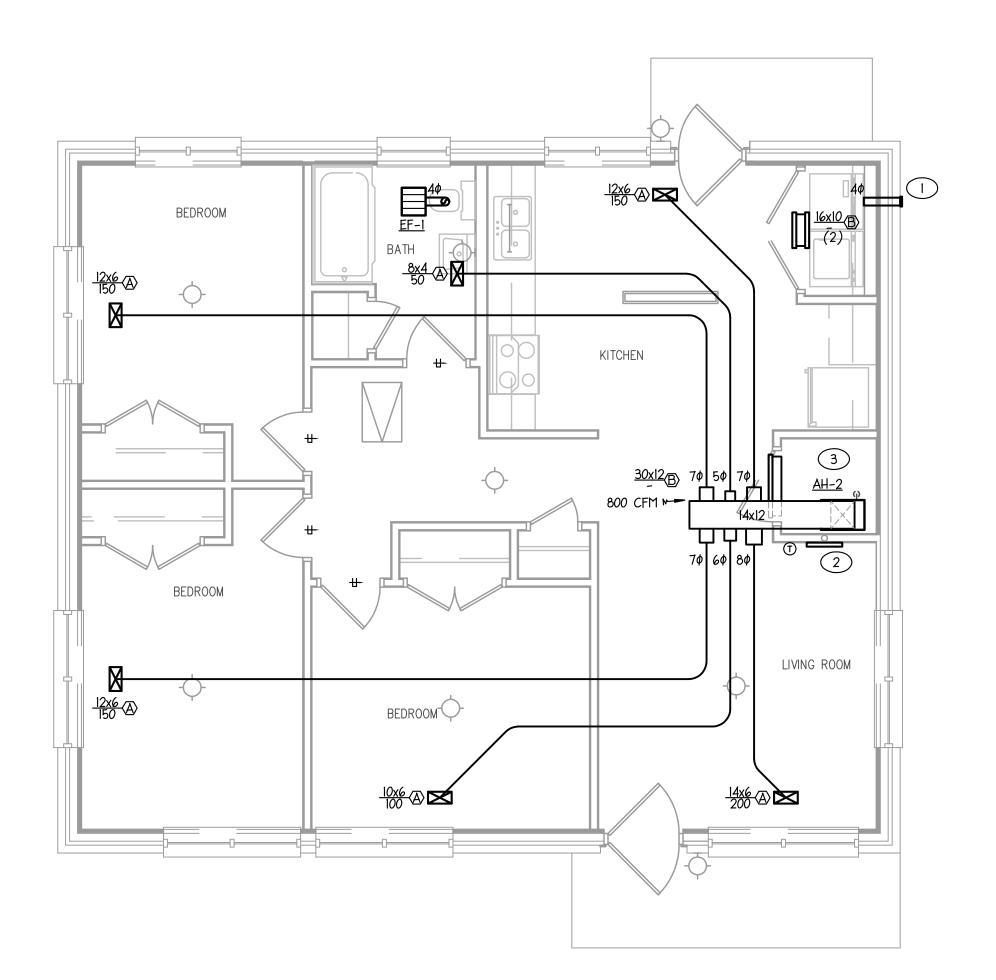

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Stogner Architecture, PARCHITECTURE - CONSTRUCTION MANAGEMENT - DESIGN BUIL 615 East Broad Avenue, Rockingham, North Carolina, 28379
Phone 910-895-6874 Fax 910-895-111

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MECHANICAL UNIT PLANS NC 15-1

COMM. NO.: 6041-B
DRAWN BY: WER
CHECKED BY: SAB
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<del>- 6041B BID SET DRAWINGS - Page ¹12 of ¹142 °</del>
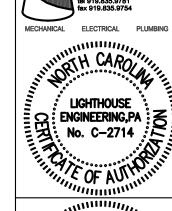
#### GENERAL NOTES - THIS SHEET

- I. HVAC UNIT \$ SUPPORTS FURNISHED \$ INSTALLED BY MECH. CONTRACTOR. UNIT SIZE, INSTALLATION, ETC., TO BE COORDINATED WITH GC \$ FRAMING CONTRACTOR.
- 2. AIR HANDLER RETURN THROUGH LOUVER ABOVE DOOR. INSTALL GRILLE ON WALL ABOVE DOOR CLOSE TO CEILING. CONFIRM WITH ARCHITECT WHICH DIRECTION BLADES ARE FACING BEFORE INSTALLATION. GRILLE MAY ALSO BUT USED AS ACCESS TO DAMPER IN DUCT IF REQUIRED. GRILLE NOT TO EXCEED A VELOCITY OF 500 FPM. TYPICAL SIZING GUIDLINES ARE AS FOLLOWS BUT SHOULD BE CONFIRMED WITH MFG PERFORMANCE DATA BEFORE INSTALLATION.

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- 4. SUPPLY AIR PLENUM OFF AIR HANDLING UNIT SHALL BE MIN. 4' LONG. TYPICAL ALL UNITS.
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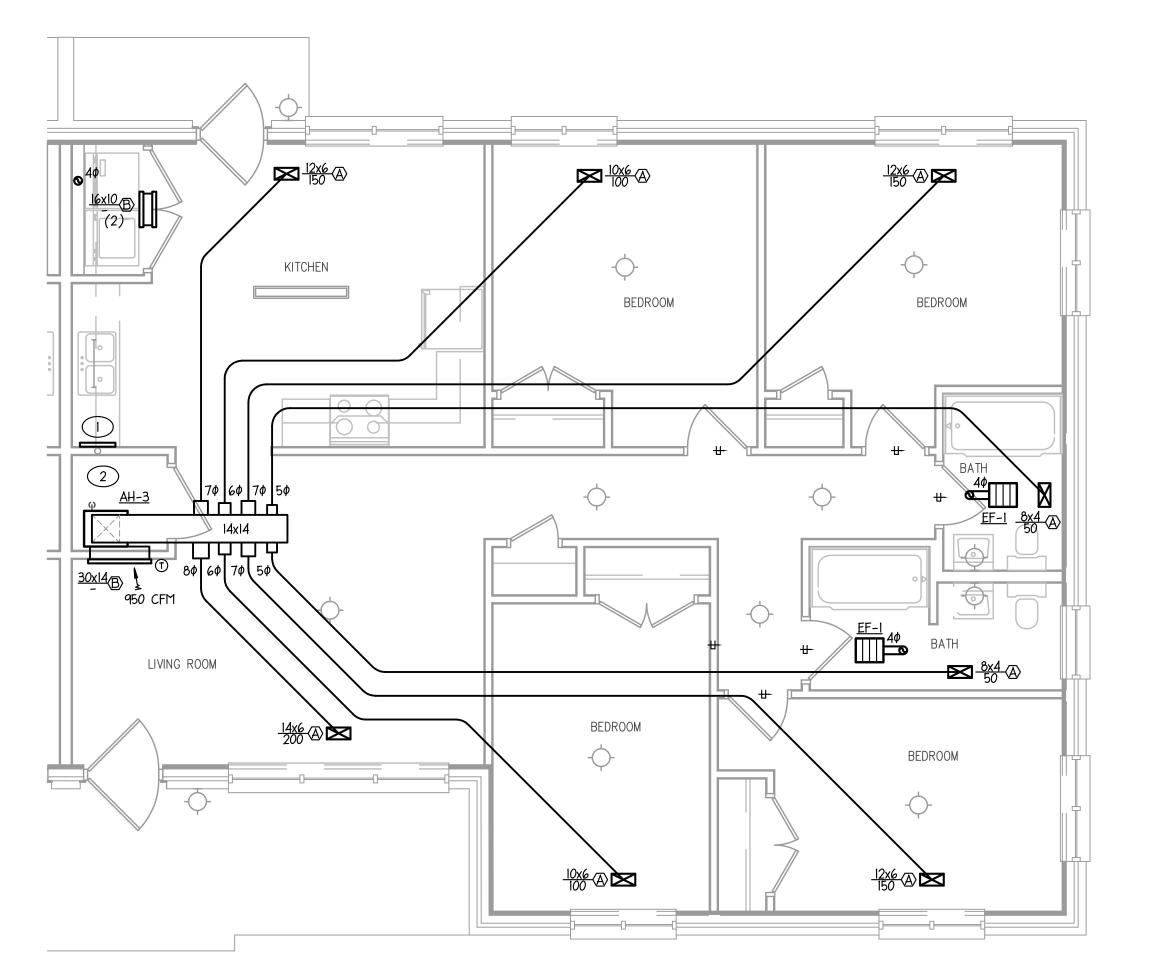
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## NATURAL VENTILATION CALCULATIONS FOUR BEDROOM UNIT - NC 15-1 BUILDING TYPE 'F' FLOOR AREA 960 SQFT OPERABLE EXTERIOR OPENINGS 112 SQFT OPERABLE OPENING AREA % 11.7% > 4%

DRYER VENT CALCU	LATIO	<u>NS</u>
FOUR BEDROOM UNIT -	NC 15	5-1
BUILDING TYPE 'F'		
	LOWE	R FLOOR
Vertical Run (ft)	10	
Horizontal Run (ft)	0	
TOTAL LINEAR LENGTH (ft)		10
# of 90° Elbows (5ft each)	0	
# of 45° Elbows (2.5ft each)	0	
DUCT FITTING EQUIVALENT LENGTH (ft)		0
Equiv. Length (ft) Per 2018 NCMC 504.8.4.1		10


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SECTION 504 8 4 1 AND ARE PROVIDED FOR CODE COMPLIANCE


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Housing Authorit
City of Golds
JOVATIONS - FAIRVIEW APARTME
15-1 FAIRVIEW CIRCLE
DSBORO.

MECHANICAL UNIT PLANS NC 15-1

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#### GENERAL NOTES - THIS SHEET

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- 5. SUPPLY AIR DUCT TRUNK TO RUN BETWEEN JOISTS. CONFIRM DIRECTION OF JOISTS DURING CONSTRUCTION AND ROTATE TRUNK 90° IF REQUIRED.
- 6. M.C. TO PROVIDE RECESSED BOX FOR DRYER VENT CONNECTION (BOX MUST BE APPROPRIATELY FIRE RATED IF INSTALLED IN A RATED WALL). MOUNT DRYER BOX AT 6" A.F.F FOR FLOOR MOUNTED DRYER. 40 DRYER VENT TO RUN FROM TOP OF DRYER BOX UP INTO FLOOR/CEILING ASSEMBLY ABOVE.
- 7. DRYER VENT PIPE SHALL BE 40 SINGLE WALL RIGID SHEETMETAL PER MECH. CODE. AT ROOF TERMINATION, M.C. TO PROVIDE 40 DRYER VENT ROOF CAP WITH BACKDRAFT DAMPER \$ TO CAULK BEHIND CAP WITH 100% SILICONE.
- 8. BATHROOM EXHAUST DUCT SHALL BE 40 SINGLE WALL RIGID SHEETMETAL. AT ROOF TERMINATION, M.C. TO PROVIDE 40 VENT CAP WITH BACKDRAFT DAMPER & INSECT SCREEN & TO CAULK BEHIND CAP WITH 100% SILICONE.
- 9. ALL BATHROOM DOORS TO HAVE UNDERCUTS FOR AIR TRANSFER.
- 10. ALL ROOMS WITH SUPPLY AIR TO HAVE I" DOOR UNDERCUTS FOR RETURN.
- II. AN APPROVED RECIRCULATING RANGE HOOD IS TO BE INSTALLED ABOVE KITCHEN RANGE.
- 12. PROVIDE TRANSFER GRILLES FOR MAKE-UP AIR TO DRYER CLOSET AS SHOWN. MIN. FREE AREA OF 120 SQIN IS REQUIRED. INSTALL GRILLES HIGH ON WALL.
- 13. CEILINGS IN DWELLING UNITS ARE NOT RATED. LIFE SAFETY DAMPERS ARE NOT REQUIRED AT NON-RATED CEILING PENETRATIONS.
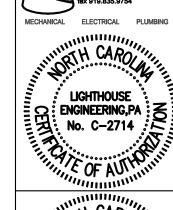
#### NATURAL VENTILATION CALCULATIONS **FOUR BEDROOM UNIT - NC 15-1 BUILDING TYPE 'F-1'**

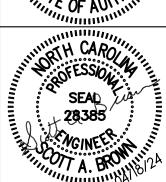FLOOR AREA 955 SQFT
OPERABLE EXTERIOR OPENINGS 118 SQFT

OPERABLE OPENING AREA % 12.4% > 4%


#### **DRYER VENT CALCULATIONS FOUR BEDROOM UNIT - NC 15-1 BUILDING TYPE 'F-1'** Vertical Run ( Horizontal Run (1 TOTAL LINEAR LENGTH (ft) # of 90° Elbows (5ft each # of 45° Elbows (2.5ft each

DUCT FITTING EQUIVALENT LENGTH (ft) Equiv. Length (ft) Per 2018 NCMC 504.8.4.1 NOTE: M.C. IS TO PROVIDE AND INSTALL PERMANENT SIGNS WITHIN 6 FT OF EACH EXHAUST DUCT CONNECTION WHICH STATE THE LINEAR DUCT LENGTH AND NUMBER OF ELBOWS FOR THE

DRYER VENT RUN AS INSTALLED. EQUIVALENT LENGTH CALCULATIONS ARE BASED ON 2018 NCMC SECTION 504.8.4.1 AND ARE PROVIDED FOR CODE COMPLIANCE ONLY. WHEN USING ALTERNATE COMPLIANCE OF MFG INSTRUCTIONS, CALCULATIONS SHOULD BE BASED ON MFG EQUIVALENT LENGTH CALCULATIONS AND NOT THIS TABLE.

#### TAGGED NOTES

- PROVIDE 12x12 GRILLE TYPE 'C' WITHOUT A FILTER, FOR ACCESS TO HUB DRAIN IN WALL.
- (2) AIR HANDLER AND WATER HEATER TO BE LOCATED AT OPPOSITE ENDS OF MECHANICAL CLOSET PER OWNER REQUEST.

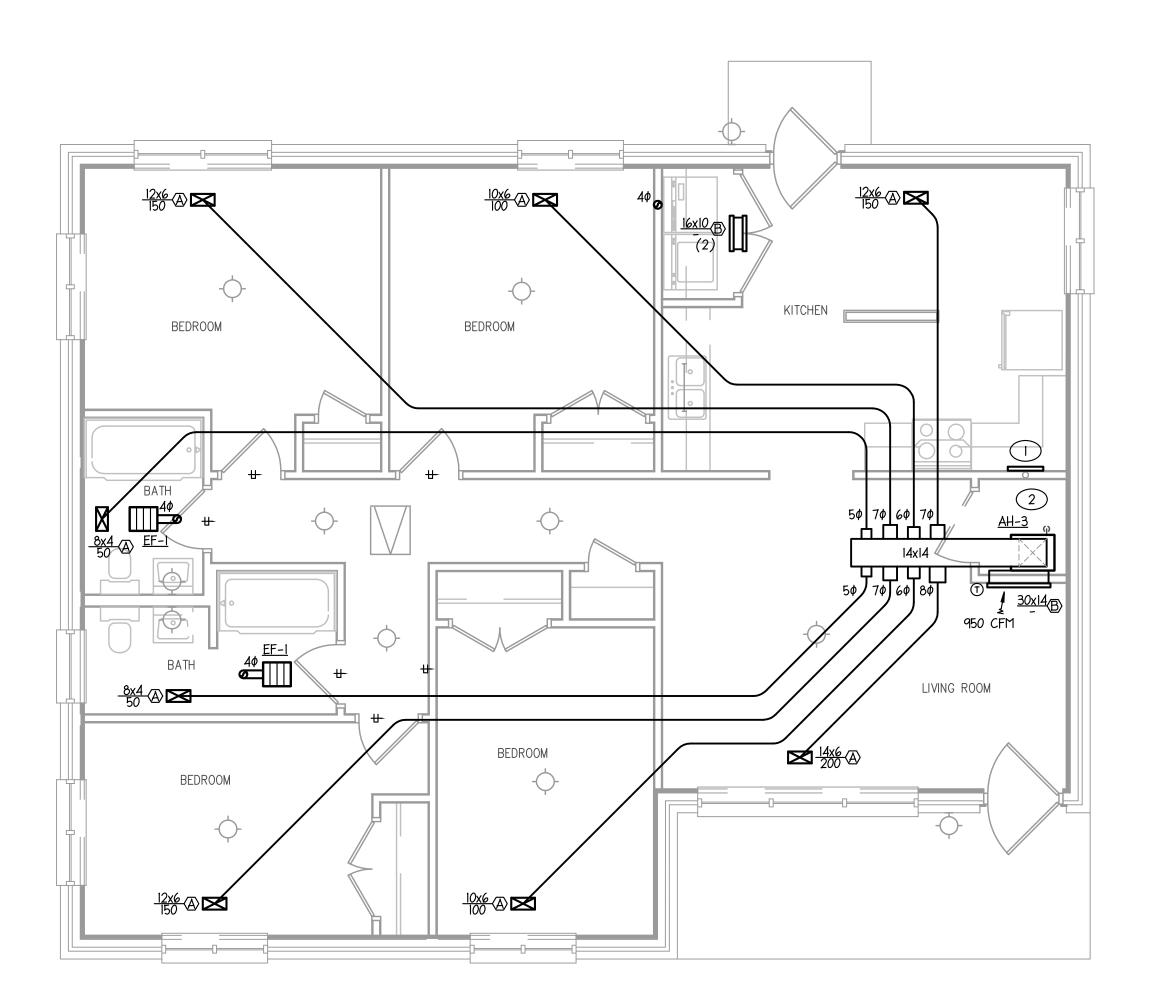







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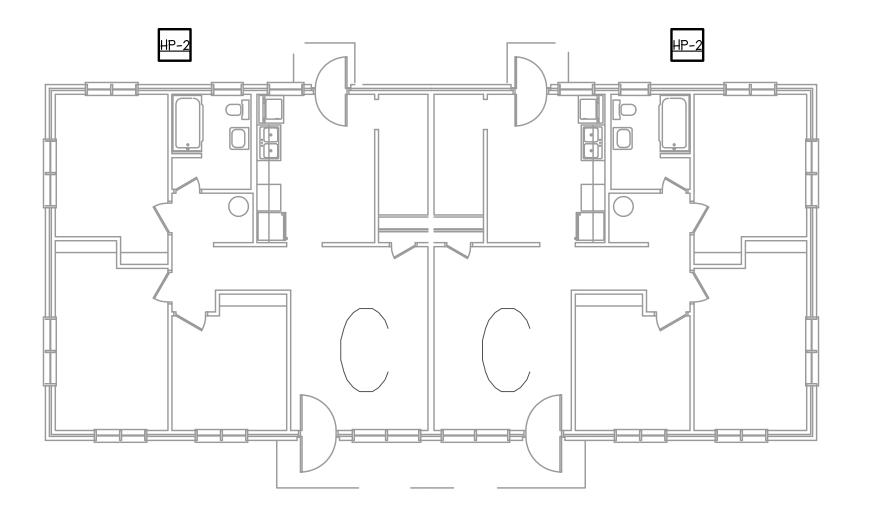
Authority of of Goldsboro

Of Housing City

MECHANICAL UNIT PLANS NC 15-1

COMM. NO.: 6041-B DRAWN BY: CHECKED BY: SAB DATE: APR. 2, 2024 SHEET NO.

<del>- 6041B BID SET DRAWINGS - Page <sup>1</sup>14 of <sup>1</sup>142 '</del>



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MECHANICAL BUILDING C & C-A PLANS NC 15-1

6041B BID SET DRAWINGS - Page 115 of 142

COMM. NO.: 6041-B DRAWN BY: CHECKED BY: SAB DATE: APR. 2, 2024 SHEET NO.

- 1. HVAC UNIT \$ SUPPORTS FURNISHED \$ INSTALLED BY MECH. CONTRACTOR. UNIT SIZE, INSTALLATION, ETC., TO BE COORDINATED WITH GC & FRAMING CONTRACTOR.
- 2. AIR HANDLER RETURN THROUGH LOUVER ABOVE DOOR. INSTALL GRILLE ON WALL ABOVE DOOR CLOSE TO CEILING. CONFIRM WITH ARCHITECT WHICH DIRECTION BLADES ARE FACING BEFORE INSTALLATION. GRILLE MAY ALSO BUT USED AS ACCESS TO DAMPER IN DUCT IF REQUIRED. GRILLE NOT TO EXCEED A VELOCITY OF 500 FPM. TYPICAL SIZING GUIDLINES ARE AS FOLLOWS BUT SHOULD BE CONFIRMED WITH MFG PERFORMANCE DATA BEFORE INSTALLATION.

1.5 TON UNIT = 30x122.0 TON UNIT = 30x122.5 TON UNIT = 30x14

- 3.  $\frac{3}{4}$  CONDENSATE DRAIN ROUTED TO HUB DRAIN (HD BY PC) IN MECH. CLOSET. REFER TO PLUMBING RISERS. COORDINATE W/ DUCTS, G.C., FRAMING CONTR., STRUCTURE, ETC.
- 4. SUPPLY AIR PLENUM OFF AIR HANDLING UNIT SHALL BE MIN. 4 LONG. TYPICAL ALL UNITS.
- 5. SUPPLY AIR DUCT TRUNK TO RUN BETWEEN JOISTS. CONFIRM DIRECTION OF JOISTS DURING CONSTRUCTION AND ROTATE TRUNK 90° IF REQUIRED.
- 6. M.C. TO PROVIDE RECESSED BOX FOR DRYER VENT CONNECTION (BOX MUST BE APPROPRIATELY FIRE RATED IF INSTALLED IN A RATED WALL). MOUNT DRYER BOX AT 6" A.F.F FOR FLOOR MOUNTED DRYER. 40 DRYER VENT TO RUN FROM TOP OF DRYER BOX UP INTO FLOOR/CEILING ASSEMBLY ABOVE.
- 7. DRYER VENT PIPE SHALL BE 40 SINGLE WALL RIGID SHEETMETAL PER MECH. CODE. AT ROOF TERMINATION, M.C. TO PROVIDE 40 DRYER VENT ROOF CAP WITH BACKDRAFT DAMPER \$ TO CAULK BEHIND CAP WITH 100% SILICONE.
- 8. BATHROOM EXHAUST DUCT SHALL BE 40 SINGLE WALL RIGID SHEETMETAL. AT ROOF TERMINATION, M.C. TO PROVIDE 40 VENT CAP WITH BACKDRAFT DAMPER & INSECT SCREEN & TO CAULK BEHIND CAP WITH 100% SILICONE.
- 9. ALL BATHROOM DOORS TO HAVE UNDERCUTS FOR AIR TRANSFER.
- 10. ALL ROOMS WITH SUPPLY AIR TO HAVE I" DOOR UNDERCUTS FOR RETURN.
- II. AN APPROVED RECIRCULATING RANGE HOOD IS TO BE INSTALLED ABOVE KITCHEN RANGE.
- 12. PROVIDE TRANSFER GRILLES FOR MAKE-UP AIR TO DRYER CLOSET AS SHOWN. MIN. FREE AREA OF 120 SQIN IS REQUIRED. INSTALL GRILLES HIGH ON WALL.
- 13. CEILINGS IN DWELLING UNITS ARE NOT RATED. LIFE SAFETY DAMPERS ARE NOT REQUIRED AT NON-RATED CEILING PENETRATIONS.

#### NATURAL VENTILATION CALCULATIONS ONE BEDROOM UNIT - NC 15-3 **BUILDING TYPE 'A'**

FLOOR AREA 360 SQFT
OPERABLE EXTERIOR OPENINGS 79 SQFT OPERABLE OPENING AREA % 21.9% > 4%


#### **DRYER VENT CALCULATIONS** ONE BEDROOM UNIT - NC 15-3 **BUILDING TYPE 'A'** LOWER FLOOR Horizontal Run (ft TOTAL LINEAR LENGTH (f # of 90° Elbows (5ft each) # of 45° Elbows (2.5ft each DUCT FITTING EQUIVALENT LENGTH (ft) Equiv. Length (ft) Per 2018 NCMC 504.8.4.1

NOTE: M.C. IS TO PROVIDE AND INSTALL PERMANENT SIGNS WITHIN 6 FT OF EACH EXHAUST DUCT CONNECTION WHICH STATE THE LINEAR DUCT LENGTH AND NUMBER OF ELBOWS FOR THE DRYER VENT RUN AS INSTALLED.


EQUIVALENT LENGTH CALCULATIONS ARE BASED ON 2018 NCMC SECTION 504.8.4.1 AND ARE PROVIDED FOR CODE COMPLIANCE ONLY. WHEN USING ALTERNATE COMPLIANCE OF MFG INSTRUCTIONS, CALCULATIONS SHOULD BE BASED ON MFG EQUIVALENT LENGTH CALCULATIONS AND NOT THIS TABLE.


#### TAGGED NOTES

- DRYER VENT TO STUB IN WALL AT A MAX OF 12"
- 2 PROVIDE 12x12 GRILLE TYPE 'C' WITHOUT A FILTER, FOR ACCESS TO HUB DRAIN IN WALL.
- (3) AIR HANDLER AND WATER HEATER TO BE LOCATED AT OPPOSITE ENDS OF MECHANICAL CLOSET PER OWNER REQUEST.

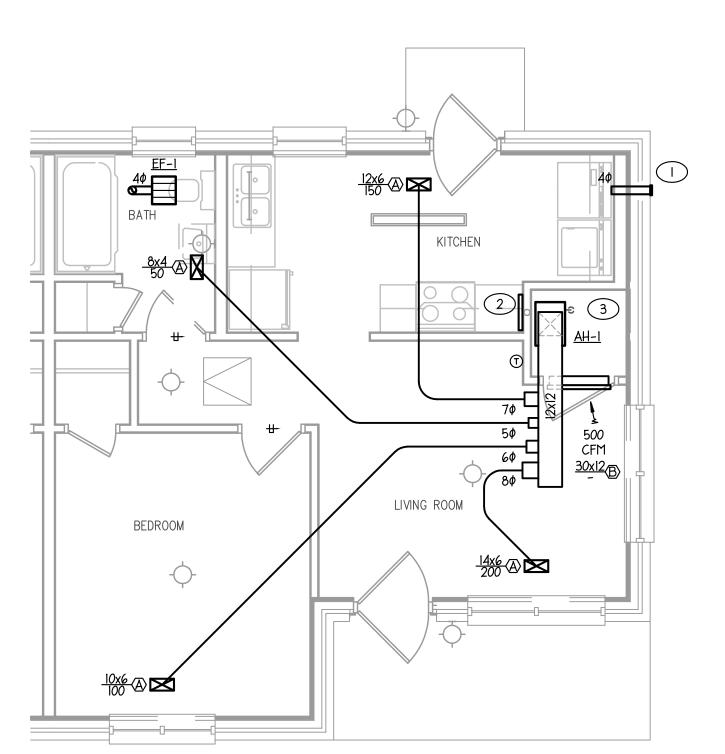

ONE BEDROOM UNIT - NC 15-3 BUILDING TYPE 'A'

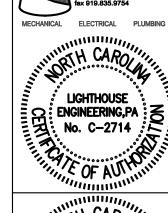

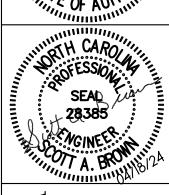

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MECHANICAL UNIT PLANS NC 15-3

COMM. NO.: 6041-B DRAWN BY: CHECKED BY: SAB DATE: APR. 2, 2024 SHEET NO.

6041B BID SET DRAWINGS - Page 116 of 142 °

#### GENERAL NOTES - THIS SHEET

- I. HVAC UNIT \$ SUPPORTS FURNISHED \$ INSTALLED BY MECH. CONTRACTOR. UNIT SIZE, INSTALLATION, ETC., TO BE COORDINATED WITH GC \$ FRAMING CONTRACTOR.
- 2. AIR HANDLER RETURN THROUGH LOUVER ABOVE DOOR. INSTALL GRILLE ON WALL ABOVE DOOR CLOSE TO CEILING. CONFIRM WITH ARCHITECT WHICH DIRECTION BLADES ARE FACING BEFORE INSTALLATION. GRILLE MAY ALSO BUT USED AS ACCESS TO DAMPER IN DUCT IF REQUIRED. GRILLE NOT TO EXCEED A VELOCITY OF 500 FPM. TYPICAL SIZING GUIDLINES ARE AS FOLLOWS BUT SHOULD BE CONFIRMED WITH MFG PERFORMANCE DATA BEFORE INSTALLATION.

1.5 TON UNIT = 30x12 2.0 TON UNIT = 30x12 2.5 TON UNIT = 30x14

- 3. 3/4" CONDENSATE DRAIN ROUTED TO HUB DRAIN (HD BY PC) IN MECH. CLOSET. REFER TO PLUMBING RISERS. COORDINATE W/DUCTS, G.C., FRAMING CONTR., STRUCTURE, ETC.
- 4. SUPPLY AIR PLENUM OFF AIR HANDLING UNIT SHALL BE MIN. 4' LONG. TYPICAL ALL UNITS.
- 5. SUPPLY AIR DUCT TRUNK TO RUN BETWEEN JOISTS. CONFIRM DIRECTION OF JOISTS DURING CONSTRUCTION AND ROTATE TRUNK 90° IF REQUIRED.
- 6. M.C. TO PROVIDE RECESSED BOX FOR DRYER VENT CONNECTION (BOX MUST BE APPROPRIATELY FIRE RATED IF INSTALLED IN A RATED WALL). MOUNT DRYER BOX AT 6" A.F.F FOR FLOOR MOUNTED DRYER. 40 DRYER VENT TO RUN FROM TOP OF DRYER BOX UP INTO FLOOR/CEILING ASSEMBLY ABOVE.
- 7. DRYER VENT PIPE SHALL BE 4¢ SINGLE WALL RIGID SHEETMETAL PER MECH. CODE. AT ROOF TERMINATION, M.C. TO PROVIDE 4¢ DRYER VENT ROOF CAP WITH BACKDRAFT DAMPER ¢ TO CAULK BEHIND CAP WITH 100% SILICONE.
- 8. BATHROOM EXHAUST DUCT SHALL BE 40 SINGLE WALL RIGID SHEETMETAL. AT ROOF TERMINATION, M.C. TO PROVIDE 40 VENT CAP WITH BACKDRAFT DAMPER & INSECT SCREEN & TO CAULK BEHIND CAP WITH 100% SILICONE.
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- 13. CEILINGS IN DWELLING UNITS ARE NOT RATED. LIFE SAFETY DAMPERS ARE NOT REQUIRED AT NON-RATED CEILING PENETRATIONS.

## NATURAL VENTILATION CALCULATIONS THREE BEDROOM UNIT - NC 15-3

**BUILDING TYPE 'C'** 

FLOOR AREA 650 SQFT
OPERABLE EXTERIOR OPENINGS 108 SQFT

OPERABLE OPENING AREA % 16.6% > 4%

## DRYER VENT CALCULATIONS THREE BEDROOM UNIT - NC 15-3 BUILDING TYPE 'C'

BUILDING TIPE C		
	LOWER	FLOOR
Vertical Run (ft)	10	
Horizontal Run (ft)	0	
TOTAL LINEAR LENGTH (ft)		10
# of 90° Elbows (5ft each)	0	
# of 45° Elbows (2.5ft each)	0	
DUCT FITTING EQUIVALENT LENGTH (ft)		0
Equiv. Length (ft) Per 2018 NCMC 504.8.4.1		10


NOTE: M.C. IS TO PROVIDE AND INSTALL PERMANENT SIGNS WITHIN 6 FT OF EACH EXHAUST DUCT CONNECTION WHICH STATE THE LINEAR DUCT LENGTH AND NUMBER OF ELBOWS FOR THE DRYER VENT RUN AS INSTALLED.

EQUIVALENT LENGTH CALCULATIONS ARE BASED ON 2018 NCMC

SECTION 504.8.4.1 AND ARE PROVIDED FOR CODE COMPLIANCE ONLY. WHEN USING ALTERNATE COMPLIANCE OF MFG INSTRUCTIONS, CALCULATIONS SHOULD BE BASED ON MFG EQUIVALENT LENGTH CALCULATIONS AND NOT THIS TABLE.

#### TAGGED NOTES

- PROVIDE 12x12 GRILLE TYPE 'C' WITHOUT A FILTER, FOR ACCESS TO HUB DRAIN IN WALL.
- AIR HANDLER AND WATER HEATER TO BE LOCATED AT OPPOSITE ENDS OF MECHANICAL CLOSET PER OWNER REQUEST.

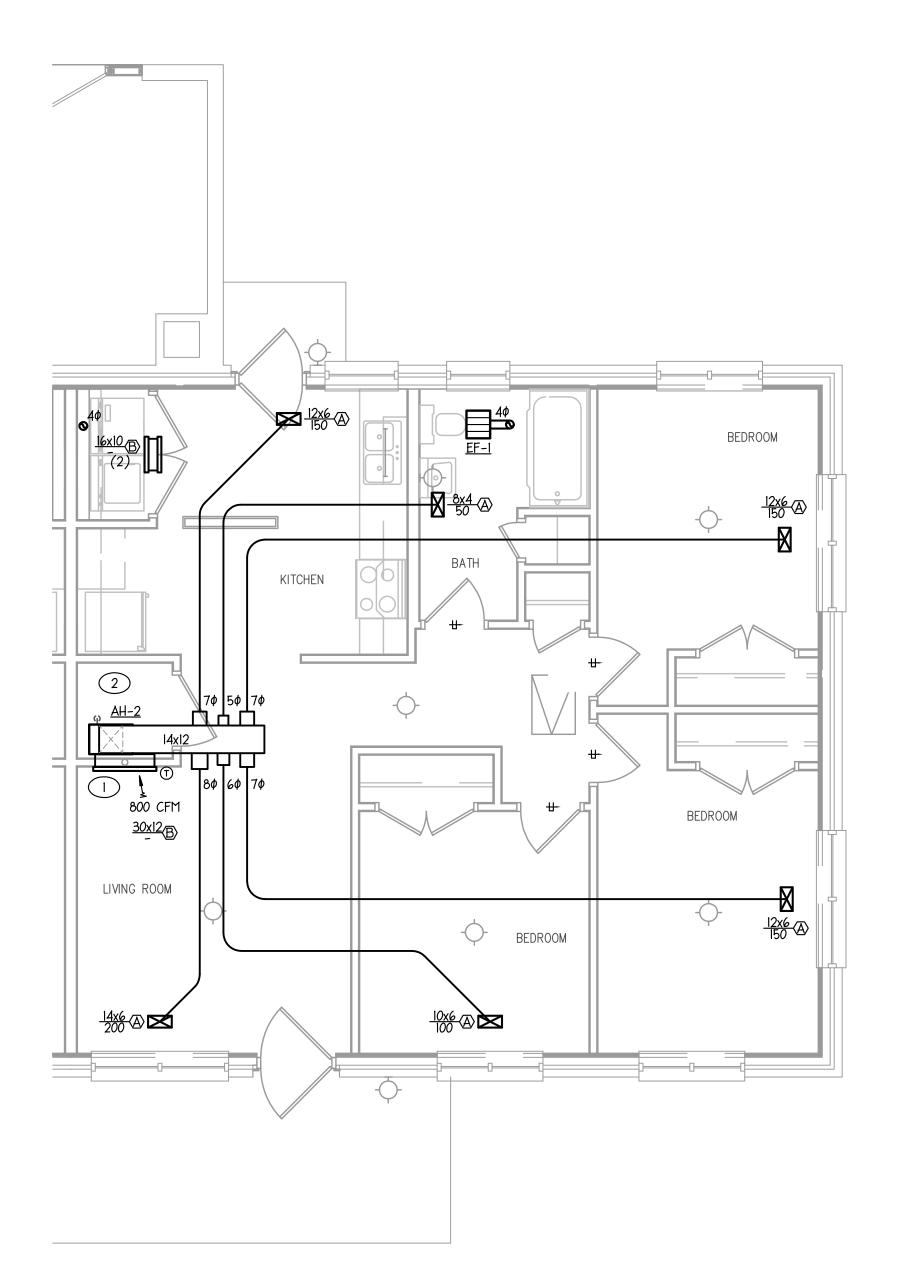





LIGHTHOUSE

SNGINGSTRING

400 W. Morgan Street, S

Raleigh, North Carolina.

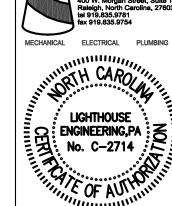

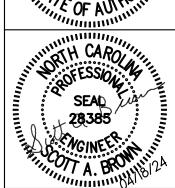

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MECHANICAL UNIT PLANS NC 15-3

COMM. NO.: 6041-B
DRAWN BY: WER
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DATE: APR. 2, 2024
SHEET NO.

6041B BID SET DRAWINGS - Page 117 of 142 °

#### GENERAL NOTES - THIS SHEET

- 1. HVAC UNIT \$ SUPPORTS FURNISHED \$ INSTALLED BY MECH. CONTRACTOR. UNIT SIZE, INSTALLATION, ETC., TO BE COORDINATED WITH GC & FRAMING CONTRACTOR.
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1.5 TON UNIT = 30x122.0 TON UNIT = 30x122.5 TON UNIT = 30x14

- 3.  $\frac{3}{4}$  CONDENSATE DRAIN ROUTED TO HUB DRAIN (HD BY PC) IN MECH. CLOSET. REFER TO PLUMBING RISERS. COORDINATE W/ DUCTS, G.C., FRAMING CONTR., STRUCTURE, ETC.
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#### NATURAL VENTILATION CALCULATIONS **THREE BEDROOM HC UNIT - NC 15-3**

**BUILDING TYPE 'C'** 

FLOOR AREA 675 SQFT
OPERABLE EXTERIOR OPENINGS 112 SQFT OPERABLE OPENING AREA % 16.6% > 4%


#### DRYER VENT CALCULATIONS **THREE BEDROOM HC UNIT - NC 15-3** DITTI DINC TYPE 'C'

BUILDING TYPE 'C'		
	LOWER	FLOOR
Vertical Run (ft)	10	
Horizontal Run (ft)	0	
TOTAL LINEAR LENGTH (ft)		10
# of 90° Elbows (5ft each)	0	
# of 45° Elbows (2.5ft each)	0	
DUCT FITTING EQUIVALENT LENGTH (ft)		0
Equiv. Length (ft) Per 2018 NCMC 504.8.4.1		10


NOTE: M.C. IS TO PROVIDE AND INSTALL PERMANENT SIGNS WITHIN 6 FT OF EACH EXHAUST DUCT CONNECTION WHICH STATE THE LINEAR DUCT LENGTH AND NUMBER OF ELBOWS FOR THE DRYER VENT RUN AS INSTALLED. EQUIVALENT LENGTH CALCULATIONS ARE BASED ON 2018 NCMC SECTION 504.8.4.1 AND ARE PROVIDED FOR CODE COMPLIANCE ONLY. WHEN USING ALTERNATE COMPLIANCE OF MFG INSTRUCTIONS, CALCULATIONS SHOULD BE BASED ON MFG EQUIVALENT LENGTH CALCULATIONS AND NOT THIS TABLE.


#### TAGGED NOTES

- PROVIDE 12x12 GRILLE TYPE 'C' WITHOUT A FILTER, FOR ACCESS TO HUB DRAIN IN WALL.
- (2) AIR HANDLER AND WATER HEATER TO BE LOCATED AT OPPOSITE ENDS OF MECHANICAL CLOSET PER OWNER REQUEST.

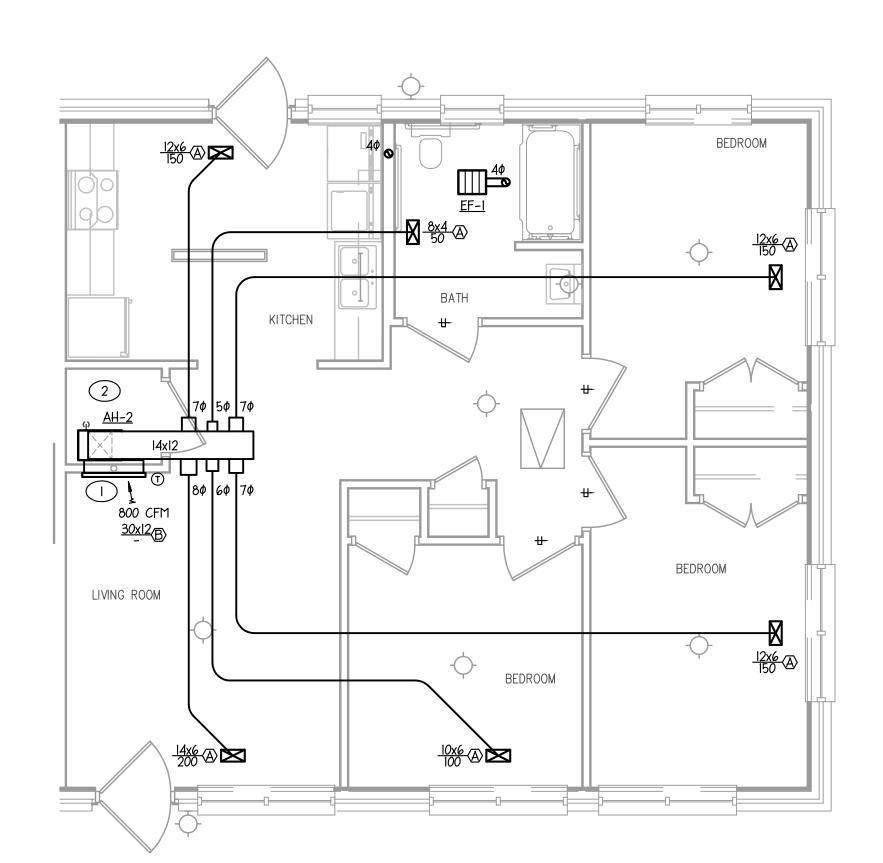



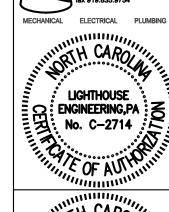

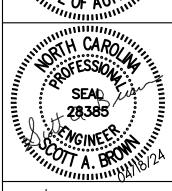

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MECHANICAL UNIT PLANS NC 15-3

COMM. NO.: 6041-B DRAWN BY: CHECKED BY: SAB DATE: APR. 2, 2024 SHEET NO.

6041B BID SET DRAWINGS - Page 118 of 142

ALARM INDICATING DEVICE, REMOTE STROBE. 80" A.F.F.; BRK SLEDI77. WHITE IN COLOR. 120V COMBINATION SMOKE ALARM / CARBON MONOXIDE DETECTOR / STROBE

WITH BATTERY BACK-UP, CONNECT TO NEAREST 120V CIRCUIT AND INSTALL PER MANUFACTURERS RECOMMENDATIONS; BRK 7030BSL 120V COMBINATION SMOKE ALARM / CARBON MONOXIDE DETECTOR WITH 10 YEAR BATTERY BACK-UP, CONNECT TO NEAREST 120V CIRCUIT AND INSTALL

PER MANUFACTURERS RECOMMENDATIONS; BRK SC9120LBL. 120V MULTI-STATION SMOKE ALARM WITH EMERGENCY POWER SOURCE BACK-UP, CONNECT TO 120V CIRCUIT AS INDICATED. EQUAL TO BRK 7020BSL. "ADA" - DEVICE SHALL PROVIDE SIGNAL TO REMOTE STROBE.

Drawing Sheet List								
#	Title							
E0.0	ELECTRICAL LEGEND, NOTES, AND SCHEDULES							
E0.1	ELECTRICAL DETAILS							
E1.0	ELECTRICAL BUILDING 1 PLANS NC 15-1							
E1.1	ELECTRICAL BUILDING 2 & 3 PLANS NC 15-1							
E1.2	ELECTRICAL BUILDING 4 & 5 PLANS NC 15-1							
E1.3	ELECTRICAL BUILDING 6 & 7 PLANS NC 15-1							
E1.4	ELECTRICAL BUILDING 8 & 9 PLANS NC 15-1							
E1.5	ELECTRICAL BUILDING 14 PLANS NC 15-1							
E1.6	ELECTRICAL BUILDING 15 PLANS NC 15-1							
E2.0	ELECTRICAL UNIT PLANS NC 15-1							
E2.1	ELECTRICAL UNIT PLANS NC 15-1							
E3.0	ELECTRICAL UNIT PLANS NC 15-1							
E3.1	ELECTRICAL UNIT PLANS NC 15-1							
E4.0	ELECTRICAL UNIT PLANS NC 15-1							
E4.1	ELECTRICAL UNIT PLANS NC 15-1							
E10.0	ELECTRICAL BUILDING C & C-A PLANS NC 15-3							
E11.0	ELECTRICAL UNIT PLANS NC 15-3							
E12.0	ELECTRICAL UNIT PLANS NC 15-3							
E12.1	ELECTRICAL UNIT PLANS NC 15-3							
E13.0	ELECTRICAL UNIT PANEL SCHEDULES							
E14.0	ELECTRICAL BUILDING RISER DIAGRAMS							
E14.1	ELECTRICAL BUILDING RISER DIAGRAMS							
E14.2	ELECTRICAL BUILDING RISER DIAGRAMS							
E14.3	ELECTRICAL BUILDING RISER DIAGRAMS							

	ELECTRICAL SYMBOL LEGEND
	CIRCUIT CONDUCTORS CONCEALED IN FLOOR, WALL OR CEILING.
	ARROWHEAD INDICATES HOMERUN TO PANEL NOTED.
//	INDICATES HOT LEG OF CIRCUIT TO BE CARRIED OVER TO NEXT DEVICE. SEE PLANS FOR CONTROL SCHEME.
0	JUNCTION BOX CEILING MOUNTED.
Ю	JUNCTION BOX WALL MOUNTED AT HEIGHT INDICATED ON DRAWINGS.
\$	SINGLE POLE SWITCH, 20A, 120/277 VOLT. "3" INDICATES 3-WAY SWITCH.
#	DUPLEX RECEPTACLE, 15 AMP, 120 VOLT. "GFI" INDICATES GROUND FAULT CIRCUIT INTERRUPTER TYPE. "WP" INDICATES WEATHERPROOF.
=	DUPLEX RECEPTACLE, AS ABOVE, MOUNTED 6" ABOVE COUNTER TOP OR 4" ABOVE BACKSPLASH, AS APPROPRIATE, OR AT HEIGHT INDICATED.
<b>≠</b>	DUPLEX RECEPTACLE, AS ABOVE, MOUNTED 6" ABOVE COUNTER TOP OR 4" ABOVE BACKSPLASH, AS APPROPRIATE, OR AT HEIGHT INDICATED.
<b>#</b>	240V RECEPTACLE, SEE PLANS FOR NEMA CONFIGURATION.
<b>□</b> ₁ 30/2/FPN	HEAVY DUTY FUSIBLE/NON-FUSIBLE DISCONNECT SWITCH, NUMBERS INDICATE FRAME SIZE, NUMBER OF POLES AND FUSING. PROVIDE NEMA I ENCLOSURE INSIDE. PROVIDE NEMA 3 ENCLOSURE, WITH INTEGRATED OUTLET, (EQUAL TO MIDWEST U065NA1010) FOR ALL SWITCHES LOCATED OUTSIDE.  "FPN" INDICATES FUSE PER EQUIPMENT NAMEPLATE
	240/120V PANEL, RECESS MOUNTED, SEE SCHEDULE FOR DETAILS.
\(\text{EF}\)	EXHAUST FAN/LIGHT, PROVIDED AND INSTALLED BY MECHANICAL CONTRACTOR WIRED BY ELECTRICAL CONTRACTOR. PROVIDE DISCONNECTING MEANS AS REQUIRED. NUTONE AE80SL FAN EQUIPPED WITH 13W A19 5000K LED BULB. WIRE TO VANITY LIGHT ON TIMER SWITCH.
WH)	ELECTRIC WATER HEATER.
<b>\$</b>	CEILING MOUNTED LIGHT.
ф	WALL MOUNTED LIGHT.
®	CONNECTION FOR RANGE HOOD/FAN.
◀	TELEPHONE OUTLET.
<b>⊲</b> ™	CABLE TV OUTLET.
®	DOOR BELL, AT 80" AFF, WITH AUDIBLE AND VISUAL NOTIFICATION AND 120V TRANSFORMER. CONNECT TO NEAREST 120V CIRCUIT; EDWARDS SIGNALING 6536-G5. AMBER/YELLOW COLOR.
Ю	LOW VOLTAGE DOOR BELL BUTTON, IN METAL PUSH BUTTON HOUSING (EQUAL TO EDWARDS SIGNALING 147-10), CONNECTED TO DOOR BELL(S); EDWARDS SIGNALING 620-L. MOUNTED AT 48" AFF MAX.
AG	ATTENDANT CALL PULL STATION, 46" AFF TO CENTER W/ PULL STRING; PROVIDE WITH EMERGENCY POWER SOURCE BACKUP; EDWARDS SIGNALING 6538-G5. PULL STRING TO BE WITHIN 4" OF THE FLOOR.
AS	ATTENDANT CALL MINI-HORN AND STROBE COMBINATION UNIT, 80" AFF; PROVIDE WITH EMERGENCY POWER SOURCE BACKUP; EDWARDS SIGNALING WG4WN-HVMC.

(MS)(CO)

Drawing Sheet List							
#	Title						
E0.0	ELECTRICAL LEGEND, NOTES, AND SCHEDUL						
E0.1	ELECTRICAL DETAILS						
E1.0	ELECTRICAL BUILDING 1 PLANS NC 15-1						
E1.1	ELECTRICAL BUILDING 2 & 3 PLANS NC 15-1						
E1.2	ELECTRICAL BUILDING 4 & 5 PLANS NC 15-1						
E1.3	ELECTRICAL BUILDING 6 & 7 PLANS NC 15-1						
E1.4	ELECTRICAL BUILDING 8 & 9 PLANS NC 15-1						
E1.5	ELECTRICAL BUILDING 14 PLANS NC 15-1						
E1.6	ELECTRICAL BUILDING 15 PLANS NC 15-1						
E2.0	ELECTRICAL UNIT PLANS NC 15-1						
E2.1	ELECTRICAL UNIT PLANS NC 15-1						
E3.0	ELECTRICAL UNIT PLANS NC 15-1						
E3.1	ELECTRICAL UNIT PLANS NC 15-1						
E4.0	ELECTRICAL UNIT PLANS NC 15-1						
E4.1	ELECTRICAL UNIT PLANS NC 15-1						
E10.0	ELECTRICAL BUILDING C & C-A PLANS NC 15						
E11.0	ELECTRICAL UNIT PLANS NC 15-3						
E12.0	ELECTRICAL UNIT PLANS NC 15-3						
E12.1	ELECTRICAL UNIT PLANS NC 15-3						
E13.0	ELECTRICAL UNIT PANEL SCHEDULES						
E14.0	ELECTRICAL BUILDING RISER DIAGRAMS						
E14.1	ELECTRICAL BUILDING RISER DIAGRAMS						
E14.2	ELECTRICAL BUILDING RISER DIAGRAMS						
E14.3	ELECTRICAL BUILDING RISER DIAGRAMS						

	DESCRIPTION
	LIVING/BEDROOM - 18" FLUSH MOUNT CEILING FIXTURE.
	HALL - 14" FLUSH MOUNT CEILING FIXTURE.
	EXTERIOR - ADDRESS LIGHT W/ PHOTOCELL CONTROL. NO SWITCH.
	KITCHEN - 24" UNDERCOUNTER LED STRIP LIGHT.
1	

MARK

UD

UNIT FIXTURES

LIGHTING

VERSALED

LIGHTING

ADDRESS-0-LITE

JUNO

LIGHTING

LITHIONIA

LIGHTING

SEASONS

INVERTER

CATALOG NUMBERS AND MANUFACTURERS ARE TO INDICATE TYPE AND QUALITY OF FIXTURE DESIRED. SUBMIT CUTSHEETS OF THESE AND ALTERNATE MANUFACTURERS FOR ARCHITECT AND OWNER APPROVAL PRIOR TO PURCHASE OF ANY FIXTURES.

UNIT FIXTURE SCHEDULE

NO.

120

120

120

120

120

120

BALLAST DATA INPUT

WATTS

TYPE

MOUNTING

SURFACE

SURFACE

SURFACE

SURFACE

COLOR TEMPERATURES OF LED BULBS AND LED LAMPS SHALL BE CONFIRMED WITH THE ARCHITECT

#### LIGHTING SYSTEMS **ENERGY CONSERVATION CODE SECTION 405**

THIS PROJECT IS CLASSIFIED AS -**☒ RESIDENTIAL** 

<u>NA</u> VS. <u>NA</u>

<u>NA</u> VS. <u>NA</u>

LAMP DATA

TYPE

LED 18W

LED IIW

LED 5.5W

LED IIW

LED 40W

LED 17W

NO.

CATALOG

NUMBER

FCMP19 - 18"

FCMP19 - 14"

54833-BPA

UCES 24IN

FMLWL 48

326957

DUAL-LITE

LG250S

INTERIOR LIGHTING POWER DENSITY CALCULATION PER TABLE 405.4.2. SEE

EXTERIOR LIGHTING POWER DENSITY CALCULATION PER TABLE 405.6.2. SEE

NONTRADABLE EXTERIOR WATTAGE SPECIFIED VS. ALLOWED NA VS. NA

☐ COMMERCIAL (SEE BELOW)

KITCHEN - 48" LED STRIP CEILING FIXTURE

BATHROOM - 24" LED VANITY FIXTURE.

250 WATT EMERGENCY POWER SOURCE BACKUP

W/ WRAPAROUND ACRYLIC LENS.

LIGHTING POWER DENSITY CALCULATION COMPLIANCE

DESIGNER STATEMENT: TO THE BEST OF MY KNOWLEDGE AND BELIEF, THE DESIGN OF THIS BUILDING COMPLIES WITH THE LIGHTING SYSTEMS REQUIREMENTS OF THE INTERNATIONAL ENERGY CONSERVATION CODE, SECTION 505 AND ANY LOCAL AMENDMENTS THEREOF.

INVERTER.

SIGNED: PAUL SCOTT, PE ELECTRICAL ENGINEER

□ 406.1.2 □ 406.1.3 □ 406.1.4 □ 406.1.5 □ 406.1.6 ☐ 406.1.1

CONFIRM MANUFACTURER, TYPE AND FINISH OF ALL LIGHTING FIXTURES AND ACCESSORIES WITH ARCHITECT AND OWNER PRIOR TO PURCHASE AND INSTALLATION.

LIGHTING FIXTURE SCHEDULE FOR FIXTURE INFORMATION.

LIGHTING FIXTURE SCHEDULE FOR FIXTURE INFORMATION.

TRADABLE EXTERIOR WATTAGE SPECIFIED VS. ALLOWED

INTERIOR WATTAGE SPECIFIED VS. ALLOWED

SECTION 406 COMPLIANCE - X N/A

#### **ELECTRICAL ABBREVIATIONS**

18"	DIMENSION INDICATES HEIGHT ABOVE FINISHED FLOOR
AFF	AT WHICH CENTER OF DEVICE IS TO BE MOUNTED.  ABOVE FINISHED FLOOR.
AFG	ABOVE FINISHED GRADE.
E.C.	ELECTRICAL CONTRACTOR.
FPN	FUSE PER EQUIPMENT NAMEPLATE REQUIREMENTS.
G.C.	GENERAL CONTRACTOR.
M.C.	MECHANICAL CONTRACTOR.
P.C.	PLUMBING CONTRACTOR.
WP	INDICATES DEVICE TO HAVE WEATHERPROOF COVER.
UON	UNLESS OTHERWISE NOTED.

GENERAL ELECTRICAL NOTES

I. ALL ELECTRICAL WORK SHALL BE IN ACCORDANCE WITH THE 2020 EDITION OF

THE NATIONAL ELECTRICAL CODE AND ALL LOCAL AND STATE CODES.

2. ALL MATERIAL, DEVICES, APPLIANCES, AND EQUIPMENT SHALL BE NEW AND

INC., AND THE NATIONAL ELECTRICAL MANUFACTURERS ASSOCIATION.

AND INDICATE ONLY THE GENERAL ARRANGEMENT.

SWITCHES, WHITE LETTERS ON BLACK BACKGROUND.

BY BUSSMANN, UNLESS NOTED OTHERWISE.

WITH THE TRADE TO BE PERFORMED.

THWN AS REQUIRED.

TO PURCHASE.

REFRIGERATOR.

REQUIREMENTS.

(PAINT, SPACKLE, ETC.).

SHALL CONFORM TO THE STANDARDS OF THE UNDERWRITER'S LABORATORIES,

3. ALL ELECTRICAL PERMITS AND INSPECTION FEES SHALL BE OBTAINED AND PAID

4. ELECTRICAL CONTRACTOR SHALL GUARANTEE ALL WORK AND MATERIALS FOR

5. ALL CUTTING AND PATCHING OF WALLS AND FLOORS FOR ELECTRICAL

ONE YEAR EFFECTIVE THE DAY THE PROJECT IS ACCEPTED BY THE OWNER.

EQUIPMENT AS WELL AS SHELVING IN CLOSET AND LAUNDRY SHALL BE THE

6. CONDUCTORS #8 AND SMALLER SHALL BE COPPER RATED AT NOT LESS THAN

STRANDED. ALL CONDUCTORS #10 AND SMALLER SHALL BE SOLID, UNLESS

7. PROVIDE A TYPED DIRECTORY IN ALL PANELBOARDS CLEARLY DESCRIBING THE

ENGRAVED PHENOLIC NAMEPLATES FOR ALL PANELBOARDS AND DISCONNECT

8. FUSES 0 - 600 AMPS SHALL BE UL CLASS "RK-1" LOW PEAK DUAL ELEMENT TIME DELAY WITH 200,000 AMPERE INTERRUPTING RATING AS MANUFACTURED

9. ALL TERMINALS/LUGS SHALL BE 60/75° RATED. ALL TERMINALS, SPLICING CONNECTORS, LUGS, ETC SHALL BE IDENTIFIED FOR USE WITH THE MATERIAL

10. VERIFY ALL REQUIREMENTS AND COORDINATE EXACT LOCATION OF INCOMING

ELECTRICAL SERVICE WITH LOCAL POWER COMPANY PRIOR TO PROJECT

START-UP. NOTIFY ENGINEER OF ANY CHANGES AS MAY BE REQUIRED.

II. E.C. TO VERIFY DEVICE PLATE COLOR AND MATERIAL WITH ARCHITECT PRIOR

12. THE ELECTRICAL CONTRACTOR SHALL BE RESPONSIBLE FOR PROTECTING ALL

ELECTRICAL EQUIPMENT FROM FOREIGN MATERIAL DURING CONSTRUCTION

13. IN REQUIRED FIRE RATED WALLS AND PARTITIONS, OPENINGS FOR INSTALLATION

TO INSURE THAT THE INTEGRITY OF THE U.L. RATING IS MAINTAINED.

14. WHERE A HOME RUN IS SHOWN THE CIRCUIT SHALL NOT BE COMBINED WITH

15. ALL 15A/20A 120V RECEPTACLES IN RESIDENTIAL UNITS SHALL BE TAMPER

EQUAL TO COOPER VGF SERIES. AUDIBLE TYPE TO BE USED BEHIND

OTHER CIRCUITS. WHERE A CIRCUIT HOMERUN IS NOT SHOWN, THE

OF BOXES THAT ARE GREATER THAN 16 SQUARE INCHES SHALL BE PROTECTED AS REQUIRED BY U.L. COORDINATE CLOSELY WITH THE GENERAL CONTRACTOR

CONTRACTOR SHALL COMBINE CIRCUITS AS FOLLOWS: A MAXIMUM OF THREE 20A

BRANCH CIRCUITS MAY BE COMBINED IN A COMMON HOMERUN WITH SEPARATE NEUTRALS FOR A MAXIMUM TOTAL OF SIX CURRENT CARRYING CONDUCTORS. ALL BRANCH CIRCUITS LARGER THAN 20A SHALL BE SEPARATELY HOMERUN TO

PROOF, EQUAL TO COOPER TR SERIES; GROUND FAULT RECEPTACLES SHALL BE

ALL RECEPTACLE REPLACEMENT SHALL COMPLY WITH NEC 406.4 AND 406.5.

LIGHTING SWITCHES SHALL BE SPECIFICATION GRADE EQUAL TO HUBBELL 1200

ENSURE DEVICES ARE INSTALLED IN COMPLIANCE WITH ANSI AII7.1 FOR ADA

16. ALL EXTERIOR FIXTURES AND DEVICES SHALL BE RATED FOR OPERATION AT 0°

17. ALL QUESTIONS MUST BE SUBMITTED IN RFI FORMAT TO THE ARCHITECT AND

MUST BE ADDRESSED BY THE APPROPRIATE DESIGNER OF RECORD PRIOR TO

F AND SHALL BE DAMP OR WET LABELED AS REQUIRED.

BECOMING A PROPOSED CHANGE ORDER.

(CU/AL) OF THE CONDUCTOR AND SHALL BE PROPERLY INSTALLED.

LOCATION OF AND TYPE OF LOAD BEING SERVED FOR ALL CIRCUITS. PROVIDE

OTHERWISE NOTED. BRANCH CIRCUIT CONDUCTORS SHALL BE TYPE THHN OR

UNITS AND #12 ELSEWHERE. ALL WIRE #8 AWG AND LARGER SHALL BE

RESPONSIBILITY OF THE ELECTRICAL CONTRACTOR OR CONTRACTOR QUALIFIED


600 VOLTS. CONDUCTORS #6 AND LARGER MAY BE ALUMINUM RATED AT NOT


LESS THAN 600 VOLTS. MINIMUM SIZE SHALL BE #14 AWG WITHIN RESIDENTIAL

FOR BY THE ELECTRICAL CONTRACTOR. DRAWINGS ARE DIAGRAMMATIC ONLY

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6041B BID SET DRAWINGS - Page 119 of 142



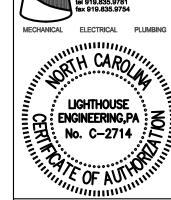
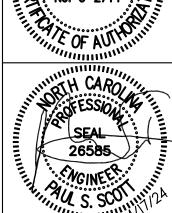
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COMM. NO.: 6041-B DRAWN BY: CHECKED BY: PSS DATE: APR. 2, 2024 SHEET NO.

F Ratings - 1 and 2 Hr T Rating — 0 Hr

in the Fire Resistance Directory and shall include the following construction features:

B. Gypsum Board\* 5/8 in. 4 ft wide with square or tapered edges. The gypsum wallboard type, number of layers and sheet orientation shall be as specified in the individual U300 or U400 Series Designs in the UL Fire Resistance Directory. Max diam of opening is 4 in.


5 steel pipe friction fit into wall assembly and installed flush with wall surfaces.

- sectional area of the opening. The annular space between the cable bundle and the periphery of the C. Type RGU/59 coaxial cable with polyethylene (PE) insulation and polyvinyl (PVC) jacket.

D. The 2/C No. 10 AWG cable with ground with polyvinyl (PVC) insulation and jacket. E. 3/C No. 12 AWG cable with polyvinyl chloride (PVC) insulation in a nominal 1/2 in. flexible metal

flush with both surfaces of wall. Fill material to be forced into interstices of cable bundle to the max extent possible on both surfaces of wall. Additional fill material to be installed such that a min 1/4 in. crown is formed around the cable bundle and lapped over the steel sleeve HILTI CONSTRUCTION CHEMICALS, DIV OF HILTI INC - CP618 Firestop Putty Stick

PENETRATION DETAIL

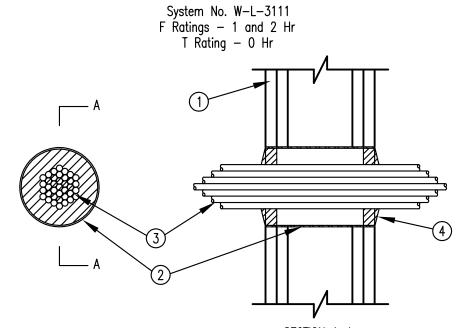

1. Wall Assembly The fire — rated gypsum wallboard/stud wall assembly shall be constructed of the materials and in the manner specified if the individual U300 or U400 Series Wall and Partition Designs A. Studs Wall framing shall consist of either wood studs or channel shaped steel studs. Wood studs to consist of 2 by 4 in. lumber spaced 16 in. OC. Steel studs to be min 2-1/2 in. wide, fabricated from min 25 MSG galvanized steel, spaced max 24 in. OC.


2. Metallic Sleeve - Optional The nominal 4 in. diam steel electrical metallic tubing (EMT) or Schedule

3. Cables Aggregate cross — sectional area of cables in cable tray to be max 25 percent of the cross opening to be min 1/8 in. to max 3/4 in. Cables to be rigidly supported on both sides of the wall assembly. Any combination of the following types and sizes of cables may be used: A. 6 pair - No. 24 AWG telephone cable with polyvinyl chloride (PVC) insulation and PVC jacket. B. 24 fiber optic cable with polyvinyl chloride (PVC) outer and subunit jacket.

4. Fill, Void or Cavity Material\* Putty - Min 5/8 in. thickness of fill material applied within annulus

\*Bearing the UL Classification Marking



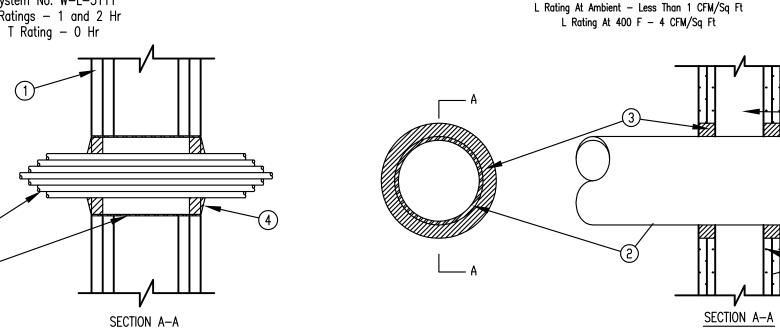

1. Wall Assembly The 1 or 2 hr fire—rated gypsum wallboard/stud wall assembly shall be constructed of the materials and in the manner specified in the individual U300 or U400 Series Wall and Partition Designs in the UL Fire Resistance Directory and shall include the following construction features:

System No. W-L-1054 F Ratings - 1 and 2 Hr (See Items 1 and 3) T Rating — 0 Hr

A. Studs Wall framing may consist of either wood studs or steel channel studs. Wood studs to consist of nom. 2 by 4 in. lumber spaced 16 in. OC. Steel studs to be min 2-1/2 in. wide and spaced max 24 in. OC. When steel studs are used and the diam, of opening exceeds the width of stud cavity, the opening shall be framed on all sides using lengths of steel stud installed between the vertical studs and screw-attached to the steel studs at each end. The framed opening in the wall shall be 4 to 6 in. wider and 4 to 6 in. higher than the diam. of the penetrating item such that, when the penetrating item is installed in the opening, a 2 to 3 in. clearance is present between the penetrating item and the framing on all four

B. Gypsum Board\* 5/8 in. thick, 4 ft wide with square or tapered edges. The gypsum wallboard type, thickness, number of layers, fastener type and sheet orientation shall be as specified in the individual U300 or U400 Series Design in the UL Fire Resistance Directory. Max. diam. of opening is 32-1/4 in. for steel stud walls. Max. diam. of opening is 14-1/2 in.


The F Rating of the firestop system is equal to the fire rating of the wall assembly. 2. Through-Penetrants One metallic pipe, conduit or tubing to be installed either concentrically or eccentrically within the firestop system. An annular space of min 0 in. to max 2-1/4 in. is required within firestop system. Pipe, conduit or tubing

to be rigidly supported on both sides of wall assembly. The following types and sizes of metallic pipes, conduits or tubing A. Steel Pipe Nom. 30 in. diam. (or smaller) schedule 10 (or heavier) steel pipe.

B. Iron Pipe Nom. 30 in. diam. (or smaller) cast or ductile iron pipe. C. Conduit Nom. 4 in. diam. (or smaller) steel electrical metallic tubing or 6 in. diam. steel conduit. D. Copper Tubing Nom. 6 in. diam. (or smaller) Type L (or heavier) copper tubing. E. Copper Pipe Nom. 6 in. diam. (or smaller) regular (or heavier) copper pipe.


3. Fill, Void or Cavity Material\* - Sealant Min 5/8 in. or 1-1/4 in. thickness of fill material applied within the annulus, flush with both surfaces of wall for 1 or 2 hr walls, respectivley. At the point contact location between pipe and wall, a min 1/2 in. diam. bead of fill material shall be applied at the pipe covering/wall interface on both surfaces of wall. HILTI CONSTRUCTION CHEMICALS, DIV OF HILTI INC - FS-One Sealant \*Bearing the UL Classification Mark



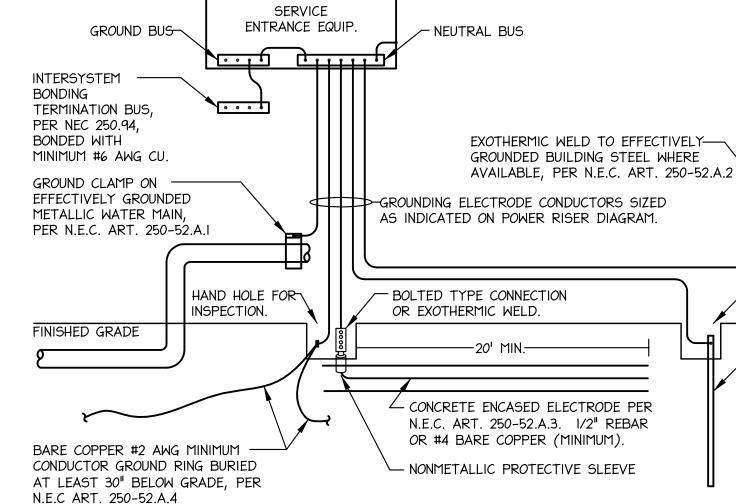



GROUNDING ELECTRODES SHALL BE PROVIDED IN ACCORDANCE WITH NEC SECTION 250. ALL GROUNDING ELECTRODE CONDUCTORS SIZED AS INDICATED ON POWER RISER DIAGRAM. ALL METHODS OF CREATING THE GROUNDING SYSTEM MAY NOT BE REQUIRED OR AVAILABLE.

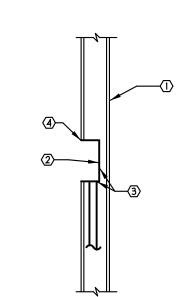

System No. W-L-8004

F Rating — 2 Hr

T Rating - 1/4 Hr

1. Wall Assembly The fire-rated gypsum wallboard/stud wall assembly shall be constructed of the materials and in the

manner specified in the individual U300 or U400 Series Wall and Partition Designs in the UL Fire Resistance Directory and shall include the following construction features:

A. Stude Wall framing may consist of either wood studs or steel channel studs. Wood studs to consist of nom 2 by

4 in. lumber spaced 16 in. OC. Steel studs to be min 2-1/2 in. wide and spaced max 24 in. OC. Additional framing

B. **Gypsum Board\*** Two layers of nom 5/8 in. thick gypsum wallboard, as specified in the individual Wall and Partition Design. Max area of opening is 96 sq in. with max dimension of 12 in. Max width of opening in wood stud

(not shown) may be installed around the perimeter of the opening in lieu of the steel wire mesh (Item No. 3A).

B. Max 25 pair - No. 24 AWG (or smaller) telephone cable with polyvinyl chloride (PVC) insulation and jacket.

D. Nom 2 in. diam (or smaller) Schedule 40 PVC pipe for use in closed (process or supply) piping systems only.

3. Firestop System The firestop system shall consist of the following:

A. Steel Wire Mesh No. 8 steel wire mesh having a min 1 in. lap along the longitudinal seam. Length of steel wire

mesh to be 4-3/4 in., centered and formed to fit periphery of through opening. Steel wire mesh is not required when

additional framing members (Item No. 1A) are used.

B. **Packing Material** Min 4.0 in. thickness of min 3.5 pcf mineral wool batt insulation firmly packed into opening as a permanent form. Packing material to be recessed from both surfaces of wall as required to accommodate the

C. Fill, Void or Cavity Material - Section Min 1/2 in. thickness of fill material applied within the annulus, flush with

PENETRATION DETAIL

E. Max 300 kcmil (or smaller) power cable with PVC insulation and PVC/nylon jacket. The through penetrating items

2. Through Penetrants The following types and sizes of pipes, conduits, tubing or cables may be used:

C. Max 3/C with ground — No. 10 AWG (or smaller) Type NM cable with PVC insulation and jacket.

to be rigidly supported on both sides of wall assembly and located as shown in the table below:

Distance Between Adjacent Pen. Item In. 1-11/16 7-7/16

7-7/16 1-11/16 7-7/16 7-7/16 1-11/16 7-7/16 7-7/16 1-11/16 7-7/16

both surfaces of wall.

HILTI CONSTRUCTION CHEMICALS, DIV OF HILTI INC - FS-ONE Sealant

A. Nom 3 in. diam (or smaller) electrical metallic tubing (EMT).

7-7/16 7-7/16

SECTION A-A

NOTE: THIS DETAIL APPLIES TO I AND 2 HOUR WALL ASSEMBLIES WITH MAXIMUM 4"x4" FLUSH ELECTRICAL BOXES ON OPPOSITE SIDES OF WALLS THAT HAVE LESS THAN 24" SEPARATION BETWEEN THEM AND ALL STAGGERED STUD WALLS. BOXES NOT PERMITTED BACK-TO-BACK.

1 OR 2 HOUR WALL ASSEMBLY EQUIVALENT TO UL300 OR UL400 SERIES.

② ELECTRICAL OUTLET BOX, NOT MORE THAN 100 SQUARE INCHES PER 100 SQUARE FEET WALL

3 MOLDABLE PUTTY PADS ARE TO BE INSTALLED TO COMPLETELY COVER THE EXTERIOR SURFACES OF THE BOX WITHIN THE STUD CAVITY WITH A BALL OF THE PUTTY MATERIAL USED TO PLUG THE END OF EACH ELECTRICAL METALLIC TUBE OR CONDUIT AT ITS CONNECTION TO THE BOX.

4 PUTTY PAD EQUIVALENT TO 3M #MPP-4S. 1/8" THICK PADS REQUIRED FOR I HOUR WALLS 1/4" THICK PADS REQUIRED FOR 2 HOUR WALLS A MAXIMUM 1/8" GAP BETWEEN BOX AND


PENETRATION DETAIL

CORNERS - ONLY ONE RECEPTACLE MAY BE IN THE SHADED AREA. NO SWITCHES ALLOWED UNLESS A 3-WAY SWITCH IS LOCATED IN AN ACCESSIBLE LOCATION. 36" MIN. 24" MAX. TO FACE OF ELECTRICAL -RECEPTACLE. AT FULLY OUTLET MOUNTED ACCESSIBLE LOCATIONS OBSTRUCTION AT MAX 46" AFF. (COMMON AREAS AND TYPE (REFRIG., WALL, "A" UNITS) BACKSPLASH STANDARD 24" DEEP SHALL BE FURRED OUT I" BASE CABINETS WITH OR A I" BOX EXTEND SHALL 25" COUNTER. BE PROVIDED.

ACCESSIBLE SWITCH AND OUTLET LOCATIONS

THESE REQUIREMENTS APPLY TO ALL RESIDENTIAL UNITS THAT ARE REQUIRED TO BE ACCESSIBLE AND/OR CONVERTABLE TO BEING ACCESSIBLE. PROVIDE SWITCHES/CONTROLS IN AN ACCESSIBLE LOCATION FOR CONTROL OF

RANGE HOODS AND OTHER BUILT-IN APPLIANCES. 2. AT BATHROOM VANITIES RECEPTACLES LOCATED ON THE SIDE WALL SHALL BE NO MORE THAN 12" FROM THE FRONT EDGE OF THE VANITY.

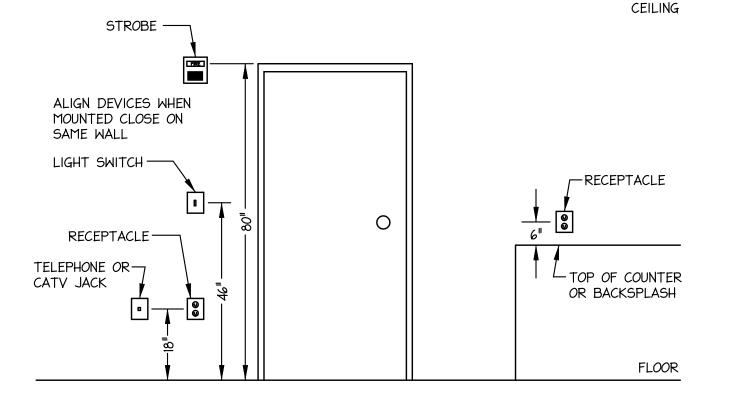

TYPICAL DEVICE MOUNTING HEIGHTS

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<del>-6041B BID SET DRAWINGS - Page ¹20 of 142°</del>

- HAND HOLE FOR

— 3/4"Φ X 8'-0" MIN.

CU GROUND ROD

DRIVEN TO ±6"

BELOW FINISH

GRADE.

INSPECTION.

TERMINAL CABINET PER LOCAL UTILITY REQUIREMETS.

GENERAL NOTES: (THIS SHEET)

ORGANIZED MANNER.

REQUIRED WORKING CLEARANCE.

24"W X 24"H x 6-3/4"D NEMA 3R LOCKABLE, HINGED CABLE TV TERMINAL CABINET PER LOCAL UTILITY REQUIREMETS.

I. PROVIDE CONNECTION TO WEATHERPROOF DISCONNECT FOR UNIT HEAT PUMPS PER RESPECTIVE UNIT PLAN AND PANEL SCHEDULE.

2. ALL DISCONNECT SWITCHES SHALL BE INSTALLED TO PERMIT

3. ALL CONDUIT RUNS AND ROUTING SHALL BE LAID OUT IN AN

4. CONFIRM A SERVICE RECEPTACLE IS WITHIN 25'-0" OF ALL HVAC EQUIPMENT. PROVIDE ADDITIONAL DEVICES AS NEEDED.

5. ALL RECEPTACLES ARE POWERED FROM THEIR RESPECTIVE UNIT.

HP-3 ELECTRICAL SERVICE, SEE DETAIL 1/E14.0 21

BUILDING 1 - NC 15-1 1/8"=1'-0" FAIRVIEW CIRCLE

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ELECTRICAL BUILDING 1 PLANS NC 15-1


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SHEET NO.

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# ELECTRICAL SERVICE, SEE DETAIL 3/EI4.0 HP-2 HP-2 BUILDING 3 - NC 15-1 1/8"=1'-0" FAIRVIEW CIRCLE





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GENERAL NOTES: (THIS SHEET)

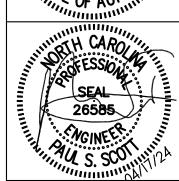- I. PROVIDE CONNECTION TO WEATHERPROOF DISCONNECT FOR UNIT HEAT PUMPS PER RESPECTIVE UNIT PLAN AND PANEL SCHEDULE.
- 2. ALL DISCONNECT SWITCHES SHALL BE INSTALLED TO PERMIT REQUIRED WORKING CLEARANCE.
- 3. ALL CONDUIT RUNS AND ROUTING SHALL BE LAID OUT IN AN ORGANIZED MANNER.
- 4. CONFIRM A SERVICE RECEPTACLE IS WITHIN 25'-0" OF ALL HVAC EQUIPMENT. PROVIDE ADDITIONAL DEVICES AS NEEDED.
- 5. ALL RECEPTACLES ARE POWERED FROM THEIR RESPECTIVE UNIT.

TAGGED NOTES: (THIS SHEET)

- 24"W X 24"H x 6-3/4"D NEMA 3R LOCKABLE, HINGED TELEPHONE TERMINAL CABINET PER LOCAL UTILITY REQUIREMETS.
- 2 24"W X 24"H x 6-3/4"D NEMA 3R LOCKABLE, HINGED CABLE TV TERMINAL CABINET PER LOCAL UTILITY REQUIREMETS.

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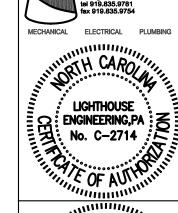
ELECTRICAL BUILDING 2 & 3 PLANS NC 15-1 COMM. NO.: 6041-B


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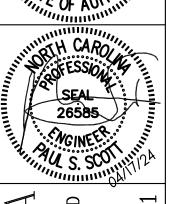
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6041B BID SET DRAWINGS - Page 122 of 142°

2 BUILDING 5 - NC 15-1
1/8"=1'-0" FAIRVIEW CIRCLE





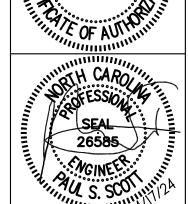

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ELECTRICAL BUILDING 4 & 5 PLANS NC 15-1

COMM. NO.: 6041-B DRAWN BY: CHECKED BY: PSS DATE: APR. 2, 2024

SHEET NO.

<del>- 6041B BID SET DRAWINGS - Page 123 of 142 <sup>∠</sup></del>

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3. ALL CONDUIT RUNS AND ROUTING SHALL BE LAID OUT IN AN

4. CONFIRM A SERVICE RECEPTACLE IS WITHIN 25'-0" OF ALL HVAC EQUIPMENT. PROVIDE ADDITIONAL DEVICES AS NEEDED.


5. ALL RECEPTACLES ARE POWERED FROM THEIR RESPECTIVE UNIT.

24"W X 24"H x 6-3/4"D NEMA 3R LOCKABLE, HINGED TELEPHONE TERMINAL CABINET PER LOCAL UTILITY REQUIREMETS.

24"W X 24"H x 6-3/4"D NEMA 3R LOCKABLE, HINGED CABLE TV TERMINAL CABINET PER LOCAL UTILITY REQUIREMETS.

ORGANIZED MANNER.

TAGGED NOTES: (THIS SHEET)

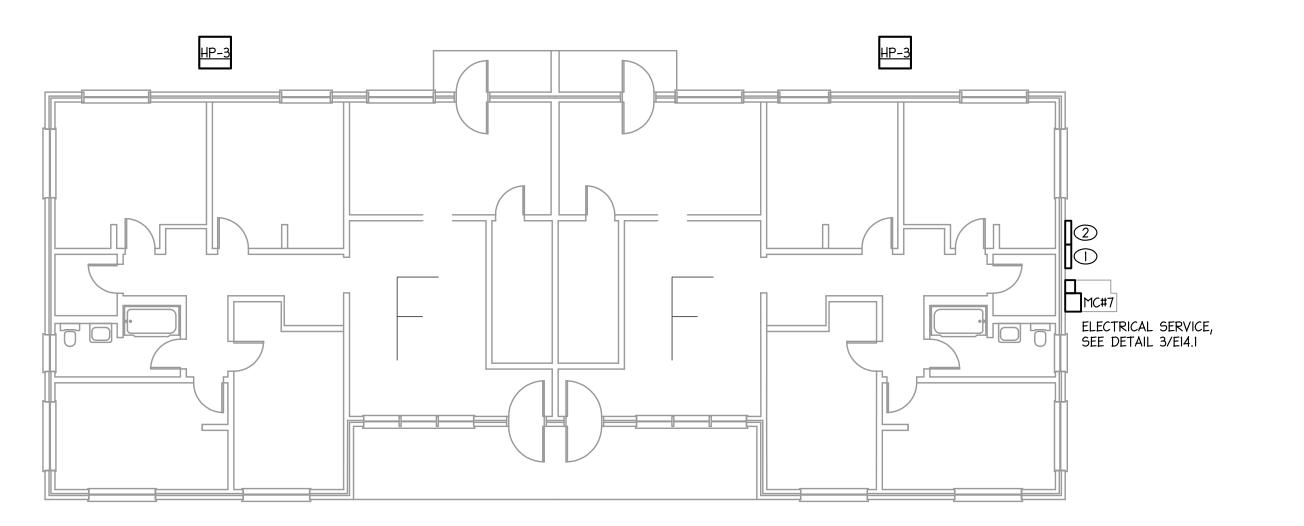

BUILDING 7 - NC 15-1

1/8"=1'-0" FAIRVIEW CIRCLE

#### GENERAL NOTES: (THIS SHEET)

- I. PROVIDE CONNECTION TO WEATHERPROOF DISCONNECT FOR UNIT HEAT PUMPS PER RESPECTIVE UNIT PLAN AND PANEL SCHEDULE.
- 2. ALL DISCONNECT SWITCHES SHALL BE INSTALLED TO PERMIT REQUIRED WORKING CLEARANCE.
- 3. ALL CONDUIT RUNS AND ROUTING SHALL BE LAID OUT IN AN ORGANIZED MANNER.
- 4. CONFIRM A SERVICE RECEPTACLE IS WITHIN 25'-0" OF ALL HVAC EQUIPMENT. PROVIDE ADDITIONAL DEVICES AS NEEDED.
- 5. ALL RECEPTACLES ARE POWERED FROM THEIR RESPECTIVE UNIT.

#### TAGGED NOTES: (THIS SHEET)

- $\bigcirc$  24"W X 24"H x 6-3/4"D NEMA 3R LOCKABLE, HINGED TELEPHONE TERMINAL CABINET PER LOCAL UTILITY REQUIREMETS.
- 2 24"W X 24"H x 6-3/4"D NEMA 3R LOCKABLE, HINGED CABLE TV TERMINAL CABINET PER LOCAL UTILITY REQUIREMETS.

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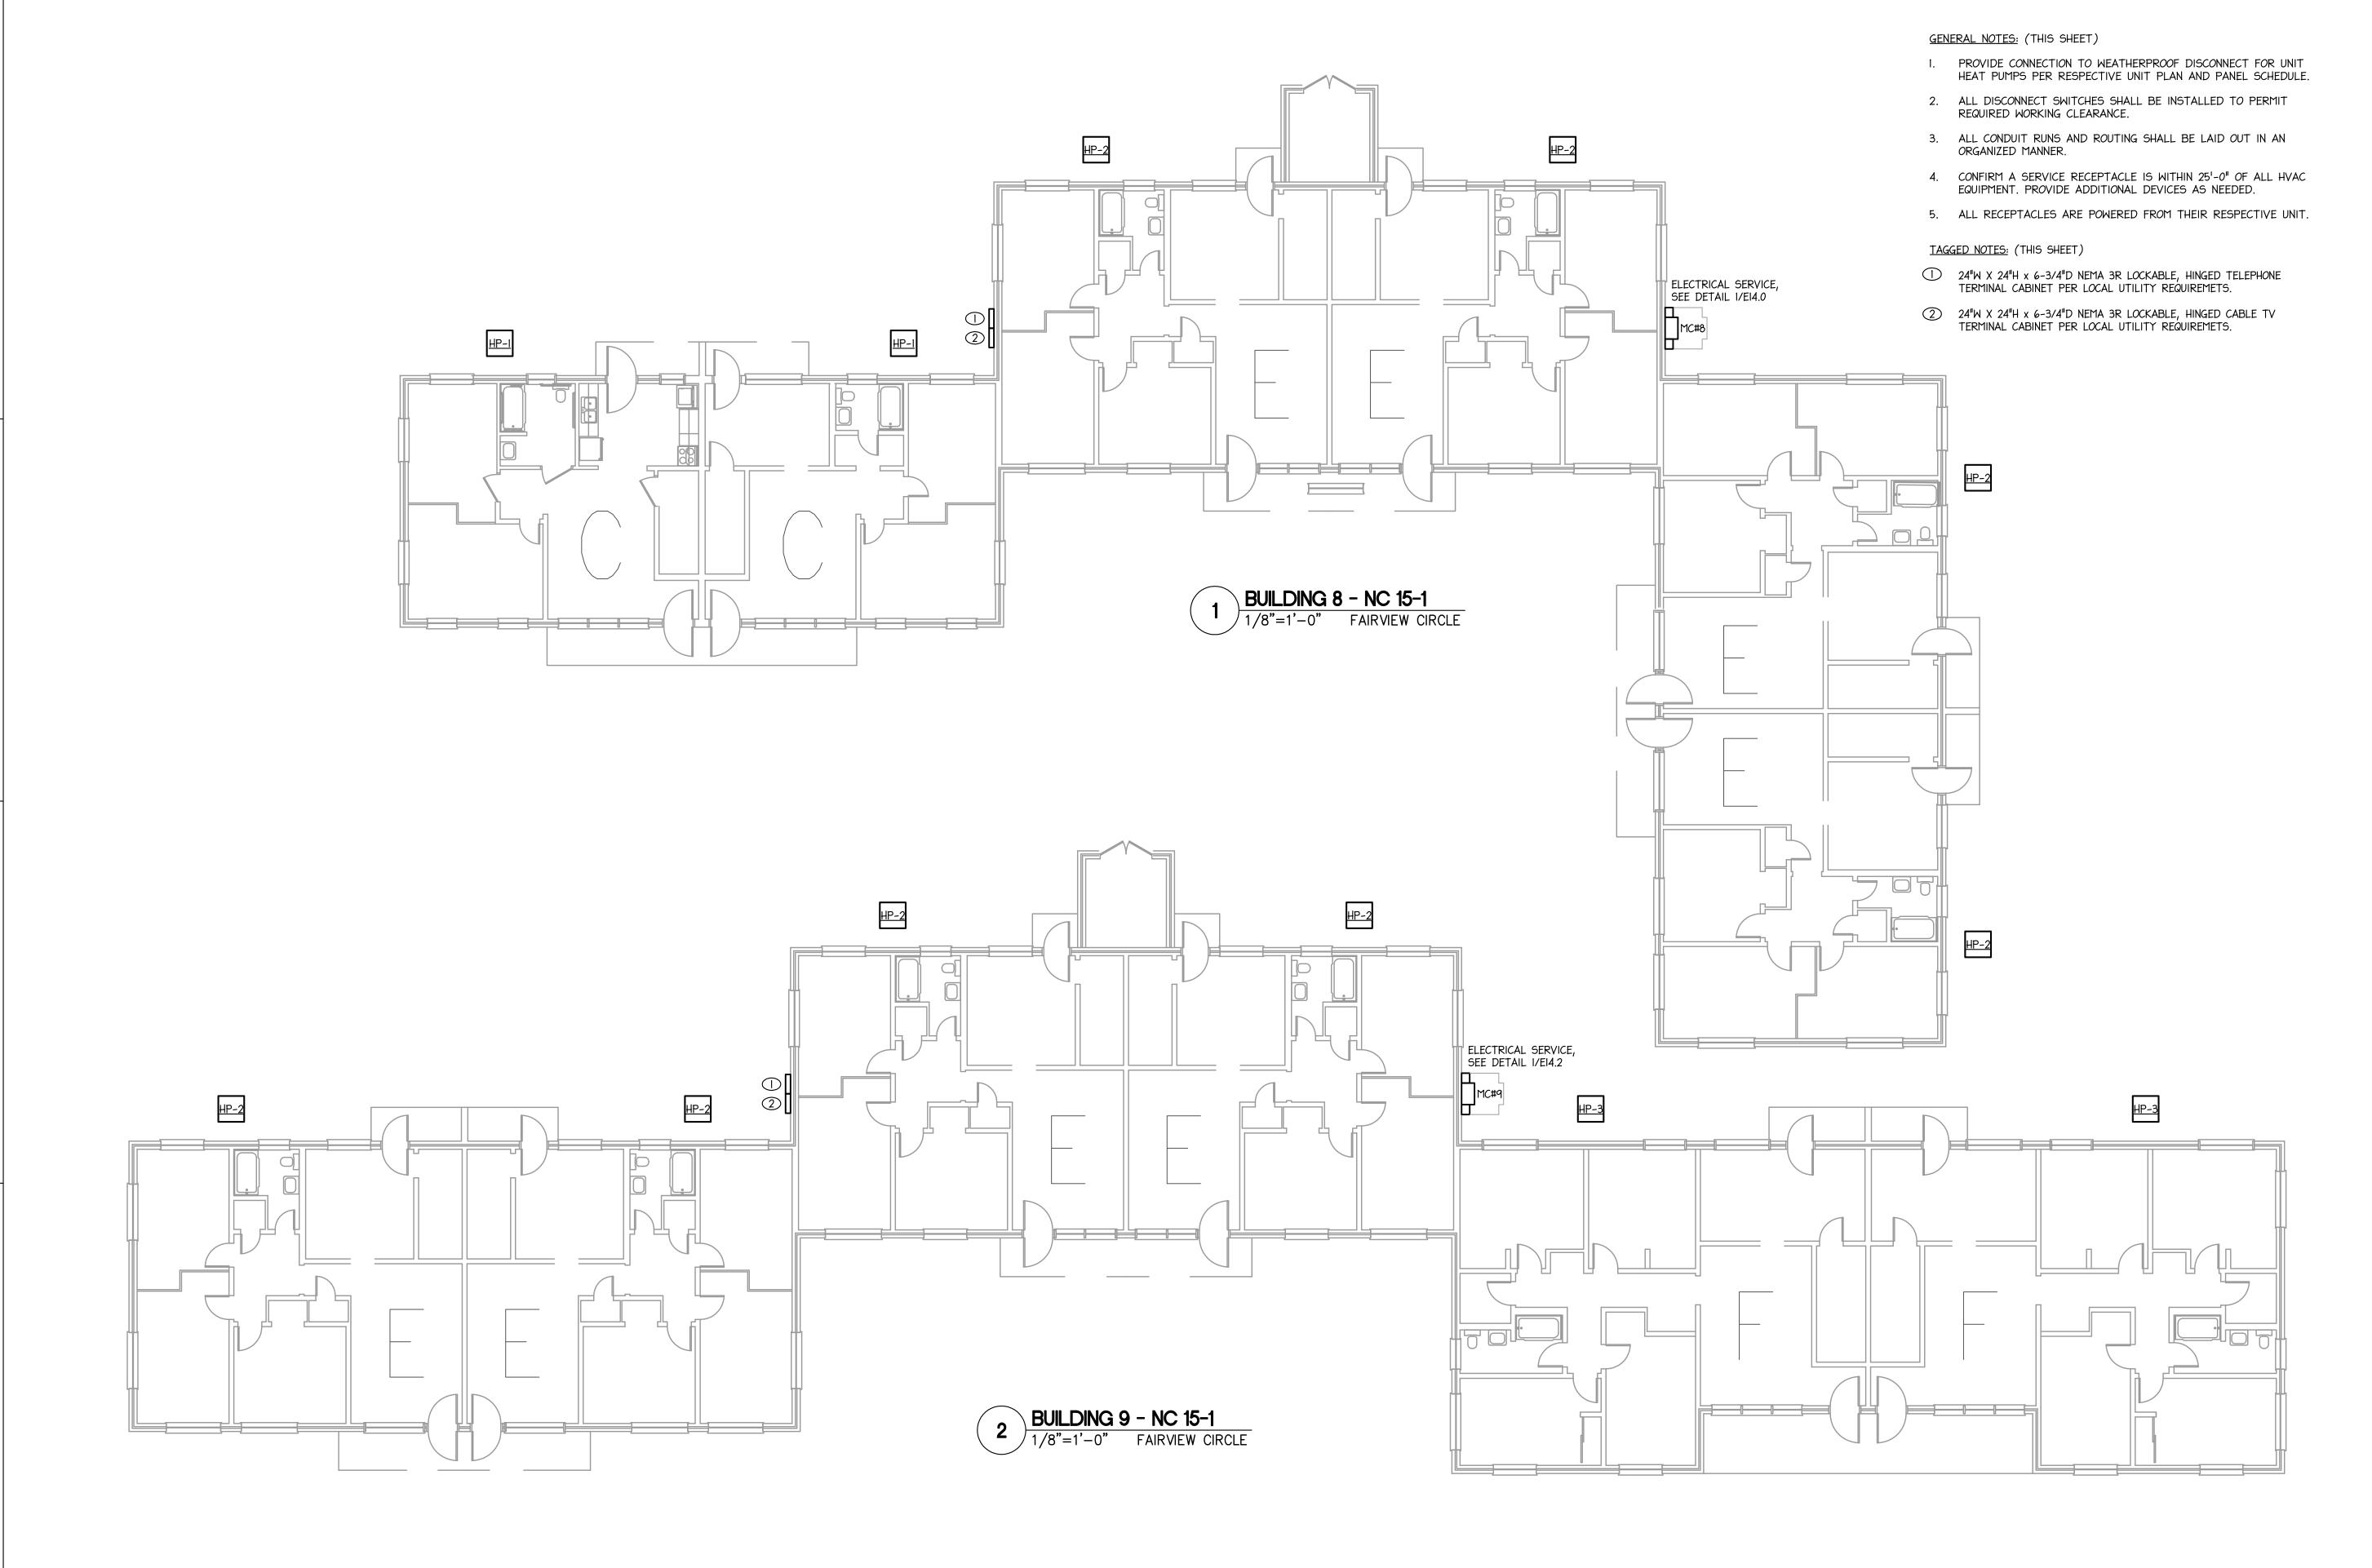
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ELECTRICAL BUILDING 6 & 7 PLANS NC 15-1


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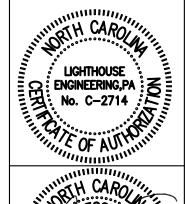
6041B BID SET DRAWINGS - Page 124 of 142










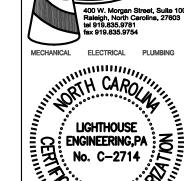



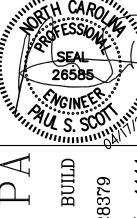

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ELECTRICAL BUILDING 8 & 9 PLANS NC 15-1

COMM. NO.: 6041-B DRAWN BY: CHECKED BY: PSS DATE: APR. 2, 2024

SHEET NO.

6041B BID SET DRAWINGS - Page 125 of 142

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LIGHTHOUSE ENGINEERING, PA No. C-2714

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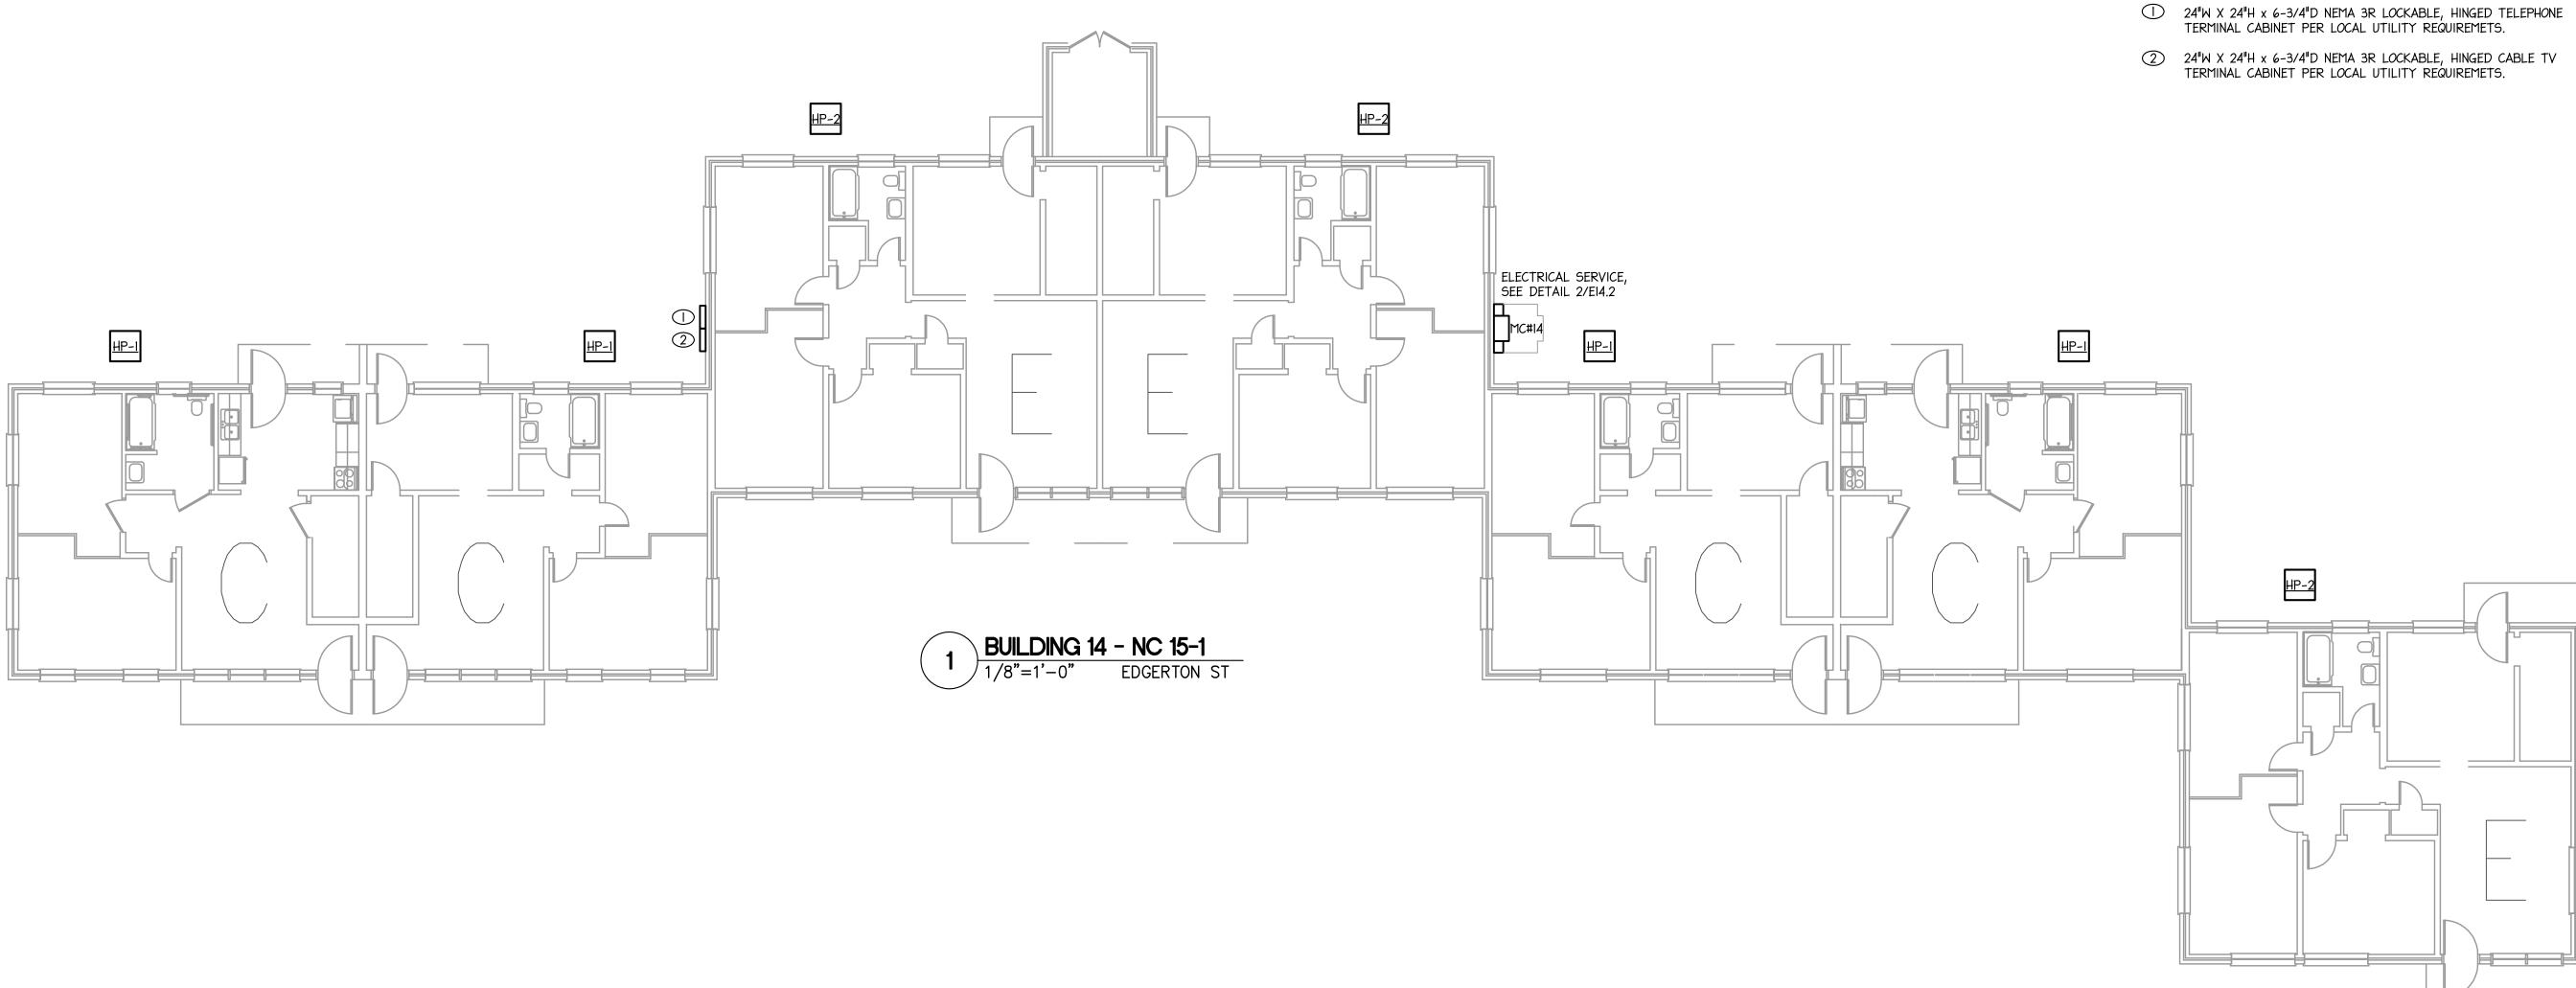
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Housing City ELECTRICAL BUILDING 14 PLANS NC 15-1

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SHEET NO. 6041B BID SET DRAWINGS - Page 126 of 142



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Housing City ELECTRICAL BUILDING 15 PLANS NC 15-1

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DATE: APR. 2, 2024 SHEET NO.

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6041B BID SET DRAWINGS - Page 127 of 142 `

5. ALL RECEPTACLES ARE POWERED FROM THEIR RESPECTIVE UNIT.

24"W X 24"H x 6-3/4"D NEMA 3R LOCKABLE, HINGED TELEPHONE TERMINAL CABINET PER LOCAL UTILITY REQUIREMETS.


24"W X 24"H x 6-3/4"D NEMA 3R LOCKABLE, HINGED CABLE TV TERMINAL CABINET PER LOCAL UTILITY REQUIREMETS.

TAGGED NOTES: (THIS SHEET)

- I. ALL CIRCUIT NUMBERS SHOWN TO RESPECTIVE UNIT PANEL. SEE SHEET EI3.0 FOR PANEL SCHEDULES.
- 2. REFER TO ID PLANS FOR DIMENSIONS, UNLESS NOTED OTHERWISE.
- 3. VERIFY EXTERIOR LIGHTING LOCATIONS AND PRODUCT SELECTION WITH ARCHITECT PRIOR TO ROUGH-IN.
- 4. SEE DETAIL 3/E0.1 FOR FURTHER INFORMATION ON ADA SWITCH AND OUTLET LOCATIONS.

#### TAGGED NOTES: (UNIT PLANS)

- PROVIDE INTEGRAL DISCONNECT SWITCH FOR UNIT'S HVAC AH UNIT. SEE UNIT PANEL SCHEDULE FOR ACTUAL WIRE AND BREAKER SIZE. DISCONNECT SWITCH SHALL BE INSTALLED TO PERMIT REQUIRED WORKING CLEARANCE. WHERE PRESENT, E.C. TO CONNECT 24V HVAC TRANSFORMER; COORDINATE WITH M.C.
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- 3 CIRCUIT FOR EACH UNIT'S WATER HEATER. SEE UNIT PANEL SCHEDULE FOR ACTUAL WIRE AND BREAKER SIZE. DISCONNECT SHALL BE BREAKER WITH LOCK-OFF DEVICE.
- 4 COMM CABINET FOR INTERFACE WITH TEL. AND CATV. SERVICES. COORDINATE REQUIREMENTS WITH UTILITIES AND MOUUNTING WITH ARCHITECT.

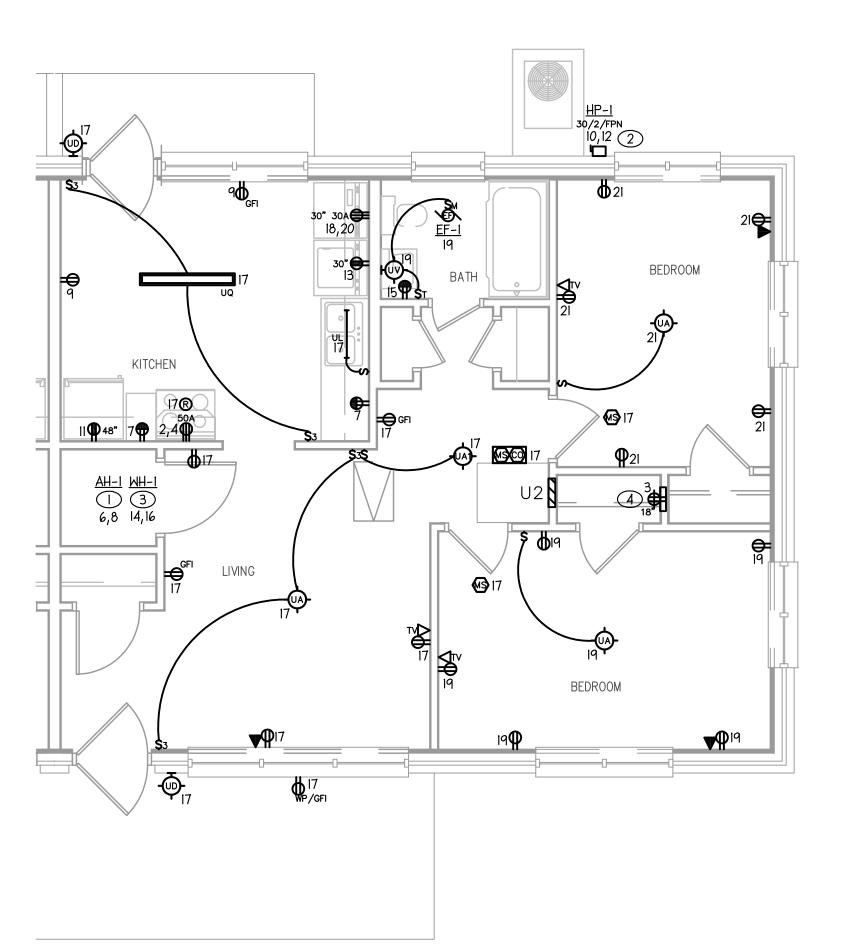







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ELECTRICAL UNIT PLANS NC 15-1


COMM. NO.: 6041-B DRAWN BY: CHECKED BY: PSS DATE: APR. 2, 2024

SHEET NO. 6041B BID SET DRAWINGS - Page 128 of 142

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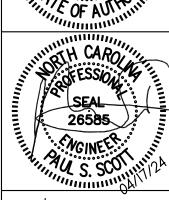
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ELECTRICAL UNIT PLANS NC 15-1

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COMM. NO.: 6041-B DRAWN BY: CHECKED BY: PSS DATE: APR. 2, 2024 SHEET NO.


6041B BID SET DRAWINGS - Page 130 of 142

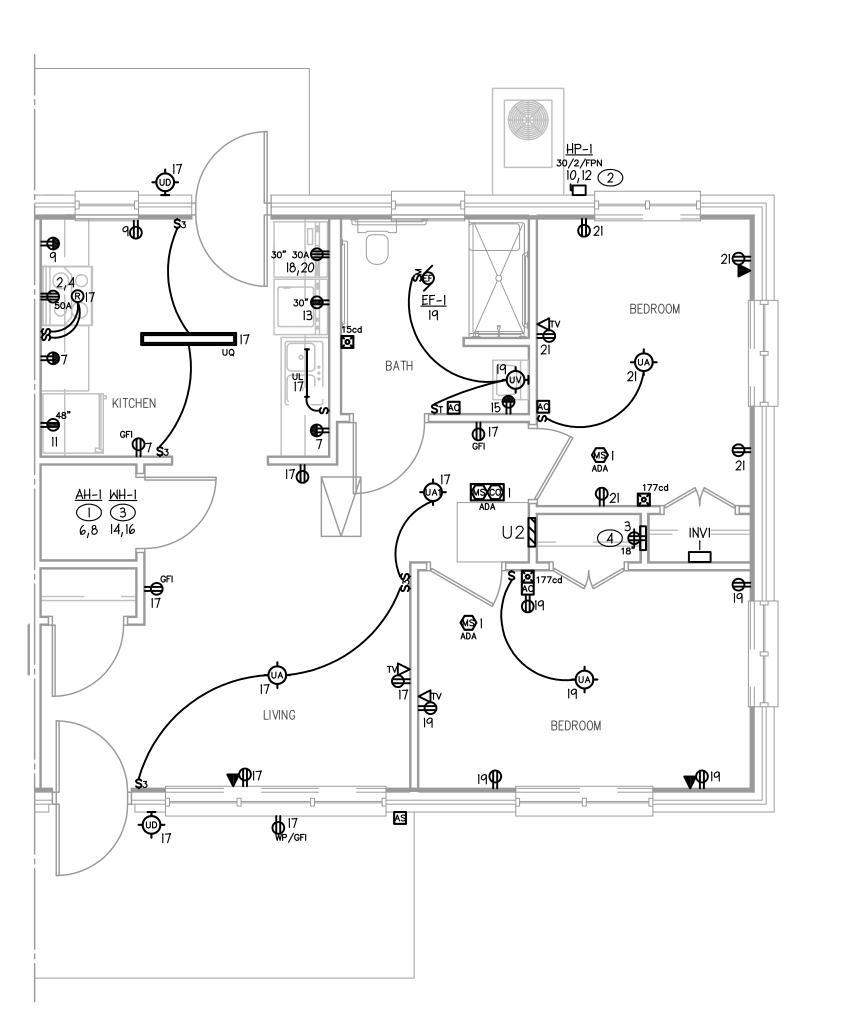GENERAL NOTES: (UNIT PLANS)

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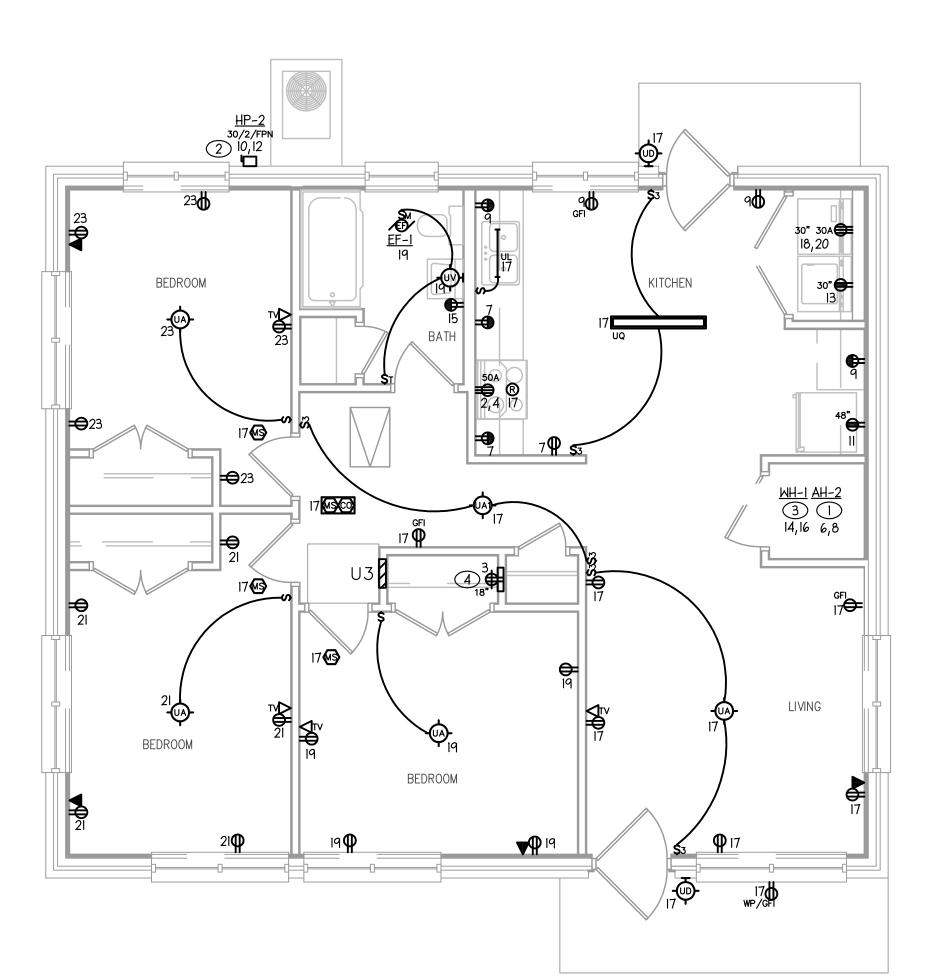





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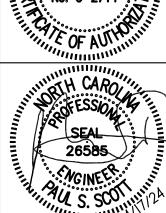
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THREE BEDROOM UNIT - NC 15-1 BUILDING TYPE 'E-1'

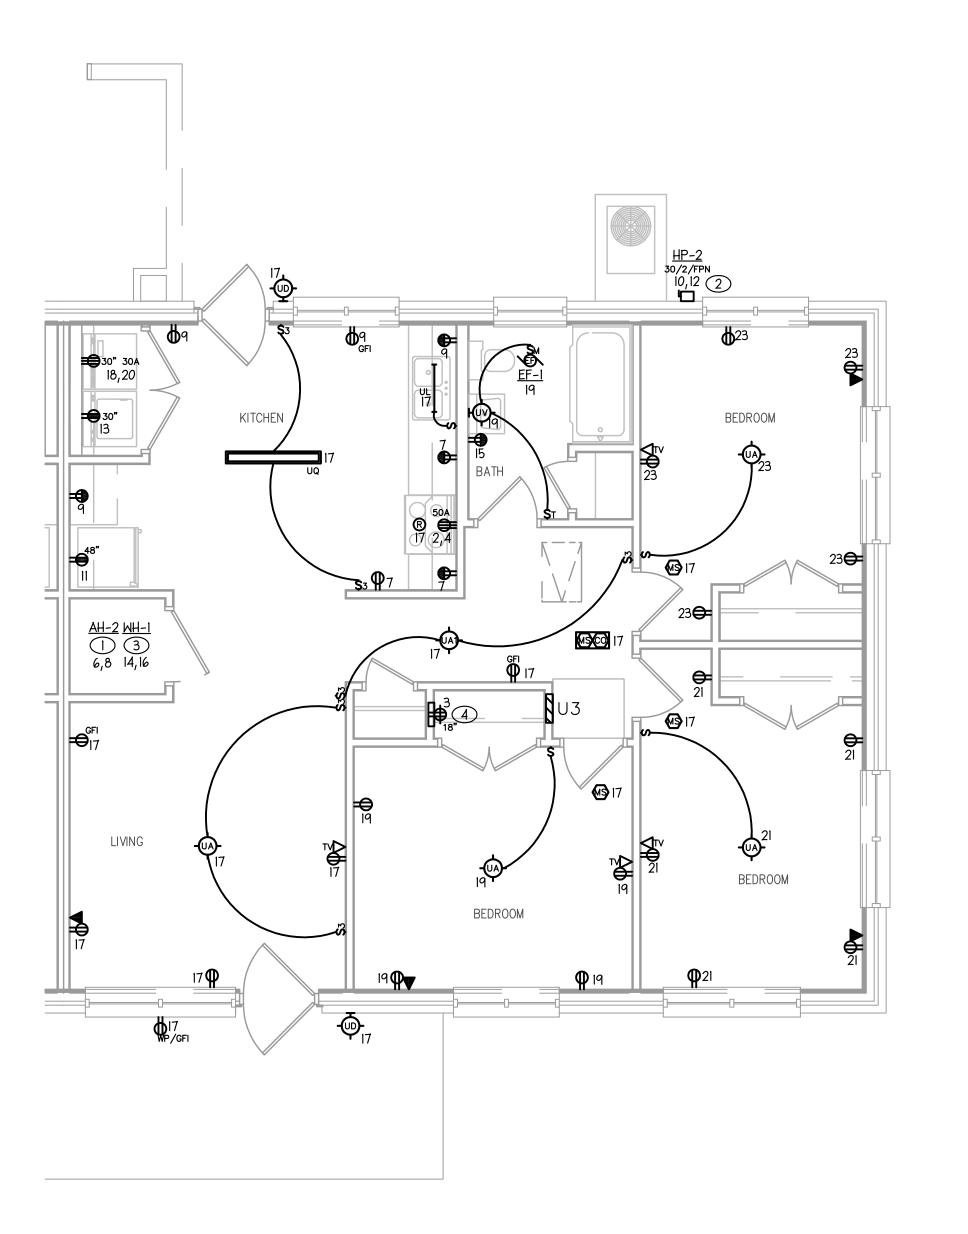



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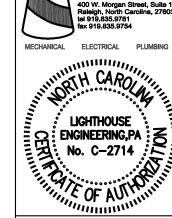
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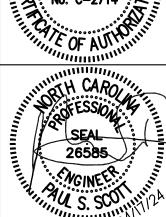
ELECTRICAL UNIT PLANS NC 15-1

COMM. NO.: 6041-B DRAWN BY: CHECKED BY: PSS DATE: APR. 2, 2024

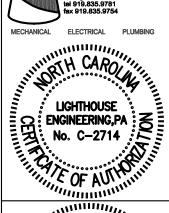SHEET NO.

6041B BID SET DRAWINGS - Page 131 of 142°





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Housing City ELECTRICAL UNIT PLANS

NC 15-1 COMM. NO.: 6041-B

DRAWN BY: CHECKED BY: PSS DATE: APR. 2, 2024 SHEET NO.


6041B BID SET DRAWINGS - Page 132 of 142

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ELECTRICAL UNIT PLANS NC 15-1

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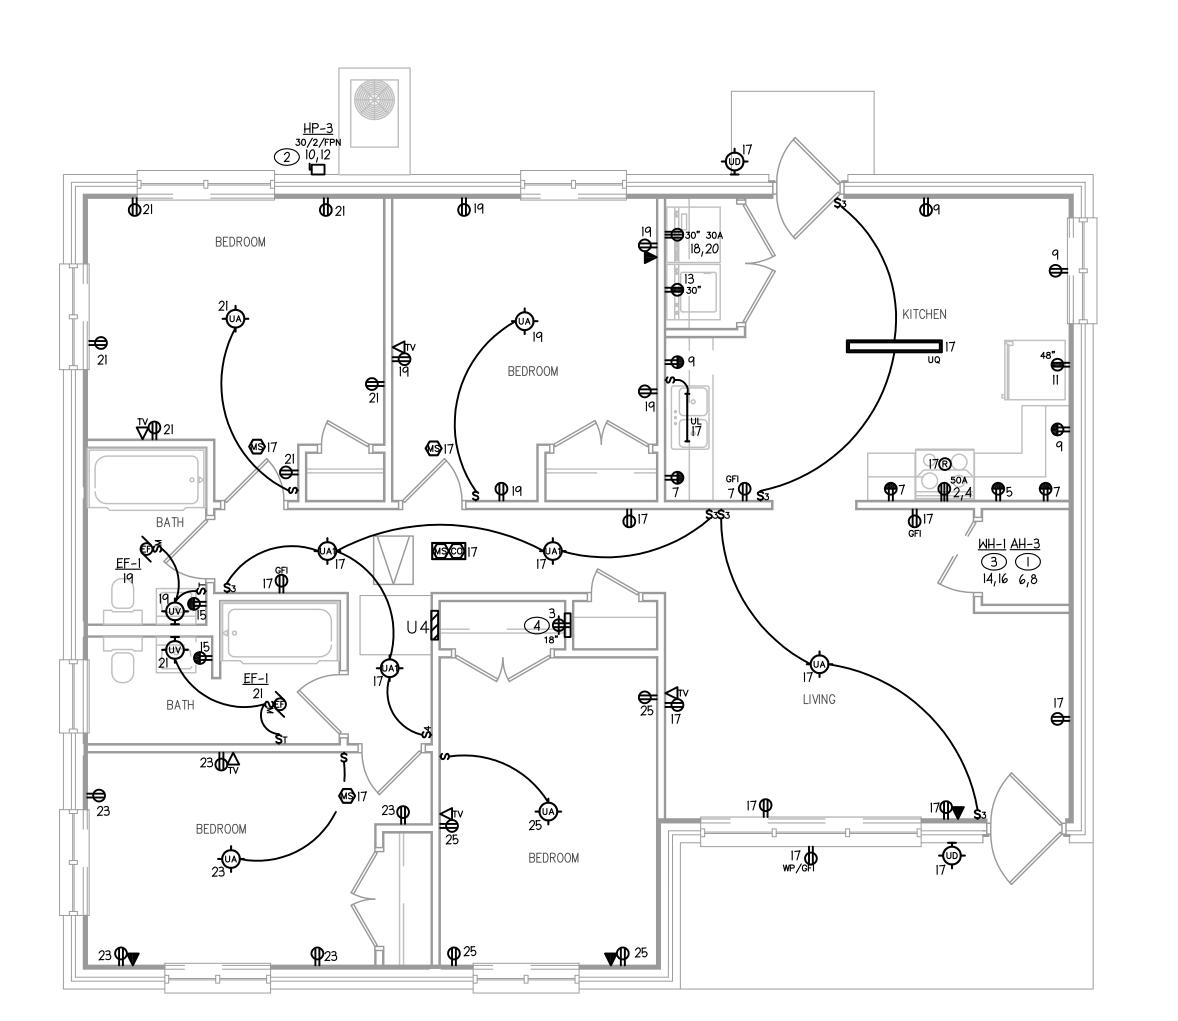
6041B BID SET DRAWINGS - Page 133 of 142°


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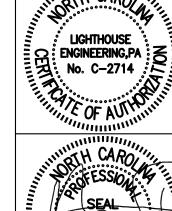


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ELECTRICAL BUILDING C & C-A PLANS NC 15-1
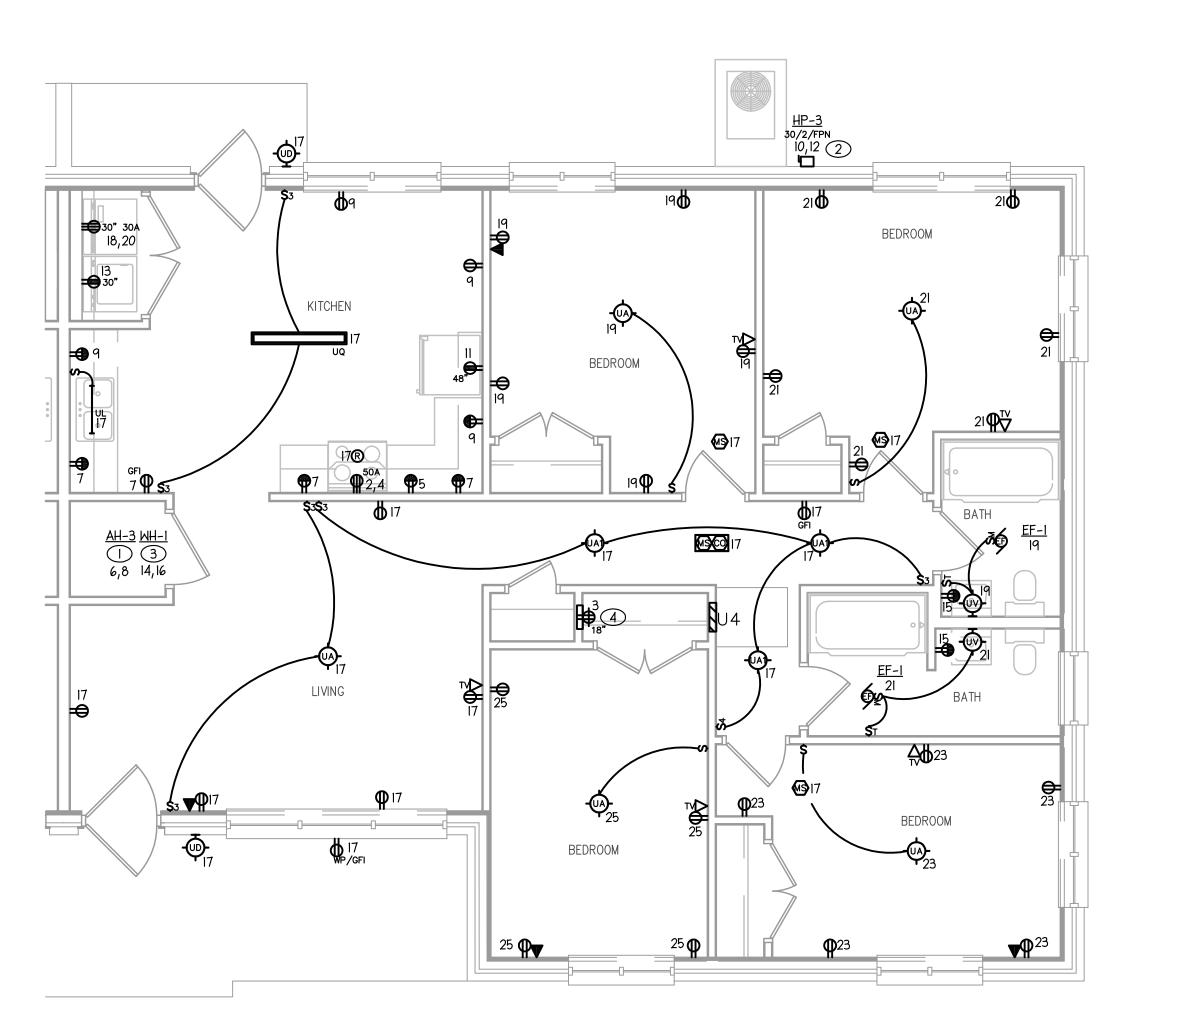
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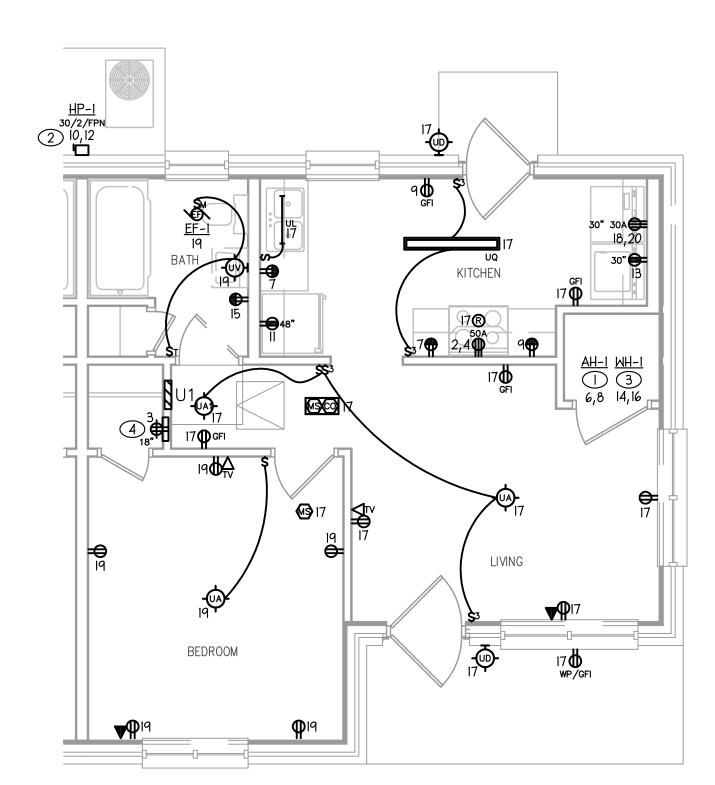
6041B BID SET DRAWINGS - Page 135 of 142°

GENERAL NOTES: (UNIT PLANS)


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- COMM CABINET FOR INTERFACE WITH TEL. AND CATV. SERVICES. COORDINATE REQUIREMENTS WITH UTILITIES AND MOUUNTING WITH ARCHITECT.

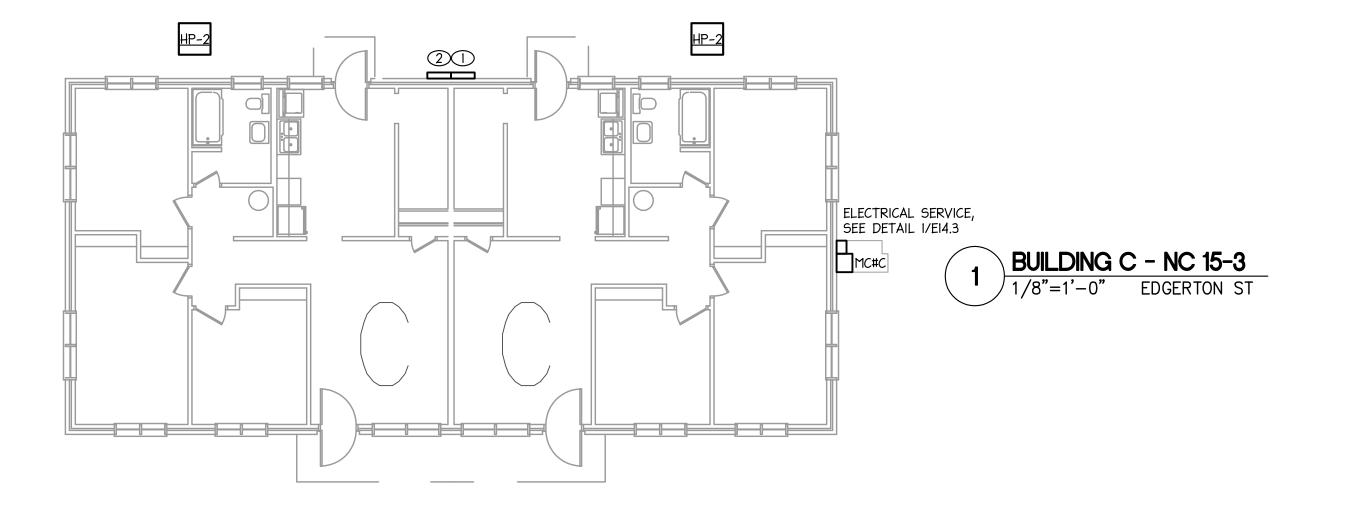

ONE BEDROOM UNIT - NC 15-3 BUILDING TYPE 'A'



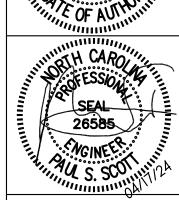

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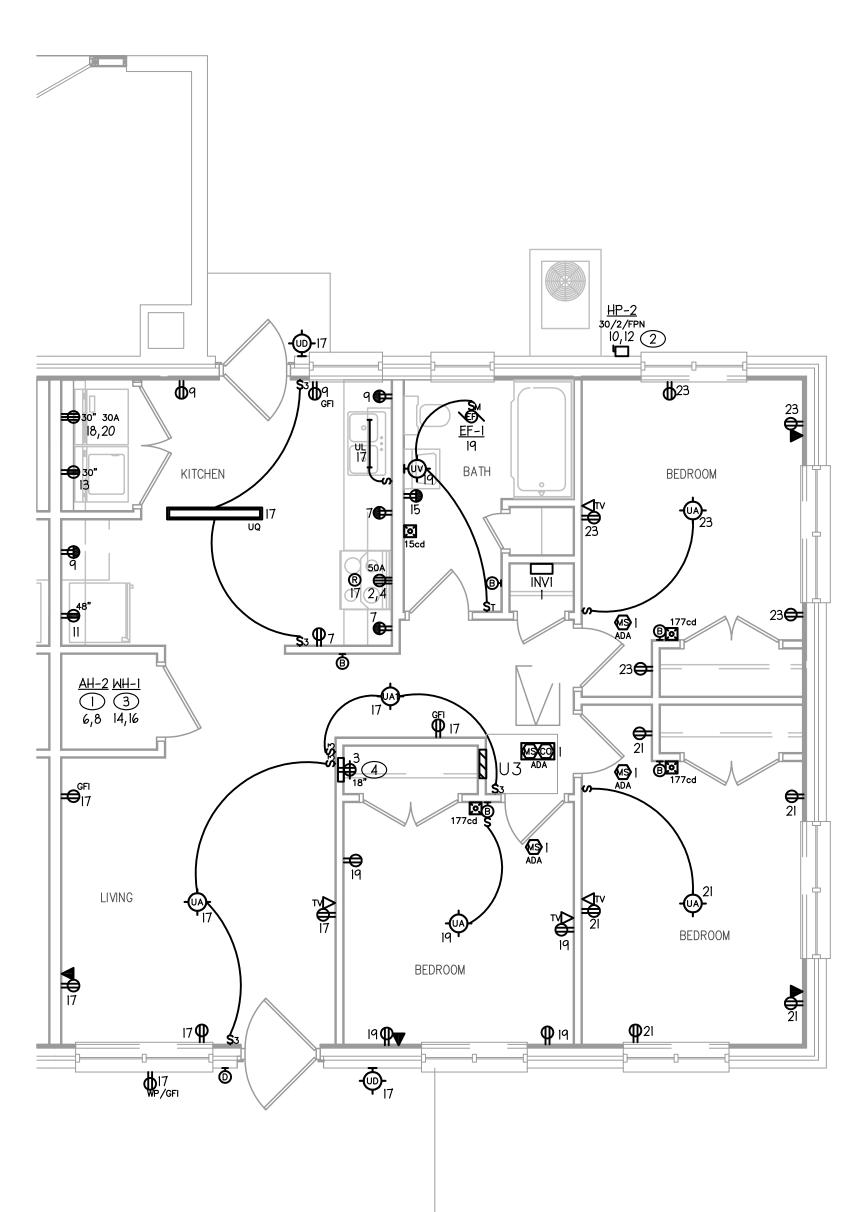
ELECTRICAL UNIT PLANS NC 15-3


COMM. NO.: 6041-B DRAWN BY: CHECKED BY: PSS DATE: APR. 2, 2024 SHEET NO.

HP-2 30/2/FPN 10,12 2 BEDROOM <u>AH-2 WH-1</u> (1) (3) MSXCO) GFI 17 LIVING BEDROOM BEDROOM

> THREE BEDROOM HI/VI UNIT - NC 15-3 BUILDING TYPE 'C'

> > GFI RECEPTACLES IN HEARING/VISUALLY IMPAIRED UNIT TYPE SHALL HAVE AUDIBLE AND VISUAL INDICATION THAT THEY HAVE TRIPPED AND SHALL BE EQUAL TO LEVITON GFTA2 SERIES; FINISH BY ARCHITECT. REFER TO ARCHITECTURAL SITE PLAN FOR THESE UNIT LOCATIONS.



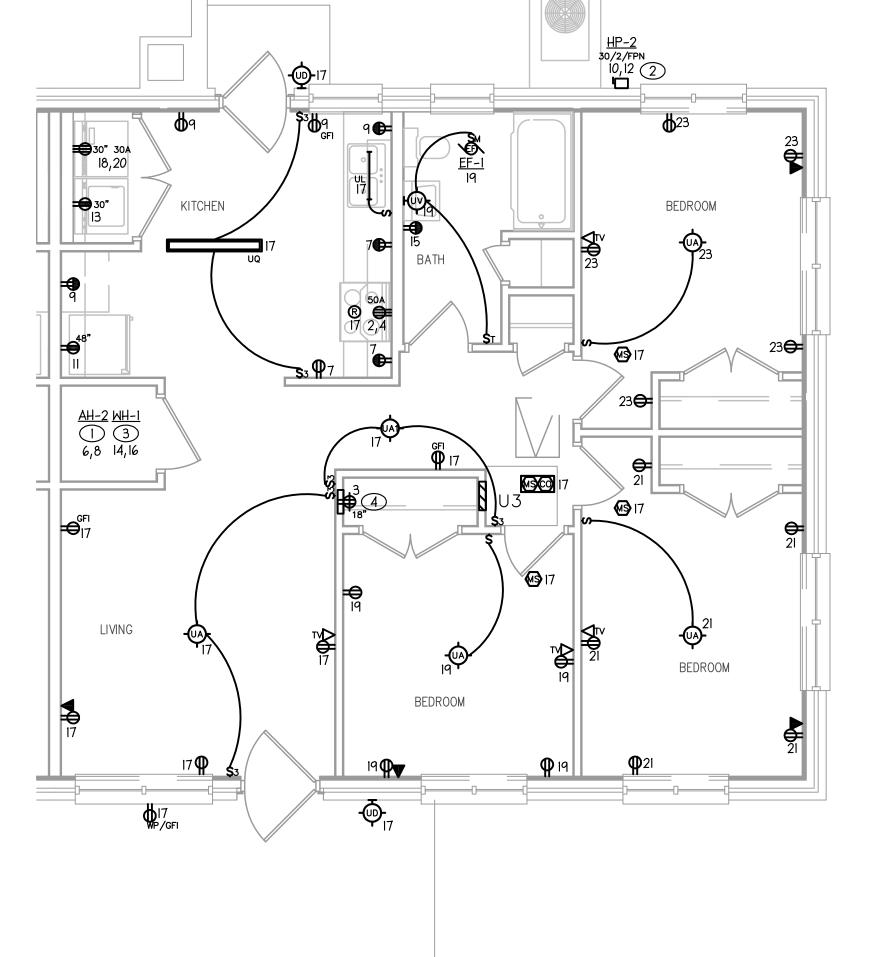

THREE BEDROOM UNIT - NC 15-3

BUILDING TYPE 'C'

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GENERAL NOTES: (UNIT PLANS)

LOCATIONS.

TAGGED NOTES: (UNIT PLANS)

FOR PANEL SCHEDULES.

ARCHITECT PRIOR TO ROUGH-IN.

5. VISUAL DOORBELL SYSTEM SHALL BE HARDWIRED.

2 SEE BUILDING PLANS FOR HEAT PUMP LOCATIONS.

I. ALL CIRCUIT NUMBERS SHOWN TO RESPECTIVE UNIT PANEL. SEE SHEET EI3.0

2. REFER TO ID PLANS FOR DIMENSIONS, UNLESS NOTED OTHERWISE.

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4. SEE DETAIL 3/E0.1 FOR FURTHER INFORMATION ON ADA SWITCH AND OUTLET

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4 COMM CABINET FOR INTERFACE WITH TEL. AND CATV. SERVICES. COORDINATE

REQUIREMENTS WITH UTILITIES AND MOUUNTING WITH ARCHITECT.

PANEL SCHEDULE FOR ACTUAL WIRE AND BREAKER SIZE. DISCONNECT SWITCH


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6041B BID SET DRAWINGS - Page 136 of 142 °

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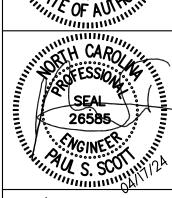
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ELECTRICAL UNIT PLANS NC 15-3

COMM. NO.: 6041-B DRAWN BY: CHECKED BY: PSS DATE: APR. 2, 2024 SHEET NO.

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UNIT TYPE: FOUR BEDROOM SYSTEM VOLTAGE: 240/120V, 10, 3W SERVICE SIZE: 125 AMPS SQUARE FEET: 1,240

LOAD DESCRIPTION LIGHTING & RECEPTACLES (SQUARE FEET X 3 VA) SMALL APPLIANCES 3.0 (2 CIRCUITS X 1.5 KVA/CIRCUIT) REFRIGERATOR 1.1 ELEC. CLOTHES DRYER 5.0 WASHER RANGE WATER HEATER MICROWAVE 1.5 COMMUNICATION CAB 0.2 TOTAL 28.5 FIRST 10 KVA AT 100% 10.0 REMAINDER AT 40% 7.4 HEAT PUMP AIR HANDLER 2.7

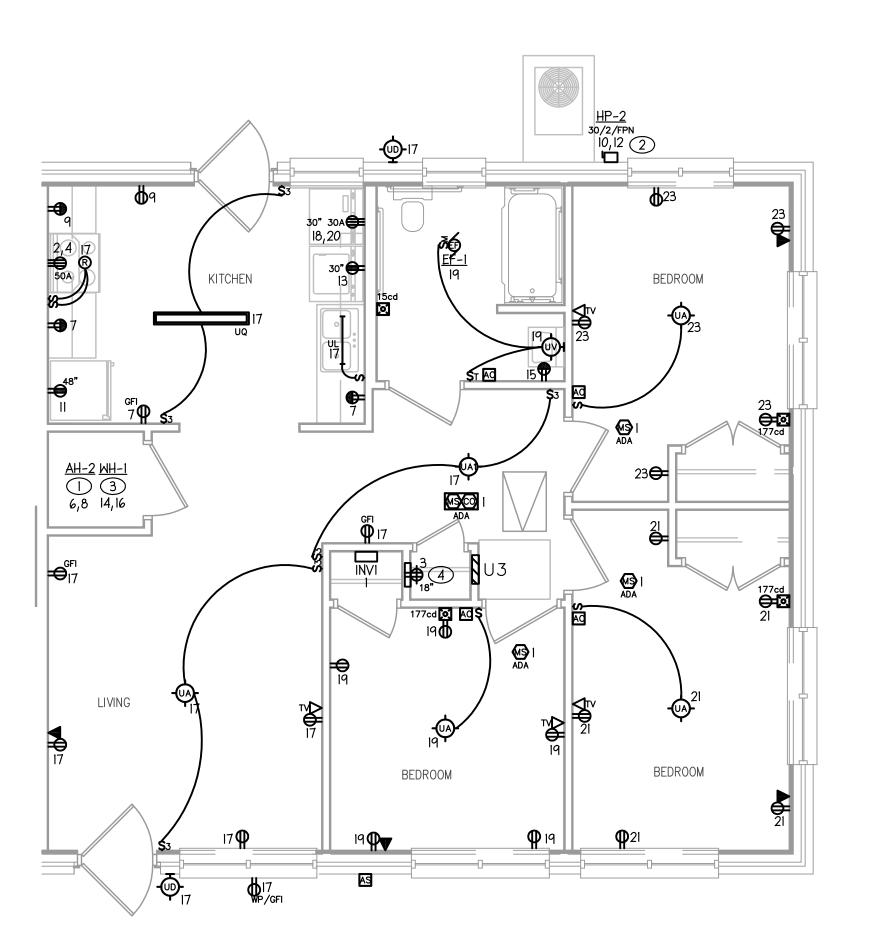3.7

9.8

STRIP HEAT AT 65%

TOTAL RESIDENTIAL KVA

HEATING AT 100%

	VOLTAGE: 240/120V AMPS: 125 - MLO				P		L: U		ļ.			I PHASE 3 WIRE FLUSH MOUNTED NEMA I
1	- DESCRIPTION -	POLE	WIRE SIZE	BRK SIZE	CCT #	A		CÇT	BRK SIZE	WIRE SIZE	POLE	- DESCRIPTION -
	SPACE	1	-	-	1	- /4.0		2	50	6		RANGE
AFI	COMM CABINET	1	14	15	3		0.2/4.0	4				
GFI/AFI	MICROWAVE	-	12	20	5	1.5/ <sub>5.1</sub>		6	50	6	2	AH-3
GFI/AFI	KITCHEN APPLIANCES	1	12	20	7		1.5/ <sub>5.1</sub>	8				
GFI/AFI	KITCHEN APPLIANCES	1	12	20	9	1.5/1.7		10	30	10	2	HP-3 *
GFI/AFI	REFRIGERATOR		12	20	11		1.1/1.7	12				
GFI/AFI	WASHER	1	12	20	13	1.5/2.2		14	35	8	2	WH-I
	BATHROOM RECEPTACLES	1	12	20	15		0.4/2.3	16				
AFI	LTS/RECEPTACLES	1	14	15	17	0.9/2.5		18	30	10	2	DRYER
AFI	LTS/RECEPTACLES	1	14	15	19		0.6/2.5	20				
AFI	LTS/RECEPTACLES	1	14	15	21	0.6/_		22	-	-	1	SPACE
AFI	LTS/RECEPTACLES	1	14	15	23		0.6/_	24	_	-	1	SPACE
AFI	LTS/RECEPTACLES	1	14	15	25	0.6/_		26	_	-	1	SPACE
	SPACE	1	-	-	27		-/-	28	_	-	1	SPACE
	SPACE	1	-	-	29	-/-		30	_	-	1	SPACE
						22.1	20.0					
	TOTAL CO	NN	ECTE	D KV	Ά	42	2.1			DEM.	AN[	D KVA: 27.2
	PANEL RM	s s	SYM.	AMP	S:	SEE F	RISER		D	EMAI	ND	AMPS: II3

PANEL SHALL BE EQUAL TO SIEMENS ES LOAD CENTER.

AFI - PROVIDE ARC FAULT CIRCUIT INTERRUPTER BREAKER FOR CIRCUIT.

L - INDICATES LOCK-ON ATTACHMENT REQUIRED. PROVIDE HACR BREAKERS FOR HVAC EQUIPMENT.

GFI - PROVIDE GFCI BREAKER FOR CIRCUIT. GFCI RECEPTACLES MAY BE USED IN LIEU OF GFCI BREAKERS SO LONG AS THE DEVICE(S) CONFORM TO NEC CODE REQUIREMENTS FOR GFCI

6. PANEL SHALL BE MOUNTED SUCH THAT THE BASE OF THE PANEL IS NO LESS THAN 15" A.F.F. AND THE TOP OF THE PANEL IS NO MORE THAN 48" A.F.F.

\* -PRIOR TO PURCHASING CONDUCTORS AND CONDUIT, E.C. SHALL VERIFY CIRCUIT VOLTAGE DROP TO BE LESS THAN 3% BASED ON ACTUAL CIRCUIT LENGTH TO BE INSTALLED.

LOAD DEMAND CALCULATION - NEC SECTION 220-8:	
UNIT TYPE: ONE BEDRO SYSTEM VOLTAGE: 240/120V SERVICE SIZE: 125 AN SQUARE FEET: 505	/, ΙΦ, 3W
LOAD DESCRIPTION	KVA
LIGHTING & RECEPTACLES (SQUARE FEET X 3 VA)	1.5
SMALL APPLIANCES (2 CIRCUITS X 1.5 KVA/CIRCUIT)	3.0
REFRIGERATOR	1.1
ELEC. CLOTHES DRYER	5.0
WASHER	1.5
RANGE	8.0
WATER HEATER	4.5
COMMUNICATION CAB	0.2
	TOTAL 24.8
FIRST 10 KVA AT 100% REMAINDER AT 40%	10.0 5.9
HEAT PUMP AIR HANDLER STRIP HEAT AT 65%	2.6 0.4 2.4
HEATING AT 100%	5.4
TOTAL RESIDENTIAL KVA	21.3

	VOLTAGE: 240/120V				P	ANE	EL: (	U1				I PHASE 3 WIRE FLUSH MOUNTED
	AMPS: 125 - MLO					LOAD PE	r Phase	]				NEMA I
	- DESCRIPTION -	POLE	WIRE SIZE	BRK SIZE	CCT #	Α	В	CCT #	BRK SIZE	WIRE SIZE	POLE	- DESCRIPTION -
	SPACE	_	1	-	1	- /4.0		2	50	6	2	RANGE
AFI	COMM CABINET	-	14	15	3		0.2/4.0	4				
	SPACE	1	1	-	5	- /2.7		6	30	10	2	AH-I
GFI/AFI	KITCHEN APPLIANCES	1	12	20	7		1.5/2.7	8				
GFI/AFI	KITCHEN APPLIANCES	1	12	20	9	1.5/1.3		10	20	12	2	HP-1 *
GFI/AFI	REFRIGERATOR	1	12	20	11		1.1 / 1.3	12				
GFI/AFI	WASHER	1	12	20	13	1.5/2.2		14	25	10	2	WH-I
	BATHROOM RECEPTACLE	1	12	20	15		0.2/2.3	16				
AFI	LTS/RECEPTACLES	1	14	15	17	0.7/2.5		18	30	10	2	DRYER
AFI	LTS/RECEPTACLES	1	14	15	19		0.6/2.5	20				
	SPACE	-	-	1	21	-/-		22	-	-	1	SPACE
	SPACE	1	-	1	23		-/-	24	-	-	1	SPACE
	SPACE	1	-	1	25	-/-		26	-	-	ī	SPACE
	SPACE	1	-	1	27		-/-	28	-	-	1	SPACE
	SPACE	1	-	1	29	-/-		30	-	-	ī	SPACE
						16.4	16.4					
	TOTAL CONNECTED KVA					32	2.8			DEMAND KVA: 21.3		
	PANEL RM	s s	SYM.	AMP	S:	SEE R	RISER		D	EMAI	ND	AMPS: 89
	I. PANEL SHALL BE EQUAL TO SIEMENS ES LOAD CENTER.											

AFI - PROVIDE ARC FAULT CIRCUIT INTERRUPTER BREAKER FOR CIRCUIT.

L - INDICATES LOCK-ON ATTACHMENT REQUIRED. PROVIDE HACR BREAKERS FOR HVAC EQUIPMENT.

GFI - PROVIDE GFCI BREAKER FOR CIRCUIT. GFCI RECEPTACLES MAY BE USED IN LIEU OF GFCI BREAKERS SO LONG AS THE DEVICE(S) CONFORM TO NEC CODE REQUIREMENTS FOR GFCI

6. PANEL SHALL BE MOUNTED SUCH THAT THE BASE OF THE PANEL IS NO LESS THAN 15" A.F.F. AND THE TOP OF THE PANEL IS NO MORE THAN 48" A.F.F.

7. \* -PRIOR TO PURCHASING CONDUCTORS AND CONDUIT, E.C. SHALL VERIFY CIRCUIT VOLTAGE DROP TO BE LESS THAN 3% BASED ON ACTUAL CIRCUIT LENGTH TO BE INSTALLED.

LOAD DEMAND CALCULATION - NEC SECTION 220-8		AL	
UNIT TYPE: THREE BED SYSTEM VOLTAGE: 240/I20\ SERVICE SIZE: I25 AN SQUARE FEET: 940	/, IΦ, 3W MPS		
LOAD DESCRIPTION		KVA	
LIGHTING & RECEPTACLES (SQUARE FEET X 3 VA)		2.8	
SMALL APPLIANCES (2 CIRCUITS X 1.5 KVA/CIRCUIT)		3.0	
REFRIGERAT <i>O</i> R		1.1	
ELEC. CLOTHES DRYER		5.0	
WASHER		1.5	
RANGE		8.0	
WATER HEATER		4.5	
COMMUNICATION CAB		0.2	
	TOTAL	26.1	
FIRST 10 KVA AT 100%		10.0	
REMAINDER AT 40%		6.4	
HEAT PUMP	2.8 0.4		
AIR HANDLER STRIP HEAT AT 65%	0.4 2.4		
HEATING AT 100%		5.6	
TOTAL RESIDENTIAL KVA	_	22.0	

	VOLTAGE: 240/120V AMPS: 125 - MLO					ANE						I PHASE 3 WIRE FLUSH MOUNTED NEMA I	
	- DESCRIPTION -	POLE	WIRE SIZE	BRK SIZE				CCT #	BRK SIZE	WIRE SIZE	POLE	- DESCRIPTION -	1
L/AFI	EQ: INVERTER (HC/HI/VI)	1	14	15		0.3/4.0		2	50	6	_	RANGE	1
AFI	COMM CABINET	1	14	15	3		0.2/4.0	4					
	SPACE	1	-	1	5	- /2.7		6	30	10	2	AH-2	
GFI/AFI	KITCHEN APPLIANCES	1	12	20	7		1.5/2.7	8					
GFI/AFI	KITCHEN APPLIANCES	1	12	20	9			10	25	10	2	HP-2 *	
GFI/AFI	REFRIGERAT <i>O</i> R	1	12	20	11		1.1/1.4	12					
GFI/AFI	WASHER	1	12	20	13	1.5/2.2		14	35	8	2	WH-1	L
	BATHROOM RECEPTACLE	1	12	20	15		0.2/2.3	16					
AFI	LTS/RECEPTACLES	1	14	15	17	0.8/2.5		18	30	10	2	DRYER	
AFI	LTS/RECEPTACLES	1	14	15	19		0.6/2.5	20					
AFI	LTS/RECEPTACLES	1	14	15	21	0.6/_		22	_	-	1	SPACE	
AFI	LTS/RECEPTACLES	1	14	15	23		0.6/_	24	1	1	1	SPACE	
	SPACE	1	-	-	25	-/-		26	-	-	1	SPACE	
	SPACE	1	1	1	27		-/-	28	1	1	1	SPACE	
	SPACE	1	-	١	29	-/-		30	1	١	1	SPACE	
						17.5	17.1						
	TOTAL CO	NN	ECTE	D KV	/A	34	1.6			DEM.	ANI	O KVA: 22.0	
	PANEL RM									EMAI	ND	AMPS: 92	

PANEL SHALL BE EQUAL TO SIEMENS ES LOAD CENTER. AFI - PROVIDE ARC FAULT CIRCUIT INTERRUPTER BREAKER FOR CIRCUIT.

L - INDICATES LOCK-ON ATTACHMENT REQUIRED.

GFI - PROVIDE GFCI BREAKER FOR CIRCUIT. GFCI RECEPTACLES MAY BE USED IN LIEU OF GFCI BREAKERS SO LONG AS THE DEVICE(S) CONFORM TO NEC CODE REQUIREMENTS FOR GFCI

6. PANEL SHALL BE MOUNTED SUCH THAT THE BASE OF THE PANEL IS NO LESS THAN 15" A.F.F.

7. \* -PRIOR TO PURCHASING CONDUCTORS AND CONDUIT, E.C. SHALL VERIFY CIRCUIT VOLTAGE

LOAD DEMAND CALCULATION	- RESIDENTIAI
NEC SECTION 220-	
UNIT TYPE: TWO BED SYSTEM VOLTAGE: 240/12 SERVICE SIZE: 125 SQUARE FEET: 72	OV, IΦ, 3W AMPS
LOAD DESCRIPTION	KVA
LIGHTING & RECEPTACLES (SQUARE FEET X 3 VA)	2.2
SMALL APPLIANCES (2 CIRCUITS X 1.5 KVA/CIRCUIT)	3.0
REFRIGERATOR	1.1
ELEC. CLOTHES DRYER	5.0
WASHER	1.5
RANGE	8.0
WATER HEATER	4.5
COMMUNICATION CAB	0.2
	TOTAL 25.5
FIRST 10 KVA AT 100%	10.0
REMAINDER AT 40%	6.2
HEAT PUMP AIR HANDLER	2.6 0.4
STRIP HEAT AT 65%	0.4 2.4
HEATING AT 100%	5.4
TOTAL RESIDENTIAL KVA	21.6

	VOLTAGE: 240/120V AMPS: 125 - MLO			•	-	ANE			•			I PHASE 3 WIRE FLUSH MOUNTED NEMA I
	- DESCRIPTION -	POLE	WIRE SIZE	BRK SIZE	CCT #	Α		₹	BRK SIZE	WIRE SIZE	POLE	- DESCRIPTION -
L/AFI	EQ: INVERTER (HC UNIT)	1	14	15	1	0.3/4.0		2	50	6	2	RANGE
AFI	COMM CABINET	_	14	15	3		0.2/4.0	4				
	SPACE	1	1	-	5	- /2.7		6	30	10	2	AH-1
FI/AFI	KITCHEN APPLIANCES	_	12	20	7		1.5/2.7	8				
FI/AFI	KITCHEN APPLIANCES	1	12	20	9	1.5/1.3		10	20	12	2	HP-1 *
FI/AFI	REFRIGERATOR	1	12	20	=		1.1/1.3	12				
FI/AFI	WASHER	_	12	20	13	1.5/2.2		14	35	8	2	MH-I
	BATHROOM RECEPTACLE	1	12	20	15		0.2/2.3	16				
AFI	LTS/RECEPTACLES	1	14	15	17	0.8/2.5		18	30	10	2	DRYER
AFI	LTS/RECEPTACLES	_	14	15	19		0.6/2.5	20				
AFI	LTS/RECEPTACLES	1	14	15	21	0.6/_		22	-	-	ī	SPACE
	SPACE	1	-	-	23		-/-	24	-	-	1	SPACE
	SPACE	1	-	-	25	-/-		26	-	-	ı	SPACE
	SPACE	1	-	-	27		-/-	28	-	-	ı	SPACE
	SPACE	1	1	-	29	-/-		30	-	-	T	SPACE
						17.4	16.4					
	TOTAL CO	TOTAL CONNECTED KVA 33.8 DEMAND KVA: 21.6										
	PANEL RM			-						EMAI	ND	AMPS: 90

AFI - PROVIDE ARC FAULT CIRCUIT INTERRUPTER BREAKER FOR CIRCUIT.

L - INDICATES LOCK-ON ATTACHMENT REQUIRED.

PROVIDE HACR BREAKERS FOR HVAC EQUIPMENT. GFI - PROVIDE GFCI BREAKER FOR CIRCUIT. GFCI RECEPTACLES MAY BE USED IN LIEU OF GFCI BREAKERS SO LONG AS THE DEVICE(S) CONFORM TO NEC CODE REQUIREMENTS FOR GFCI

6. PANEL SHALL BE MOUNTED SUCH THAT THE BASE OF THE PANEL IS NO LESS THAN 15" A.F.F. AND THE TOP OF THE PANEL IS NO MORE THAN 48" A.F.F.

7. \* -PRIOR TO PURCHASING CONDUCTORS AND CONDUIT, E.C. SHALL VERIFY CIRCUIT VOLTAGE DROP TO BE LESS THAN 3% BASED ON ACTUAL CIRCUIT LENGTH TO BE INSTALLED.

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ELECTRICAL PANEL SCHEDULES

COMM. NO.: 6041-B DRAWN BY: CHECKED BY: PSS DATE: APR. 2, 2024 SHEET NO.


PROVIDE HACR BREAKERS FOR HVAC EQUIPMENT. AND THE TOP OF THE PANEL IS NO MORE THAN 48" A.F.F. DROP TO BE LESS THAN 3% BASED ON ACTUAL CIRCUIT LENGTH TO BE INSTALLED.

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## ELECTRICAL RISER DIAGRAM - BUILDING 4


RISER DIAGRAM NOTES:

PROVIDE LABEL ON SERVICE EQUIPMENT PER 110.24(A) AND 110.22(A)

- 1. SERVICE LATERAL CONDUCTORS TO METER CENTER PROVIDED AND INSTALLED BY UTILITY. E.C. TO PROVIDE (2) 3" CONDUITS. COORDINATE TRENCHING AND CONDUIT REQUIREMENTS; OWNER SHALL PAY ALL FEES.
- 2. #2 CU. GND TO GROUNDING ELECTRODE SYSTEM, SEE 1/E0.1
- METER CENTER PROVIDED AND INSTALLED BY ELECTRICAL CONTRACTOR METER CENTERS SHALL BE EQUAL TO SIEMENS POWER-MOD SERIES WITH 800A CROSS BUS. METERS PROVIDED AND INSTALLED BY POWER CO. COORDINATE
- 4. 2 POLE CIRCUIT BREAKER IN NEMA 3R ENCLOSURE, UL LISTED FOR SERVICE ENTRANCE EQUIPMENT. TYPICAL FOR ALL UNIT PANELS. AIC RATING OF FEEDER CIRCUIT BREAKERS SHALL BE AS INDICATED. RESIDENTIAL UNIT BRANCH CIRCUIT BREAKERS MAY BE SERIES RATED WITH FEEDER BREAKERS. PROVIDE NEW PHENOLIC ENGRAVED NAMEPLATE AT EACH METER IDENTIFYING APARTMENT NUMBER.
- 5. 3#2/0 (AL), #2 GND (AL) TYPE SER SERVICE ENTRANCE CABLE (TYPICAL FOR 125A PANELS) PER NEC 310.15(B)(7).

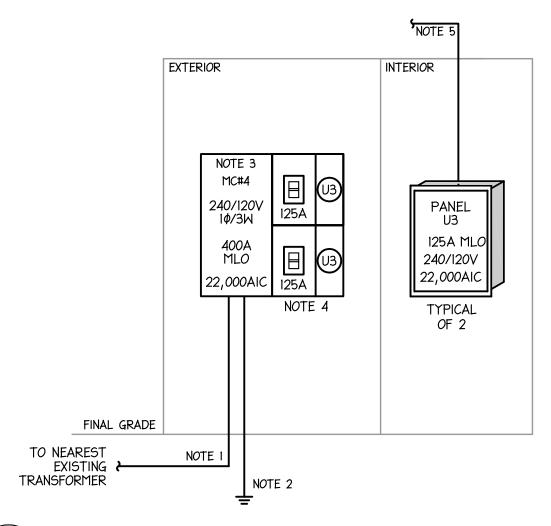MC#4 SERVICE DEMAND											
UNIT TYPE	kVA CONN. PER PANEL	# OF PANELS	TOTAL kVA PER PANEL TYPE								
U3	34.6	3	103.8								
RESIDENTIAL	CONNECTED kV	Α	103.8								
DEMAND FAC	TOR (NEC 220-	85)	0.45								
RESIDENTIAL	DEMAND kVA		46.7								
TOTAL DEMA	46.7										
AMPS AT 240	OV, IPH.		194.6								

E.C. TO FIELD VERIFY ALL EXISTING CONDITIONS AND LOCATIONS OF EQUIPMENT PRIOR TO BIDDING WORK.

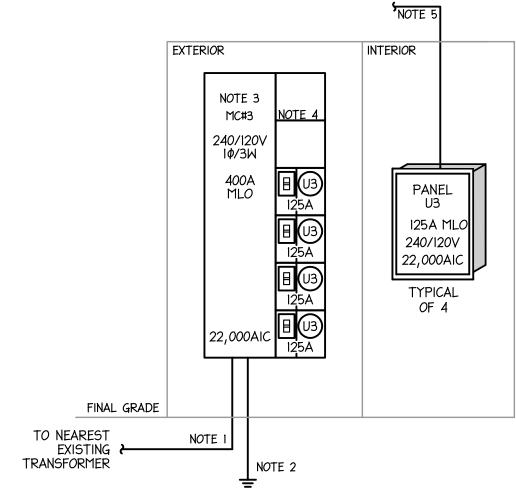

## ELECTRICAL RISER DIAGRAM - BUILDING 3


RISER DIAGRAM NOTES:

PROVIDE LABEL ON SERVICE EQUIPMENT PER 110.24(A) AND 110.22(A).

- SERVICE LATERAL CONDUCTORS TO METER CENTER PROVIDED AND INSTALLED BY UTILITY. E.C. TO PROVIDE (2) 3" CONDUITS. COORDINATE TRENCHING AND CONDUIT REQUIREMENTS; OWNER SHALL PAY ALL FEES.
- #2 CU. GND TO GROUNDING ELECTRODE SYSTEM, SEE 1/E0.1.
- METER CENTER PROVIDED AND INSTALLED BY ELECTRICAL CONTRACTOR METER CENTERS SHALL BE EQUAL TO SIEMENS POWER-MOD SERIES WITH 800A CROSS BUS. METERS PROVIDED AND INSTALLED BY POWER CO. COORDINATE REQUIREMENTS WITH POWER CO.
- 4. 2 POLE CIRCUIT BREAKER IN NEMA 3R ENCLOSURE, UL LISTED FOR SERVICE ENTRANCE EQUIPMENT. TYPICAL FOR ALL UNIT PANELS. AIC RATING OF FEEDER CIRCUIT BREAKERS SHALL BE AS INDICATED. RESIDENTIAL UNIT BRANCH CIRCUIT BREAKERS MAY BE SERIES RATED WITH FEEDER BREAKERS. PROVIDE NEW PHENOLIC ENGRAVED NAMEPLATE AT EACH METER IDENTIFYING APARTMENT NUMBER.
- 5. 3#2/0 (AL), #2 GND (AL) TYPE SER SERVICE ENTRANCE CABLE (TYPICAL FOR 125A PANELS) PER NEC 310.15(B)(7).

MC#3 SERVICE DEMAND										
kVA CONN. PER PANEL	# OF PANELS	TOTAL kVA PER PANEL TYPE								
34.6	4	138.4								
CONNECTED kV	A	138.4								
TOR (NEC 220-8	34)	0.45								
DEMAND kVA		62.3								
TOTAL DEMAND kVA										
DV, IPH.		259.6								
	kVA CONN. PER PANEL 34.6  CONNECTED kV TOR (NEC 220-6 DEMAND kVA	kVA CONN. PER PANEL  34.6  CONNECTED kVA  TOR (NEC 220-84)  DEMAND kVA								

E.C. TO FIELD VERIFY ALL EXISTING CONDITIONS AND LOCATIONS OF EQUIPMENT PRIOR TO BIDDING WORK.

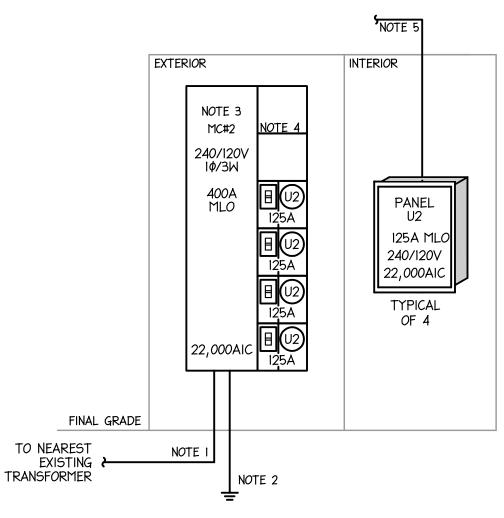

## ELECTRICAL RISER DIAGRAM - BUILDING 2


RISER DIAGRAM NOTES:

PROVIDE LABEL ON SERVICE EQUIPMENT PER 110.24(A) AND 110.22(A).

- SERVICE LATERAL CONDUCTORS TO METER CENTER PROVIDED AND INSTALLED BY UTILITY. E.C. TO PROVIDE (2) 3" CONDUITS. COORDINATE TRENCHING AND CONDUIT REQUIREMENTS; OWNER SHALL PAY ALL FEES.
- 2. #2 CU. GND TO GROUNDING ELECTRODE SYSTEM, SEE I/EO.I.
- METER CENTER PROVIDED AND INSTALLED BY ELECTRICAL CONTRACTOR. METER CENTERS SHALL BE EQUAL TO SIEMENS POWER-MOD SERIES WITH 800A CROSS BUS. METERS PROVIDED AND INSTALLED BY POWER CO. COORDINATE
- 4. 2 POLE CIRCUIT BREAKER IN NEMA 3R ENCLOSURE, UL LISTED FOR SERVICE ENTRANCE EQUIPMENT. TYPICAL FOR ALL UNIT PANELS. AIC RATING OF FEEDER CIRCUIT BREAKERS SHALL BE AS INDICATED. RESIDENTIAL UNIT BRANCH CIRCUIT BREAKERS MAY BE SERIES RATED WITH FEEDER BREAKERS. PROVIDE NEW PHENOLIC ENGRAVED NAMEPLATE AT EACH METER IDENTIFYING APARTMENT NUMBER.
- 5. 3#2/0 (AL), #2 GND (AL) TYPE SER SERVICE ENTRANCE CABLE (TYPICAL FOR 125A PANELS) PER NEC 310.15(B)(7).

MC#	2 SERVI	CE DE	MAND					
UNIT TYPE	kVA CONN. PER PANEL	# OF PANELS	TOTAL kVA PER PANEL TYPE					
U2	33.8	4	135.2					
RESIDENTIAL	CONNECTED kV	A	135.2					
DEMAND FAC	TOR (NEC 220-	84)	0.45					
RESIDENTIAL	DEMAND kVA		60.8					
TOTAL DEMA	TOTAL DEMAND kVA							
AMPS AT 240	DV, IPH.		<u>253.3</u>					

E.C. TO FIELD VERIFY ALL EXISTING CONDITIONS AND LOCATIONS OF EQUIPMENT PRIOR TO BIDDING WORK.

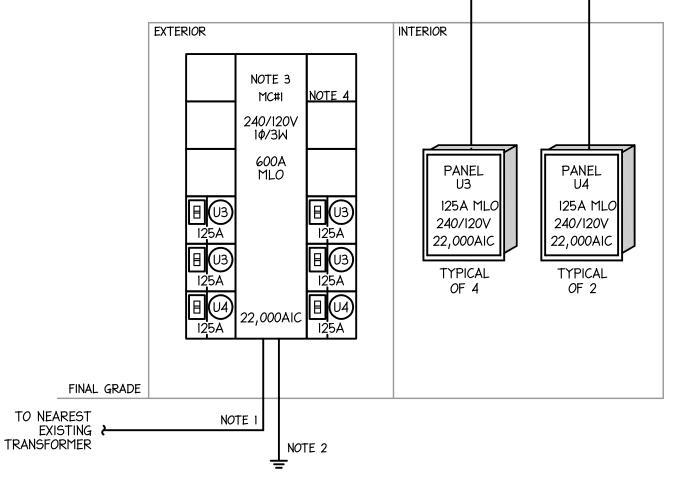

## ELECTRICAL RISER DIAGRAM - BUILDING 1

RISER DIAGRAM NOTES:

PROVIDE LABEL ON SERVICE EQUIPMENT PER 110.24(A) AND 110.22(A).

- SERVICE LATERAL CONDUCTORS TO METER CENTER PROVIDED AND INSTALLED BY UTILITY. E.C. TO PROVIDE (2) 3" CONDUITS. COORDINATE TRENCHING AND CONDUIT REQUIREMENTS; OWNER SHALL PAY ALL FEES.
- 2. #I/O CU. GND TO GROUNDING ELECTRODE SYSTEM, SEE I/EO.I.
- METER CENTER PROVIDED AND INSTALLED BY ELECTRICAL CONTRACTOR. METER CENTERS SHALL BE EQUAL TO SIEMENS POWER-MOD SERIES WITH 800A CROSS BUS. METERS PROVIDED AND INSTALLED BY POWER CO. COORDINATE REQUIREMENTS WITH POWER CO.
- 4. 2 POLE CIRCUIT BREAKER IN NEMA 3R ENCLOSURE, UL LISTED FOR SERVICE ENTRANCE EQUIPMENT. TYPICAL FOR ALL UNIT PANELS. AIC RATING OF FEEDER CIRCUIT BREAKERS SHALL BE AS INDICATED. RESIDENTIAL UNIT BRANCH CIRCUIT BREAKERS MAY BE SERIES RATED WITH FEEDER BREAKERS. PROVIDE NEW PHENOLIC ENGRAVED NAMEPLATE AT EACH METER IDENTIFYING APARTMENT NUMBER.
- 5. 3#2/0 (AL), #2 GND (AL) TYPE SER SERVICE ENTRANCE CABLE (TYPICAL FOR 125A PANELS) PER NEC 310,15(B)(7).

MC#1 SERVICE DEMAND										
UNIT TYPE	kVA CONN. PER PANEL	# OF PANELS	TOTAL KVA PER PANEL TYPE							
U3	34.6	4	138.4							
U4	42.1	2	84.2							
RESIDENTIAL	CONNECTED kV	А	222.6							
DEMAND FAC	TOR (NEC 220-	84)	0.44							
RESIDENTIAL	DEMAND kVA		97.9							
TOTAL DEMA	<u>97.9</u>									
AMPS AT 240	OV, IPH.		407.9							

E.C. TO FIELD VERIFY ALL EXISTING CONDITIONS AND LOCATIONS OF EQUIPMENT PRIOR TO BIDDING WORK.

ELECTRICAL BUILDING RISER DIAGRAMS

> DRAWN BY: CHECKED BY: PSS DATE: APR. 2, 2024 SHEET NO.

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RISER DIAGRAMS

ELECTRICAL BUILDING

COMM. NO.: 6041-B DRAWN BY: CHECKED BY: PSS DATE: APR. 2, 2024 SHEET NO.

NOTE 5 **EXTERIOR** INTERIOR MC#8 240/120V 1ø/3W 600A PANEL 125A MLC 125A MLO 240/120V 240/120V 22,000AIC 22,000AIC 目 (J3 125A TYPICAL TYPICAL *O*F 2 OF 4 FINAL GRADE TO NEAREST NOTE 1 EXISTING 2 TRANSFORMER NOTE 2

### RISER DIAGRAM NOTES:

PROVIDE LABEL ON SERVICE EQUIPMENT PER 110.24(A) AND 110.22(A)


1. SERVICE LATERAL CONDUCTORS TO METER CENTER PROVIDED AND INSTALLED BY UTILITY. E.C. TO PROVIDE (2) 3" CONDUITS. COORDINATE TRENCHING AND CONDUIT REQUIREMENTS; OWNER SHALL PAY ALL FEES.

ELECTRICAL RISER DIAGRAM - BUILDING 8

- 2. #I/O CU. GND TO GROUNDING ELECTRODE SYSTEM, SEE I/EO.I.
- METER CENTER PROVIDED AND INSTALLED BY ELECTRICAL CONTRACTOR METER CENTERS SHALL BE EQUAL TO SIEMENS POWER-MOD SERIES WITH 800A CROSS BUS. METERS PROVIDED AND INSTALLED BY POWER CO. COORDINATE REQUIREMENTS WITH POWER CO.
- 4. 2 POLE CIRCUIT BREAKER IN NEMA 3R ENCLOSURE, UL LISTED FOR SERVICE ENTRANCE EQUIPMENT. TYPICAL FOR ALL UNIT PANELS. AIC RATING OF FEEDER CIRCUIT BREAKERS SHALL BE AS INDICATED. RESIDENTIAL UNIT BRANCH CIRCUIT BREAKERS MAY BE SERIES RATED WITH FEEDER BREAKERS. PROVIDE NEW PHENOLIC ENGRAVED NAMEPLATE AT EACH METER IDENTIFYING APARTMENT NUMBER.
- 5. 3#2/0 (AL), #2 GND (AL) TYPE SER SERVICE ENTRANCE CABLE (TYPICAL FOR 125A PANELS) PER NEC 310.15(B)(7).

MC#8 SERVICE DEMAND										
UNIT TYPE	kVA CONN. PER PANEL	# OF PANELS	TOTAL kVA PER PANEL TYPE							
U2	33.8	2	67.6							
U3	34.6	4	138.4							
RESIDENTIAL	CONNECTED kV	A	206.0							
DEMAND FAC	TOR (NEC 220-	84)	0.44							
RESIDENTIAL	DEMAND kVA		90.6							
TOTAL DEMA	TOTAL DEMAND kVA									
AMPS AT 240	OV, IPH.		<u>377.5</u>							

E.C. TO FIELD VERIFY ALL EXISTING CONDITIONS AND LOCATIONS OF EQUIPMENT PRIOR TO BIDDING WORK.

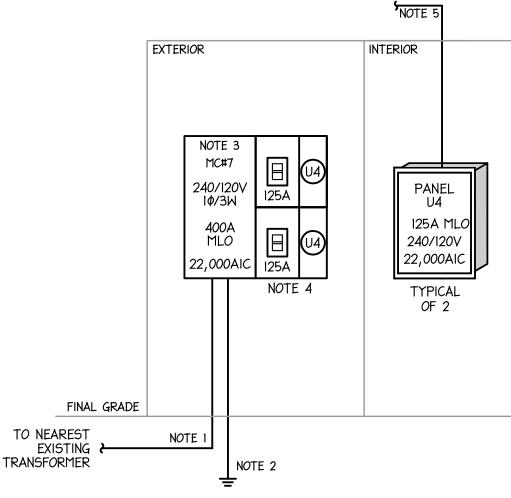

## ELECTRICAL RISER DIAGRAM - BUILDING 7


#### RISER DIAGRAM NOTES:

PROVIDE LABEL ON SERVICE EQUIPMENT PER 110.24(A) AND 110.22(A).

- SERVICE LATERAL CONDUCTORS TO METER CENTER PROVIDED AND INSTALLED BY UTILITY. E.C. TO PROVIDE (2) 3" CONDUITS. COORDINATE TRENCHING AND CONDUIT REQUIREMENTS; OWNER SHALL PAY ALL FEES.
- #2 CU. GND TO GROUNDING ELECTRODE SYSTEM, SEE 1/E0.1.
- METER CENTER PROVIDED AND INSTALLED BY ELECTRICAL CONTRACTOR METER CENTERS SHALL BE EQUAL TO SIEMENS POWER-MOD SERIES WITH 800A CROSS BUS. METERS PROVIDED AND INSTALLED BY POWER CO. COORDINATE REQUIREMENTS WITH POWER CO.
- 4. 2 POLE CIRCUIT BREAKER IN NEMA 3R ENCLOSURE, UL LISTED FOR SERVICE ENTRANCE EQUIPMENT. TYPICAL FOR ALL UNIT PANELS. AIC RATING OF FEEDER CIRCUIT BREAKERS SHALL BE AS INDICATED. RESIDENTIAL UNIT BRANCH CIRCUIT BREAKERS MAY BE SERIES RATED WITH FEEDER BREAKERS. PROVIDE NEW PHENOLIC ENGRAVED NAMEPLATE AT EACH METER IDENTIFYING APARTMENT NUMBER.
- 5. 3#2/0 (AL), #2 GND (AL) TYPE SER SERVICE ENTRANCE CABLE (TYPICAL FOR 125A PANELS) PER NEC 310.15(B)(7).

MC#7 SERVICE DEMAND										
UNIT TYPE	kVA CONN. PER PANEL	# OF PANELS	TOTAL kVA PER PANEL TYPE							
U4	42.1	3	126.3							
RESIDENTIAL	CONNECTED kV	A	126.3							
DEMAND FAC	TOR (NEC 220-	85 <i>)</i>	0.45							
RESIDENTIAL	DEMAND kVA		56.8							
TOTAL DEMA	56.8									
AMPS AT 240	DV, IPH.		<u>236.7</u>							

E.C. TO FIELD VERIFY ALL EXISTING CONDITIONS AND LOCATIONS OF EQUIPMENT PRIOR TO BIDDING WORK.

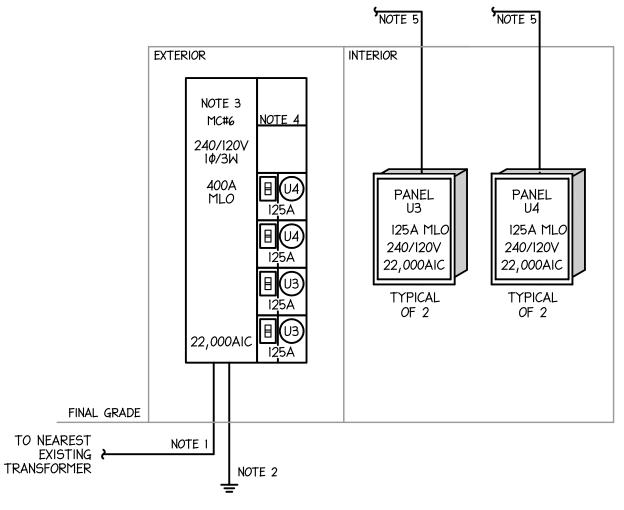

## ELECTRICAL RISER DIAGRAM - BUILDING 6


RISER DIAGRAM NOTES:

PROVIDE LABEL ON SERVICE EQUIPMENT PER 110.24(A) AND 110.22(A).

- SERVICE LATERAL CONDUCTORS TO METER CENTER PROVIDED AND INSTALLED BY UTILITY. E.C. TO PROVIDE (2) 3" CONDUITS. COORDINATE TRENCHING AND CONDUIT REQUIREMENTS; OWNER SHALL PAY ALL FEES.
- 2. #2 CU. GND TO GROUNDING ELECTRODE SYSTEM, SEE 1/E0.1.
- METER CENTER PROVIDED AND INSTALLED BY ELECTRICAL CONTRACTOR. METER CENTERS SHALL BE EQUAL TO SIEMENS POWER-MOD SERIES WITH 800A CROSS BUS. METERS PROVIDED AND INSTALLED BY POWER CO. COORDINATE REQUIREMENTS WITH POWER CO.
- 4. 2 POLE CIRCUIT BREAKER IN NEMA 3R ENCLOSURE, UL LISTED FOR SERVICE ENTRANCE EQUIPMENT. TYPICAL FOR ALL UNIT PANELS. AIC RATING OF FEEDER CIRCUIT BREAKERS SHALL BE AS INDICATED. RESIDENTIAL UNIT BRANCH CIRCUIT BREAKERS MAY BE SERIES RATED WITH FEEDER BREAKERS. PROVIDE NEW PHENOLIC ENGRAVED NAMEPLATE AT EACH METER IDENTIFYING APARTMENT NUMBER.
- 5. 3#2/0 (AL), #2 GND (AL) TYPE SER SERVICE ENTRANCE CABLE (TYPICAL FOR 125A PANELS) PER NEC 310.15(B)(7).

MC#6 SERVICE DEMAND										
UNIT TYPE	kVA CONN. PER PANEL	# OF PANELS	TOTAL kVA PER PANEL TYPE							
U3	34.6	2	69.2							
U4	42.1	2	84.2							
RESIDENTIAL	CONNECTED kV	Ά	153.4							
DEMAND FAC	TOR (NEC 220-	84)	0.45							
RESIDENTIAL	DEMAND kVA		69.0							
TOTAL DEMA	69.0									
AMPS AT 240	OV, IPH.		<u>287.5</u>							

E.C. TO FIELD VERIFY ALL EXISTING CONDITIONS AND LOCATIONS OF EQUIPMENT PRIOR TO BIDDING WORK.

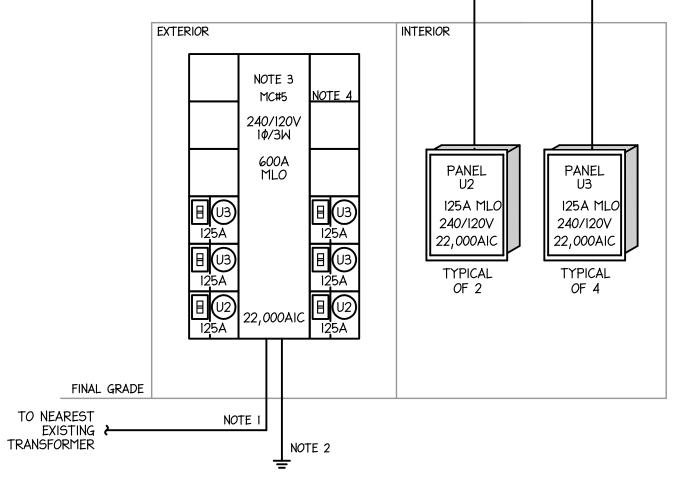

## ELECTRICAL RISER DIAGRAM - BUILDING 5

RISER DIAGRAM NOTES:

PROVIDE LABEL ON SERVICE EQUIPMENT PER 110.24(A) AND 110.22(A).

- SERVICE LATERAL CONDUCTORS TO METER CENTER PROVIDED AND INSTALLED BY UTILITY. E.C. TO PROVIDE (2) 3" CONDUITS. COORDINATE TRENCHING AND CONDUIT REQUIREMENTS; OWNER SHALL PAY ALL FEES.
- 2. #I/O CU. GND TO GROUNDING ELECTRODE SYSTEM, SEE I/EO.I.
- METER CENTER PROVIDED AND INSTALLED BY ELECTRICAL CONTRACTOR. METER CENTERS SHALL BE EQUAL TO SIEMENS POWER-MOD SERIES WITH 800A CROSS BUS. METERS PROVIDED AND INSTALLED BY POWER CO. COORDINATE REQUIREMENTS WITH POWER CO.
- 4. 2 POLE CIRCUIT BREAKER IN NEMA 3R ENCLOSURE, UL LISTED FOR SERVICE ENTRANCE EQUIPMENT. TYPICAL FOR ALL UNIT PANELS. AIC RATING OF FEEDER CIRCUIT BREAKERS SHALL BE AS INDICATED. RESIDENTIAL UNIT BRANCH CIRCUIT BREAKERS MAY BE SERIES RATED WITH FEEDER BREAKERS. PROVIDE NEW PHENOLIC ENGRAVED NAMEPLATE AT EACH METER IDENTIFYING APARTMENT NUMBER.
- 5. 3#2/0 (AL), #2 GND (AL) TYPE SER SERVICE ENTRANCE CABLE (TYPICAL FOR 125A PANELS) PER NEC 310.15(B)(7).

MC#5 SERVICE DEMAND			
UNIT TYPE	kVA CONN. PER PANEL	# OF PANELS	TOTAL kVA PER PANEL TYPE
U2	33.8	2	67.6
U3	34.6	4	138.4
RESIDENTIAL CONNECTED kVA			206.0
DEMAND FACTOR (NEC 220-84)			0.44
RESIDENTIAL DEMAND kVA			90.6
TOTAL DEMAND kVA			90.6
AMPS AT 240V, IPH.		377.5	

E.C. TO FIELD VERIFY ALL EXISTING CONDITIONS AND LOCATIONS OF EQUIPMENT PRIOR TO BIDDING WORK.

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SHEET NO.

**EXTERIOR** INTERIOR NOTE 3 MC#15 240/120V 1ø/3W 600A PANEL 125A MLC 125A MLO 240/120V 240/120V 22,000AIC 22,000AIC TYPICAL TYPICAL *O*F 3 FINAL GRADE TO NEAREST NOTE 1 EXISTING & TRANSFORMER NOTE 2

## ELECTRICAL RISER DIAGRAM - BUILDING 15


RISER DIAGRAM NOTES:

PROVIDE LABEL ON SERVICE EQUIPMENT PER 110.24(A) AND 110.22(A).

- SERVICE LATERAL CONDUCTORS TO METER CENTER PROVIDED AND INSTALLED BY UTILITY. E.C. TO PROVIDE (2) 3" CONDUITS. COORDINATE TRENCHING AND CONDUIT REQUIREMENTS; OWNER SHALL PAY ALL FEES.
- 2. #I/O CU. GND TO GROUNDING ELECTRODE SYSTEM, SEE I/EO.I.
- METER CENTER PROVIDED AND INSTALLED BY ELECTRICAL CONTRACTOR METER CENTERS SHALL BE EQUAL TO SIEMENS POWER-MOD SERIES WITH 800A CROSS BUS. METERS PROVIDED AND INSTALLED BY POWER CO. COORDINATE REQUIREMENTS WITH POWER CO.
- 4. 2 POLE CIRCUIT BREAKER IN NEMA 3R ENCLOSURE, UL LISTED FOR SERVICE ENTRANCE EQUIPMENT. TYPICAL FOR ALL UNIT PANELS. AIC RATING OF FEEDER CIRCUIT BREAKERS SHALL BE AS INDICATED. RESIDENTIAL UNIT BRANCH CIRCUIT BREAKERS MAY BE SERIES RATED WITH FEEDER BREAKERS. PROVIDE NEW PHENOLIC ENGRAVED NAMEPLATE AT EACH METER IDENTIFYING APARTMENT NUMBER.
- 5. 3#2/0 (AL), #2 GND (AL) TYPE SER SERVICE ENTRANCE CABLE (TYPICAL FOR 125A PANELS) PER NEC 310.15(B)(7).

MC#15 SERVICE DEMAND			
UNIT TYPE	kVA CONN. PER PANEL	# OF PANELS	TOTAL KVA PER PANEL TYPE
U3	34.6	2	69.2
U4	42.1	3	126.3
RESIDENTIAL CONNECTED kVA			195.5
DEMAND FACTOR (NEC 220-84)			0.45
RESIDENTIAL DEMAND kVA			88.0
TOTAL DEMAND kVA			<u>88.0</u>
AMPS AT 240V, IPH.			<u> 366.7</u>

E.C. TO FIELD VERIFY ALL EXISTING CONDITIONS AND LOCATIONS OF EQUIPMENT PRIOR TO BIDDING WORK.

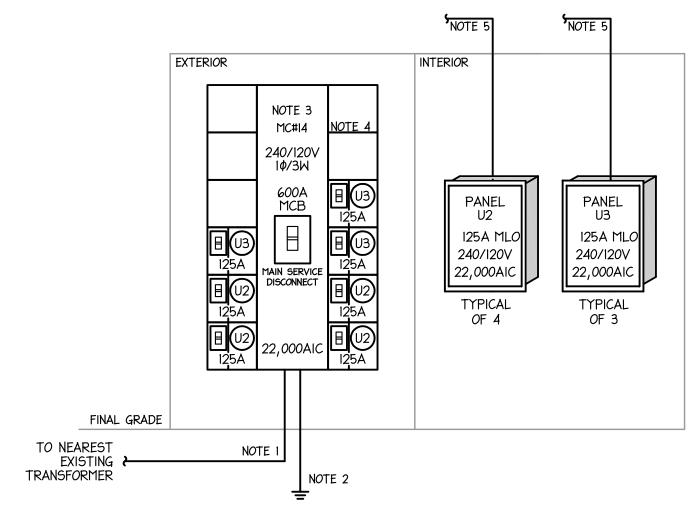

## ELECTRICAL RISER DIAGRAM - BUILDING 14


RISER DIAGRAM NOTES:

PROVIDE LABEL ON SERVICE EQUIPMENT PER 110.24(A) AND 110.22(A).

- SERVICE LATERAL CONDUCTORS TO METER CENTER PROVIDED AND INSTALLED BY UTILITY. E.C. TO PROVIDE (2) 3" CONDUITS. COORDINATE TRENCHING AND CONDUIT REQUIREMENTS; OWNER SHALL PAY ALL FEES.
- 2. #I/O CU. GND TO GROUNDING ELECTRODE SYSTEM, SEE I/EO.I.
- METER CENTER PROVIDED AND INSTALLED BY ELECTRICAL CONTRACTOR. METER CENTERS SHALL BE EQUAL TO SIEMENS POWER-MOD SERIES WITH 800A CROSS BUS. METERS PROVIDED AND INSTALLED BY POWER CO. COORDINATE REQUIREMENTS WITH POWER CO.
- 4. 2 POLE CIRCUIT BREAKER IN NEMA 3R ENCLOSURE, UL LISTED FOR SERVICE ENTRANCE EQUIPMENT. TYPICAL FOR ALL UNIT PANELS. AIC RATING OF FEEDER CIRCUIT BREAKERS SHALL BE AS INDICATED. RESIDENTIAL UNIT BRANCH CIRCUIT BREAKERS MAY BE SERIES RATED WITH FEEDER BREAKERS. PROVIDE NEW PHENOLIC ENGRAVED NAMEPLATE AT EACH METER IDENTIFYING APARTMENT NUMBER.
- 5. 3#2/0 (AL), #2 GND (AL) TYPE SER SERVICE ENTRANCE CABLE (TYPICAL FOR 125A PANELS) PER NEC 310.15(B)(7).

MC#14 SERVICE DEMAND			
UNIT TYPE	kVA CONN. PER PANEL	# OF PANELS	TOTAL kVA PER PANEL TYPE
U2	33.8	4	135.2
U3	34.6	3	103.8
RESIDENTIAL CONNECTED kVA			239.0
DEMAND FACTOR (NEC 220-84)			0.44
RESIDENTIAL DEMAND KVA			105.2
TOTAL DEMAND kVA			105.2
AMPS AT 240V, IPH.			<u>438.3</u>

E.C. TO FIELD VERIFY ALL EXISTING CONDITIONS AND LOCATIONS OF EQUIPMENT PRIOR TO BIDDING WORK.

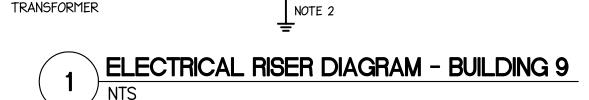

NOTE 3

MC#9

240/120V

1ø/3W

600A

**INTERIOR** 

PANEL

125A MLC

240/I20V

22,000AIC

TYPICAL

OF 4

PANEL

125A MLO

240/120V

22,000AIC

**TYPICAL** 

RISER DIAGRAM NOTES:

FINAL GRADE

TO NEAREST

EXISTING ?

EXTERIOR

125A 125A 125A

NOTE I

PROVIDE LABEL ON SERVICE EQUIPMENT PER 110.24(A) AND 110.22(A).

- SERVICE LATERAL CONDUCTORS TO METER CENTER PROVIDED AND INSTALLED BY UTILITY. E.C. TO PROVIDE (2) 3" CONDUITS. COORDINATE TRENCHING AND CONDUIT REQUIREMENTS; OWNER SHALL PAY ALL FEES.
- 2. #I/O CU. GND TO GROUNDING ELECTRODE SYSTEM, SEE I/EO.I.
- METER CENTER PROVIDED AND INSTALLED BY ELECTRICAL CONTRACTOR. METER CENTERS SHALL BE EQUAL TO SIEMENS POWER-MOD SERIES WITH 800A CROSS BUS. METERS PROVIDED AND INSTALLED BY POWER CO. COORDINATE REQUIREMENTS WITH POWER CO.
- 4. 2 POLE CIRCUIT BREAKER IN NEMA 3R ENCLOSURE, UL LISTED FOR SERVICE ENTRANCE EQUIPMENT. TYPICAL FOR ALL UNIT PANELS. AIC RATING OF FEEDER CIRCUIT BREAKERS SHALL BE AS INDICATED. RESIDENTIAL UNIT BRANCH CIRCUIT BREAKERS MAY BE SERIES RATED WITH FEEDER BREAKERS. PROVIDE NEW PHENOLIC ENGRAVED NAMEPLATE AT EACH METER IDENTIFYING APARTMENT NUMBER.
- 5. 3#2/0 (AL), #2 GND (AL) TYPE SER SERVICE ENTRANCE CABLE (TYPICAL FOR 125A PANELS) PER NEC 310.15(B)(7).

MC#9 SERVICE DEMAND			
UNIT TYPE	kVA CONN. PER PANEL	# OF PANELS	TOTAL kVA PER PANEL TYPE
U3	34.6	4	138.4
U4	42.1	2	84.2
RESIDENTIAL CONNECTED kVA			222.6
DEMAND FACTOR (NEC 220-84)			0.44
RESIDENTIAL DEMAND kVA			97.9
TOTAL DEMAND KVA			97.9
AMPS AT 240V, IPH.		407.9	

E.C. TO FIELD VERIFY ALL EXISTING CONDITIONS AND LOCATIONS OF EQUIPMENT PRIOR TO BIDDING WORK.

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NOTE 5 EXTERIOR INTERIOR MC#CA 240/120V PANEL PANEL MCB 125A MLO 125A MLO 240/120V 240/120\ 22,000AIC 22,000AIC TYPICAL TYPICAL *O*F 2 OF 4 FINAL GRADE TO NEAREST NOTE I EXISTING ~ TRANSFORMER NOTE 2

## ELECTRICAL RISER DIAGRAM - BUILDING C-A


RISER DIAGRAM NOTES:

PROVIDE LABEL ON SERVICE EQUIPMENT PER 110.24(A) AND 110.22(A).

- SERVICE LATERAL CONDUCTORS TO METER CENTER PROVIDED AND INSTALLED BY UTILITY. E.C. TO PROVIDE (2) 3" CONDUITS. COORDINATE TRENCHING AND CONDUIT REQUIREMENTS; OWNER SHALL PAY ALL FEES.
- 2. #I/O CU. GND TO GROUNDING ELECTRODE SYSTEM, SEE I/EO.I.
- METER CENTER PROVIDED AND INSTALLED BY ELECTRICAL CONTRACTOR. METER CENTERS SHALL BE EQUAL TO SIEMENS POWER-MOD SERIES WITH 800A CROSS BUS. METERS PROVIDED AND INSTALLED BY POWER CO. COORDINATE REQUIREMENTS WITH POWER CO.
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- 5. 3#2/0 (AL), #2 GND (AL) TYPE SER SERVICE ENTRANCE CABLE (TYPICAL FOR 125A PANELS) PER NEC 310.15(B)(7).

MC#CA SERVICE DEMAND			
UNIT TYPE	kVA CONN. PER PANEL	# OF PANELS	TOTAL kVA PER PANEL TYPE
UI	32.8	2	65.6
U3	34.6	4	138.4
RESIDENTIAL CONNECTED kVA			204.0
DEMAND FACTOR (NEC 220-84)			0.44
RESIDENTIAL DEMAND KVA			90.0
TOTAL DEMAND kVA			90.0
AMPS AT 240V, IPH.			<u>375.0</u>

E.C. TO FIELD VERIFY ALL EXISTING CONDITIONS AND LOCATIONS OF EQUIPMENT PRIOR TO BIDDING WORK.

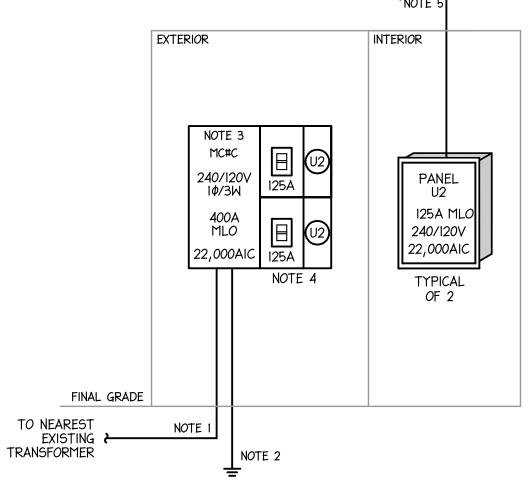

## ELECTRICAL RISER DIAGRAM - BUILDING C

RISER DIAGRAM NOTES:

PROVIDE LABEL ON SERVICE EQUIPMENT PER 110.24(A) AND 110.22(A).

- I. SERVICE LATERAL CONDUCTORS TO METER CENTER PROVIDED AND INSTALLED BY UTILITY. E.C. TO PROVIDE (2) 3" CONDUITS. COORDINATE TRENCHING AND CONDUIT REQUIREMENTS; OWNER SHALL PAY ALL FEES.
- 2. #2 CU. GND TO GROUNDING ELECTRODE SYSTEM, SEE 1/EO.I.
- METER CENTER PROVIDED AND INSTALLED BY ELECTRICAL CONTRACTOR. METER CENTERS SHALL BE EQUAL TO SIEMENS POWER-MOD SERIES WITH 800A CROSS BUS. METERS PROVIDED AND INSTALLED BY POWER CO. COORDINATE REQUIREMENTS WITH POWER CO.
- 4. 2 POLE CIRCUIT BREAKER IN NEMA 3R ENCLOSURE, UL LISTED FOR SERVICE ENTRANCE EQUIPMENT. TYPICAL FOR ALL UNIT PANELS. AIC RATING OF FEEDER CIRCUIT BREAKERS SHALL BE AS INDICATED. RESIDENTIAL UNIT BRANCH CIRCUIT BREAKERS MAY BE SERIES RATED WITH FEEDER BREAKERS. PROVIDE NEW PHENOLIC ENGRAVED NAMEPLATE AT EACH METER IDENTIFYING APARTMENT NUMBER.
- 5. 3#2/0 (AL), #2 GND (AL) TYPE SER SERVICE ENTRANCE CABLE (TYPICAL FOR 125A PANELS) PER NEC 310.15(B)(7).

MC#C SERVICE DEMAND			
UNIT TYPE	kVA CONN. PER PANEL	# OF PANELS	TOTAL KVA PER PANEL TYPE
U2	33.8	3	101.4
RESIDENTIAL CONNECTED kVA			101.4
DEMAND FACTOR (NEC 220-85)			0.45
RESIDENTIAL DEMAND kVA			45.6
TOTAL DEMAND kVA			45.6
AMPS AT 240V, IPH.			190.0

E.C. TO FIELD VERIFY ALL EXISTING CONDITIONS AND LOCATIONS OF EQUIPMENT PRIOR TO BIDDING WORK.

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