


Beaufort PK-3 School

BEAUFORT COUNTY PUBLIC SCHOOLS

947 Hudnell St

Beaufort County / North Carolina

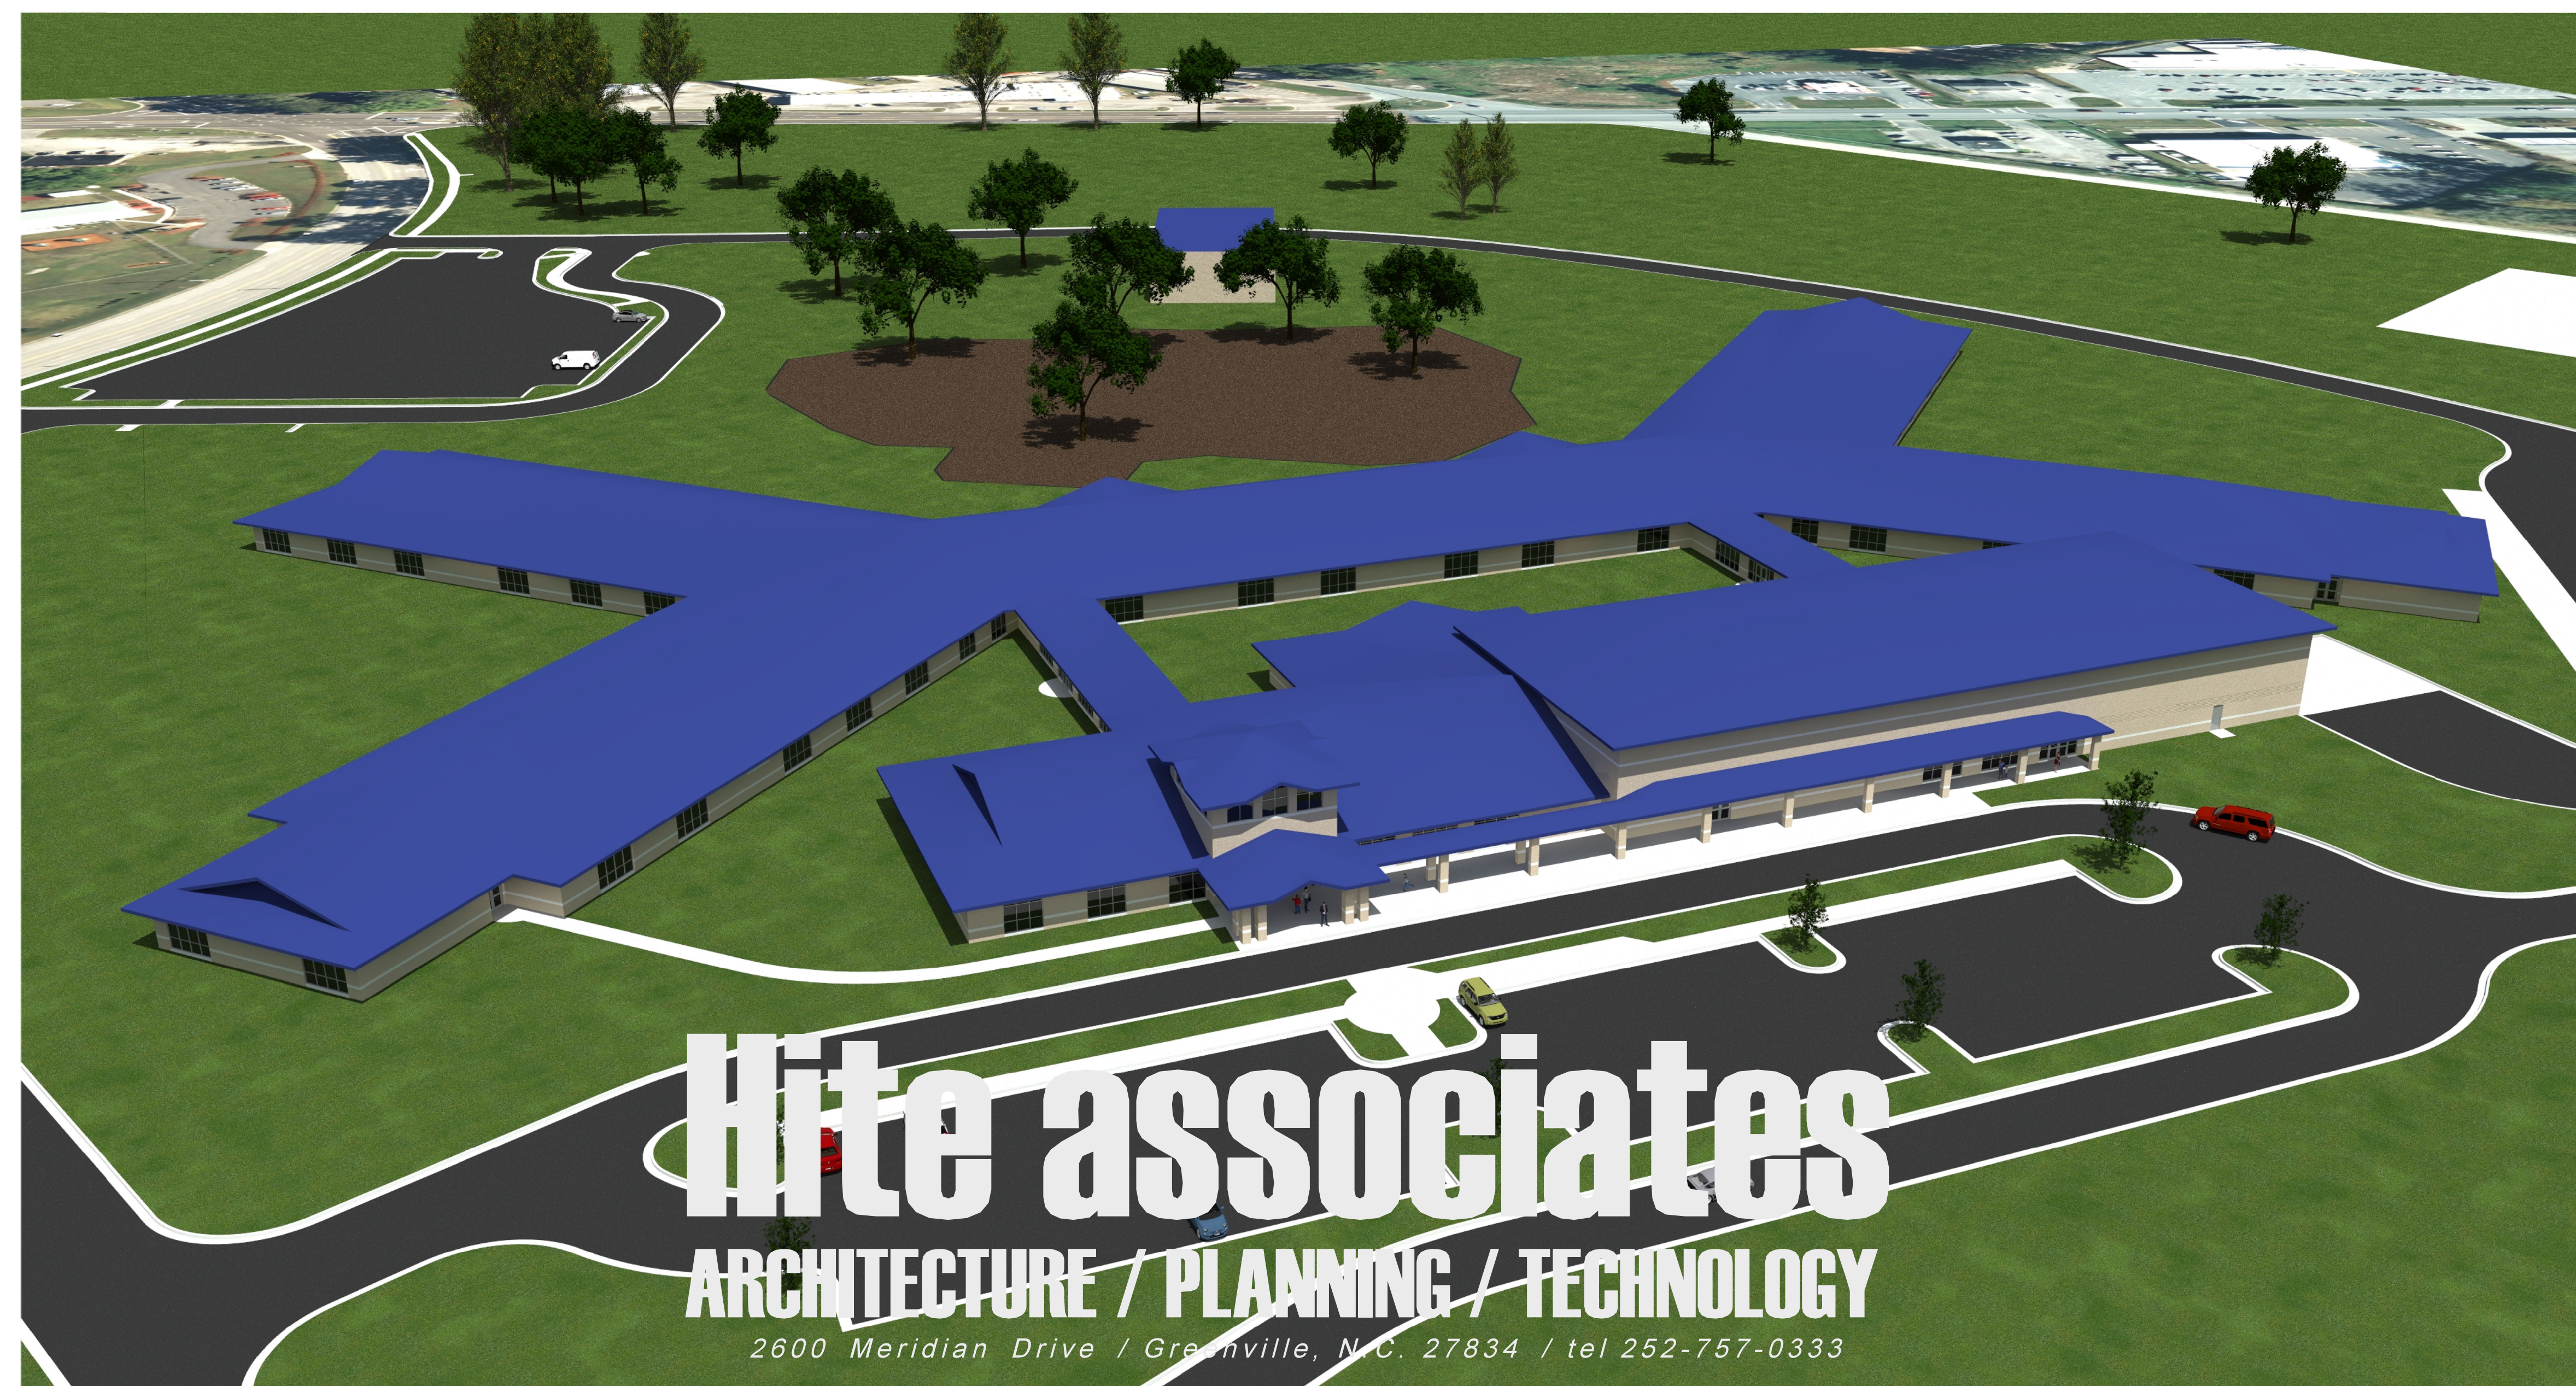

2 OF 3

STRUCTURAL CONSULTANT:

QUEEN ENGINEERING & DESIGN, P.A.

5530 Munford Road Raleigh, North Carolina 27612 tel (919) 420-0480

CIVIL CONSULTANT:

RIVERS AND ASSOCIATES, INC.

107 East 2nd Street Greenville, North Carolina 27858 tel (252) 752-4135

MEPT ENGINEERING CONSULTANT:

ENGINEERING SOURCE, P.A.

102 Regency Boulevard Greenville, North Carolina 27834 tel (252) 439-0338

Set Two of Three: ARCHITECTURAL - FOOD SERVICE - STRUCTURAL

ABBREVIATIONS

Table of abbreviations for architectural drawings, including terms like AFF (Above Finish Floor), ANGLE, AB (Anchor Bolt), etc.

DRAWING INDEX

SET 1 OF 3 COVER

Index table for Set 1 of 3, listing drawing titles and sheet numbers for categories like BCS-100 (Building Code Summary), LS-001 (Life Safety Plan), and FRA-001 (Fire Rated Assemblies).

SET 2 OF 3 COVER

Index table for Set 2 of 3, listing drawing titles and sheet numbers for categories like A-001 (Overall Floor Plan), A-800 (Building Sections), and A-901 (Millwork Details).

SET 3 OF 3 COVER

Index table for Set 3 of 3, listing drawing titles and sheet numbers for categories like FP-001 (Rated Wall Details), PME-001 (Site Lighting Information), and P-001 (Plumbing Notes & Schedules).

DRAWING SYMBOLS

DRAWING IDENTIFICATION MARKERS

201.1




Table of drawing symbols: a dashed line for 'HIDDEN LINE OR ABSTRACT LINE', a line with a dash for 'LINE ABOVE', and a long-dashed line for 'CENTERLINE'.

MATERIAL SYMBOLS

- List of material symbols: EARTH, SAND, MORTAR OR GROUT, CONCRETE, BRICK, CONCRETE MASONRY UNIT, STEEL, ROUGH WOOD (CONTINUOUS), ROUGH WOOD (INTERMITTENT), FINISH WOOD, PLYWOOD, BATT OR BLOWN INSULATION, RIGID INSULATION, METAL STUD / GYPBOARD WALL.

Continuation of drawing index for sets 1, 2, and 3, listing drawing titles and sheet numbers for various mechanical, structural, and plumbing details.

Revision table with columns for No., Date, and Revision.

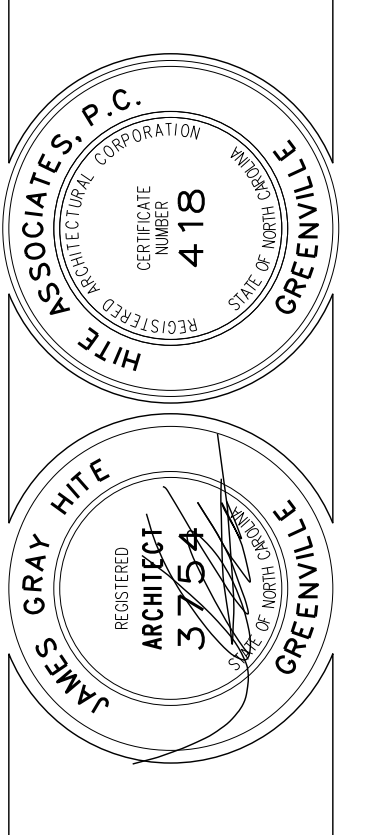

600 Unit Existing Gymnasium

GENERAL NOTES:

- (1) CMU WALLS WHERE INDICATED SHALL BE RUN SOLID TO BOTTOM OF DECK, GROUTED SOLID TO DECK. ALL OTHER CMU WALLS UNLESS OTHERWISE NOTED, SHALL BE RUN TO FULL BLOCK COURSE ABOVE CEILING. UNBRACED SECTIONS OF LESS-THAN-FULL-HEIGHT WALLS SHALL BE BRACED TO ROOF. SEE STRUCTURAL DRAWINGS.
- (2) CMU WALL INTERSECTIONS SHALL BE BONDED WITH HOT DIPPED GALVANIZED HARDWARE CLOTH EACH COURSE AND PREFORMED "T" HORIZONTAL REINFORCING AS SPECIFIED AT 16" ON CENTER.
- (3) PROVIDE WALL CONTROL AND EXPANSION JOINTS WHERE SHOWN AND DETAILED OR IN PRE-APPROVED, ALTERNATING LOCATIONS 32" ON CENTER MAXIMUM PROVIDE IN ONE SIDE OF EACH OPENING IN MASONRY WALLS BOTH SIDES IN OPENINGS WITH WIDTH EXCEEDING 5'-0". SEE DETAIL.
- (4) PROVIDE WALL EXPANSION JOINTS AT POINTS AND INTERSECTIONS WHERE INDICATED, 1/2" WIDE, FILLED WITH EXPANSION JOINT MATERIAL AND CAULK, WITH BACKER ROD EACH EXPOSED SIDE.
- (5) ALL 90° OUTSIDE CMU CORNERS SHALL HAVE BULLNOSE EDGE LION.
- (6) ALL 45° CMU WALL BENDS SHALL BE CONSTRUCTED WITH SPECIAL PRECAST UNITS.
- (7) INTERIOR CMU JOINTS SHALL BE TOOLED CONCAVE.
- (8) ALL CMU SURFACES TO RECEIVE PAINT OR PLASTER SHALL BE POINTED UP AND PATCHED WITH MORTAR TO ELIMINATE DEPRESSIONS, VOIDS, OR OTHER IRREGULARITIES LARGER THAN 1/4" DIAMETER. PAINTER SHALL CAULK SMALL DEFECTS LARGER THAN 1/4" DIAMETER AFTER APPLICATION OF BLOCK FILLER. BLOCK FILLER SHALL BE APPLIED IN THICKNESS AND COATS REQUIRED TO ELIMINATE ALL VOIDS AND PINHOLES IN MASONRY SURFACES. FINISH PAINT SHALL BE SPRAY APPLIED & ROLLED IN.
- (9) LAY-IN ACUSTICAL TILE CEILING SYSTEM SHALL BE 2' x 2' GRID, IN LAYING OUT CEILINGS COORDINATE WITH MECHANICAL AND ELECTRICAL DRAWINGS, AND AVOID THE USE OF LESS-THAN-HALF SIZE UNITS.
- (10) PROVIDE EXTERIOR CONCRETE WALKS AND CONCRETE AREAS WITH EXPANSION AND SCORED JOINTS IN PRE-APPROVED LOCATIONS. EXPANSION JOINTS SHALL BE 1/2" WIDE WITH EDGES TOOLED TO 1/4" RAD. AND FILLED WITH HOT RUBBER ASPHALT SEALANT - PROVIDE AT ALL CORNERS, INTERSECTIONS, CHANGES IN SLOPE OR DIRECTION, AGAINST EXISTING OR NEW WALLS OR PAVEMENTS, AND AT INTERVALS NOT TO EXCEED 30'. SCORED JOINTS SHALL BE SCORED 1" DEEP MINIMUM AND RADUSED 1/4", AND SHALL BE PLACED AT INTERVALS NOT TO EXCEED 5 FEET.
- (11) GENERAL CONTRACTOR SHALL CONFIRM CASEWORK BUILT-INS AND ACCESSORIES LOCATIONS WITH OTHER PRIME CONTRACTORS TO COORDINATE INSTALLATION OF PLUMBING, MECHANICAL, AND ELECTRICAL FIXTURES.

QUALITY CONTROL:

- (1) CONSTRUCT SAMPLE 4' x 4' WALL PANEL WITH INSULATION IN PLACE, SHOWING EXTERIOR BRICK AND INTERIOR BLOCK WORKMANSHIP. APPROVED PANEL WILL BE USED AS STANDARD OF QUALITY REQUIRED THROUGHOUT.
- (2) COMPLETE CONSTRUCTION OF ONE EACH OF THE FOLLOWING IS REQUIRED FOR ARCHITECTS APPROVAL. APPROVED CONSTRUCTION IN EACH CASE WILL BE USED AS STANDARD OF QUALITY REQUIRED THROUGHOUT.
 - A. WINDOW SECTION, FITTED AND CAULKED.
 - B. ROOF OVERHANG WITH GUTTER.
 - C. ROOF CORING SECTIONS (2 WITH JOINT).
 - D. CLASSROOM: CARPET, RUBBER BASE, PAINTING/STAINING, CHALKBOARDS AND TACKBOARDS, CEILING.
- (3) SEE SPECIFICATIONS FOR ALLOWABLE CONSTRUCTION TOLERANCES. THESE WILL BE CHECKED AND ENFORCED.

Student Capacity (per DPI)			
GRADE	NO. CLASSROOMS	CAPACITY	TOTAL
PK	5	18	90
K	13	18	234
1	13	17	221
2	12	17	204
3	12	17	204
EC	2	10	20
			973

400 Unit Second Grade / Third Grade

200 Unit Kindergarten / First Grade

300 Unit Pre-K / E.C.

Art / Music

Media

Multipurpose

Cafeteria

Admin

100 Unit Admin / Media / Multipurpose / Cafeteria

Gross Building Square Footages

- 100 Unit Administration: 34,560 square feet
- 200 Unit Classroom Wing: 41,288 square feet
- 300 Unit Classroom Wing: 17,920 square feet
- 400 Unit Classroom Wing: 38,728 square feet
- 500 Connectors: 3,198 square feet

Grand Total Base Plan New Construction: 135,692 square feet
600 Existing Gym: 7,905 square feet

001.1 OVERALL FLOOR PLAN

SCALE: 1" = 20'-0"


No.	Date	Revision

Hite associates
ARCHITECTURE / PLANNING / TECHNOLOGY
2600 Meridian Drive / Greenville, NC 27834 / tel (252) 757-0333



Beaufort PK-3 School
BEAUFORT COUNTY SCHOOLS
Washington / North Carolina / 27889

Project No: 22344
Date: 1 July 2024
Drawing no: **A 001**

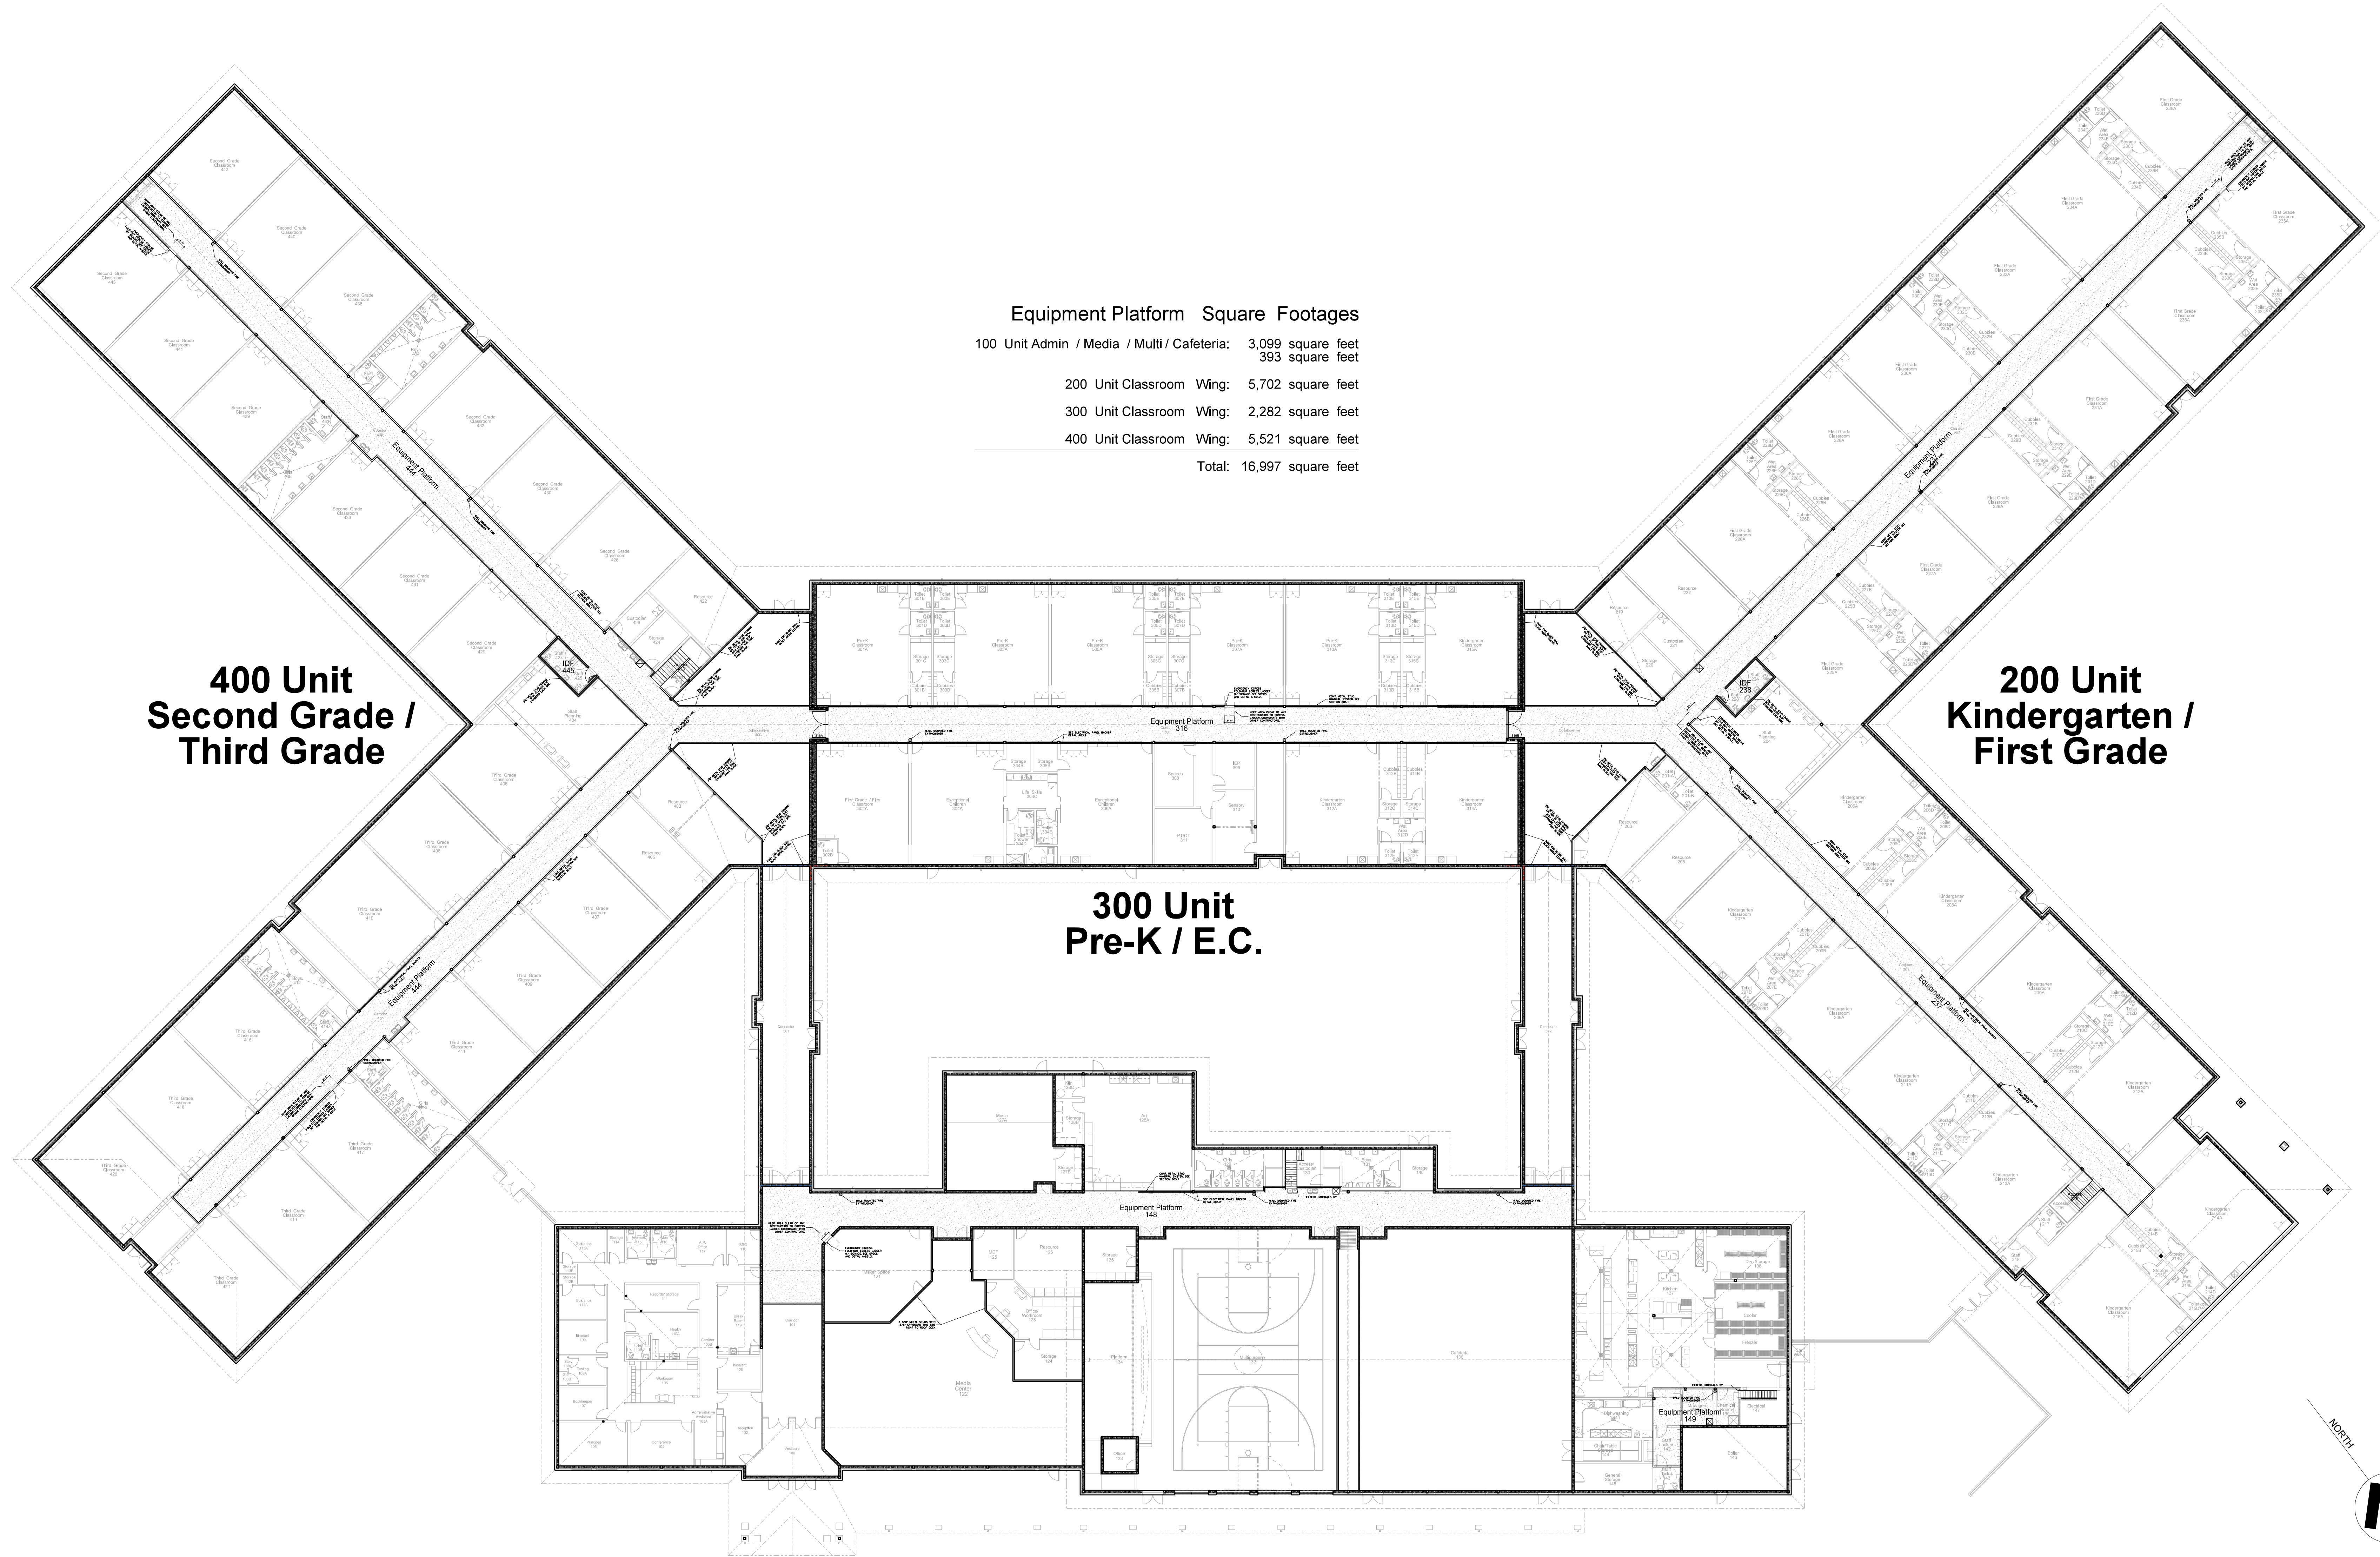

Equipment Platform	Square Footages
100 Unit Admin / Media / Multi / Cafeteria:	3,099 square feet
	393 square feet
200 Unit Classroom Wing:	5,702 square feet
300 Unit Classroom Wing:	2,282 square feet
400 Unit Classroom Wing:	5,521 square feet
Total:	16,997 square feet

**400 Unit
Second Grade /
Third Grade**

**200 Unit
Kindergarten /
First Grade**

**300 Unit
Pre-K / E.C.**

**100 Unit
Admin / Media /
Multipurpose / Cafeteria**

002.1 OVERALL PLATFORM PLAN
SCALE: 1" = 20'-0"


No.	Date	Revision

Hite associates
ARCHITECTURE / PLANNING / TECHNOLOGY
2600 Meridian Drive / Greenville, NC 27834 / tel (252) 757-0333




Beaufort PK-3 School
BEAUFORT COUNTY SCHOOLS
Washington / North Carolina / 27889

Project No: 22344
Date: 1 July 2024
Drawing no: **A 002**

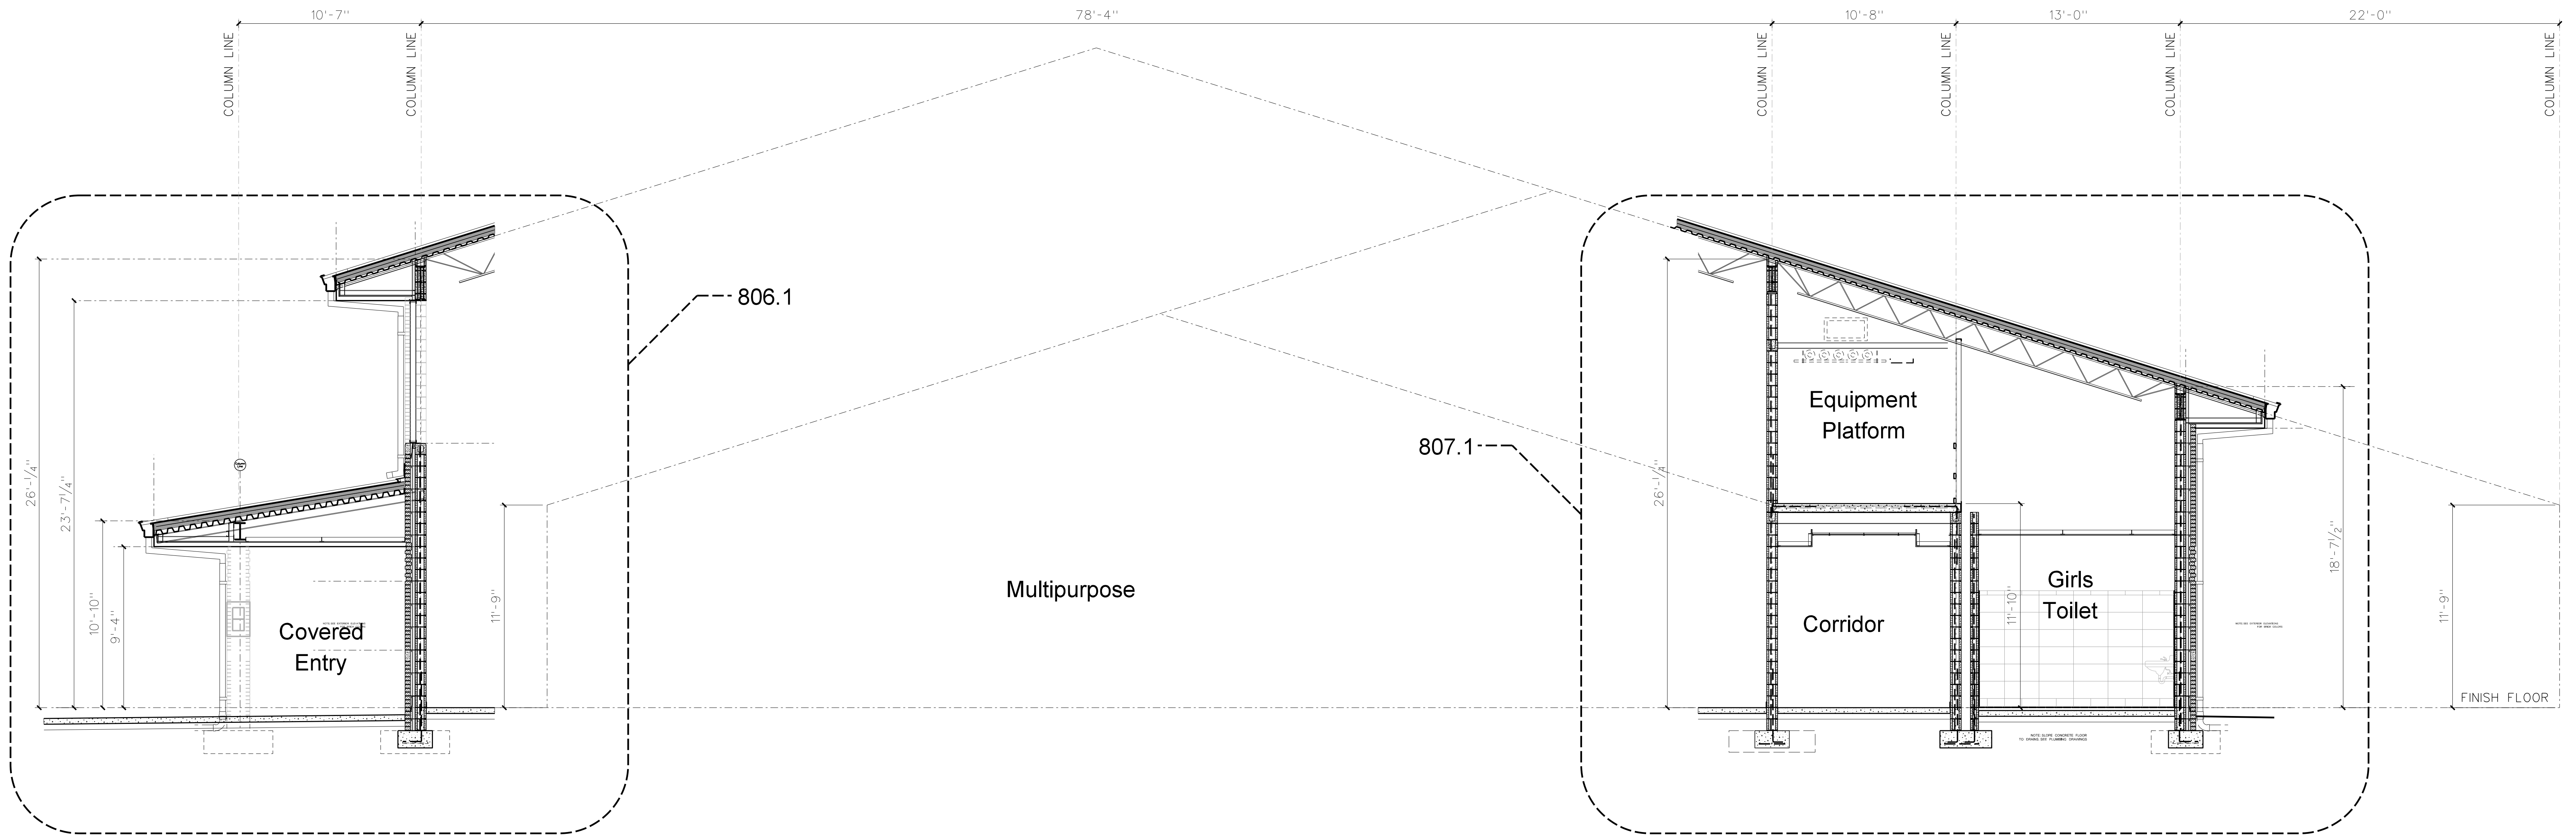


800.2 BUILDING SECTION
SCALE: 1/4" = 1'-0"

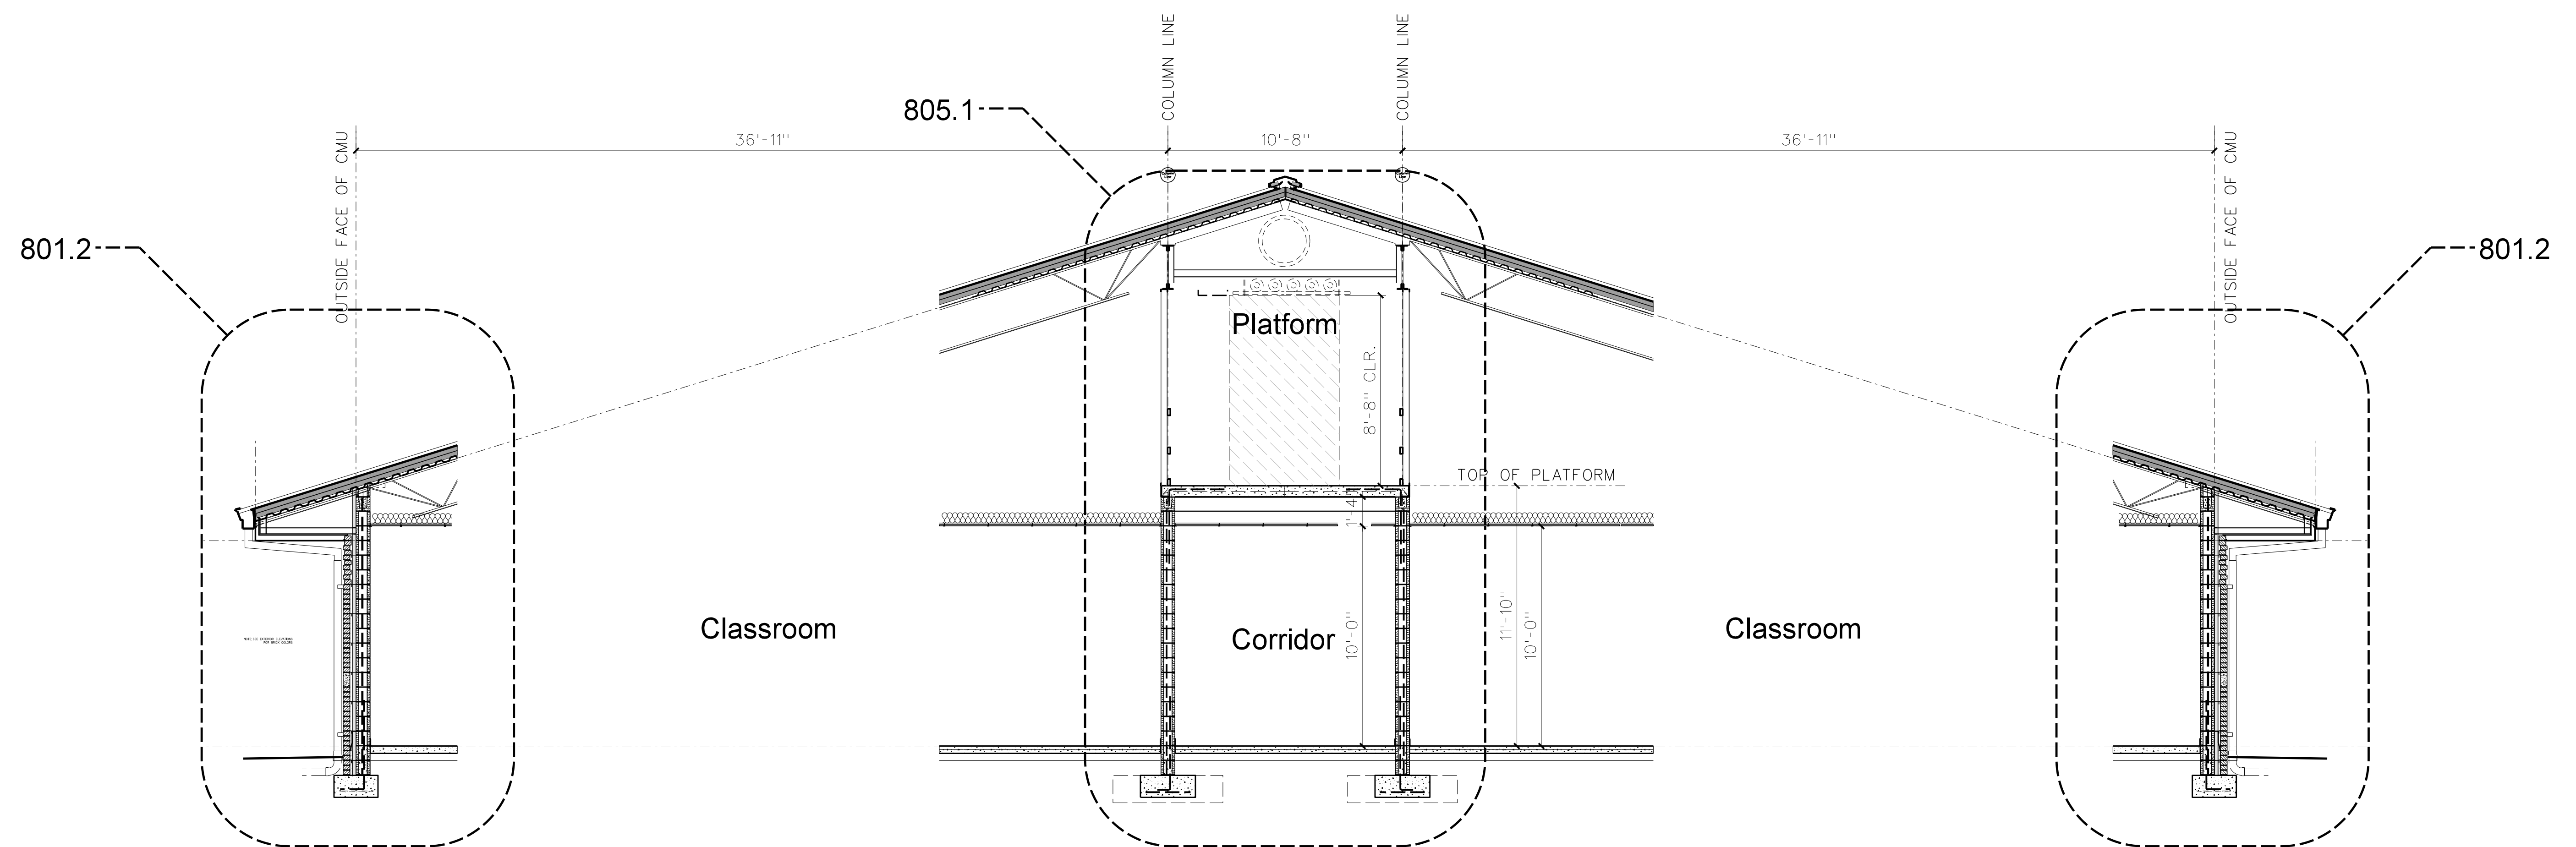

800.1 BUILDING SECTION
SCALE: 1/4" = 1'-0"

No.	Date	Revision

Hite associates
 ARCHITECTURE / PLANNING / TECHNOLOGY
 2600 Meridian Drive / Greenville, NC 27834 / tel (252) 757-0333

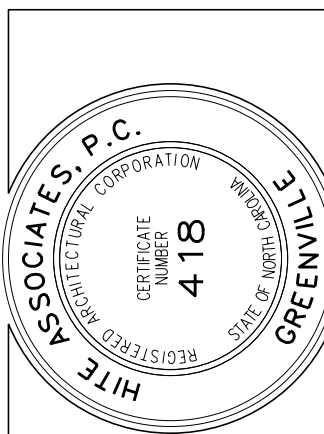


Beaufort PK-3 School
 BEAUFORT COUNTY SCHOOLS
 Washington / North Carolina / 27889

Project No.	22344
Date:	1 July 2024
Drawing no.	A 800

- General Notes for Wall Sections**
- (1) SEE EXTERIOR ELEVATIONS FOR BRICK COLOR.
 - (2) GENERAL CONTRACTOR SHALL VERIFY TOP OF FINISH GRADES, TOP OF CONCRETE WALKS AND TOP OF CONCRETE SLABS ADJACENT TO BUILDING AND ADJUST LOCATION OF THROUGH WALL FLASHING ACCORDINGLY.
 - (3) PROVIDE PLASTIC INSERT WEEPS AT ALL AT DOOR, WINDOW AND FLOOR FLASHING.
 - (4) GENERAL CONTRACTOR SHALL SLOPE CONCRETE FLOOR TO FLOOR DRAINS AS SHOWN ON PLUMBING DRAWINGS.
 - (5) ALL CMU CELLS BELOW FINISH FLOOR SHALL BE FILLED WITH CONCRETE.
 - (6) ALL VAPOR BARRIERS UNDER FLOOR SLABS SHALL BE LAPPED 12" MINIMUM AND TAPED CONTINUOUS AT JOINTS. GENERAL CONTRACTOR SHALL REPAIR ANY DAMAGED VAPOR BARRIER PRIOR TO PLACING CONCRETE.
 - (7) PROVIDE 4" MINIMUM SPRAY POLYURETHANE INSULATION IN ALL METAL STUDS EXTERIOR WALLS. SEE WALL SECTIONS AND SPECIFICATIONS.
 - (8) PROVIDE SPRAY POLYURETHANE INSULATION IN ALL NESTED METAL STUD WINDOW AND DOOR JAMBS, SILLS AND HEADS.
 - (9) ALL INTERIOR METAL STUD/GYPSUM WALLBOARD PARTITIONS REQUIRE SOUND ATTENUATION BATTS.
 - (10) PROVIDE METAL CHAIRS UNDER ALL STEEL WIRE MATS REINFORCING STEEL FOR CONCRETE SLABS AND FOUNDATIONS.
 - (11) PROVIDE GYPSUM CONTROL JOINTS AT ALL GYPSUM / METAL STUD WINDOW JAMBS. SEE INTERIOR ELEVATIONS.
 - (12) ALL SEALANT COLORS TO BE SELECTED BY ARCHITECT.
 - (13) ROOF INSULATION TAPE ALL ROOF INSULATION JOINTS, BOTH LAYER LAP AND TAPE VAPOR BARRIER. ARCHITECT TO FIELD VERIFY PRIOR TO METAL ROOF PANEL INSTALLATION.
 - (14) PROVIDE PRE-FORMED THRU-WALL FLASHING CORNER MEMBERS FOR EXTERIOR WALL CORNERS AS SPECIFIED.


No.	Date	Revision

Hite associates
 ARCHITECTURE / PLANNING / TECHNOLOGY
 2600 Meridian Drive / Greenville, NC 27834 / tel (252) 757-0333

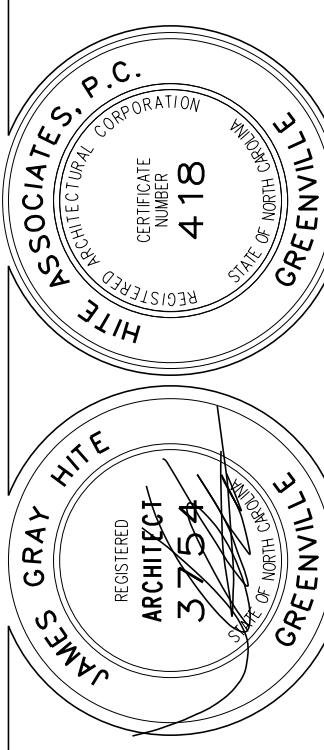


Beaufort PK-3 School
 BEAUFORT COUNTY SCHOOLS
 Washington / North Carolina / 727889

Project No. 22344
 Date: 1 July 2024
 Drawing no. **A 801**

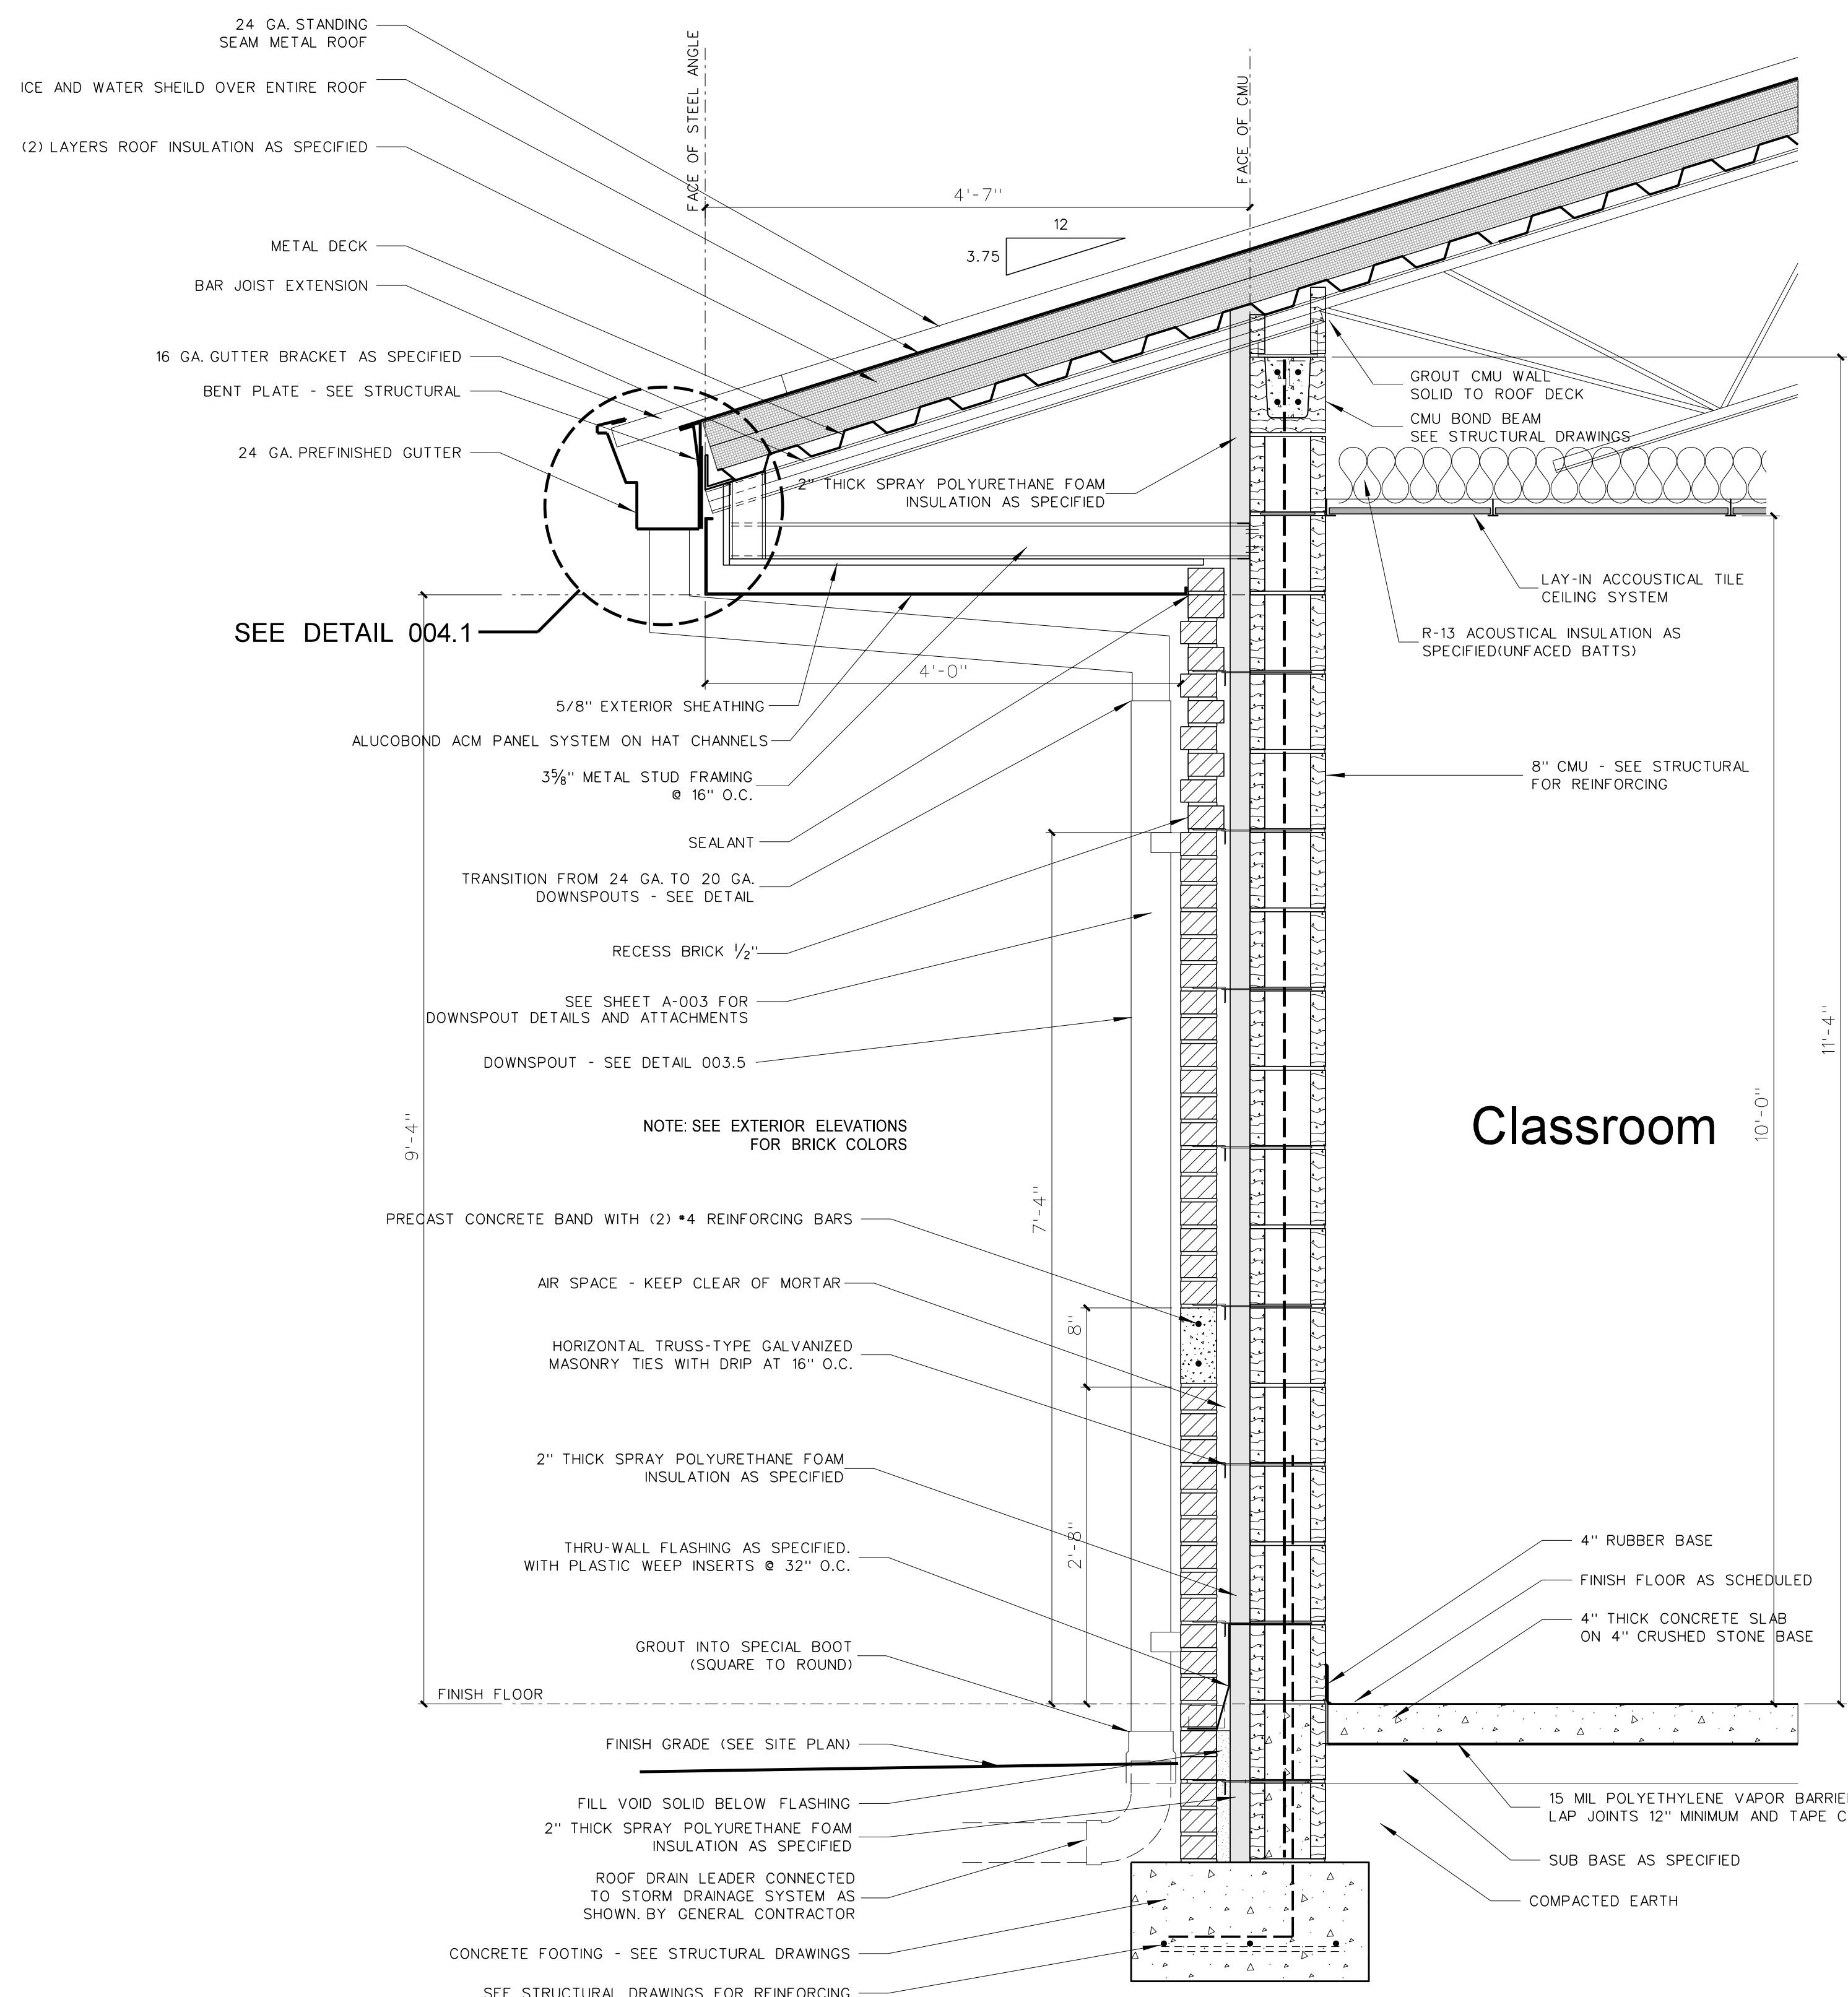


801.2 TYPICAL WALL SECTION
 SCALE: 1" = 1'-0"

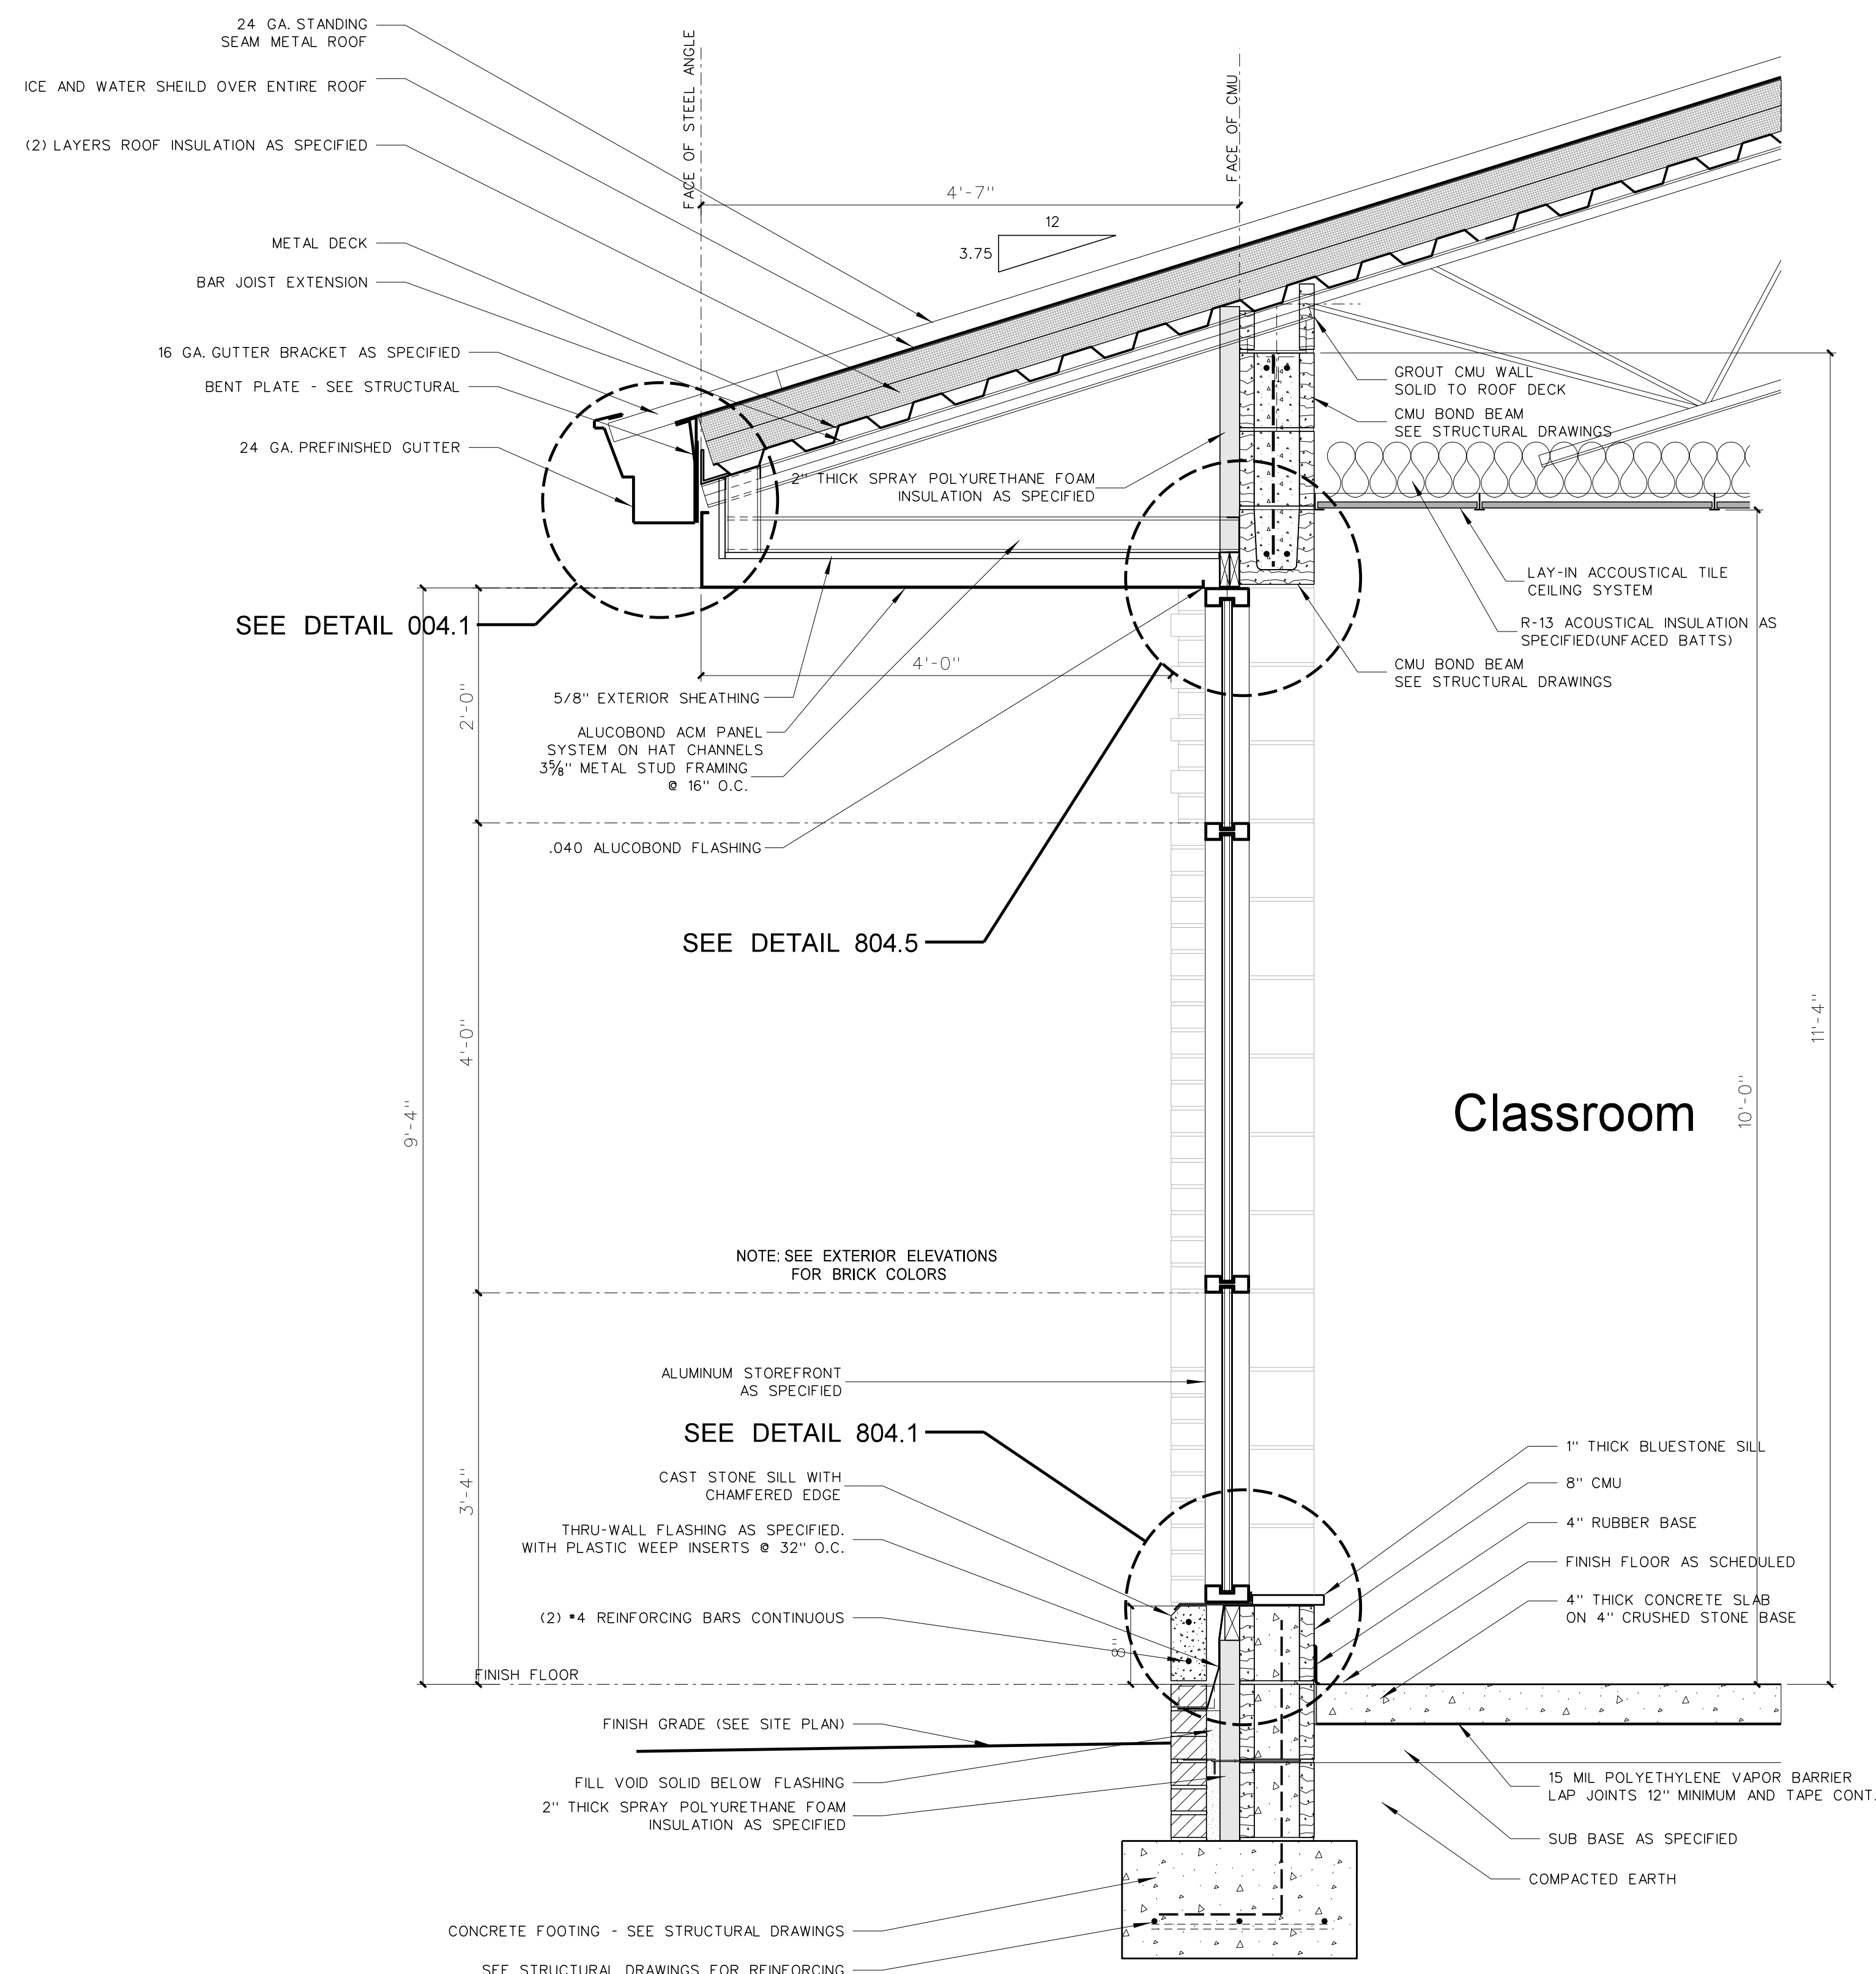


801.1 TYPICAL WALL SECTION @ STOREFRONT WINDOW
 SCALE: 1" = 1'-0"

- ### General Notes for Wall Sections
- (1) SEE EXTERIOR ELEVATIONS FOR BRICK COLOR.
 - (2) GENERAL CONTRACTOR SHALL VERIFY TOP OF FINISH GRADES, TOP OF CONCRETE WALKS AND TOP OF CONCRETE SLABS ADJACENT TO BUILDING AND ADJUST LOCATION OF THROUGH WALL FLASHING ACCORDINGLY.
 - (3) PROVIDE PLASTIC INSERT WEEPS AT ALL AT DOOR, WINDOW AND FLOOR DRAINS AS SHOWN ON PLUMBING DRAWINGS.
 - (4) GENERAL CONTRACTOR SHALL SLOPE CONCRETE FLOOR TO FLOOR DRAINS AS SHOWN ON PLUMBING DRAWINGS.
 - (5) ALL CMU CELLS BELOW FINISH FLOOR SHALL BE FILLED WITH CONCRETE.
 - (6) ALL VAPOR BARRIERS UNDER FLOOR SLABS SHALL BE LAPPED 12" MINIMUM AND TAPED CONTINUOUS AT JOINTS. GENERAL CONTRACTOR SHALL REPAIR ANY DAMAGED VAPOR BARRIER PRIOR TO PLACING CONCRETE.
 - (7) PROVIDE 4" MINIMUM SPRAY POLYURETHANE INSULATION IN ALL METAL STUDS EXTERIOR WALLS. SEE WALL SECTIONS AND SPECIFICATIONS.
 - (8) PROVIDE SPRAY POLYURETHANE INSULATION IN ALL NESTED METAL STUD WINDOW AND DOOR JAMBS, SILLS AND HEADS.
 - (9) ALL INTERIOR METAL STUD/GYPSUM WALLBOARD PARTITIONS REQUIRE SOUND ATTENUATION BATTS.
 - (10) PROVIDE METAL CHAIRS UNDER ALL STEEL WIRE MATS REINFORCING STEEL FOR CONCRETE SLABS AND FOUNDATIONS.
 - (11) PROVIDE GYPSUM CONTROL JOINTS AT ALL GYPBOARD / METAL STUD WINDOW JAMBS. SEE INTERIOR ELEVATIONS.
 - (12) ALL SEALANT COLORS TO BE SELECTED BY ARCHITECT.
 - (13) ROOF INSULATION TAPE ALL ROOF INSULATION JOINTS, BOTH LAYER LAP AND TAPE VAPOR BARRIER. ARCHITECT TO FIELD VERIFY PRIOR TO METAL ROOF PANEL INSTALLATION.
 - (14) PROVIDE PRE-FORMED THRU-WALL FLASHING CORNER MEMBERS FOR EXTERIOR WALL CORNERS AS SPECIFIED.

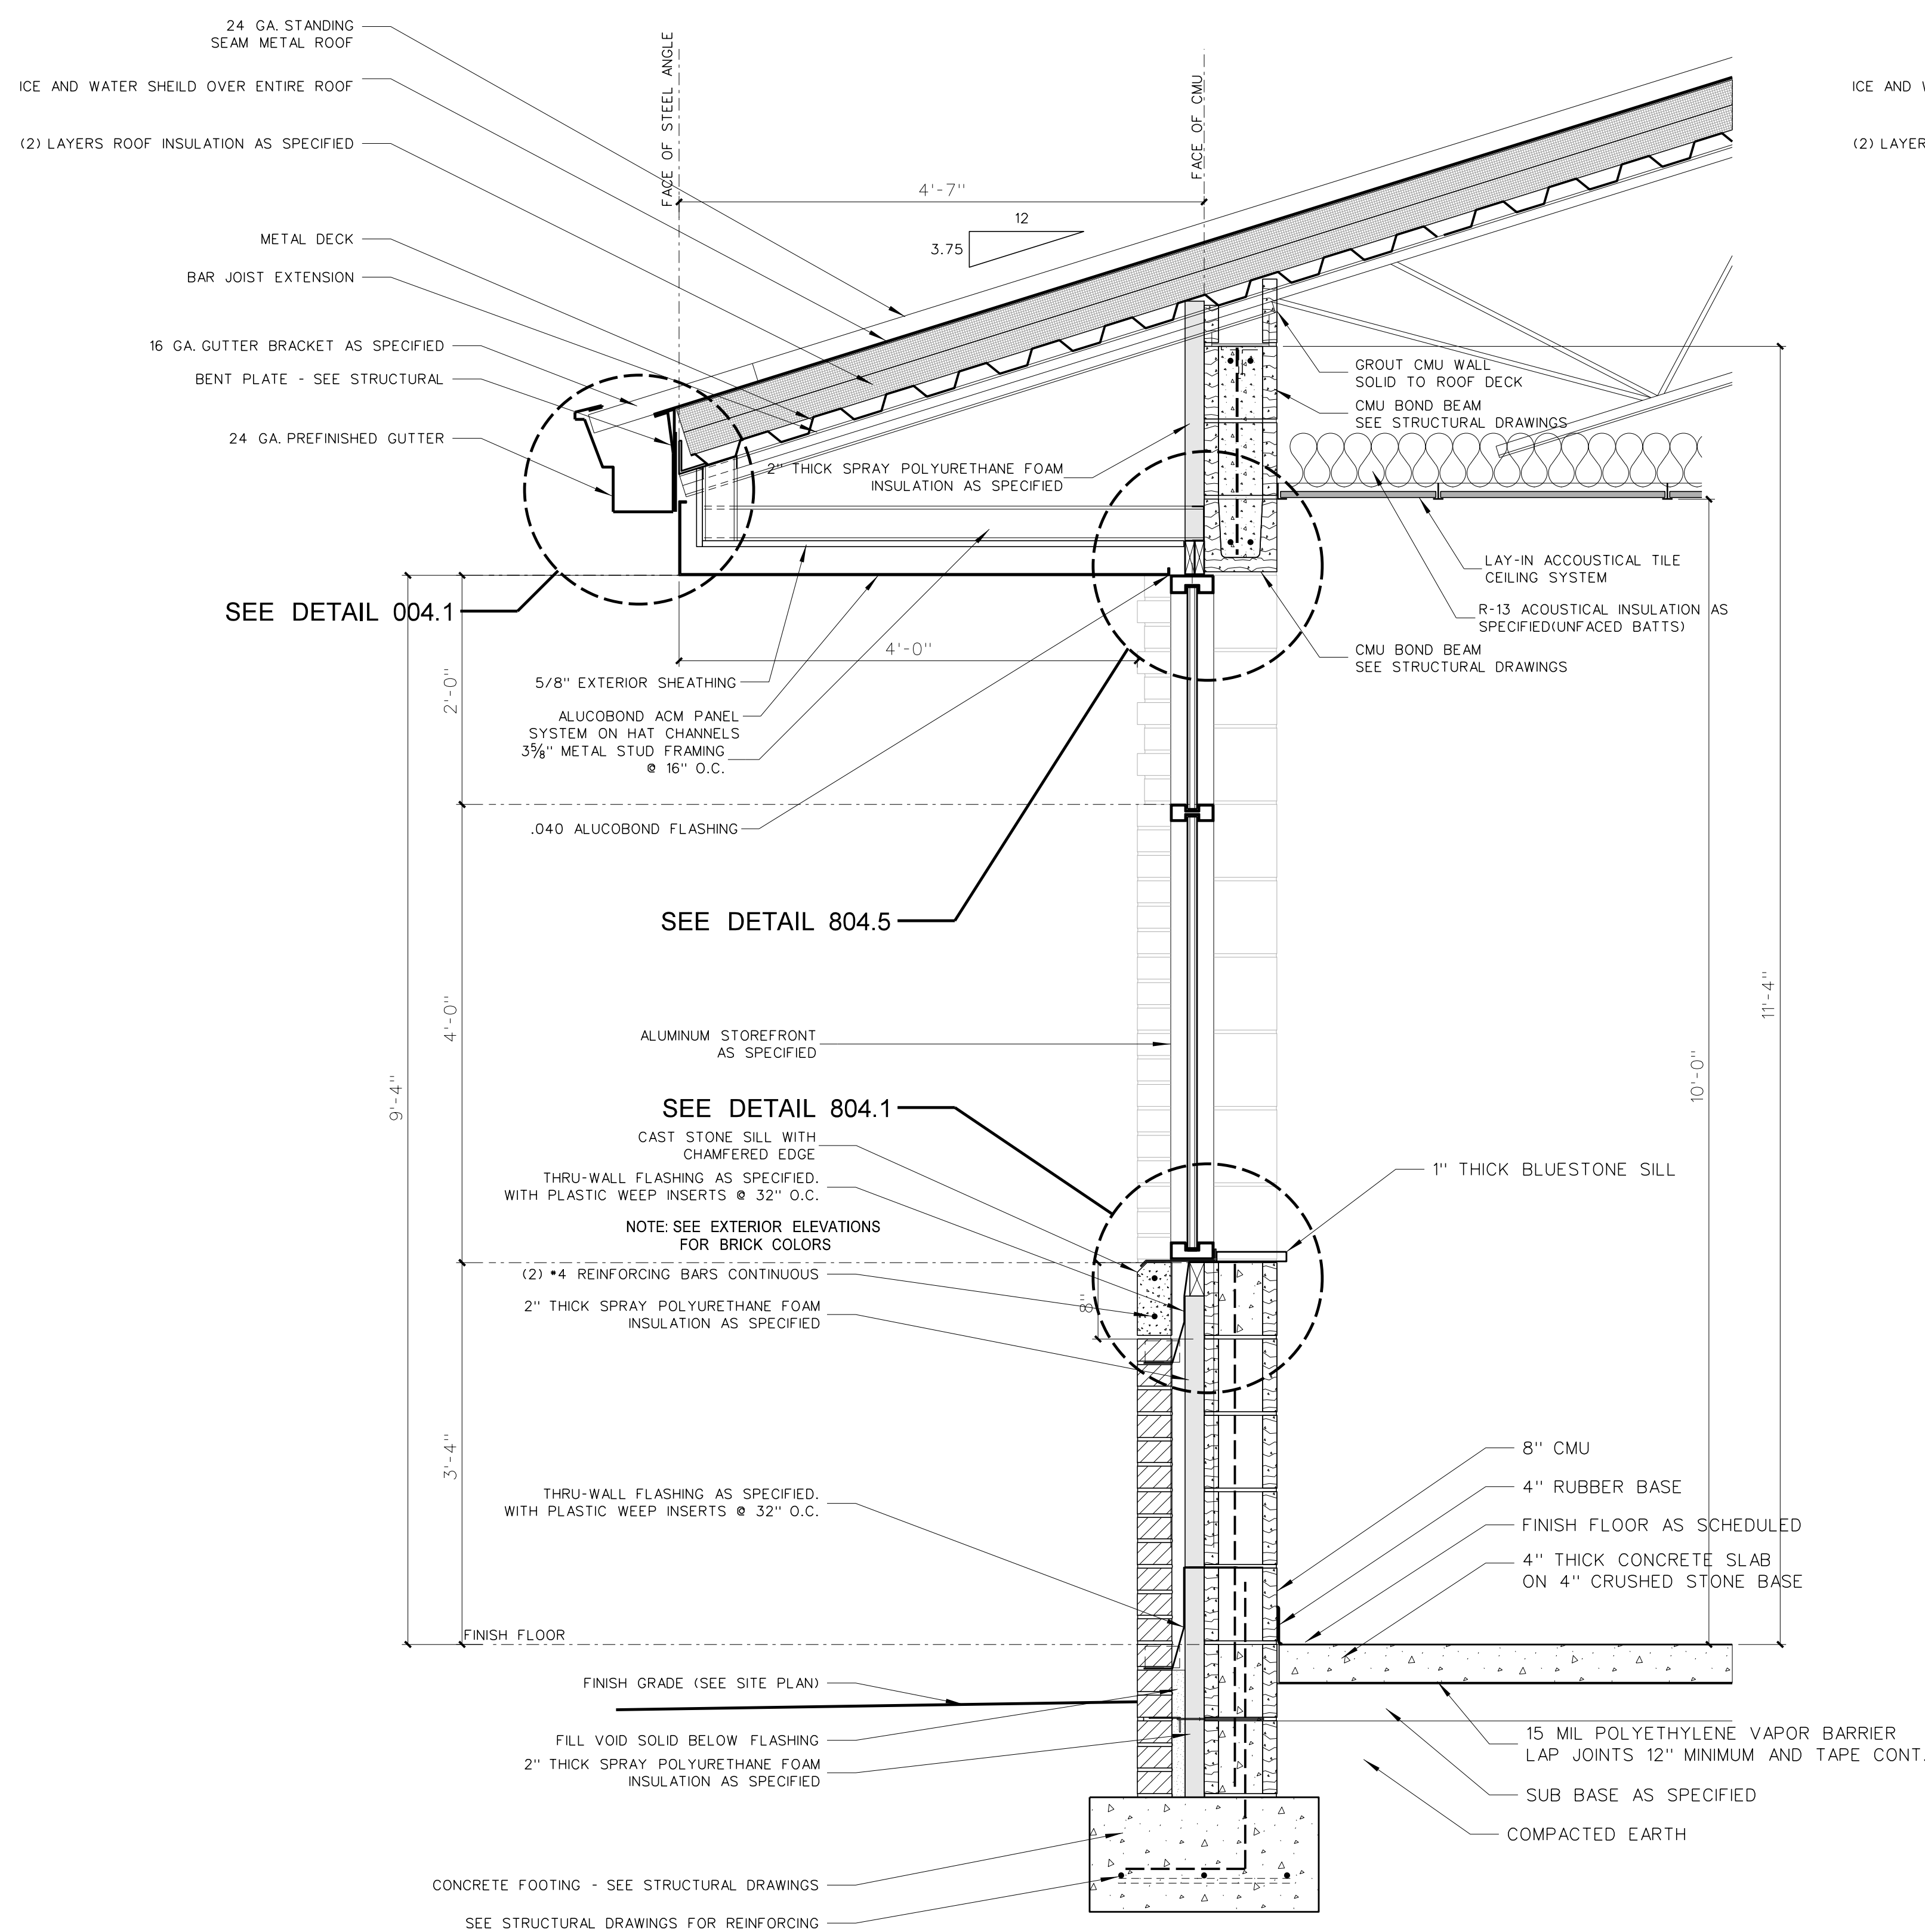

802.2 TYPICAL WALL SECTION @ STOREFRONT WINDOW
SCALE: 1" = 1'-0"

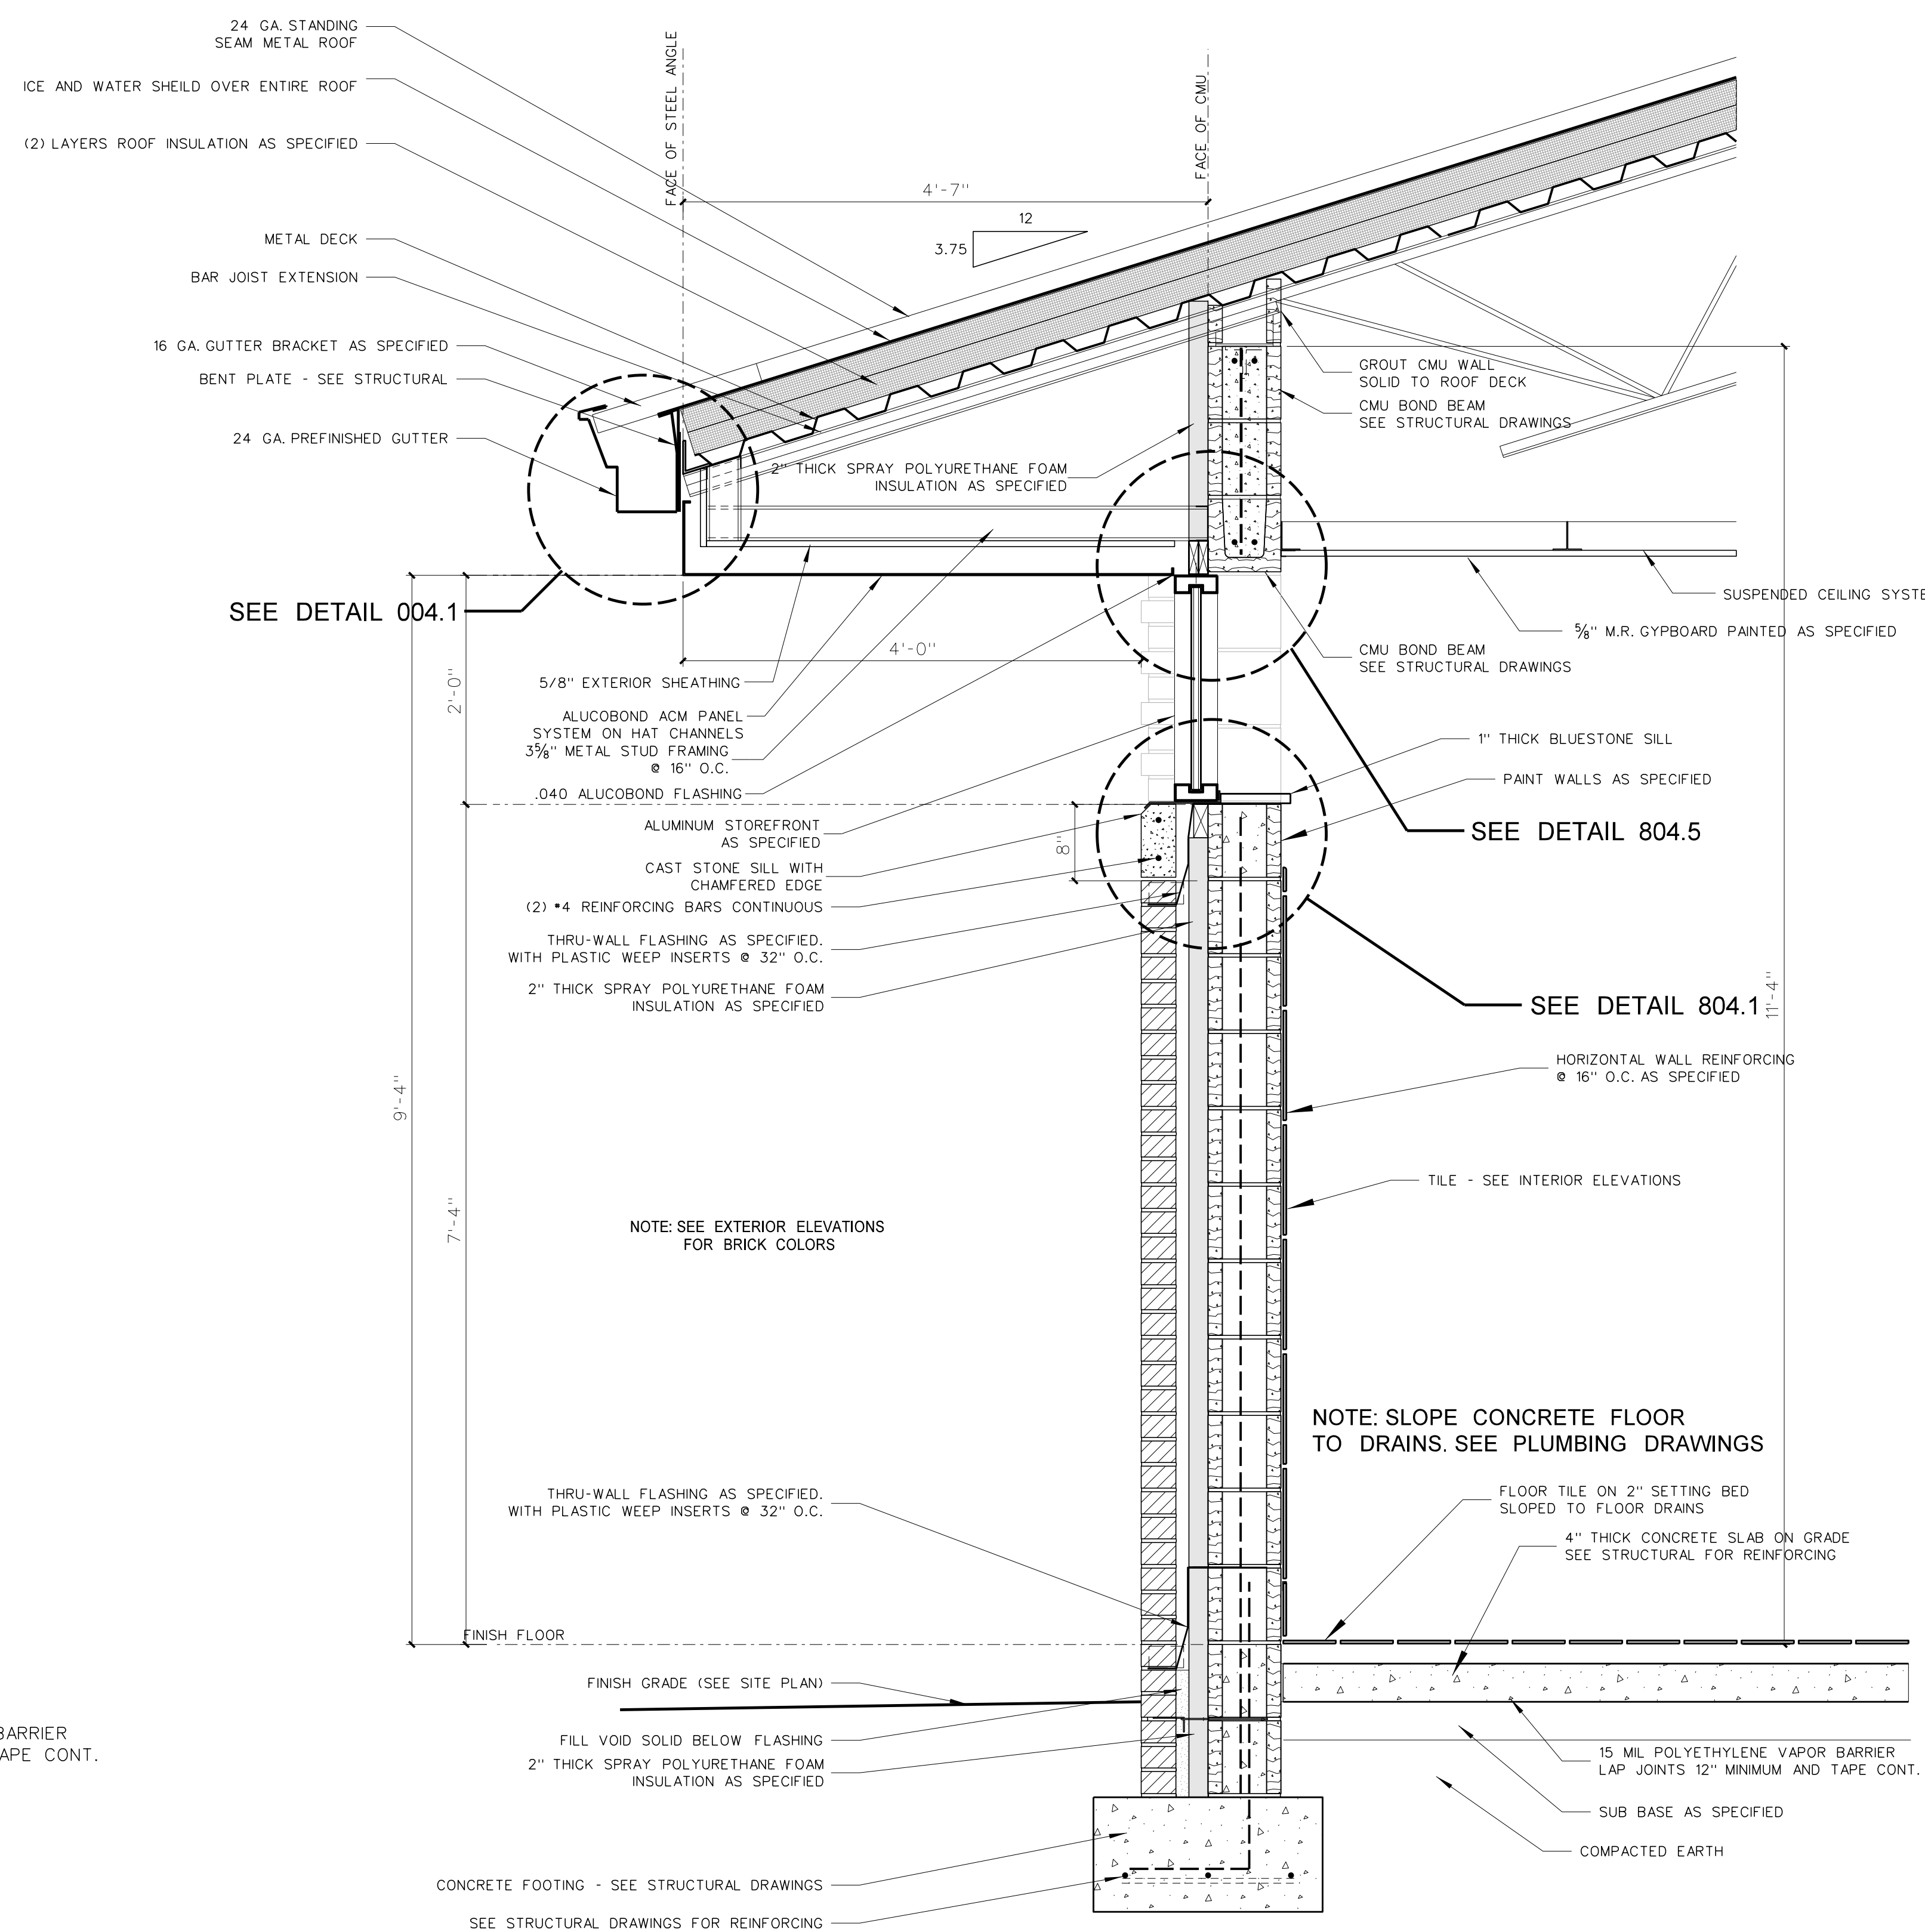

802.1 TYPICAL WALL SECTION @ STOREFRONT WINDOW
SCALE: 1" = 1'-0"

No.	Date	Revision


Hite associates
ARCHITECTURE / PLANNING / TECHNOLOGY
2600 Meridian Drive / Greenville, NC 27834 / tel (252) 757-0333



Beaufort PK-3 School
BEAUFORT COUNTY SCHOOLS
Washington / North Carolina / 727889

Project No. 22344
Date: 1 July 2024
Drawing No. **A 802**


- ### General Notes for Wall Sections
- (1) SEE EXTERIOR ELEVATIONS FOR BRICK COLOR.
 - (2) GENERAL CONTRACTOR SHALL VERIFY TOP OF FINISH GRADES, TOP OF CONCRETE WALKS AND TOP OF CONCRETE SLABS ADJACENT TO BUILDING AND ADJUST LOCATION OF THROUGH WALL FLASHING ACCORDINGLY.
 - (3) PROVIDE PLASTIC INSERT WEEPS AT ALL AT DOOR, WINDOW AND FLOOR FLASHING.
 - (4) GENERAL CONTRACTOR SHALL SLOPE CONCRETE FLOOR TO FLOOR DRAINS AS SHOWN ON PLUMBING DRAWINGS.
 - (5) ALL CMU CELLS BELOW FINISH FLOOR SHALL BE FILLED WITH CONCRETE.
 - (6) ALL VAPOR BARRIERS UNDER FLOOR SLABS SHALL BE LAPPED 12" MINIMUM AND TAPED CONTINUOUS AT JOINTS. GENERAL CONTRACTOR SHALL REPAIR ANY DAMAGED VAPOR BARRIER PRIOR TO PLACING CONCRETE.
 - (7) PROVIDE 4" MINIMUM SPRAY POLYURETHANE INSULATION IN ALL METAL STUDS EXTERIOR WALLS. SEE WALL SECTIONS AND SPECIFICATIONS.
 - (8) PROVIDE SPRAY POLYURETHANE INSULATION IN ALL NESTED METAL STUD WINDOW AND DOOR JAMBS, SILLS AND HEADS.
 - (9) ALL INTERIOR METAL STUD/GYPSUM WALLBOARD PARTITIONS REQUIRE SOUND ATTENUATION BATTS.
 - (10) PROVIDE METAL CHAIRS UNDER ALL STEEL WIRE MATS REINFORCING STEEL FOR CONCRETE SLABS AND FOUNDATIONS.
 - (11) PROVIDE GYPSUM CONTROL JOINTS AT ALL GYPSUM / METAL STUD WINDOW JAMBS. SEE INTERIOR ELEVATIONS.
 - (12) ALL SEALANT COLORS TO BE SELECTED BY ARCHITECT.
 - (13) ROOF INSULATION TAPE ALL ROOF INSULATION JOINTS, BOTH LAYER LAP AND TAPE VAPOR BARRIER. ARCHITECT TO FIELD VERIFY PRIOR TO METAL ROOF PANEL INSTALLATION.
 - (14) PROVIDE PRE-FORMED THRU-WALL FLASHING CORNER MEMBERS FOR EXTERIOR WALL CORNERS AS SPECIFIED.

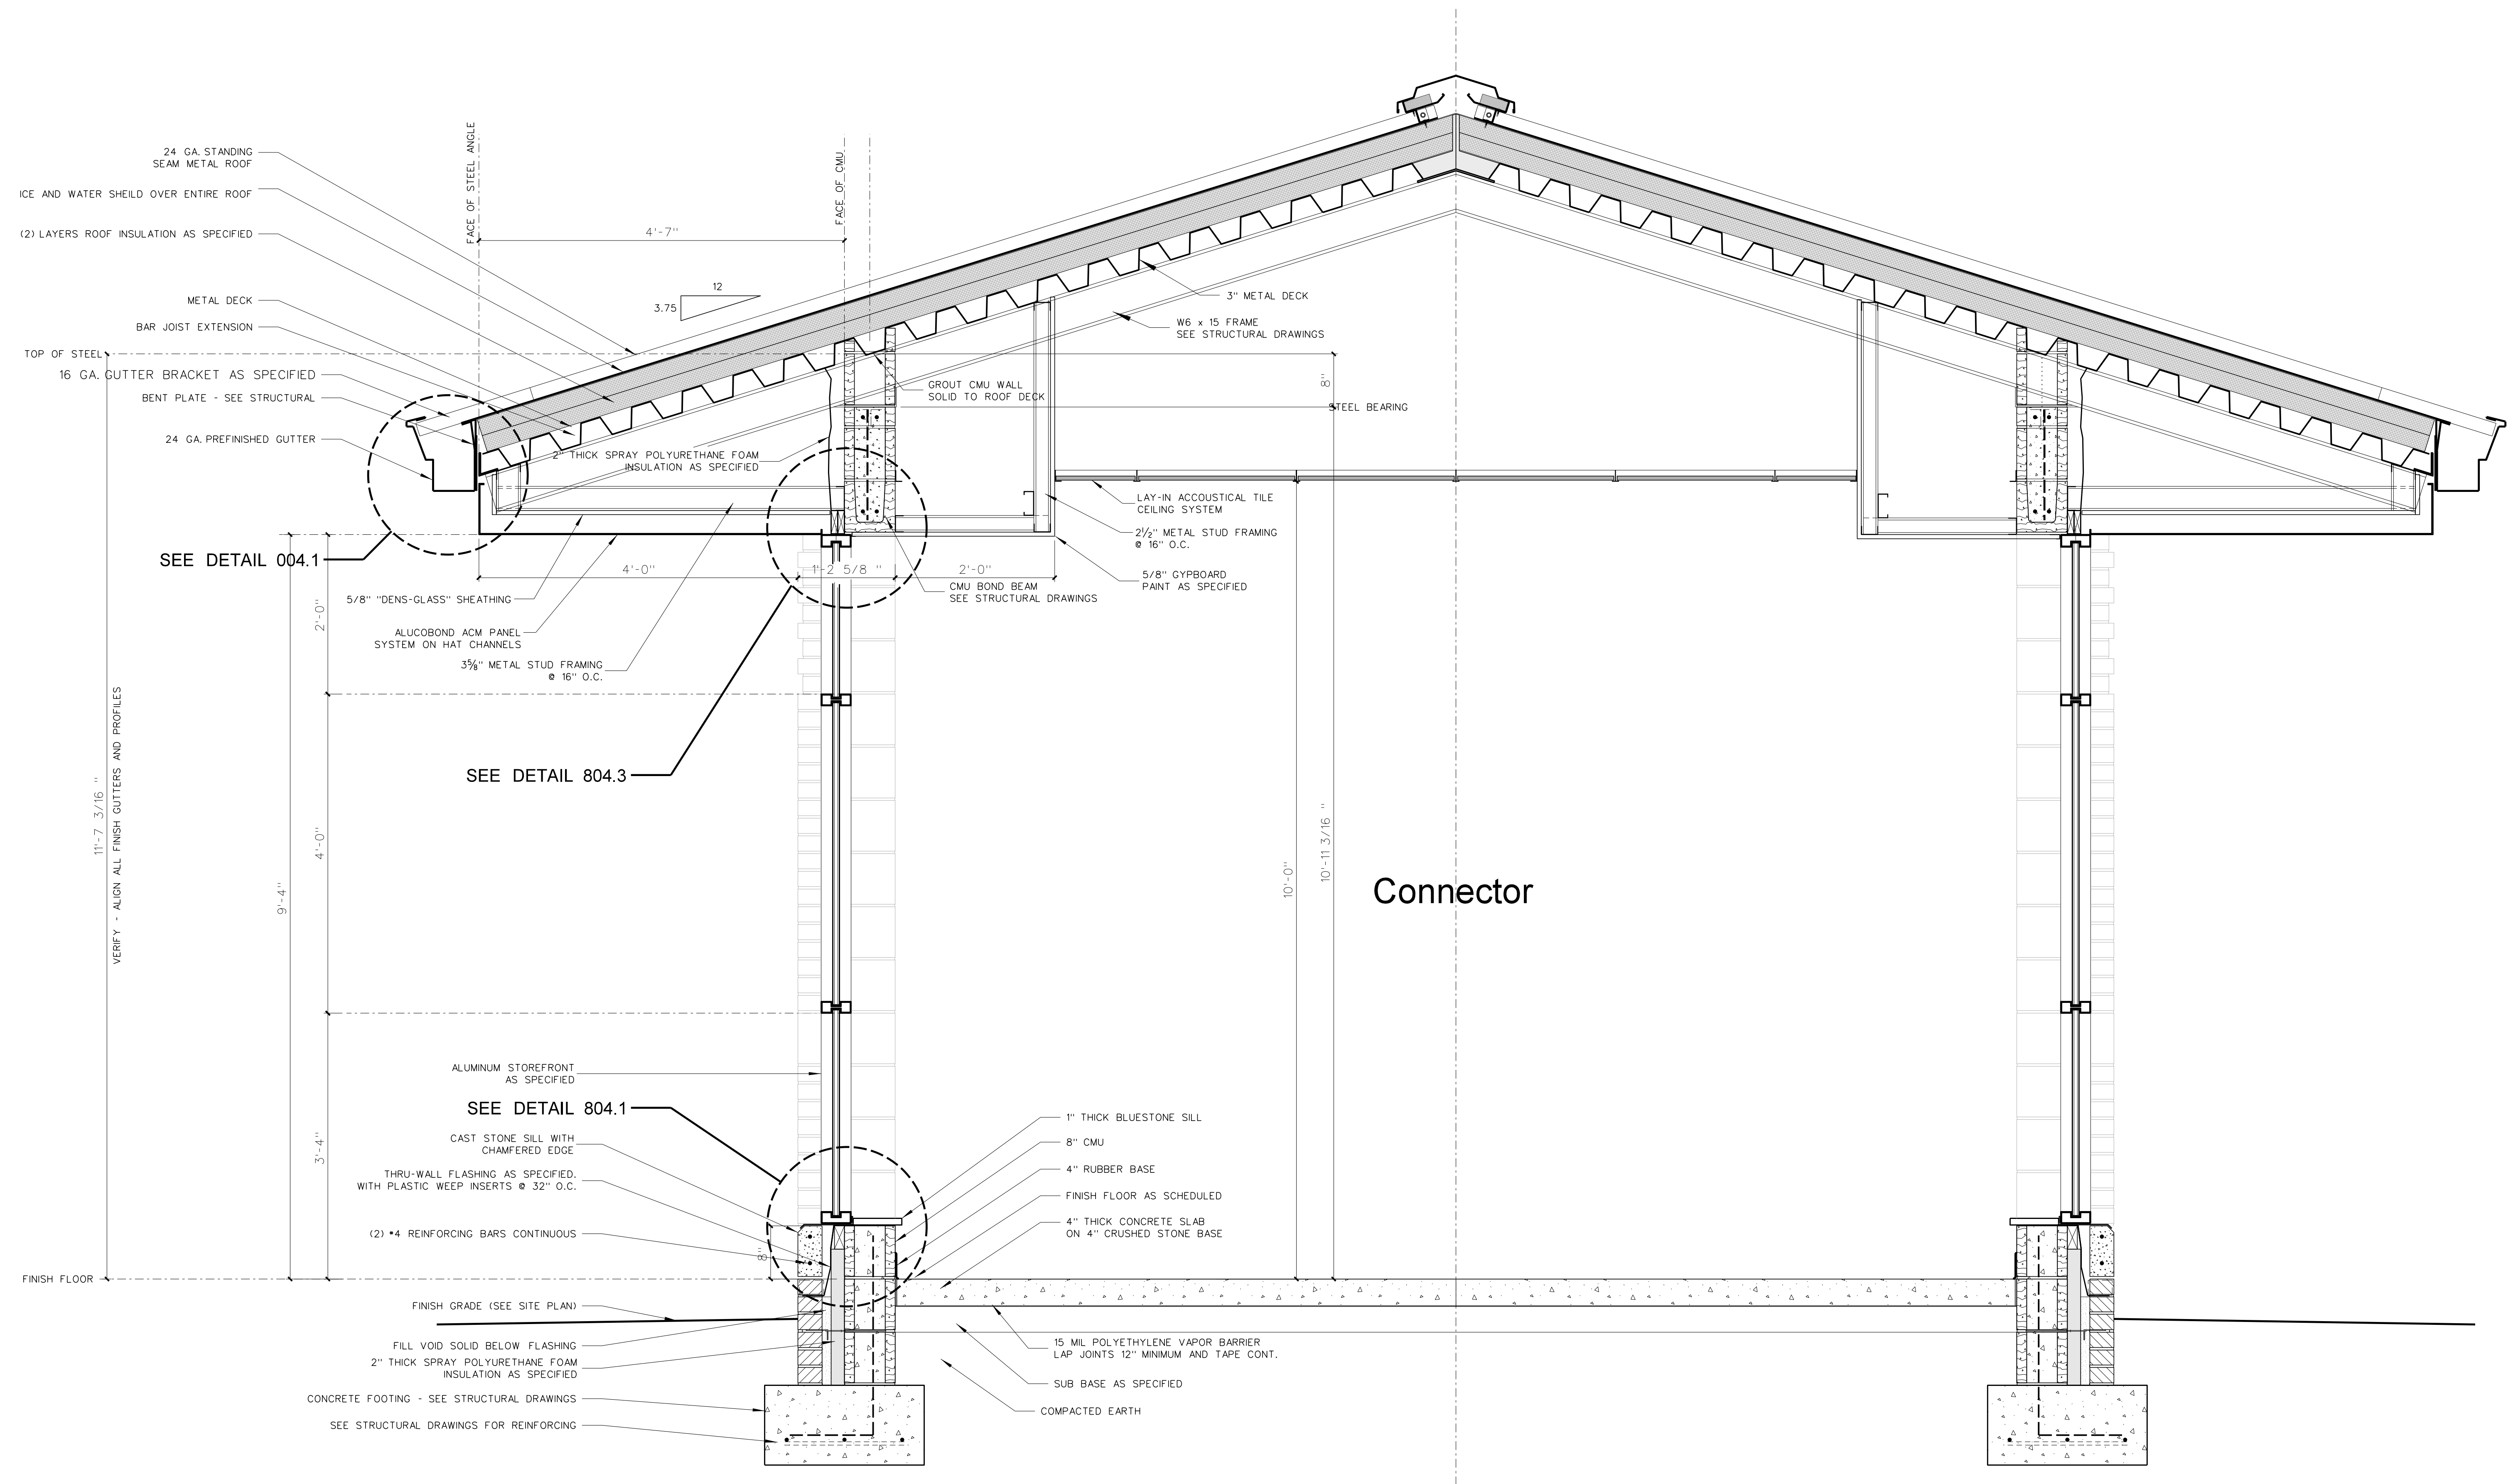

803.1 TYPICAL WALL SECTION - CONNECTOR
SCALE: 1" = 1'-0"


No.	Date	Revision

Hite associates
ARCHITECTURE / PLANNING / TECHNOLOGY
2600 Meridian Drive / Greenville, NC 27834 / tel (252) 757-0333

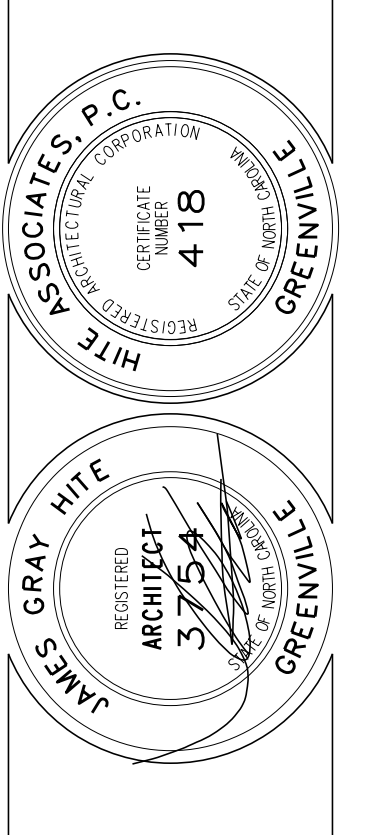

Beaufort PK-3 School
BEAUFORT COUNTY SCHOOLS
Washington / North Carolina / 27889



Project No.	22344
Date:	1 July 2024
Drawing no.	A 803

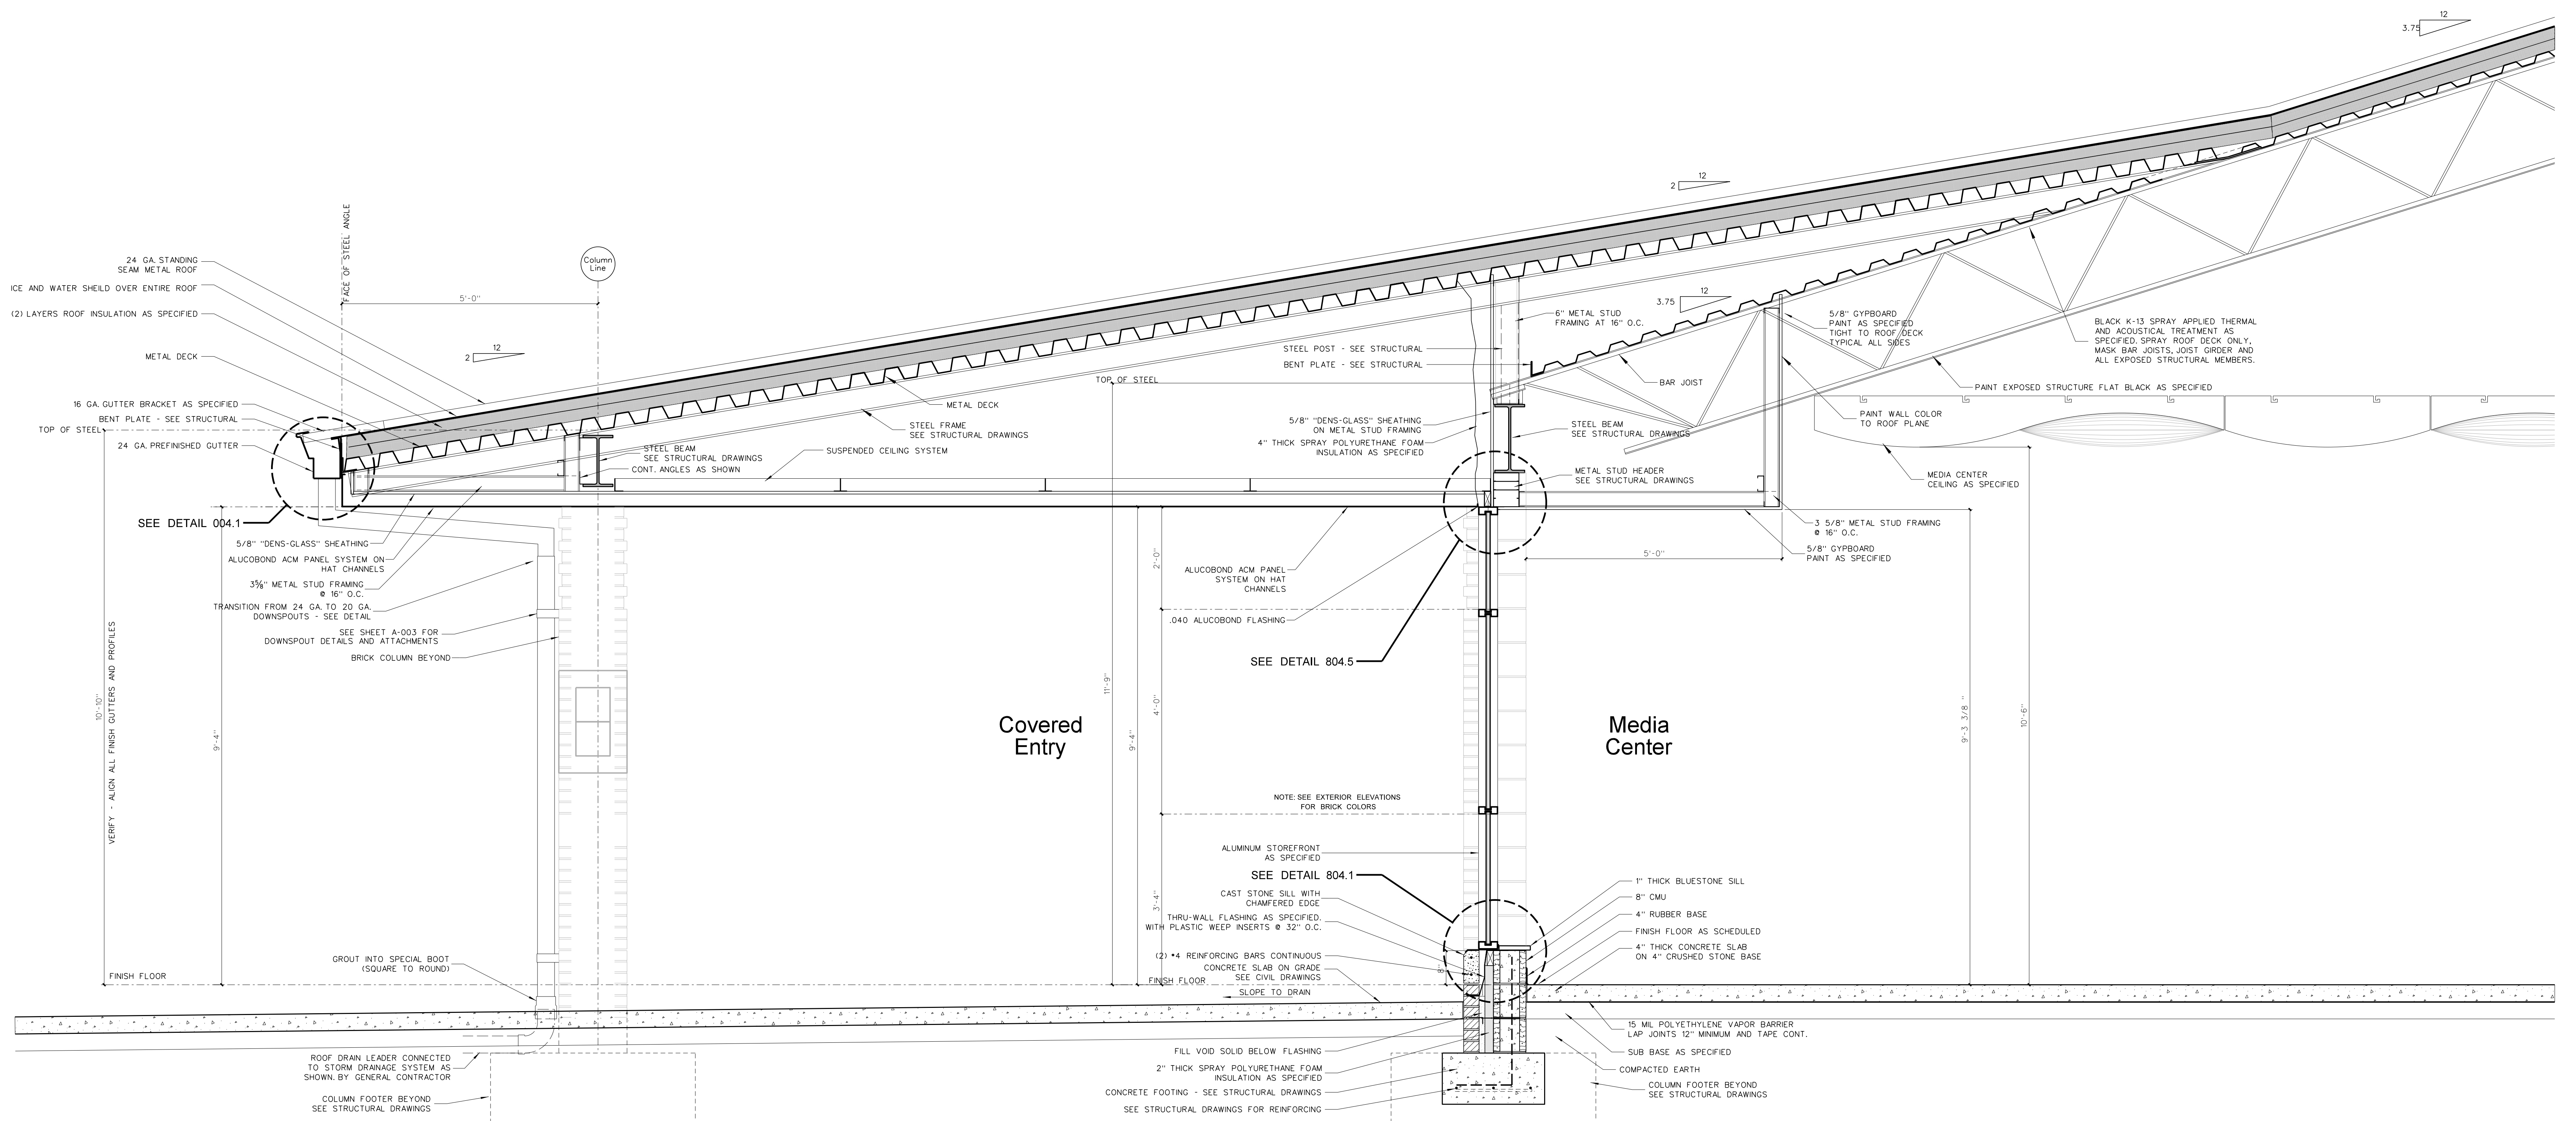

804.1 SECTION AT FRONT COVERED ENTRY
 SCALE: 3/4" = 1'-0"



No.	Date	Revision

Hite associates
 ARCHITECTURE / PLANNING / TECHNOLOGY
 2600 Meridian Drive / Greenville, NC 27834 / tel (252) 757-0333

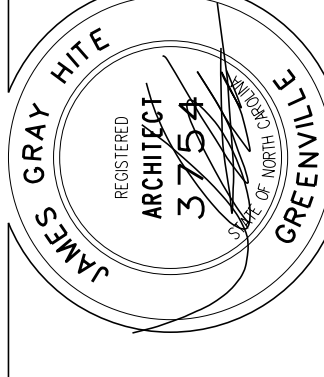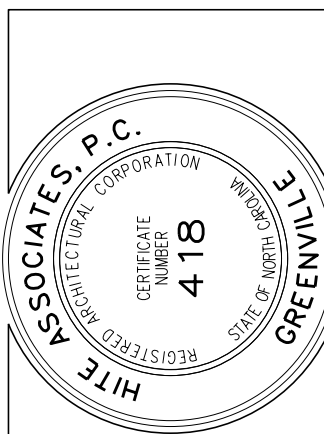

Beaufort PK-3 School
 BEAUFORT COUNTY SCHOOLS
 Washington / North Carolina / 27889

Project No.	22344
Date:	1 July 2024
Drawing No.	A 804

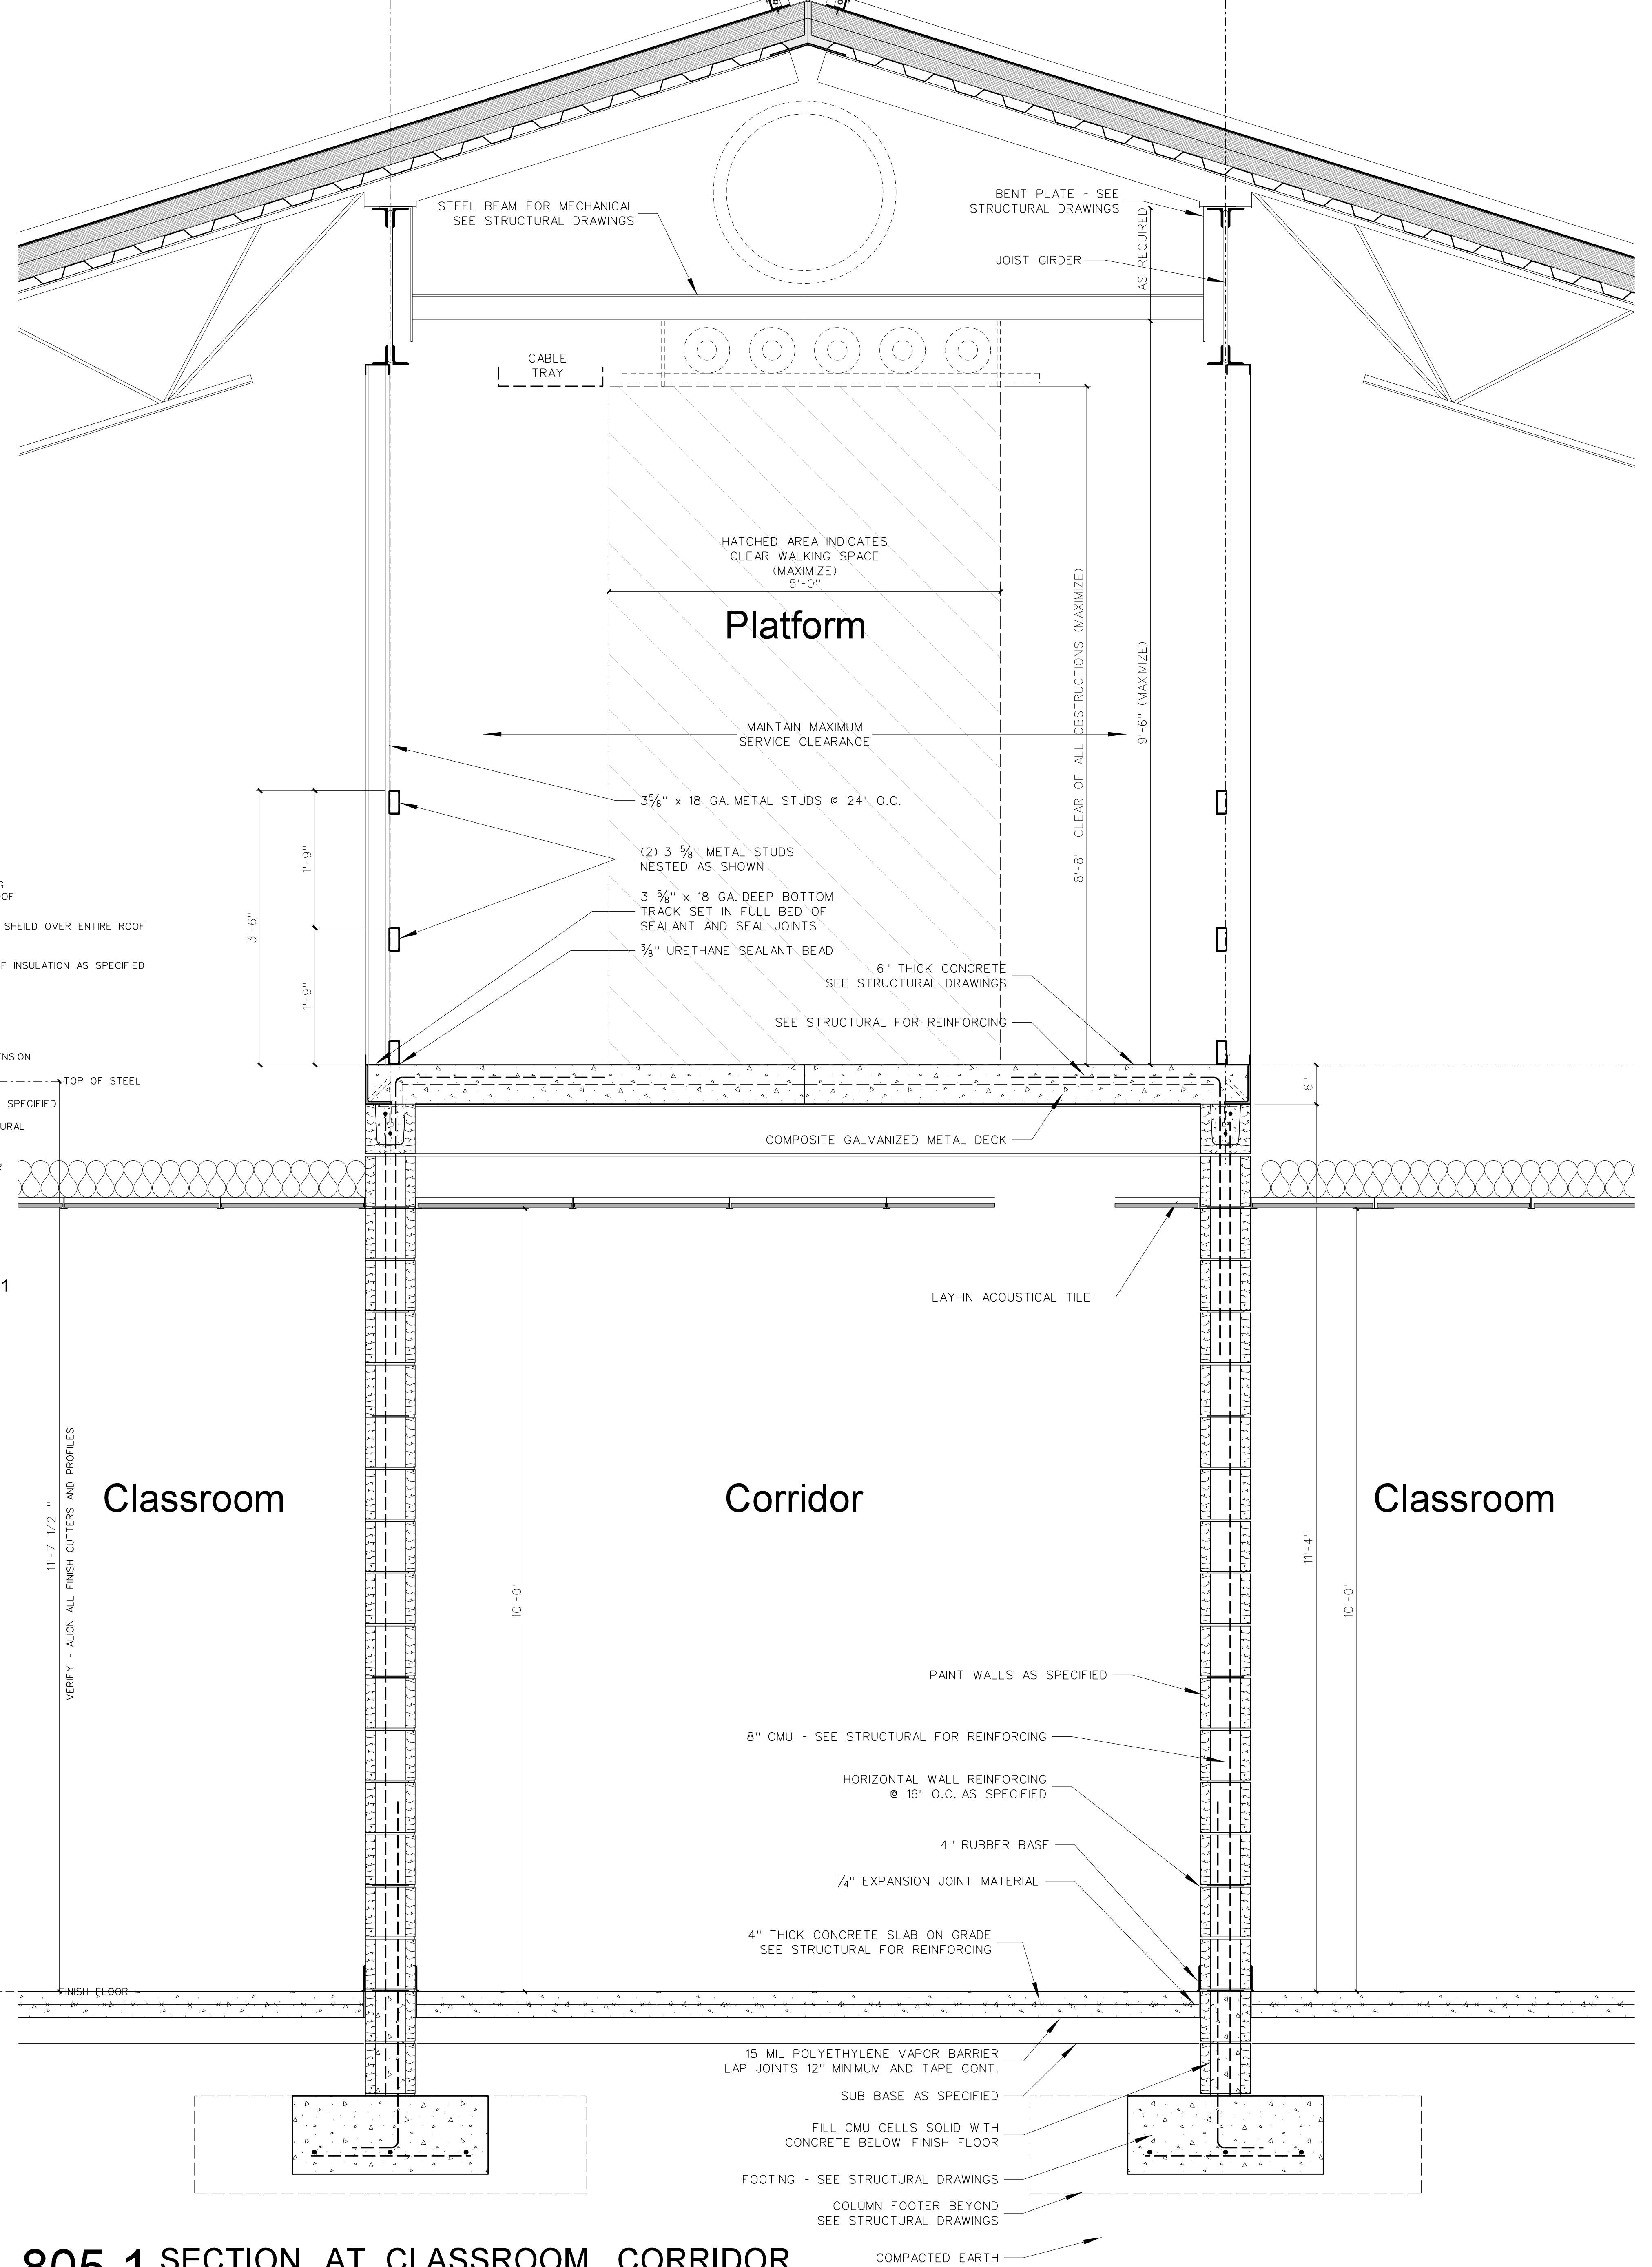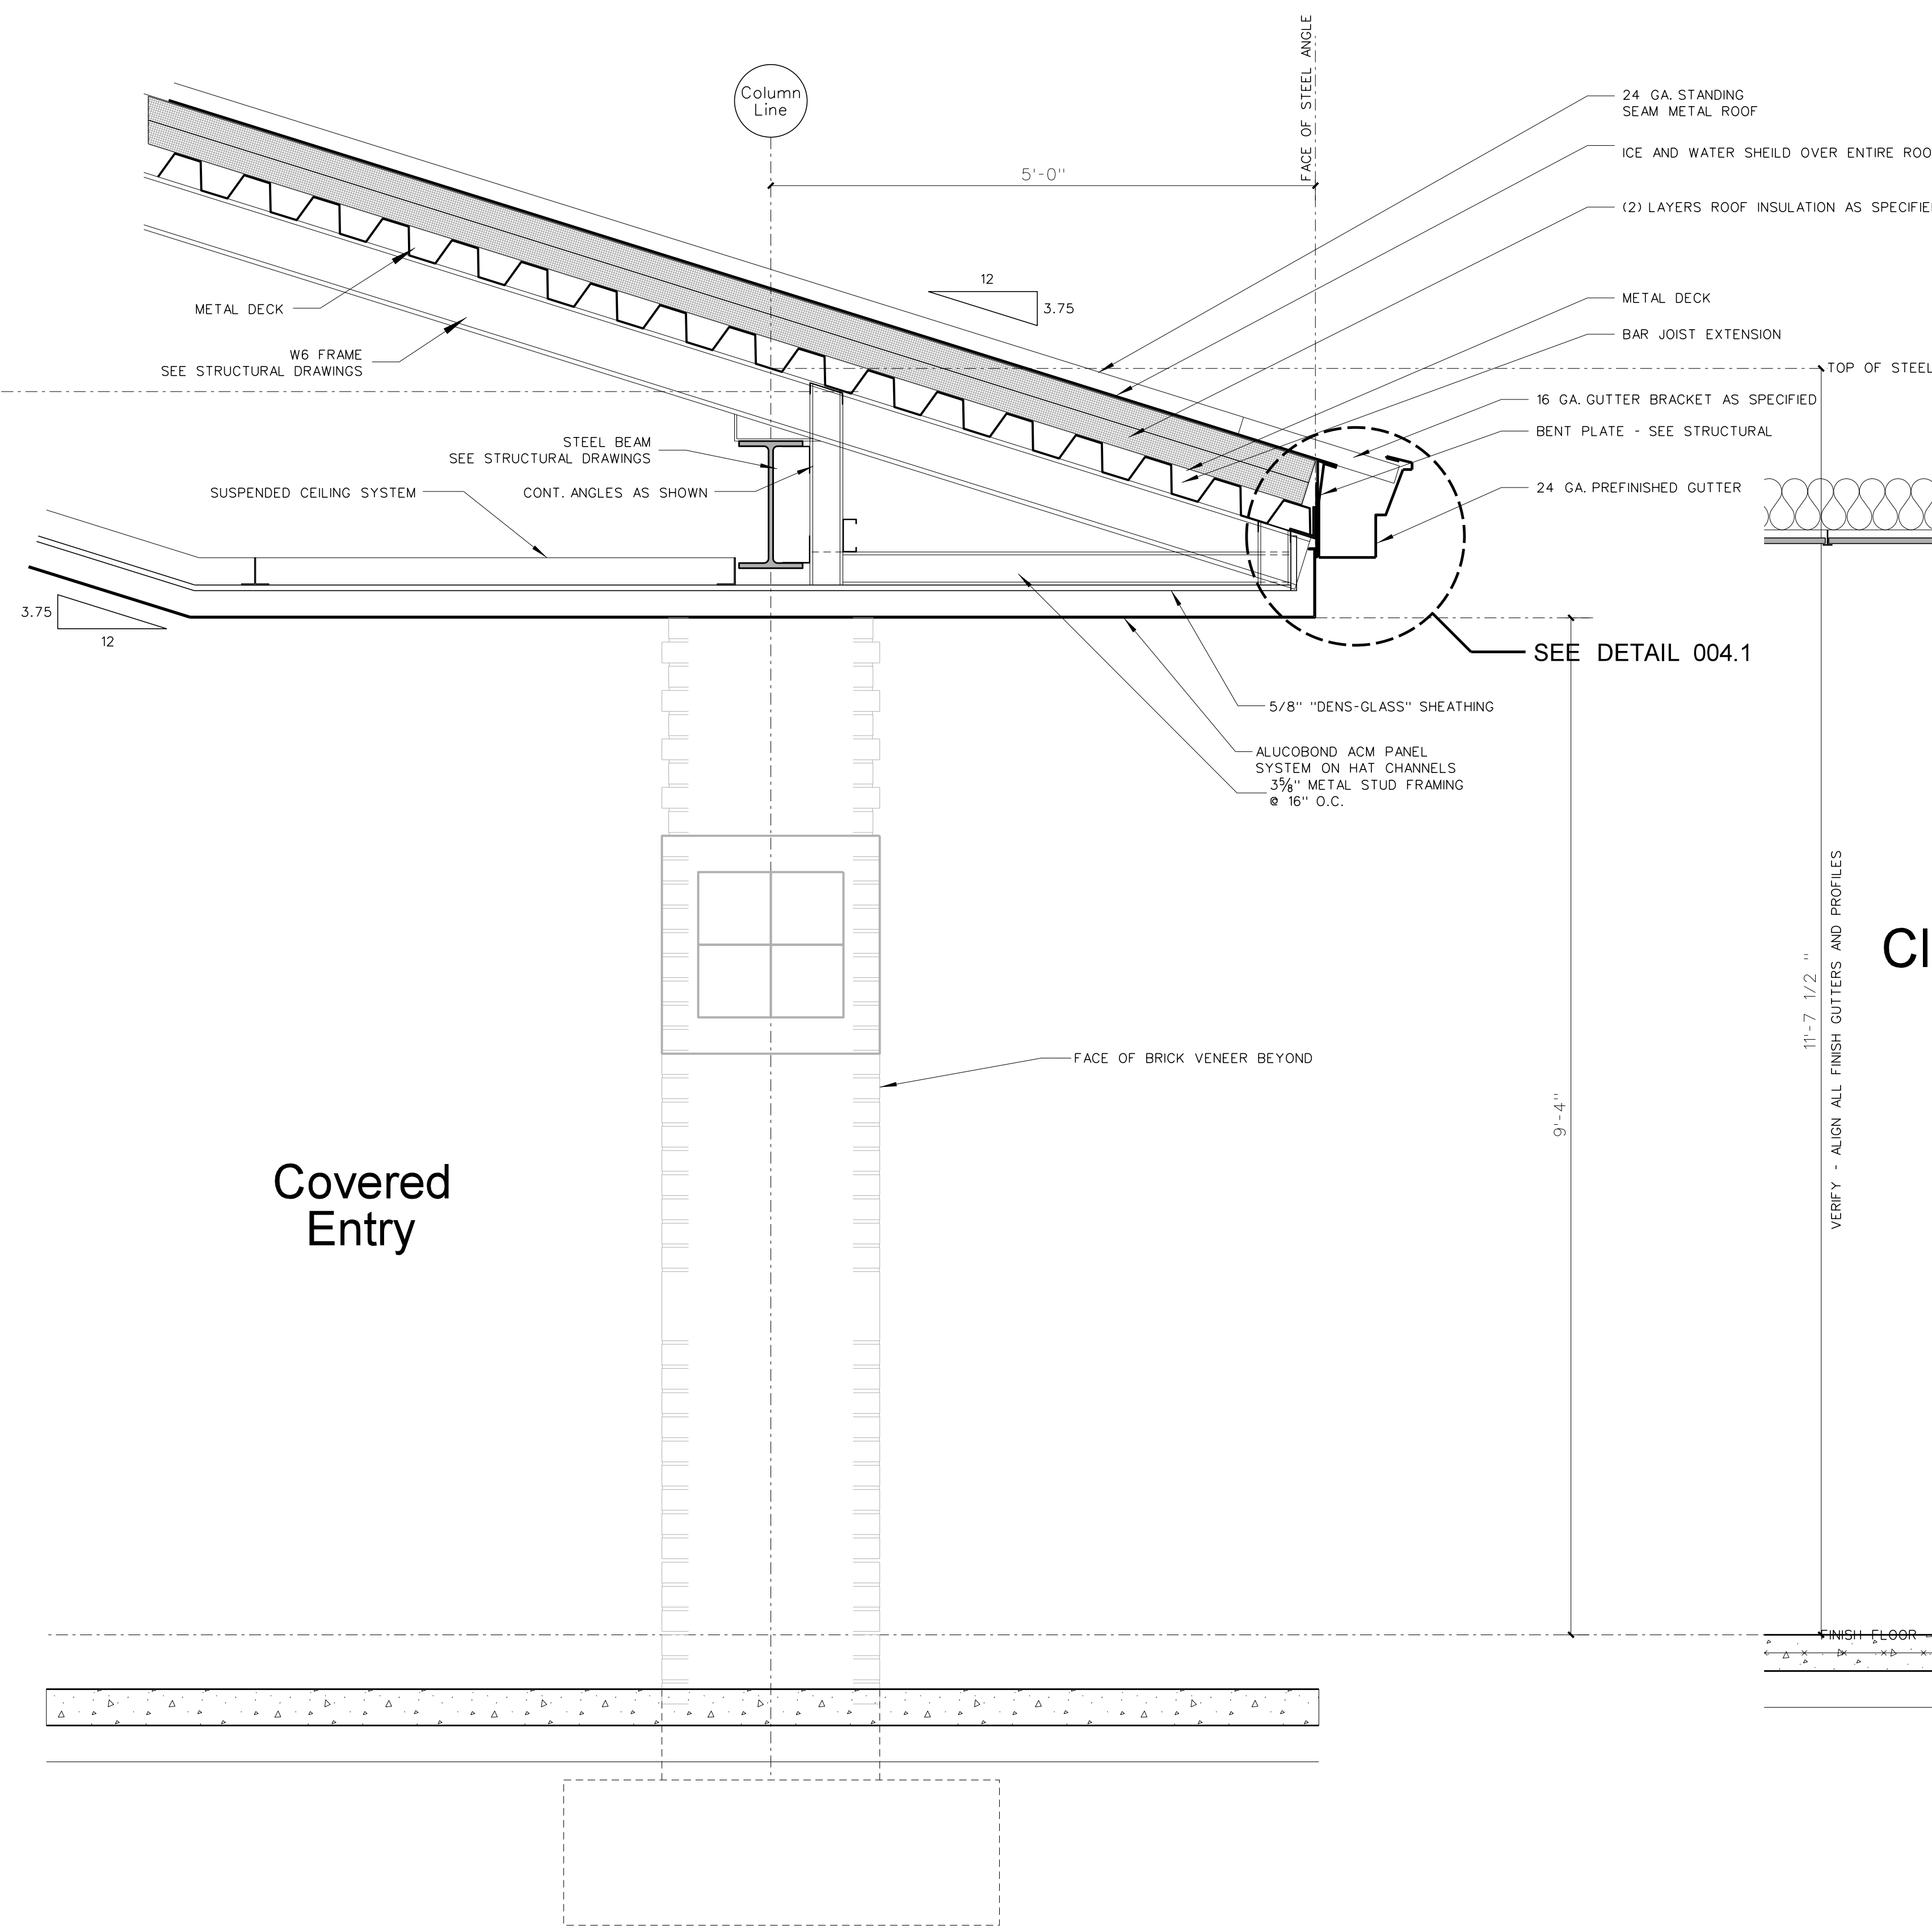


No.	Date	Revision

Hite associates
ARCHITECTURE / PLANNING / TECHNOLOGY
2600 Meridian Drive / Greenville, NC 27834 / tel (252) 757-0333



Beaufort PK-3 School
BEAUFORT COUNTY SCHOOLS
Washington / North Carolina / 27889

Project No. 22344
Date: 1 July 2024
Drawing no. **A 805**

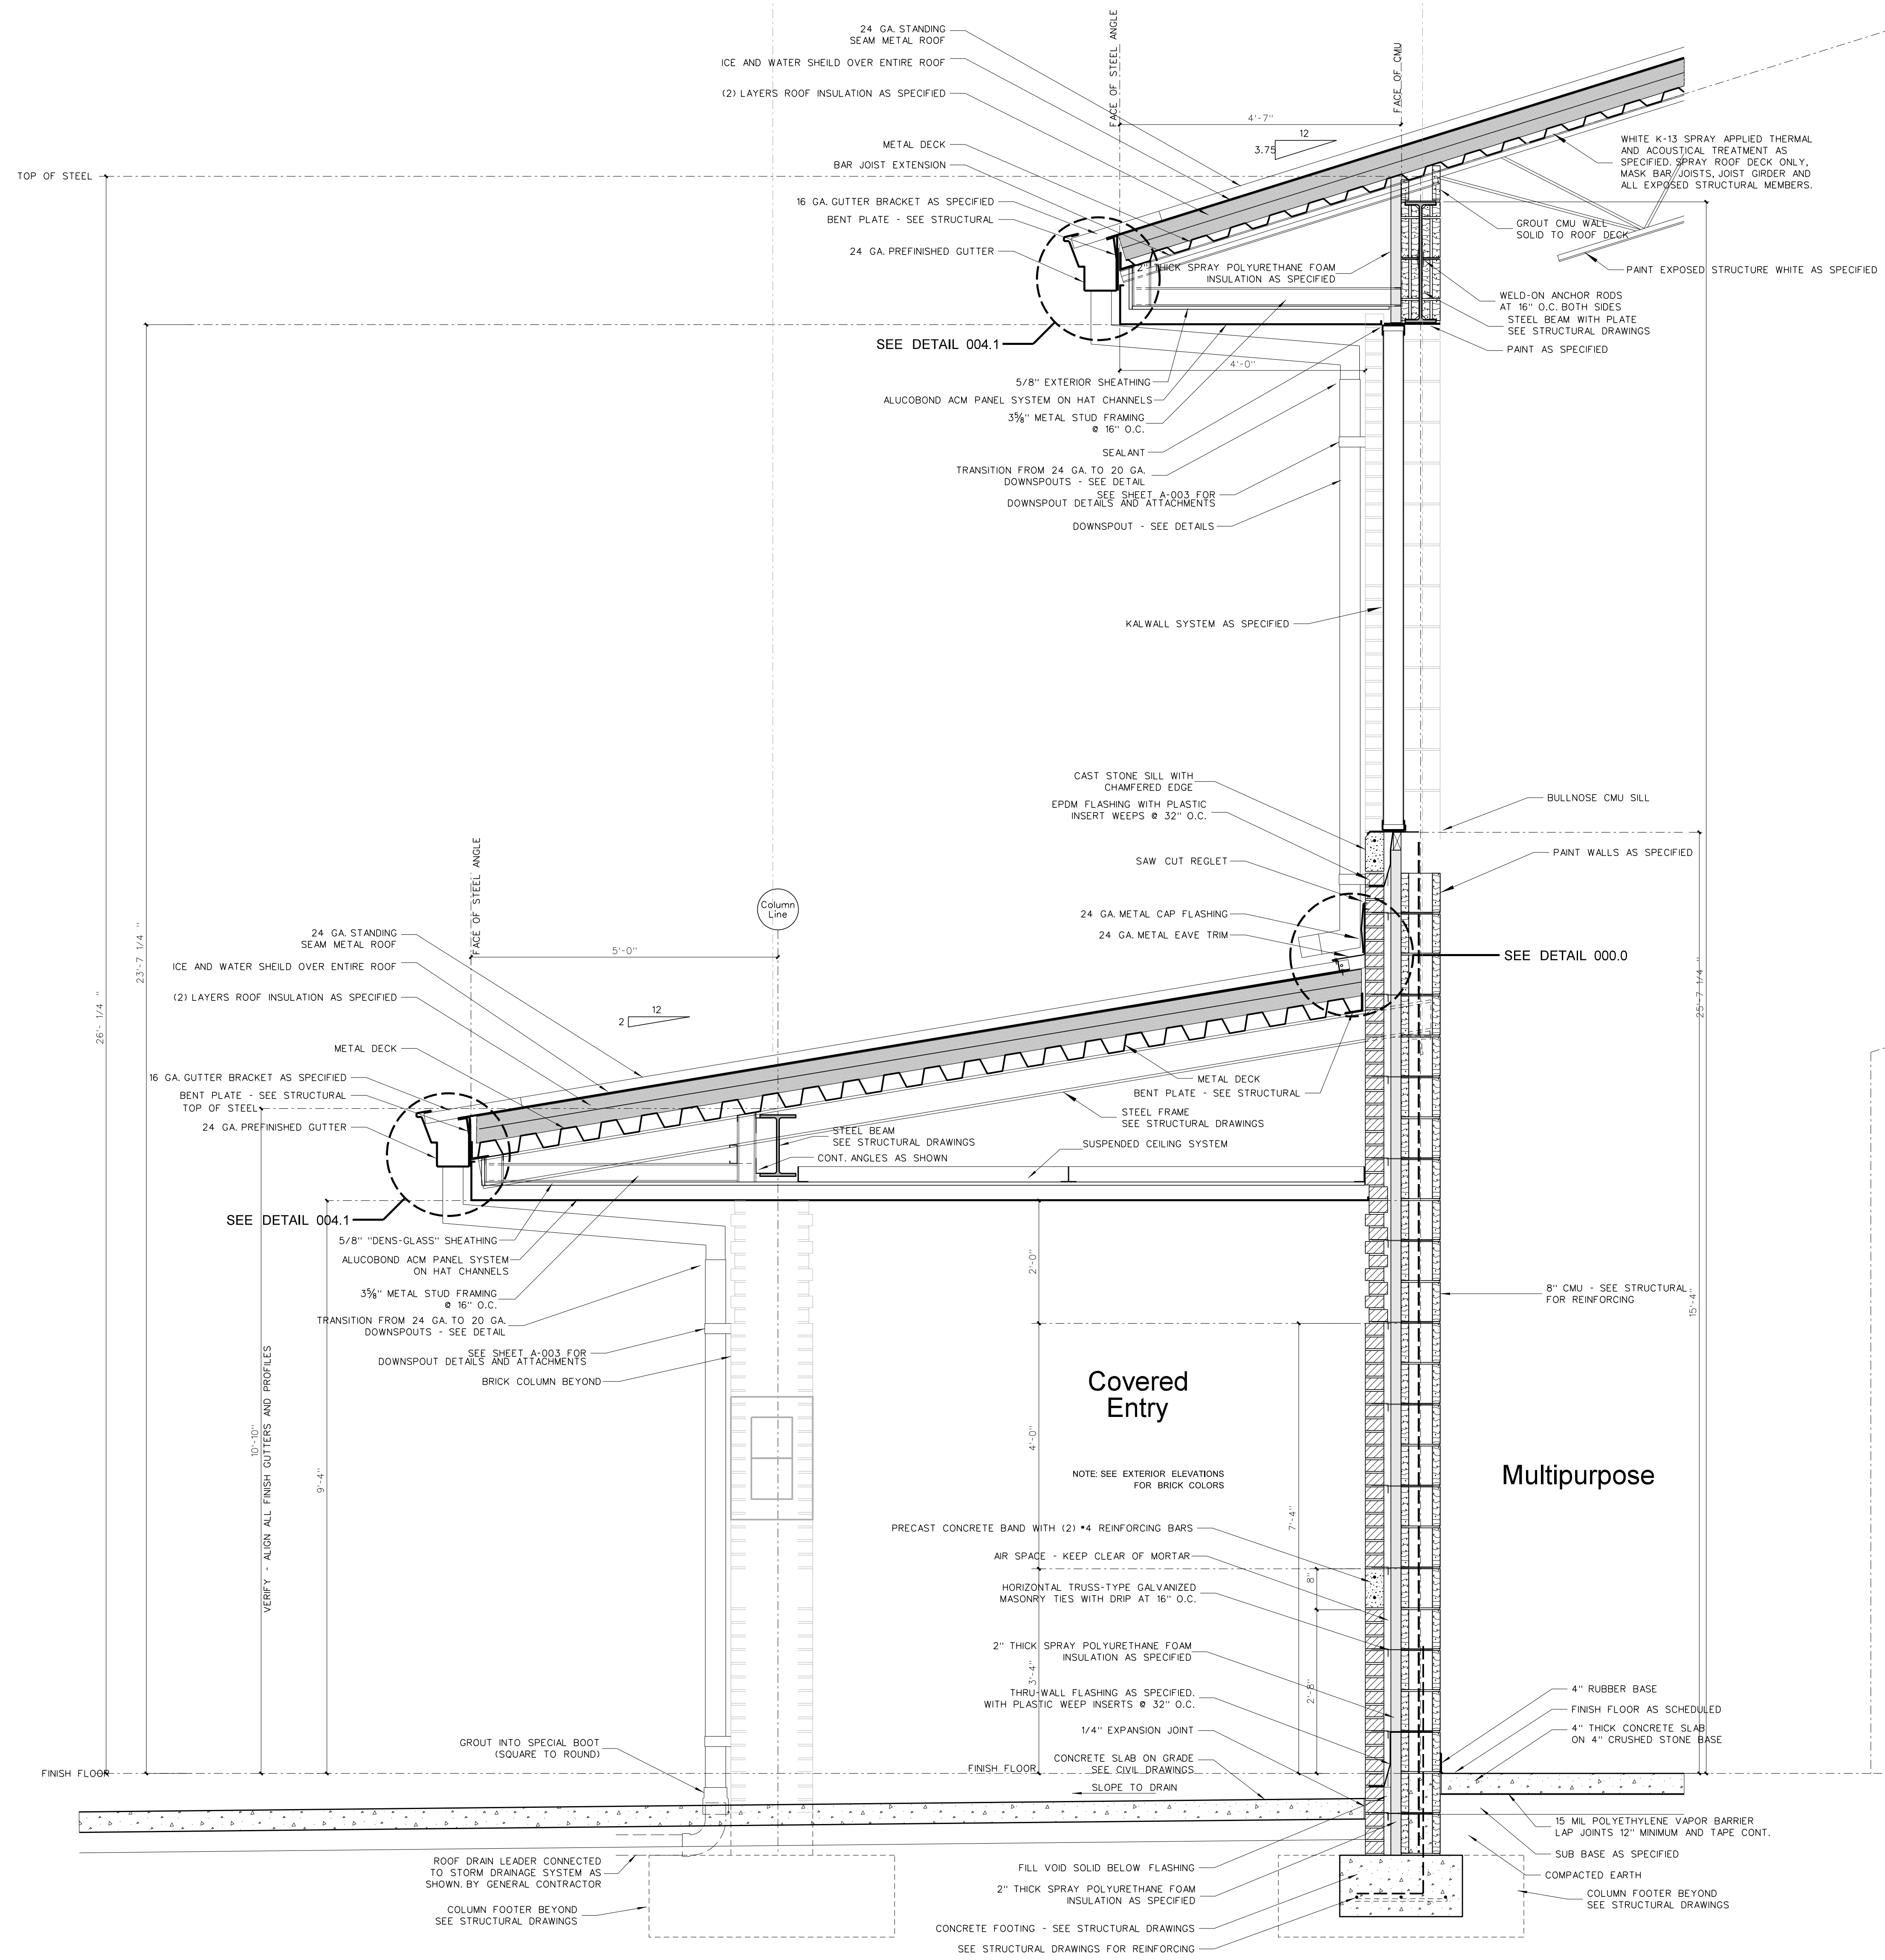

- ### General Notes for Wall Sections
- (1) SEE EXTERIOR ELEVATIONS FOR BRICK COLOR.
 - (2) GENERAL CONTRACTOR SHALL VERIFY TOP OF FINISH GRADES, TOP OF CONCRETE WALKS AND TOP OF CONCRETE SLABS ADJACENT TO BUILDING AND ADJUST LOCATION OF THROUGH WALL FLASHING ACCORDINGLY.
 - (3) PROVIDE PLASTIC INSERT WEEPS AT ALL AT DOOR, WINDOW AND FLOOR FLASHING.
 - (4) GENERAL CONTRACTOR SHALL SLOPE CONCRETE FLOOR TO FLOOR DRAINS AS SHOWN ON PLUMBING DRAWINGS.
 - (5) ALL CMU CELLS BELOW FINISH FLOOR SHALL BE FILLED WITH CONCRETE.
 - (6) ALL VAPOR BARRIERS UNDER FLOOR SLABS SHALL BE LAPPED 12" MINIMUM AND TIED CONTINUOUS AT JOINTS. GENERAL CONTRACTOR SHALL REPAIR ANY DAMAGED VAPOR BARRIER PRIOR TO PLACING CONCRETE.
 - (7) PROVIDE 4" MINIMUM SPRAY POLYURETHANE INSULATION IN ALL METAL STUDS EXTERIOR WALLS. SEE WALL SECTIONS AND SPECIFICATIONS.
 - (8) PROVIDE SPRAY POLYURETHANE INSULATION IN ALL NESTED METAL STUD WINDOW AND DOOR JAMBS, SILLS AND HEADS.
 - (9) ALL INTERIOR METAL STUD/GYPSUM WALLBOARD PARTITIONS REQUIRE SOUND ATTENUATION BATTS.
 - (10) PROVIDE METAL CHAIRS UNDER ALL STEEL WIRE MATS REINFORCING STEEL FOR CONCRETE SLABS AND FOUNDATIONS.
 - (11) PROVIDE GYPSUM CONTROL JOINTS AT ALL GYPSUM / METAL STUD WINDOW JAMBS. SEE INTERIOR ELEVATIONS.
 - (12) ALL SEALANT COLORS TO BE SELECTED BY ARCHITECT.
 - (13) ROOF INSULATION TAPE ALL ROOF INSULATION JOINTS, BOTH LAYER LAP AND TAPE VAPOR BARRIER. ARCHITECT TO FIELD VERIFY PRIOR TO METAL ROOF PANEL INSTALLATION.
 - (14) PROVIDE PRE-FORMED THRU-WALL FLASHING CORNER MEMBERS FOR EXTERIOR WALL CORNERS AS SPECIFIED.

806.1 SECTION AT FRONT COVERED ENTRY

SCALE: 3/4" = 1'-0"

No.	Date	Revision


Hite associates
 ARCHITECTURE / PLANNING / TECHNOLOGY
 2600 Meridian Drive / Greenville, NC 27834 / tel (252) 757-0333

REGISTERED ARCHITECT
 NUMBER 418
 STATE OF NORTH CAROLINA
 JAMES GRAY HITE
 REGISTERED ARCHITECT
 NUMBER 5755
 STATE OF NORTH CAROLINA

Beaufort PK-3 School
 BEAUFORT COUNTY SCHOOLS
 Washington / North Carolina / 27889

Project No. 22344
 Date: 1 July 2024
 Drawing no. **A 806**

- ### General Notes for Wall Sections
- (1) SEE EXTERIOR ELEVATIONS FOR BRICK COLOR.
 - (2) GENERAL CONTRACTOR SHALL VERIFY TOP OF FINISH GRADES, TOP OF CONCRETE WALKS AND TOP OF CONCRETE SLABS ADJACENT TO BUILDING AND ADJUST LOCATION OF THROUGH WALL FLASHING ACCORDINGLY.
 - (3) PROVIDE PLASTIC INSERT WEEPS AT ALL AT DOOR, WINDOW AND FLOOR FLASHING.
 - (4) GENERAL CONTRACTOR SHALL SLOPE CONCRETE FLOOR TO FLOOR DRAINS AS SHOWN ON PLUMBING DRAWINGS.
 - (5) ALL CMU CELLS BELOW FINISH FLOOR SHALL BE FILLED WITH CONCRETE.
 - (6) ALL VAPOR BARRIERS UNDER FLOOR SLABS SHALL BE LAPPED 12" MINIMUM AND TAPED CONTINUOUS AT JOINTS. GENERAL CONTRACTOR SHALL REPAIR ANY DAMAGED VAPOR BARRIER PRIOR TO PLACING CONCRETE.
 - (7) PROVIDE 4" MINIMUM SPRAY POLYURETHANE INSULATION IN ALL METAL STUDS EXTERIOR WALLS. SEE WALL SECTIONS AND SPECIFICATIONS.
 - (8) PROVIDE SPRAY POLYURETHANE INSULATION IN ALL NESTED METAL STUD WINDOW AND DOOR JAMBS, SILLS AND HEADS.
 - (9) ALL INTERIOR METAL STUD/GYPSUM WALLBOARD PARTITIONS REQUIRE SOUND ATTENUATION BATTS.
 - (10) PROVIDE METAL CHAIRS UNDER ALL STEEL WIRE MATS REINFORCING STEEL FOR CONCRETE SLABS AND FOUNDATIONS.
 - (11) PROVIDE GYPSUM CONTROL JOINTS AT ALL GYBOARD / METAL STUD WINDOW JAMBS. SEE INTERIOR ELEVATIONS.
 - (12) ALL SEALANT COLORS TO BE SELECTED BY ARCHITECT.
 - (13) ROOF INSULATION TAPE ALL ROOF INSULATION JOINTS, BOTH LAYS, LAP AND TAPE VAPOR BARRIER ARCHITECT TO FIELD VERIFY PRIOR TO METAL ROOF PANEL INSTALLATION.
 - (14) PROVIDE PRE-FORMED THRU-WALL FLASHING CORNER MEMBERS FOR EXTERIOR WALL CORNERS AS SPECIFIED.

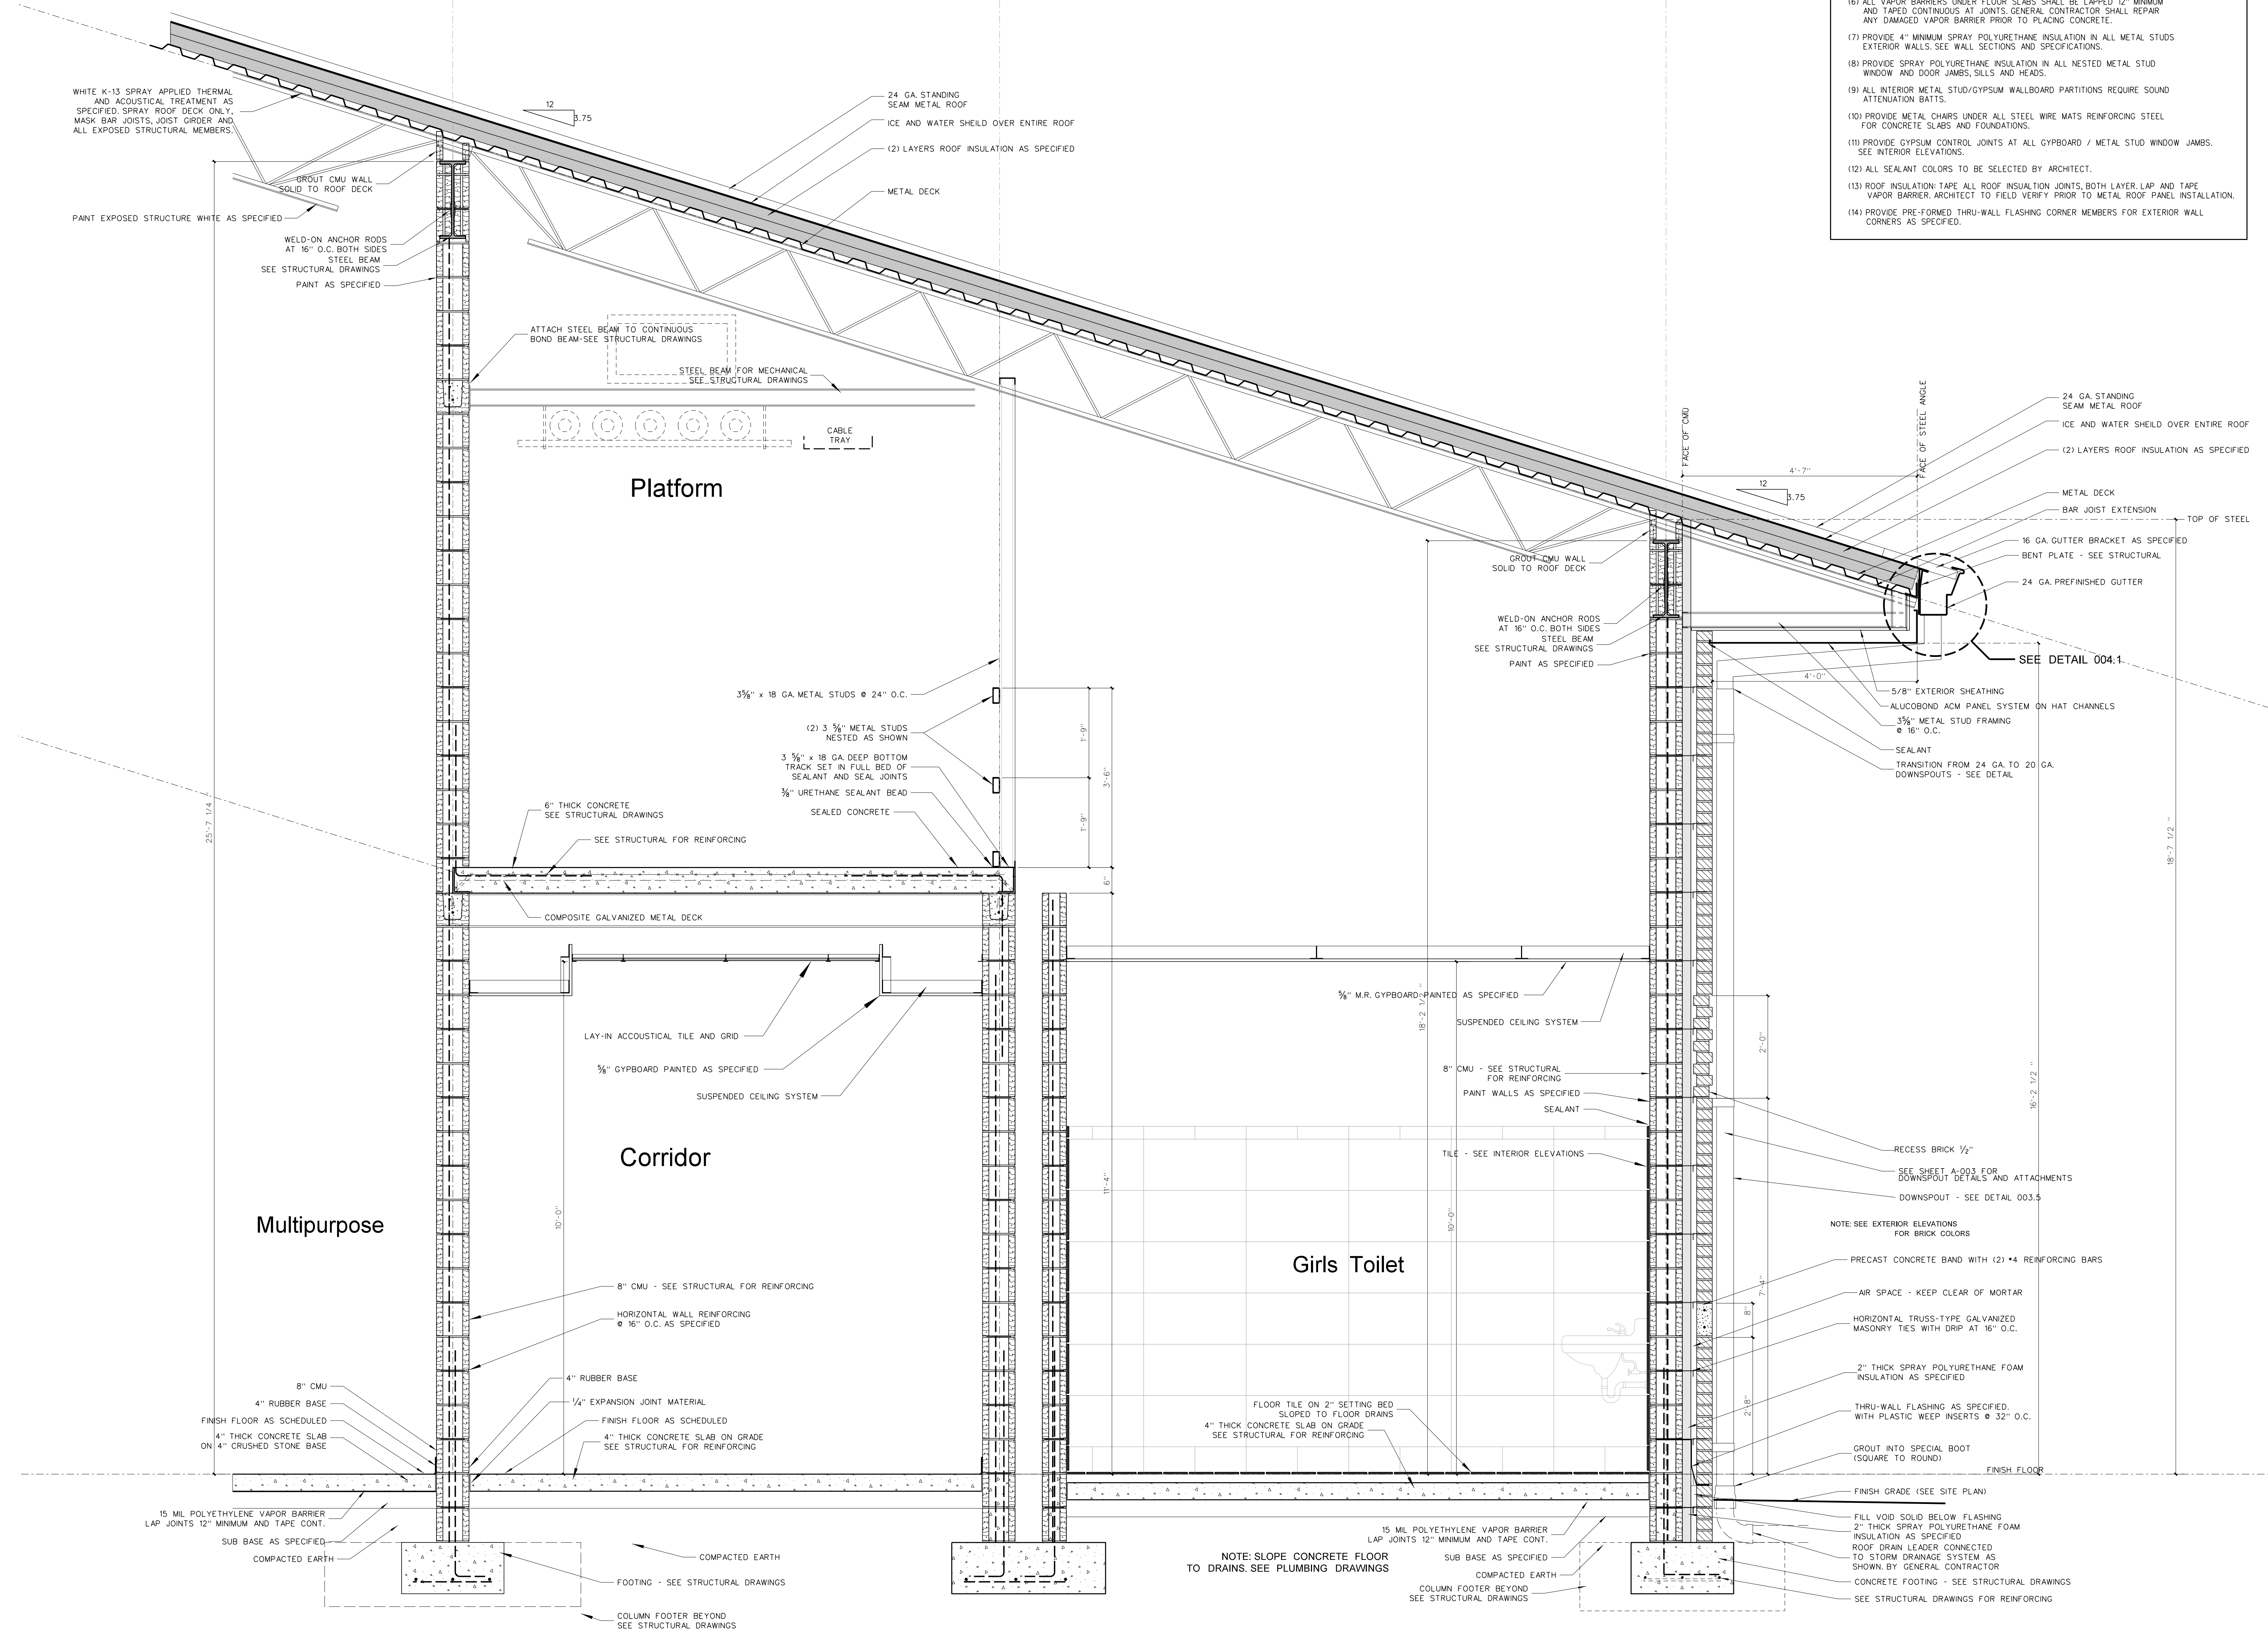


807.1 SECTION AT TOILETS

SCALE: 3/4" = 1'-0"


No.	Date	Revision

Hite associates
 ARCHITECTURE / PLANNING / TECHNOLOGY
 2600 Meridian Drive / Greenville, NC 27834 / tel (252) 757-0333

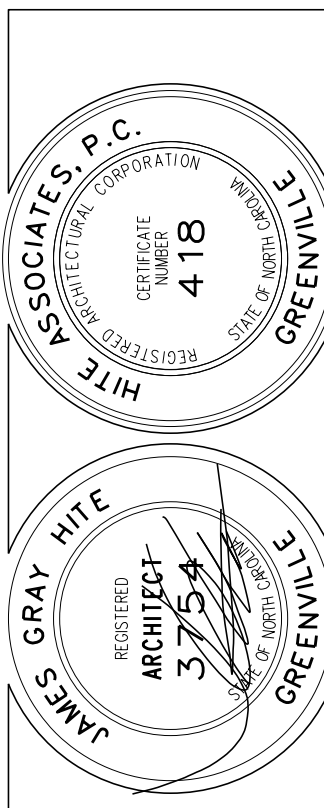

Beaufort PK-3 School
 BEAUFORT COUNTY SCHOOLS
 Washington / North Carolina / 727889

Project No. 22344
 Date: 1 July 2024
 Drawing no. **A 807**

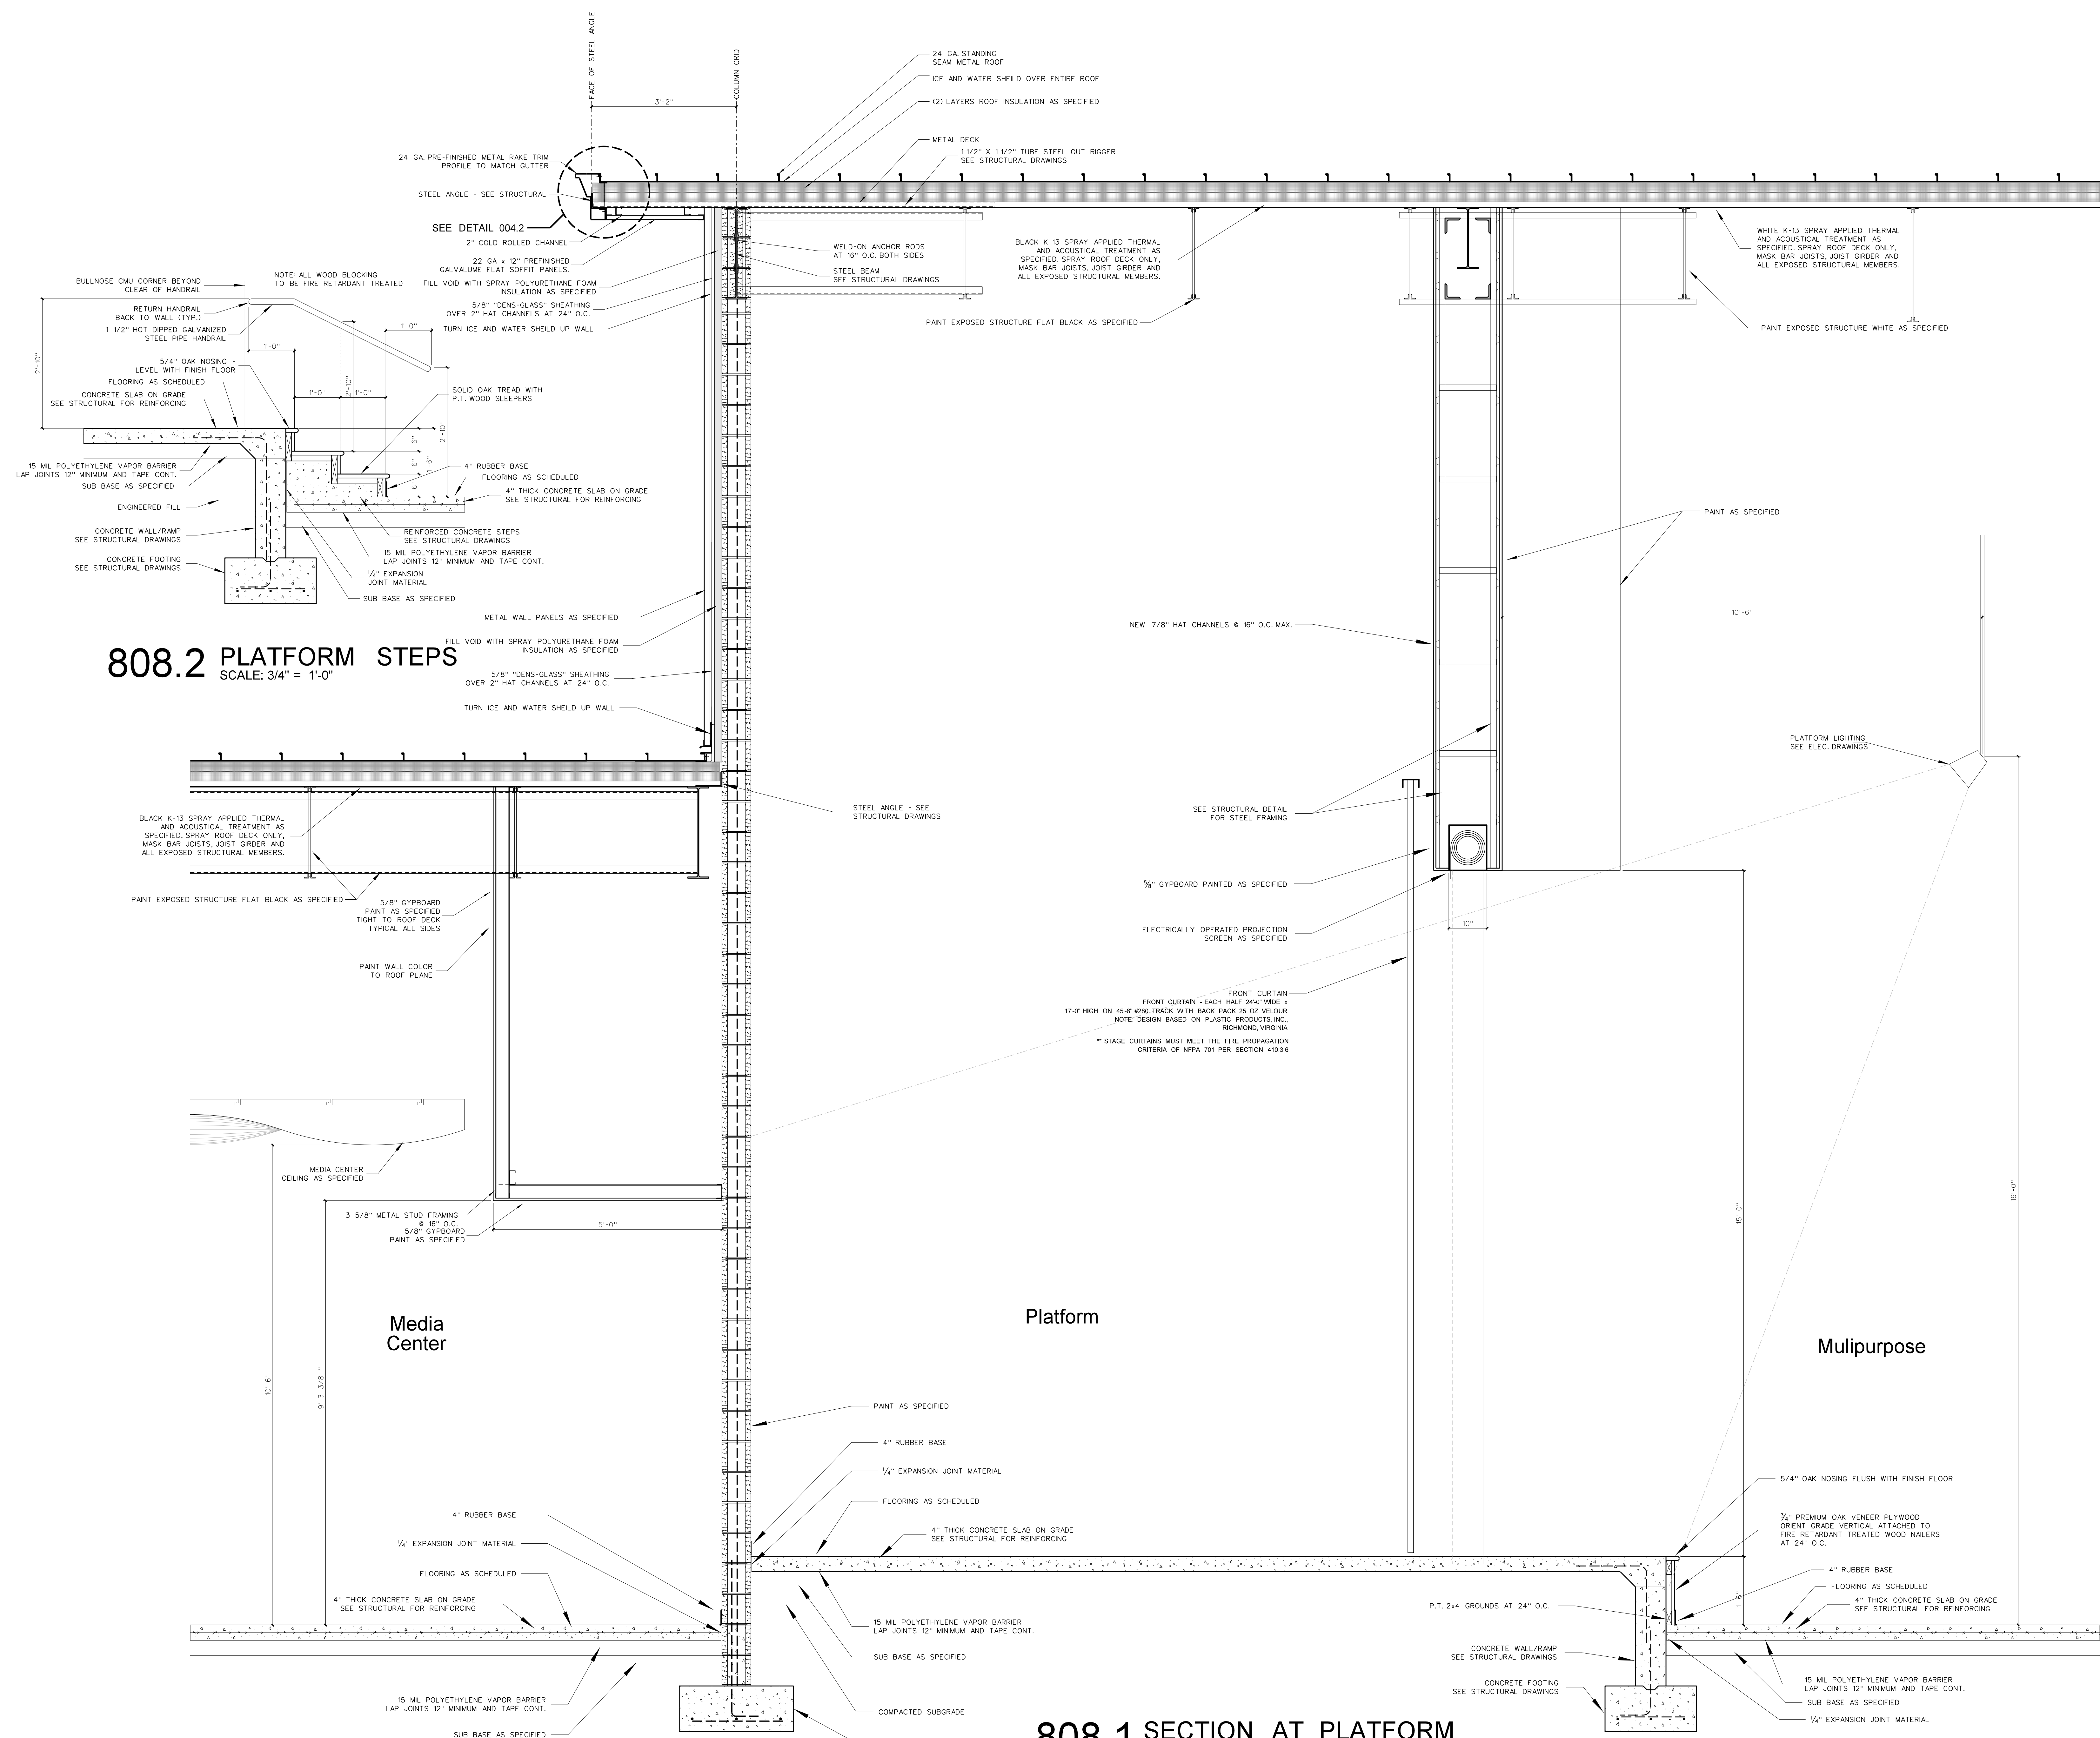

808.2 PLATFORM STEPS

SCALE: 3/4" = 1'-0"

808.1 SECTION AT PLATFORM

SCALE: 3/4" = 1'-0"


Media Center

Platform

Multipurpose

No.	Date	Revision


Hite associates
 ARCHITECTURE / PLANNING / TECHNOLOGY
 2600 Meridian Drive / Greenville, NC 27834 / tel: (252) 757-0333

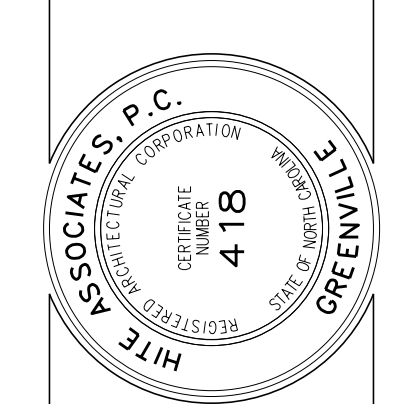


Beaufort PK-3 School
 BEAUFORT COUNTY SCHOOLS
 Washington / North Carolina / 27889

Project No. 22344
 Date: 1 July 2024
 Drawing no. **A 808**

- (1) SEE EXTERIOR ELEVATIONS FOR BRICK COLOR.
- (2) GENERAL CONTRACTOR SHALL VERIFY TOP OF FINISH GRADES, TOP OF CONCRETE WALKS AND TOP OF CONCRETE SLABS ADJACENT TO BUILDING AND ADJUST LOCATION OF THROUGH WALL FLASHING ACCORDINGLY.
- (3) PROVIDE PLASTIC INSERT WEEPS AT ALL AT DOOR, WINDOW AND FLOOR FLASHING.
- (4) GENERAL CONTRACTOR SHALL SLOPE CONCRETE FLOOR TO FLOOR DRAINS AS SHOWN ON PLUMBING DRAWINGS.
- (5) ALL CMU CELLS BELOW FINISH FLOOR SHALL BE FILLED WITH CONCRETE.
- (6) ALL VAPOR BARRIERS UNDER FLOOR SLABS SHALL BE LAPPED 12" MINIMUM AND TAPED CONTINUOUS AT JOINTS. GENERAL CONTRACTOR SHALL REPAIR ANY DAMAGED VAPOR BARRIER PRIOR TO PLACING CONCRETE.
- (7) PROVIDE 4" MINIMUM SPRAY POLYURETHANE INSULATION IN ALL METAL STUDS EXTERIOR WALLS. SEE WALL SECTIONS AND SPECIFICATIONS.
- (8) PROVIDE SPRAY POLYURETHANE INSULATION IN ALL NESTED METAL STUD WINDOW AND DOOR JAMBS, SILLS AND HEADS.
- (9) ALL INTERIOR METAL STUD/GYPSUM WALLBOARD PARTITIONS REQUIRE SOUND ATTENUATION BATTS.
- (10) PROVIDE METAL CHAIRS UNDER ALL STEEL WIRE MATS REINFORCING STEEL FOR CONCRETE SLABS AND FOUNDATIONS.
- (11) PROVIDE GYPSUM CONTROL JOINTS AT ALL GYPBOARD / METAL STUD WINDOW JAMBS. SEE INTERIOR ELEVATIONS.
- (12) ALL SEALANT COLORS TO BE SELECTED BY ARCHITECT.
- (13) ROOF INSULATION TAPE ALL ROOF INSULATION JOINTS, BOTH LAYER, LAP AND TAPE VAPOR BARRIER. ARCHITECT TO FIELD VERIFY PRIOR TO METAL ROOF PANEL INSTALLATION.
- (14) PROVIDE PRE-FORMED THRU-WALL FLASHING CORNER MEMBERS FOR EXTERIOR WALL CORNERS AS SPECIFIED.

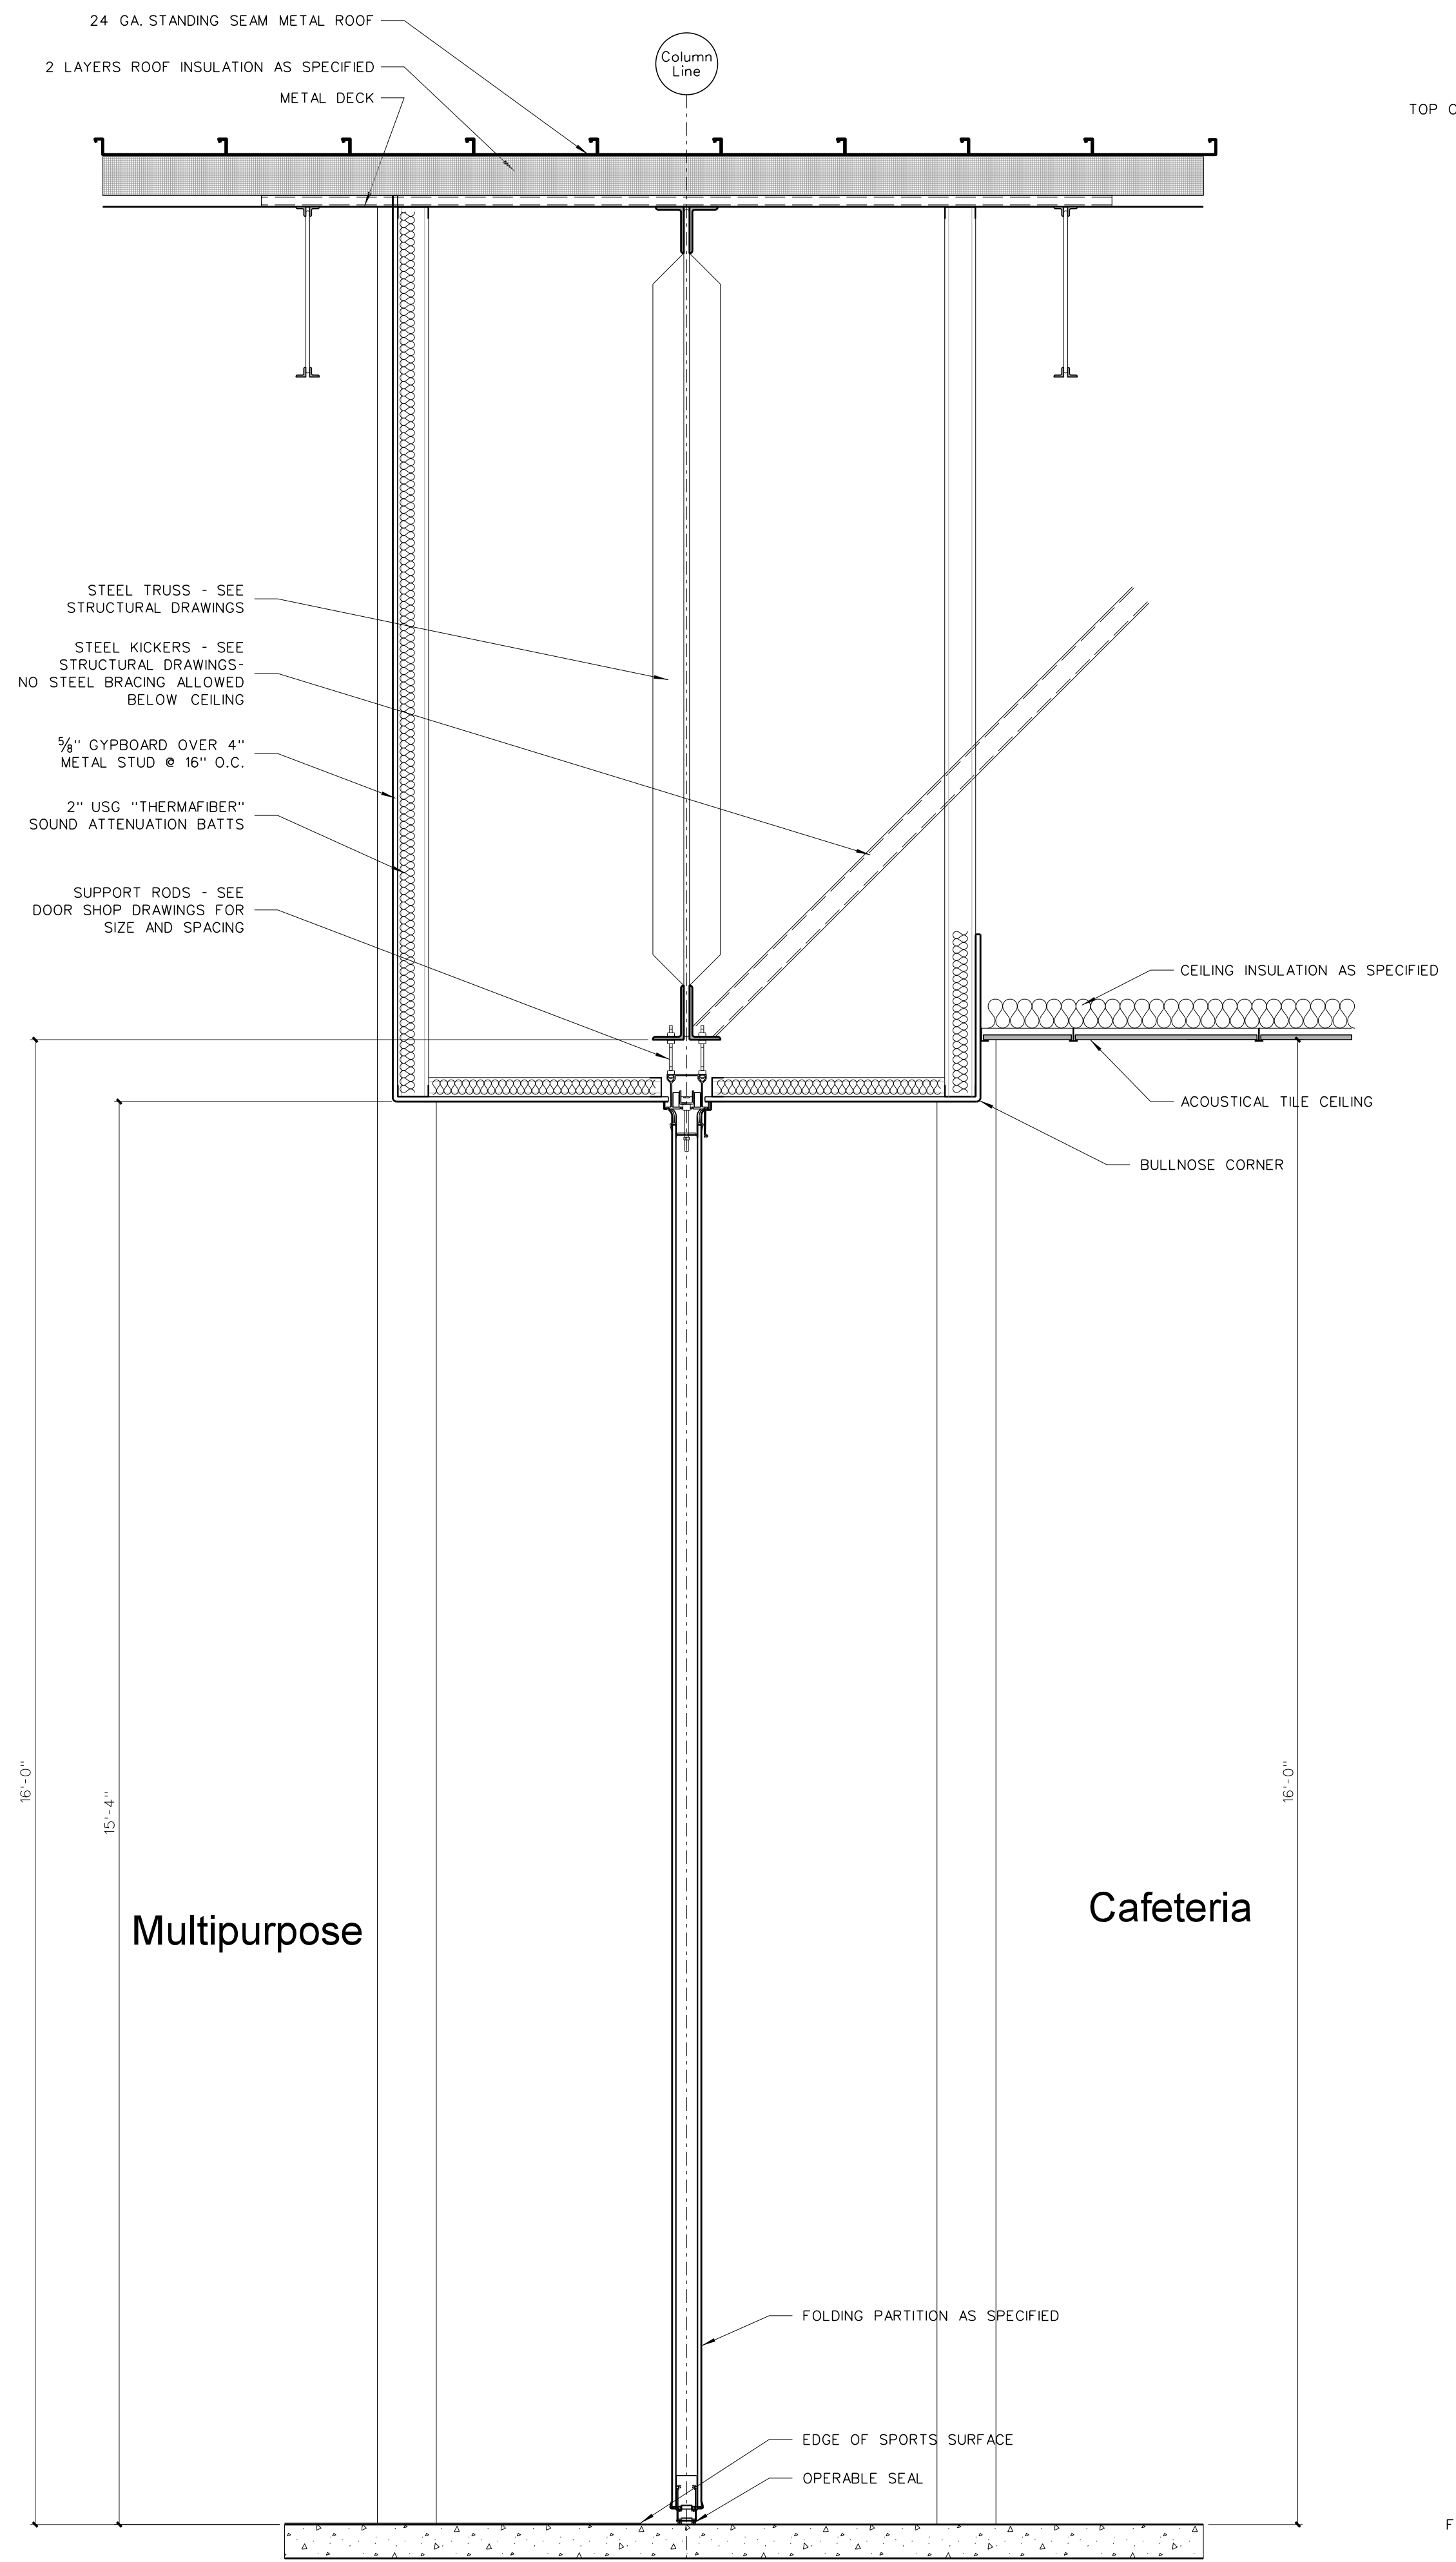

809.2 SECTION AT FOLDING PARTITION
SCALE: 3/4" = 1'-0"

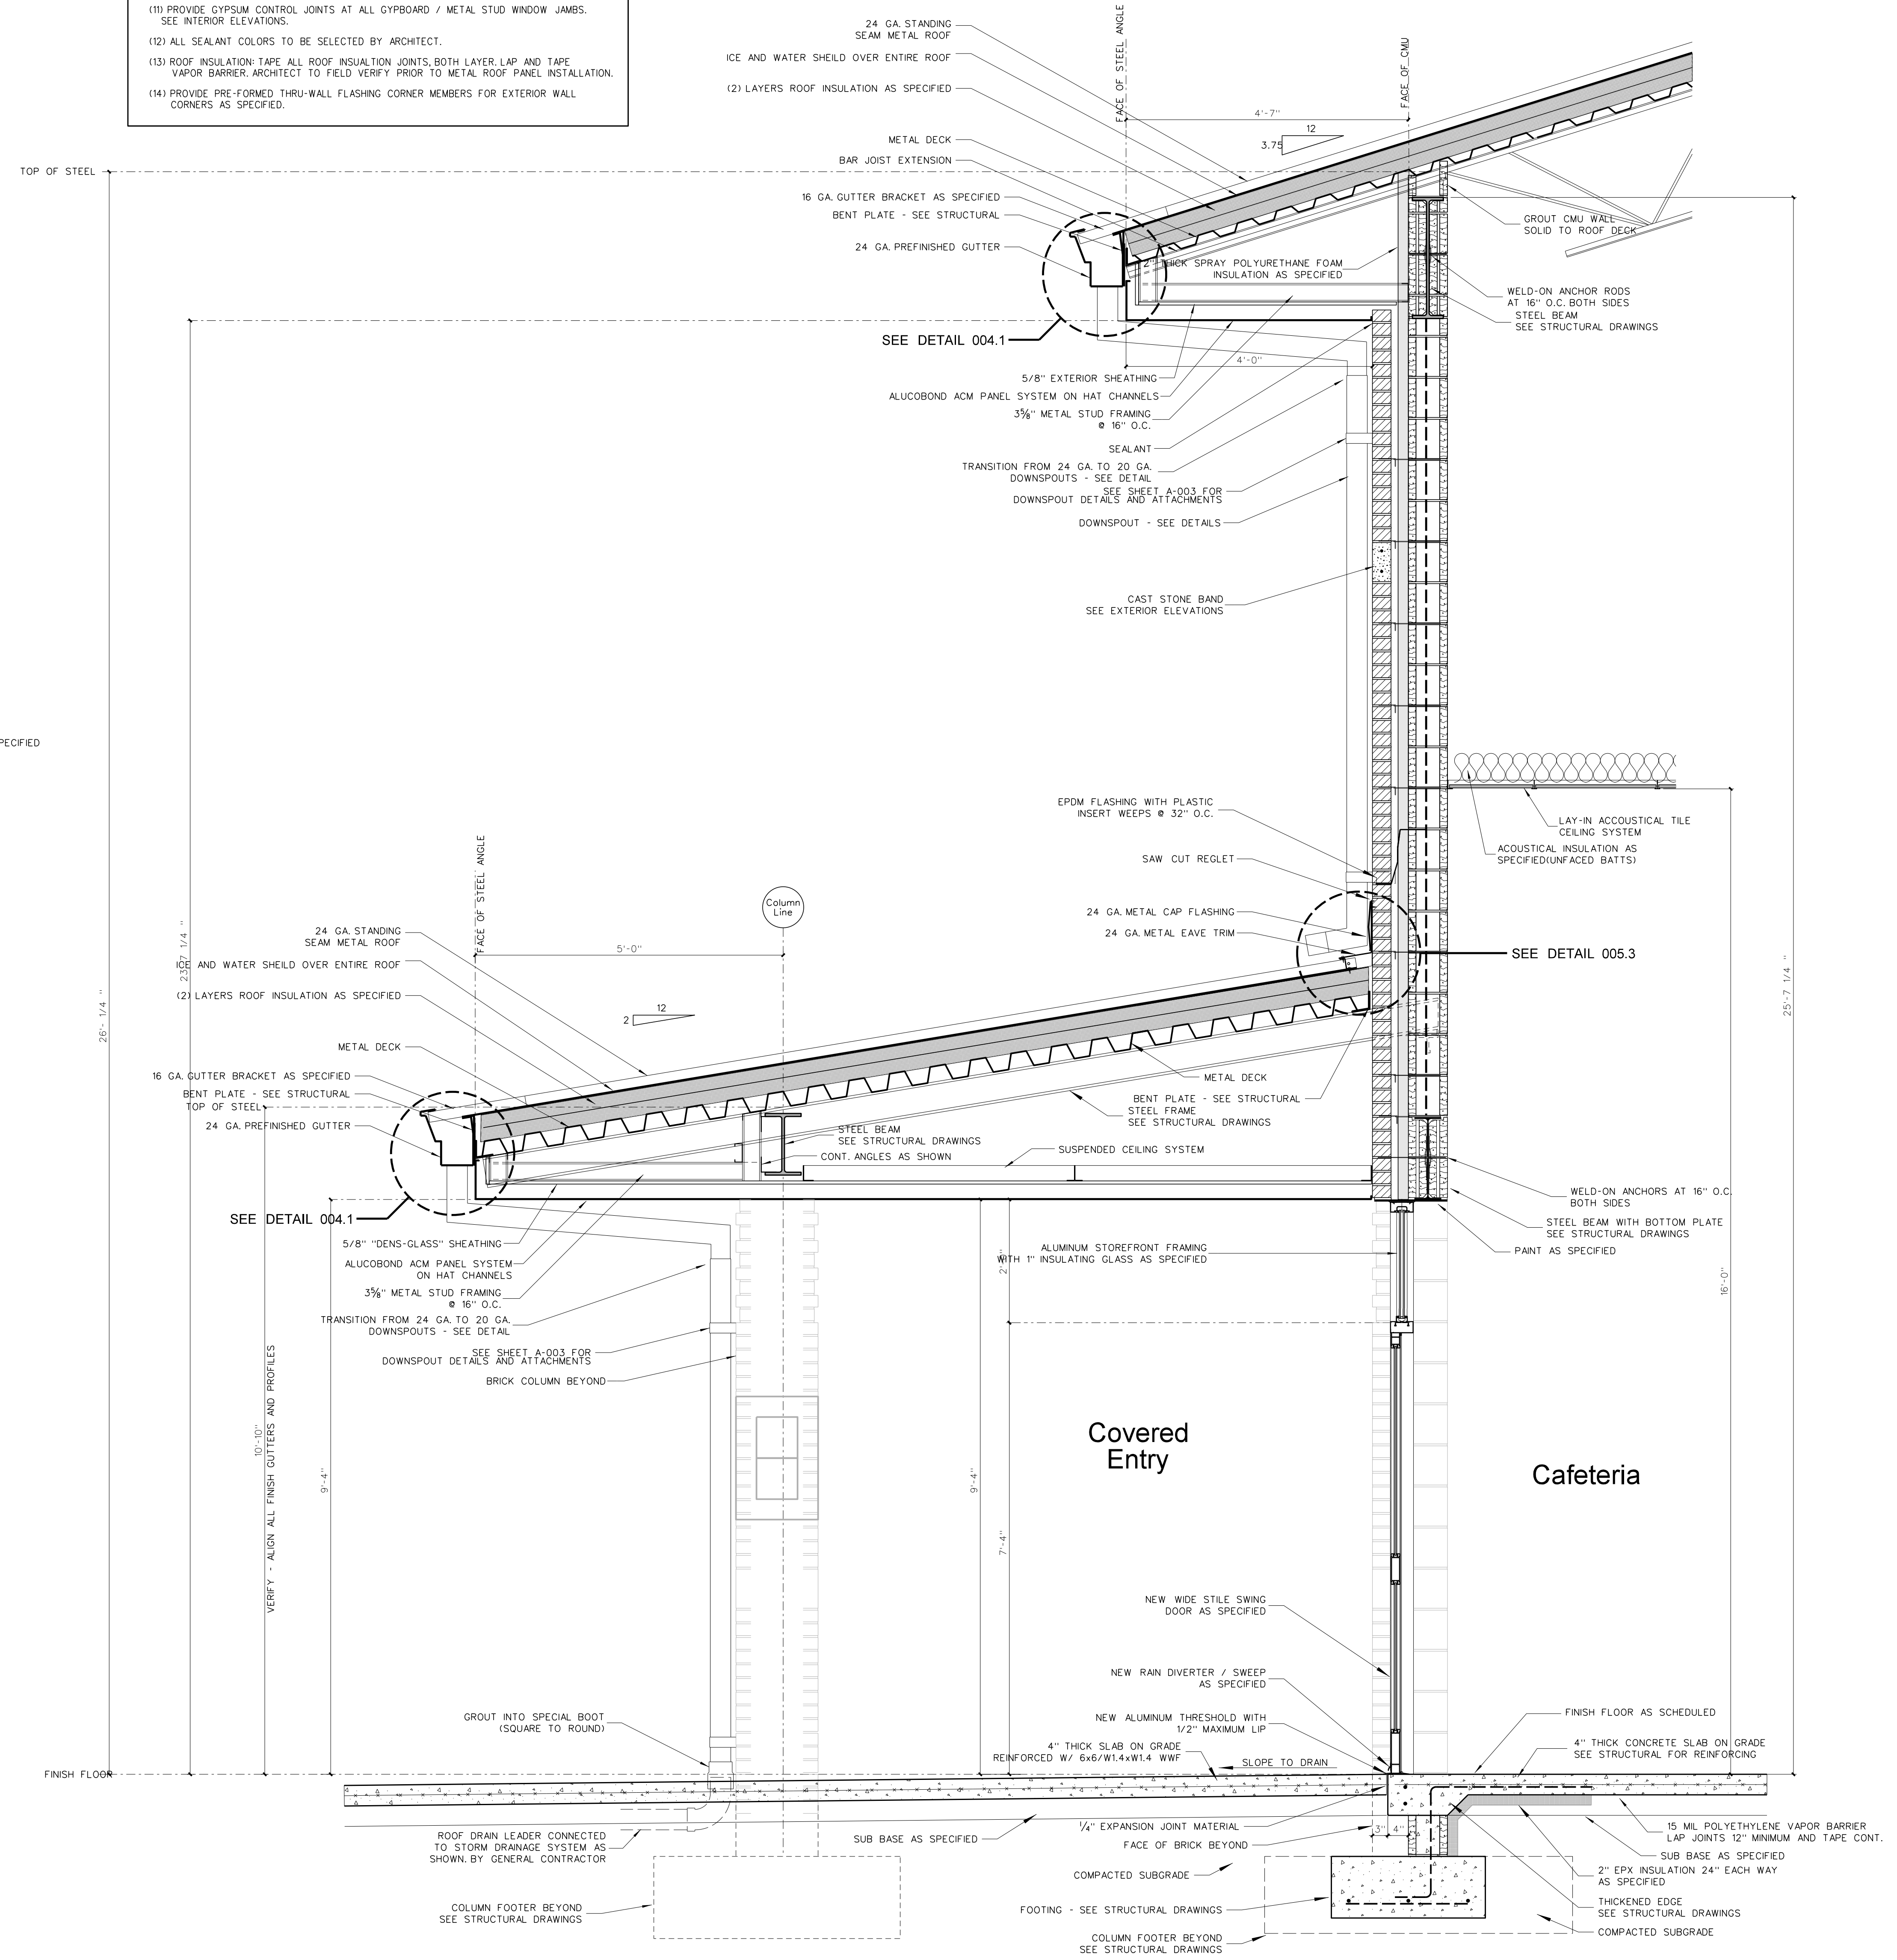


809.1 SECTION AT FRONT COVERED ENTRY
SCALE: 3/4" = 1'-0"

<p>Hite associates ARCHITECTURE / PLANNING / TECHNOLOGY 2600 Meridian Drive / Greenville, NC 27834 / Tel (252) 757-0333</p>	<p>Beaufort PK-3 School BEAUFORT COUNTY SCHOOLS Washington / North Carolina / 27889</p>
<p>Project No. 22344</p>	<p>Date: 1 July 2024</p>
<p>Drawing No. A</p>	<p>809</p>


General Notes for Wall Sections

- (1) SEE EXTERIOR ELEVATIONS FOR BRICK COLOR.
- (2) GENERAL CONTRACTOR SHALL VERIFY TOP OF FINISH GRADES, TOP OF CONCRETE WALKS AND TOP OF CONCRETE SLABS ADJACENT TO BUILDING AND ADJUST LOCATION OF THROUGH WALL FLASHING ACCORDINGLY.
- (3) PROVIDE PLASTIC INSERT WEEPS AT ALL AT DOOR, WINDOW AND FLOOR FLASHING.
- (4) GENERAL CONTRACTOR SHALL SLOPE CONCRETE FLOOR TO FLOOR DRAINS AS SHOWN ON PLUMBING DRAWINGS.
- (5) ALL CMU CELLS BELOW FINISH FLOOR SHALL BE FILLED WITH CONCRETE.
- (6) ALL VAPOR BARRIERS UNDER FLOOR SLABS SHALL BE LAPPED 12" MINIMUM AND TAPED CONTINUOUS AT JOINTS. GENERAL CONTRACTOR SHALL REPAIR ANY DAMAGED VAPOR BARRIER PRIOR TO FINISHING CONCRETE.
- (7) PROVIDE 4" MINIMUM SPRAY POLYURETHANE INSULATION IN ALL METAL STUDS EXTERIOR WALLS. SEE WALL SECTIONS AND SPECIFICATIONS.
- (8) PROVIDE SPRAY POLYURETHANE INSULATION IN ALL NESTED METAL STUD WINDOW AND DOOR JAMBS, SILLS AND HEADS.
- (9) ALL INTERIOR METAL STUD/GYPSUM WALLBOARD PARTITIONS REQUIRE SOUND ATTENUATION BATTIS.
- (10) PROVIDE METAL CHAIRS UNDER ALL STEEL WIRE MATS REINFORCING STEEL FOR CONCRETE SLABS AND FOUNDATIONS.
- (11) PROVIDE GYPSUM CONTROL JOINTS AT ALL GYPSUM / METAL STUD WINDOW JAMBS. SEE INTERIOR ELEVATIONS.
- (12) ALL SEALANT COLORS TO BE SELECTED BY ARCHITECT.
- (13) ROOF INSULATION: TAPE ALL ROOF INSULATION JOINTS, BOTH LAYER LAP AND TAPE VAPOR BARRIER ARCHITECT TO FIELD VERIFY PRIOR TO METAL ROOF PANEL INSTALLATION.
- (14) PROVIDE PRE-FORMED THRU-WALL FLASHING CORNER MEMBERS FOR EXTERIOR WALL CORNERS AS SPECIFIED.

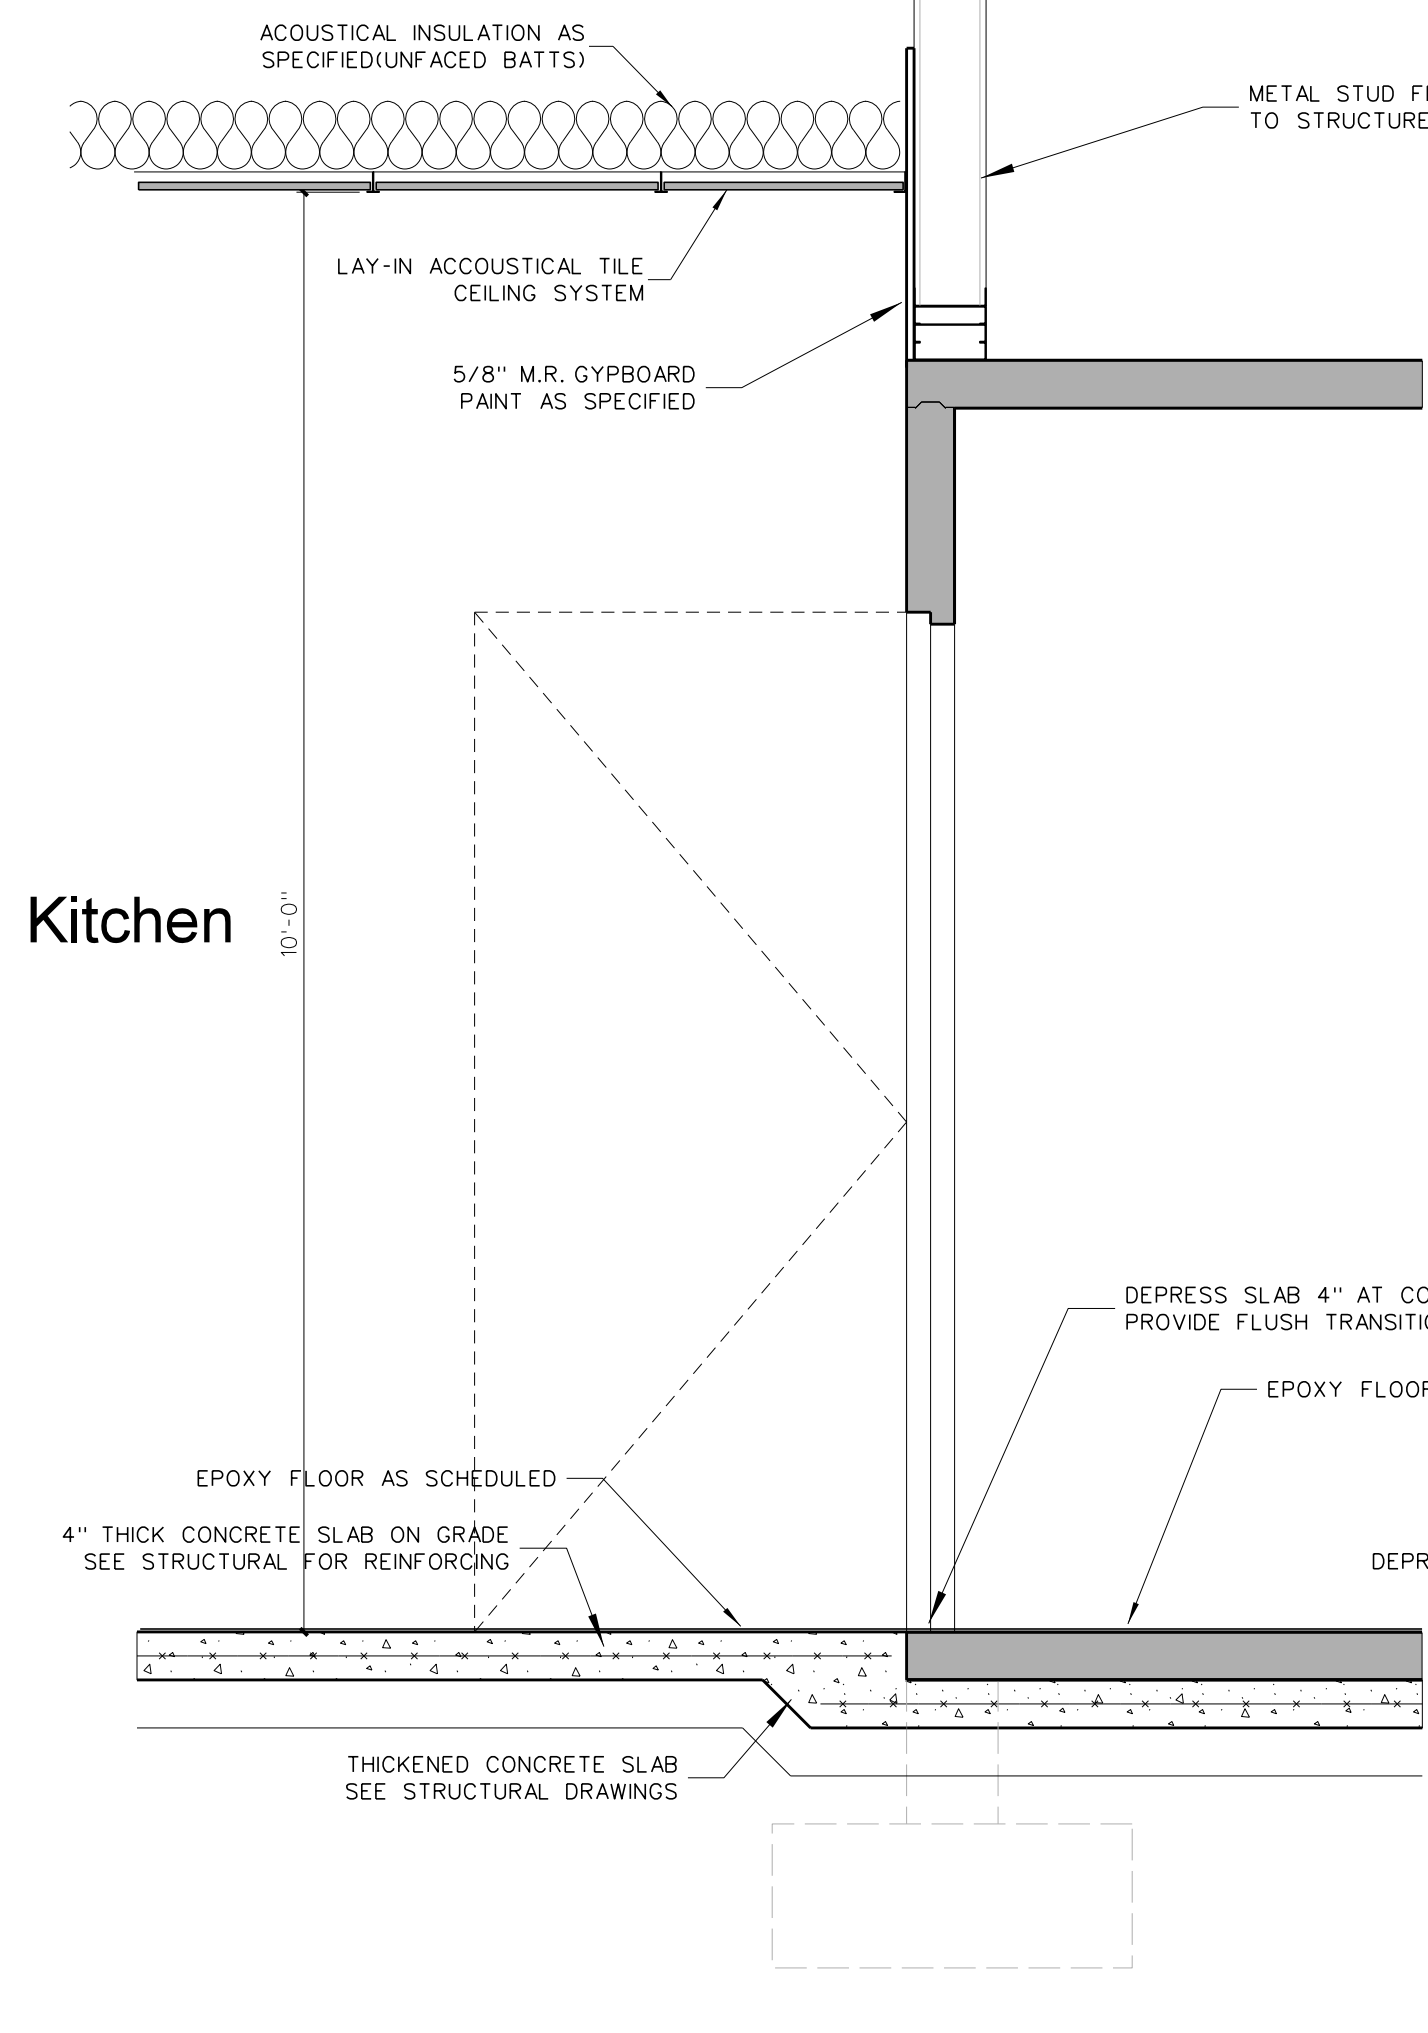

810.2 SECTION AT WALK-IN COOLER / FREEZER

SCALE: 3/4" = 1'-0"

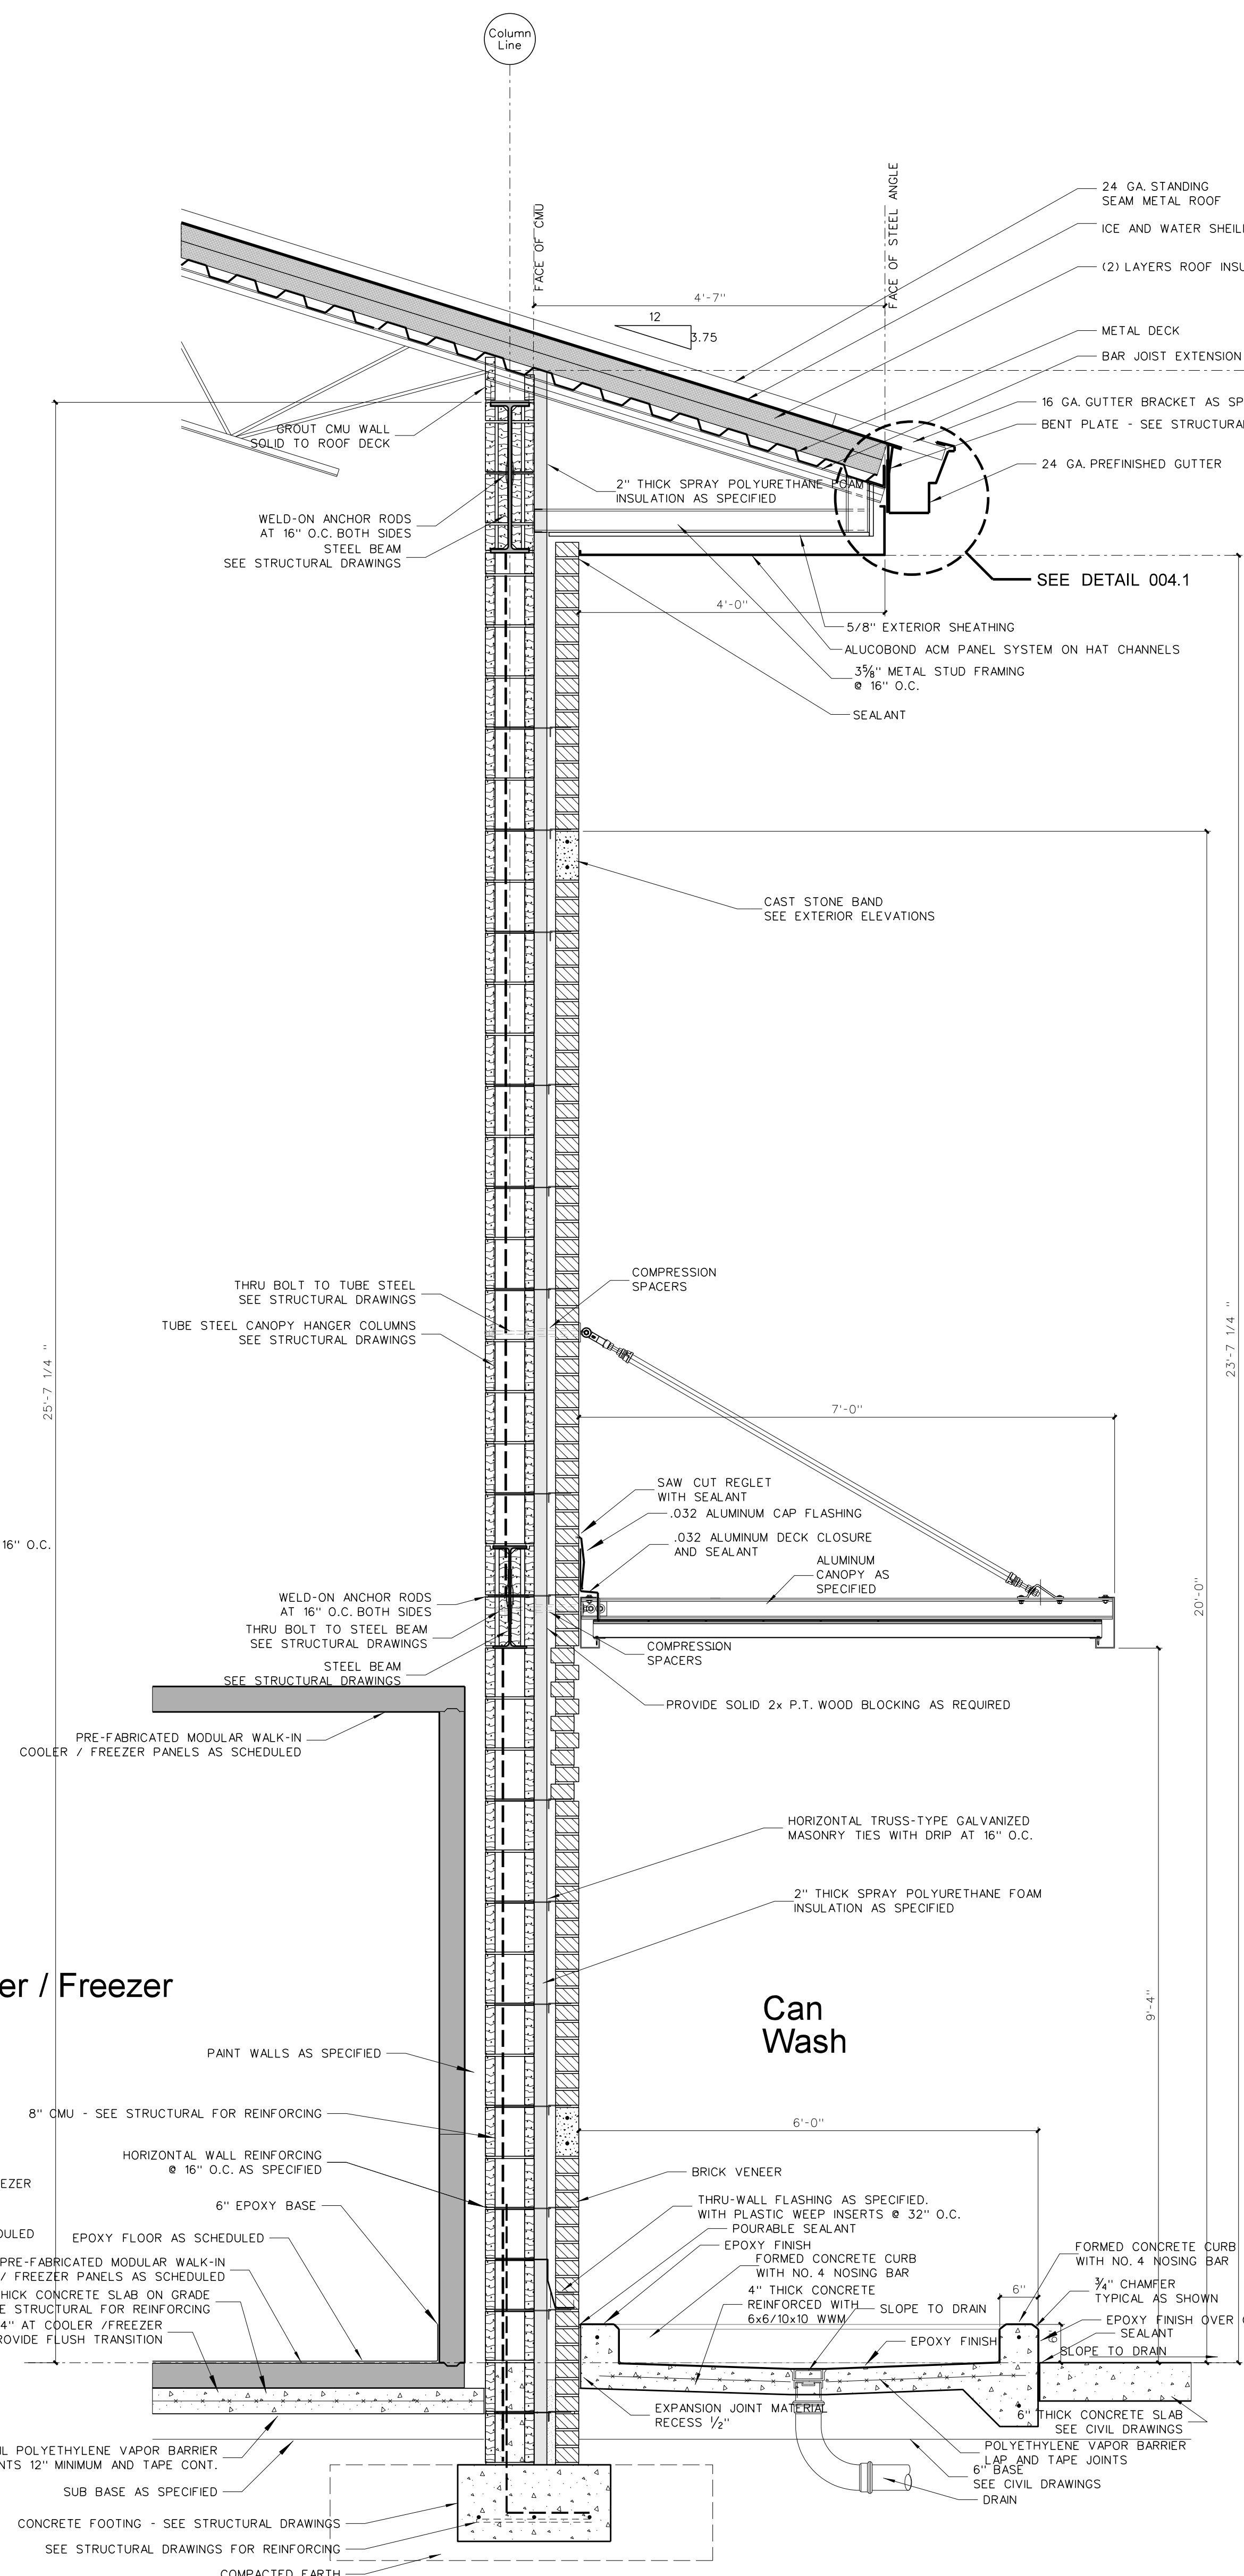


810.1 SECTION AT KITCHEN ENTRY

SCALE: 3/4" = 1'-0"

No.	Date	Revision

Hite associates
 ARCHITECTURE / PLANNING / TECHNOLOGY
 2600 Meridian Drive / Greenville, NC 27834 / tel (252) 757-0333

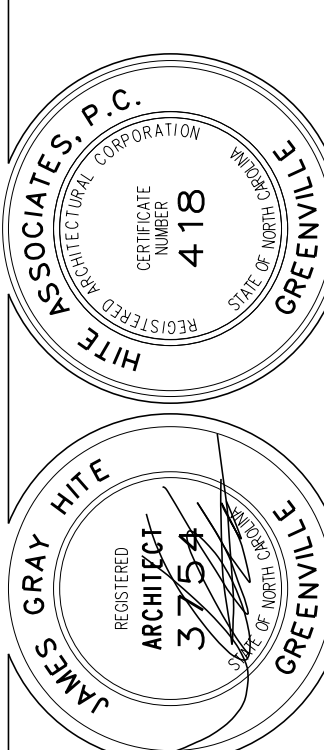


Beaufort PK-3 School
 BEAUFORT COUNTY SCHOOLS
 Washington / North Carolina / 27889


Project No.	22344
Date:	1 July 2024
Drawing no.	A 810

General Notes for Wall Sections

- (1) SEE EXTERIOR ELEVATIONS FOR BRICK COLOR.
- (2) GENERAL CONTRACTOR SHALL VERIFY TOP OF FINISH GRADES, TOP OF CONCRETE WALKS AND TOP OF CONCRETE SLABS ADJACENT TO BUILDING AND ADJUST LOCATION OF THROUGH WALL FLASHING ACCORDINGLY.
- (3) PROVIDE PLASTIC INSERT WEEPS AT ALL AT DOOR, WINDOW AND FLOOR FLASHING.
- (4) GENERAL CONTRACTOR SHALL SLOPE CONCRETE FLOOR TO FLOOR DRAINS AS SHOWN ON PLUMBING DRAWINGS.
- (5) ALL CMU CELLS BELOW FINISH FLOOR SHALL BE FILLED WITH CONCRETE.
- (6) ALL VAPOR BARRIERS UNDER FLOOR SLABS SHALL BE LAPPED 12" MINIMUM AND TAPED CONTIGUOUS AT JOINTS. GENERAL CONTRACTOR SHALL REPAIR ANY DAMAGED VAPOR BARRIER PRIOR TO PLACING CONCRETE.
- (7) PROVIDE 4" MINIMUM SPRAY POLYURETHANE INSULATION IN ALL METAL STUDS EXTERIOR WALLS. SEE WALL SECTIONS AND SPECIFICATIONS.
- (8) PROVIDE SPRAY POLYURETHANE INSULATION IN ALL NESTED METAL STUD WINDOW AND DOOR JAMBS, SILLS AND HEADS.
- (9) ALL INTERIOR METAL STUD/GYPSUM WALLBOARD PARTITIONS REQUIRE SOUND ATTENUATION BATTS.
- (10) PROVIDE METAL CHAIRS UNDER ALL STEEL WIRE MATS REINFORCING STEEL FOR CONCRETE SLABS AND FOUNDATIONS.
- (11) PROVIDE GYPSUM CONTROL JOINTS AT ALL GYPSOBOARD / METAL STUD WINDOW JAMBS. SEE INTERIOR ELEVATIONS.
- (12) ALL SEALANT COLORS TO BE SELECTED BY ARCHITECT.
- (13) ROOF INSULATION TAPE ALL ROOF INSULATION JOINTS, BOTH LAYER LAP AND TAPE VAPOR BARRIER. ARCHITECT TO FIELD VERIFY PRIOR TO METAL ROOF PANEL INSTALLATION.
- (14) PROVIDE PRE-FORMED THRU-WALL FLASHING CORNER MEMBERS FOR EXTERIOR WALL CORNERS AS SPECIFIED.

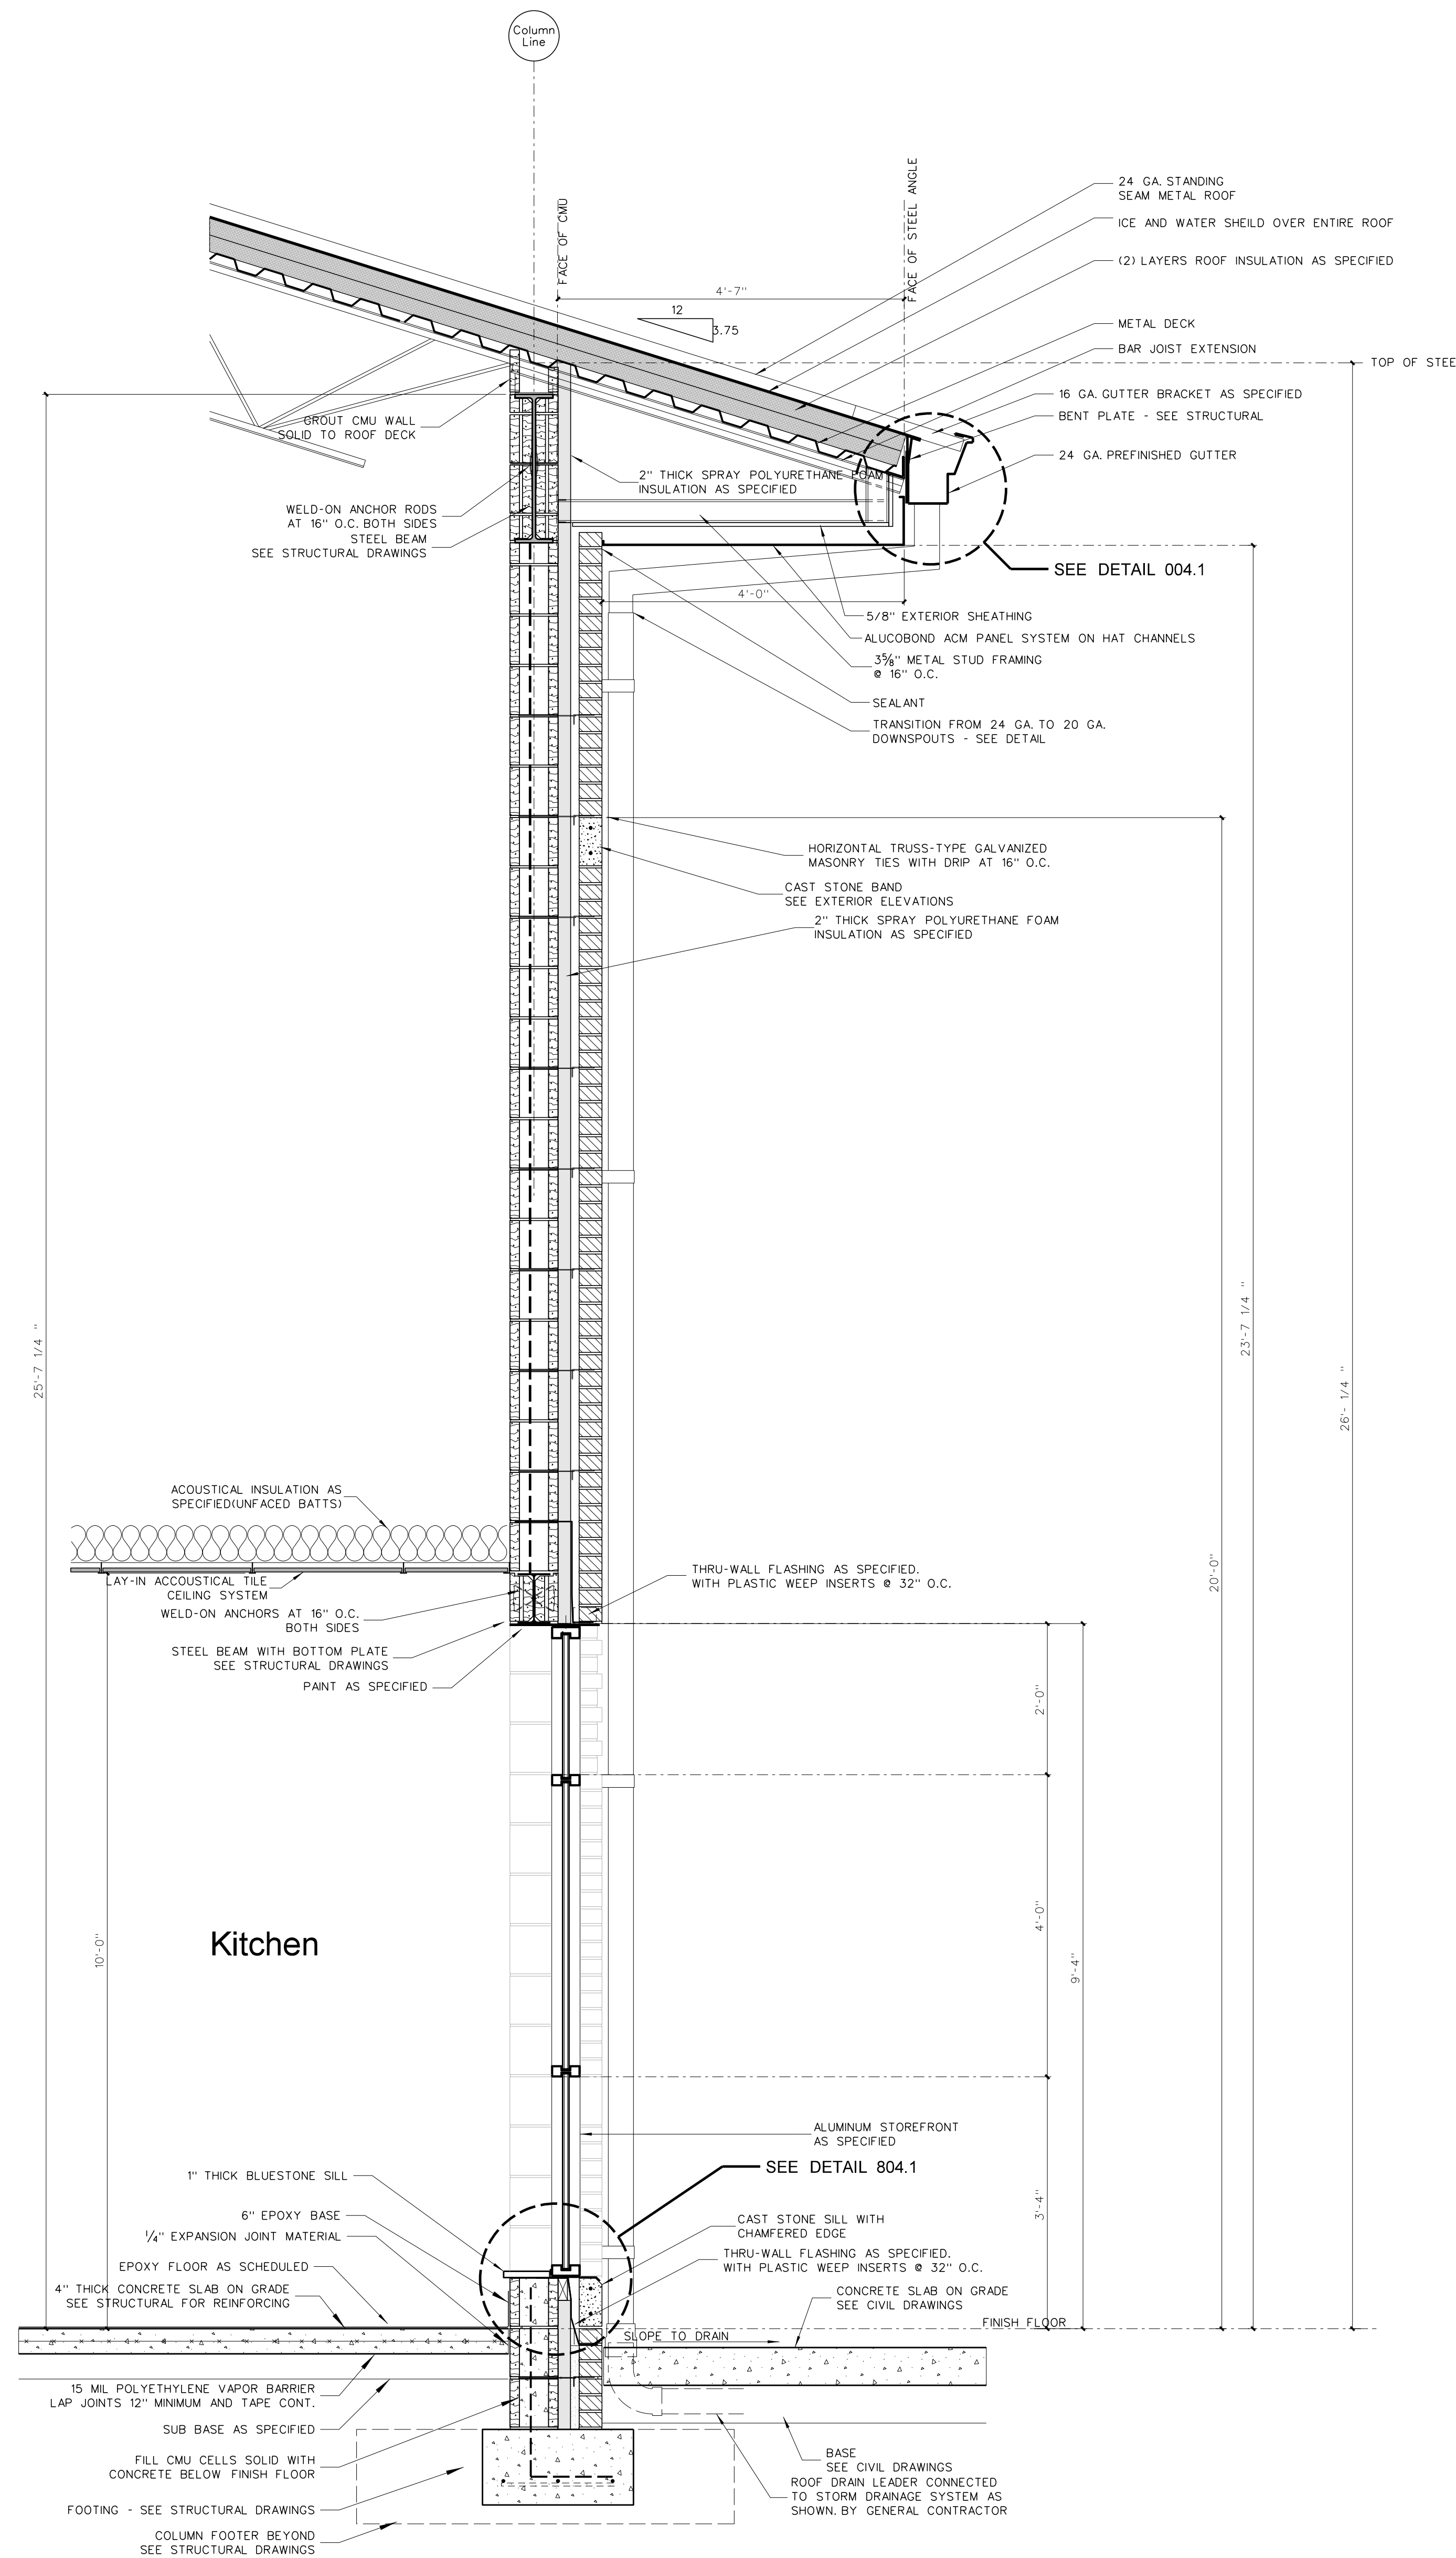

811.2 SECTION AT KITCHEN
SCALE: 3/4" = 1'-0"

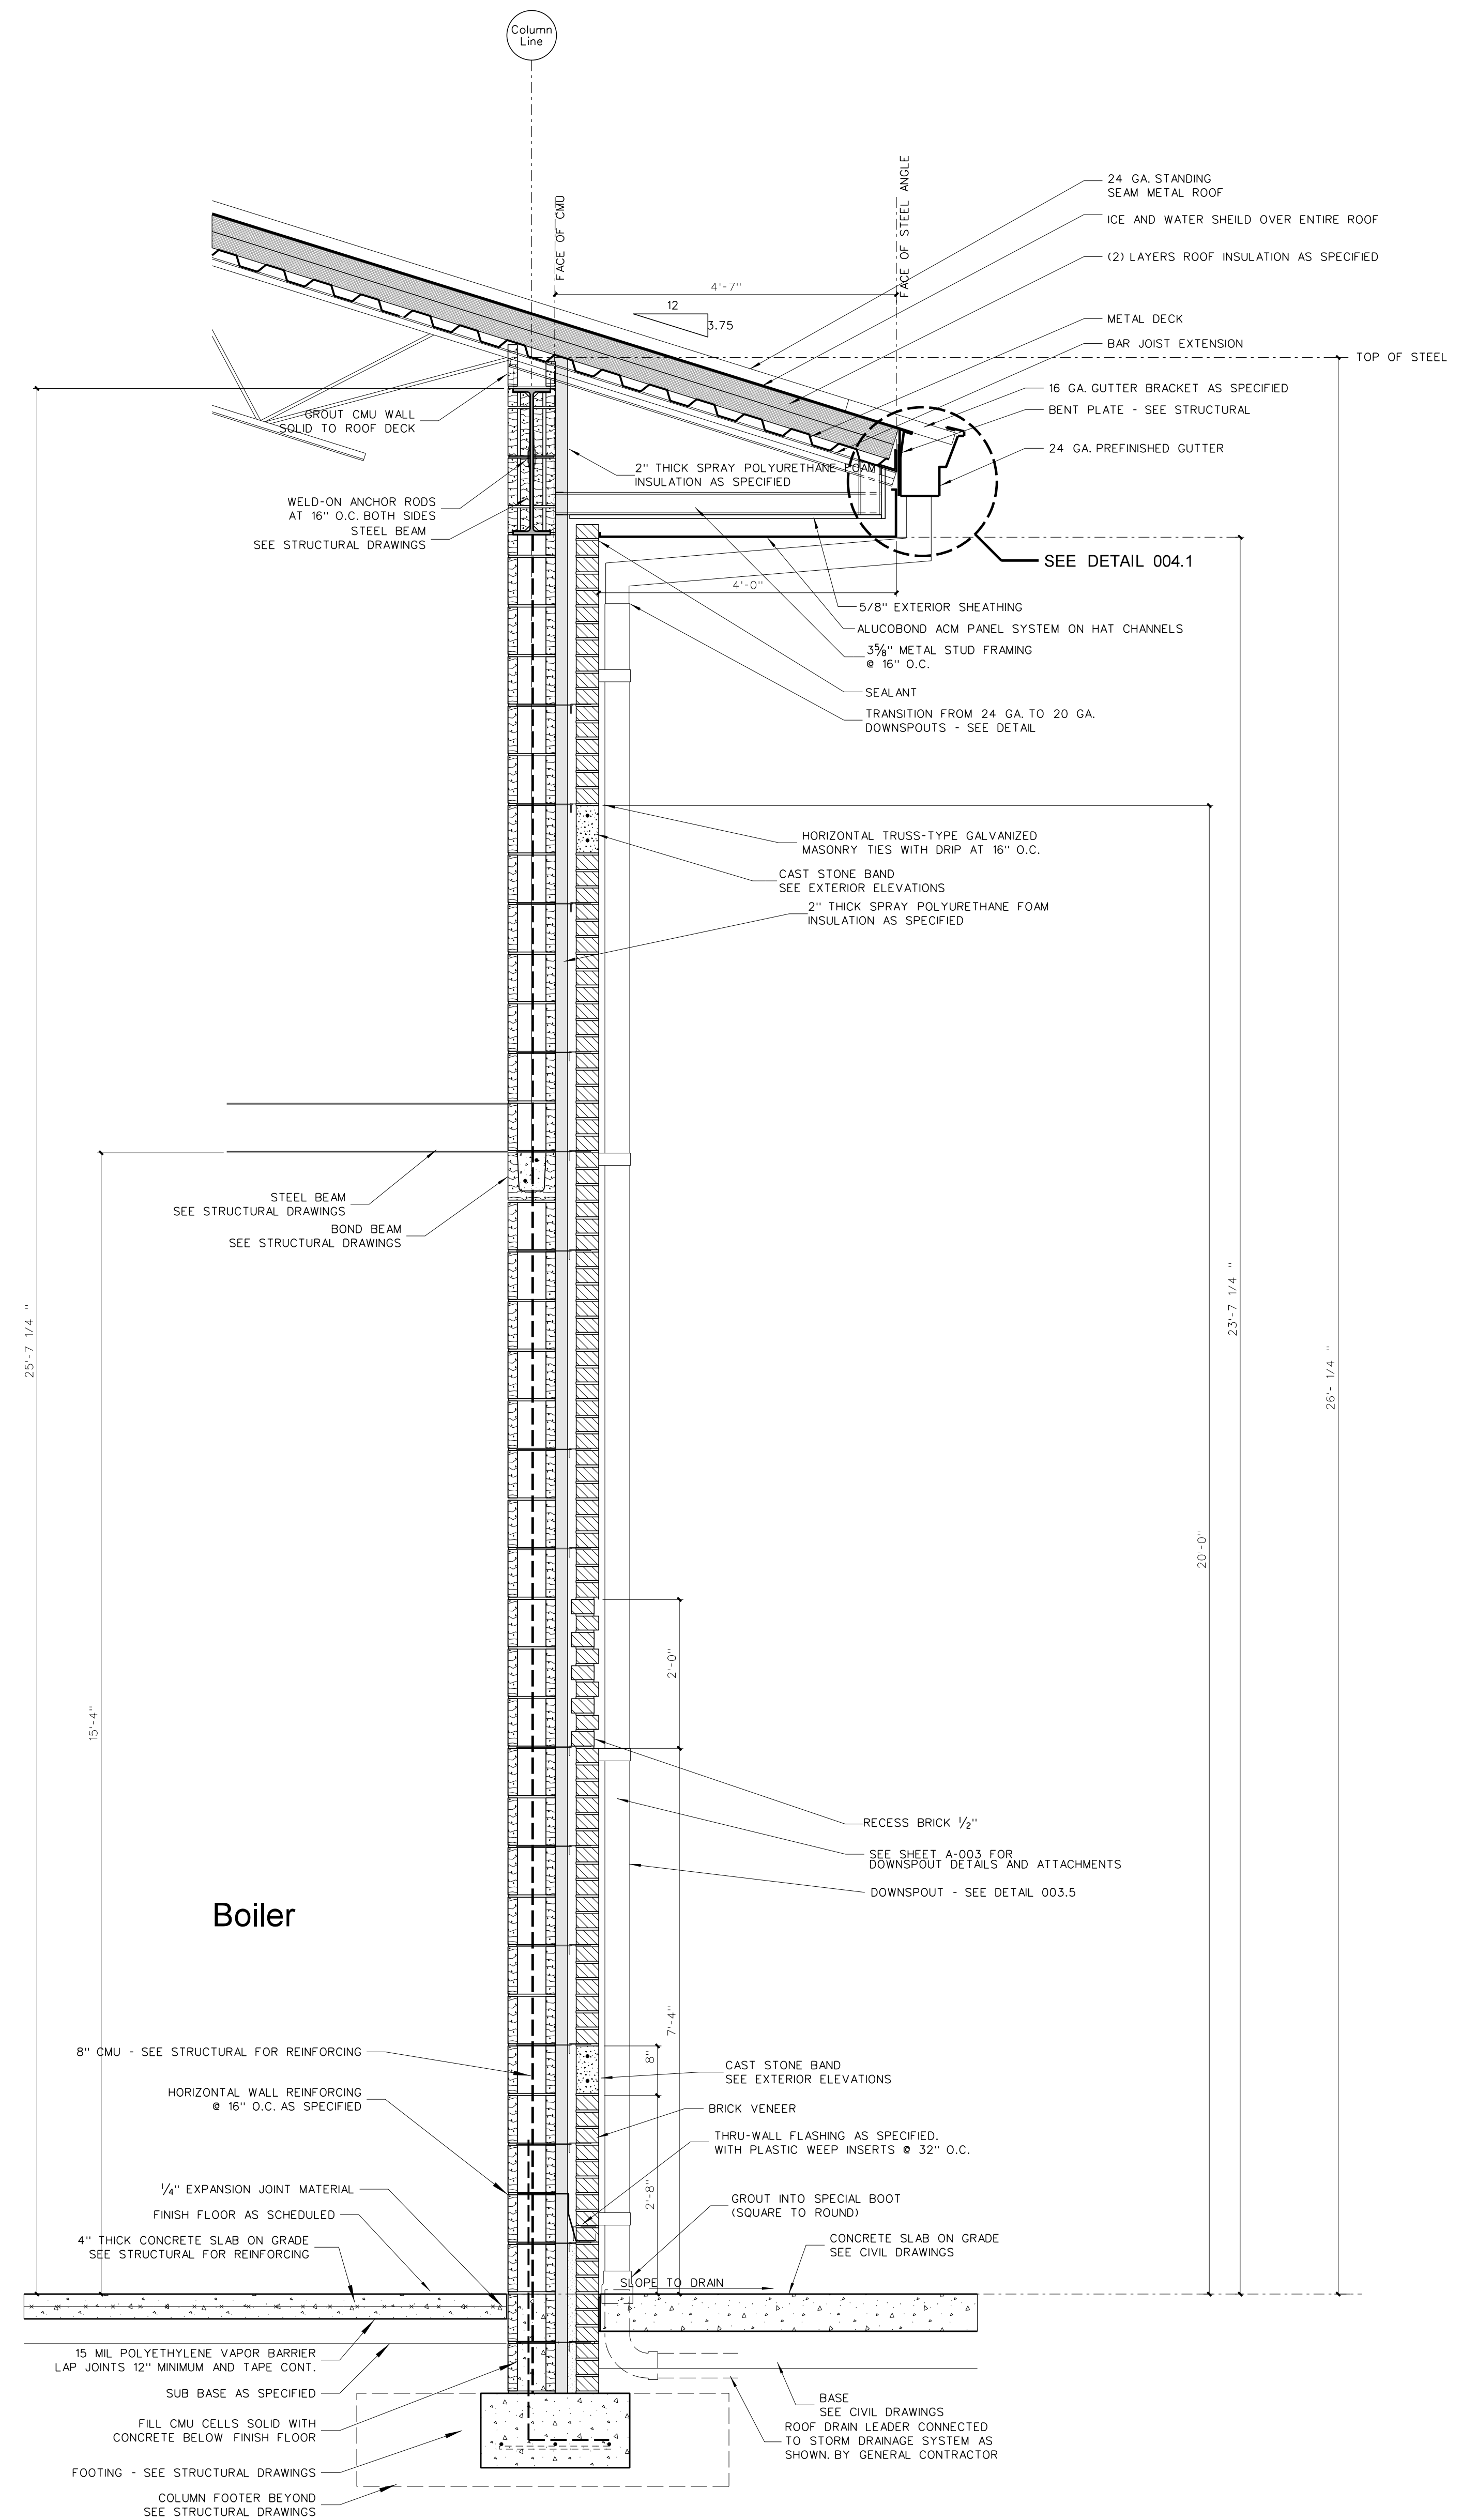

811.1 SECTION AT BOILER ROOM
SCALE: 3/4" = 1'-0"

No.	Date	Revision

Hite associates
ARCHITECTURE / PLANNING / TECHNOLOGY
2600 Meridian Drive / Greenville, NC 27834 / tel (252) 757-0333



Beaufort PK-3 School
BEAUFORT COUNTY SCHOOLS
Washington / North Carolina / 727889

Project No. 22344


Date: 1 July 2024

Drawing no.

A
811

General Notes for Wall Sections

- (1) SEE EXTERIOR ELEVATIONS FOR BRICK COLOR.
- (2) GENERAL CONTRACTOR SHALL VERIFY TOP OF FINISH GRADES, TOP OF CONCRETE WALLS AND TOP OF CONCRETE SLABS ADJACENT TO BUILDING AND ADJUST LOCATION OF THROUGH WALL FLASHING ACCORDINGLY.
- (3) PROVIDE PLASTIC INSERT WEEPS AT ALL AT DOOR, WINDOW AND FLOOR FLASHING.
- (4) GENERAL CONTRACTOR SHALL SLOPE CONCRETE FLOOR TO FLOOR DRAINS AS SHOWN ON PLUMBING DRAWINGS.
- (5) ALL CMU CELLS BELOW FINISH FLOOR SHALL BE FILLED WITH CONCRETE.
- (6) ALL VAPOR BARRIERS UNDER FLOOR SLABS SHALL BE LAPPED 12" MINIMUM AND TAPED CONTINUOUS AT JOINTS. GENERAL CONTRACTOR SHALL REPAIR ANY DAMAGED VAPOR BARRIER PRIOR TO PLACING CONCRETE.
- (7) PROVIDE 4" MINIMUM SPRAY POLYURETHANE INSULATION IN ALL METAL STUDS EXTERIOR WALLS. SEE WALL SECTIONS AND SPECIFICATIONS.
- (8) PROVIDE SPRAY POLYURETHANE INSULATION IN ALL NESTED METAL STUD WINDOW AND DOOR JAMBS, SILLS AND HEADS.
- (9) ALL INTERIOR METAL STUD/GYPSUM WALLBOARD PARTITIONS REQUIRE SOUND ATTENUATION BATT.
- (10) PROVIDE METAL CHAIRS UNDER ALL STEEL WIRE MATS REINFORCING STEEL FOR CONCRETE SLABS AND FOUNDATIONS.
- (11) PROVIDE GYPSUM CONTROL JOINTS AT ALL GYPSUM BOARD / METAL STUD WINDOW JAMBS. SEE INTERIOR ELEVATIONS.
- (12) ALL SEALANT COLORS TO BE SELECTED BY ARCHITECT.
- (13) ROOF INSULATION: TAPE ALL ROOF INSULATION JOINTS, BOTH LAYER, LAP AND TAPE VAPOR BARRIER, ARCHITECT TO FIELD VERIFY PRIOR TO METAL ROOF PANEL INSTALLATION.
- (14) PROVIDE PRE-FORMED THRU-WALL FLASHING CORNER MEMBERS FOR EXTERIOR WALL CORNERS AS SPECIFIED.

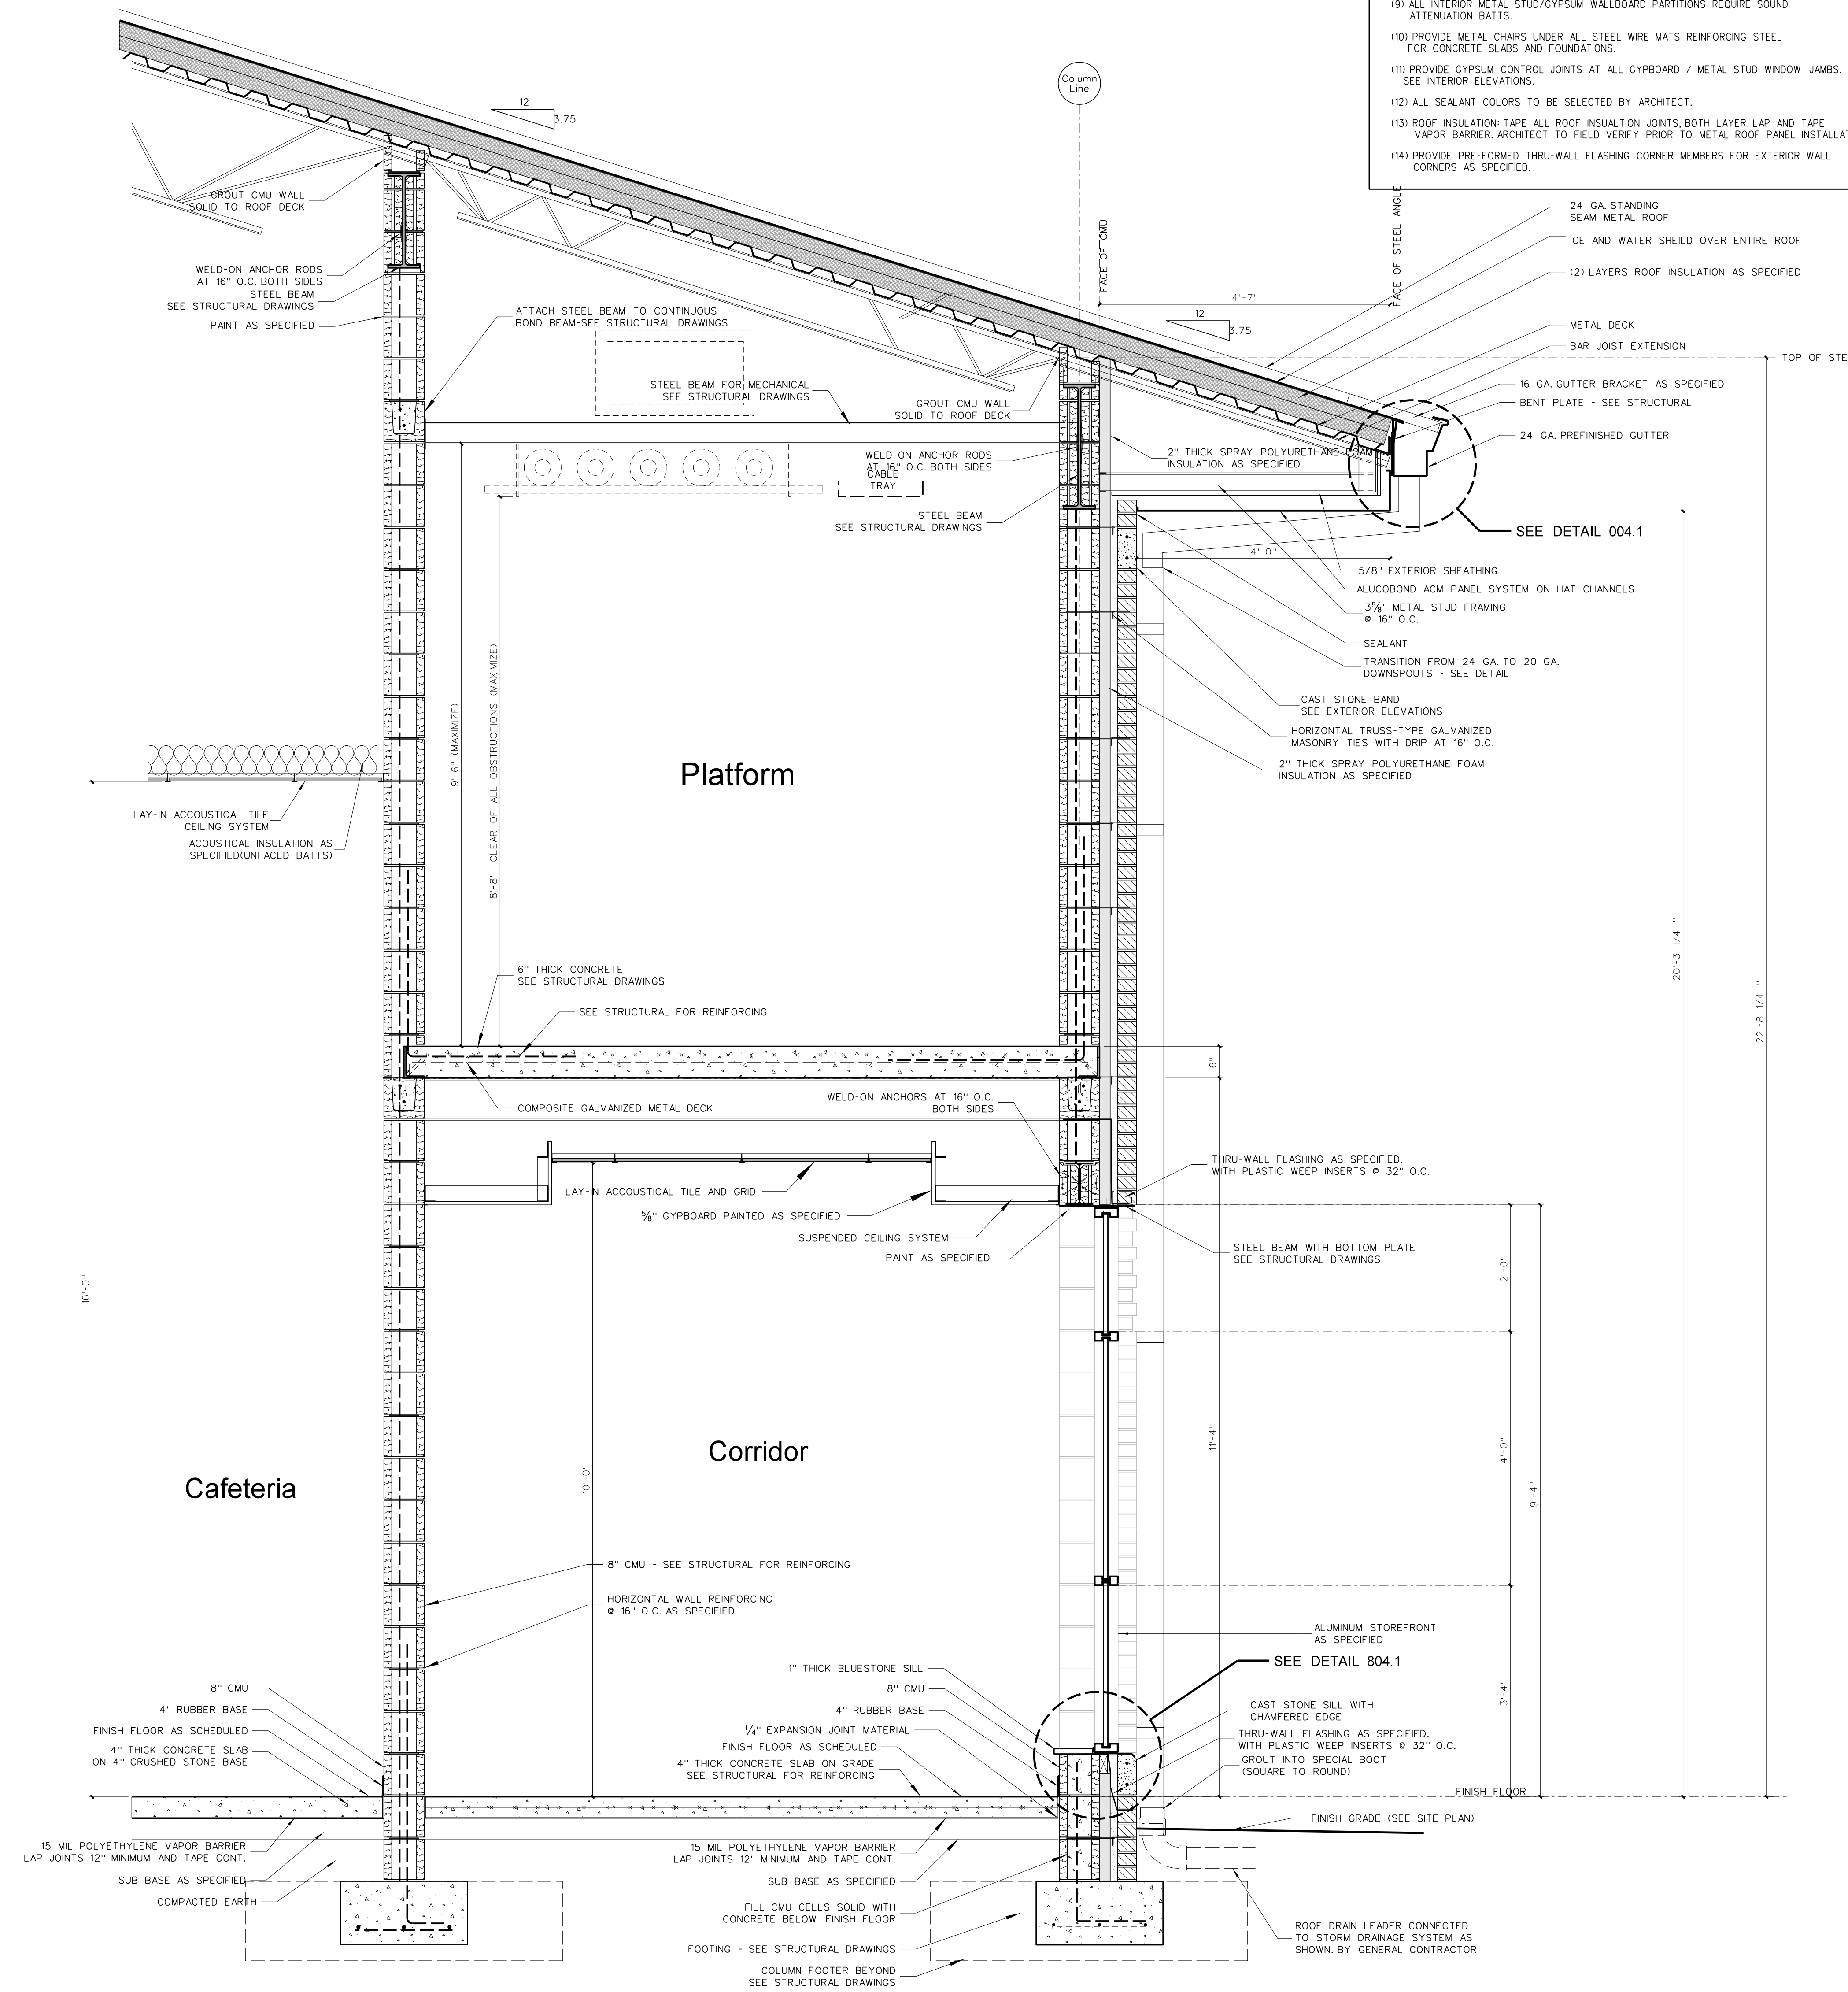

No.	Date	Revision

Hite associates
 ARCHITECTURE / PLANNING / TECHNOLOGY
 2600 Meridian Drive / Greenville, NC 27834 / tel (252) 757-0333



Beaufort PK-3 School
 BEAUFORT COUNTY SCHOOLS
 Washington / North Carolina / 27889


Project No. 22344
 Date: 1 July 2024

Drawing No. **A 812**

812.1 SECTION AT PLATFORM
 SCALE: 3/4" = 1'-0"

General Notes for Wall Sections

- (1) SEE EXTERIOR ELEVATIONS FOR BRICK COLOR.
- (2) GENERAL CONTRACTOR SHALL VERIFY TOP OF FINISH GRADES, TOP OF CONCRETE WALKS AND TOP OF CONCRETE SLABS ADJACENT TO BUILDING AND ADJUST LOCATION OF THROUGH WALL FLASHING ACCORDINGLY.
- (3) PROVIDE PLASTIC INSERT WEEPS AT ALL AT DOOR, WINDOW AND FLOOR FLASHING.
- (4) GENERAL CONTRACTOR SHALL SLOPE CONCRETE FLOOR TO FLOOR DRAINS AS SHOWN ON PLUMBING DRAWINGS.
- (5) ALL CMU CELLS BELOW FINISH FLOOR SHALL BE FILLED WITH CONCRETE.
- (6) ALL VAPOR BARRIERS UNDER FLOOR SLABS SHALL BE LAPPED 12" MINIMUM AND TAPED CONTINUOUS AT JOINTS. GENERAL CONTRACTOR SHALL REPAIR ANY DAMAGED VAPOR BARRIER PRIOR TO PLACING CONCRETE.
- (7) PROVIDE 4" MINIMUM SPRAY POLYURETHANE INSULATION IN ALL METAL STUDS EXTERIOR WALLS. SEE WALL SECTIONS AND SPECIFICATIONS.
- (8) PROVIDE SPRAY POLYURETHANE INSULATION IN ALL NESTED METAL STUD WINDOW AND DOOR JAMES, SILLS AND HEADS.
- (9) ALL INTERIOR METAL STUD/GYPSUM WALLBOARD PARTITIONS REQUIRE SOUND ATTENUATION BATTS.
- (10) PROVIDE METAL CHAIRS UNDER ALL STEEL WIRE MATS REINFORCING STEEL FOR CONCRETE SLABS AND FOUNDATIONS.
- (11) PROVIDE GYPSUM CONTROL JOINTS AT ALL GYPSUM / METAL STUD WINDOW JAMES.
- (12) ALL SEALANT COLORS TO BE SELECTED BY ARCHITECT.
- (13) ROOF INSULATION TAPE ALL ROOF INSULATION JOINTS, BOTH LAYER LAP AND TAPE VAPOR BARRIER ARCHITECT TO FIELD VERIFY PRIOR TO METAL ROOF PANEL INSTALLATION.
- (14) PROVIDE PRE-FORMED THRU-WALL FLASHING CORNER MEMBERS FOR EXTERIOR WALL CORNERS AS SPECIFIED.

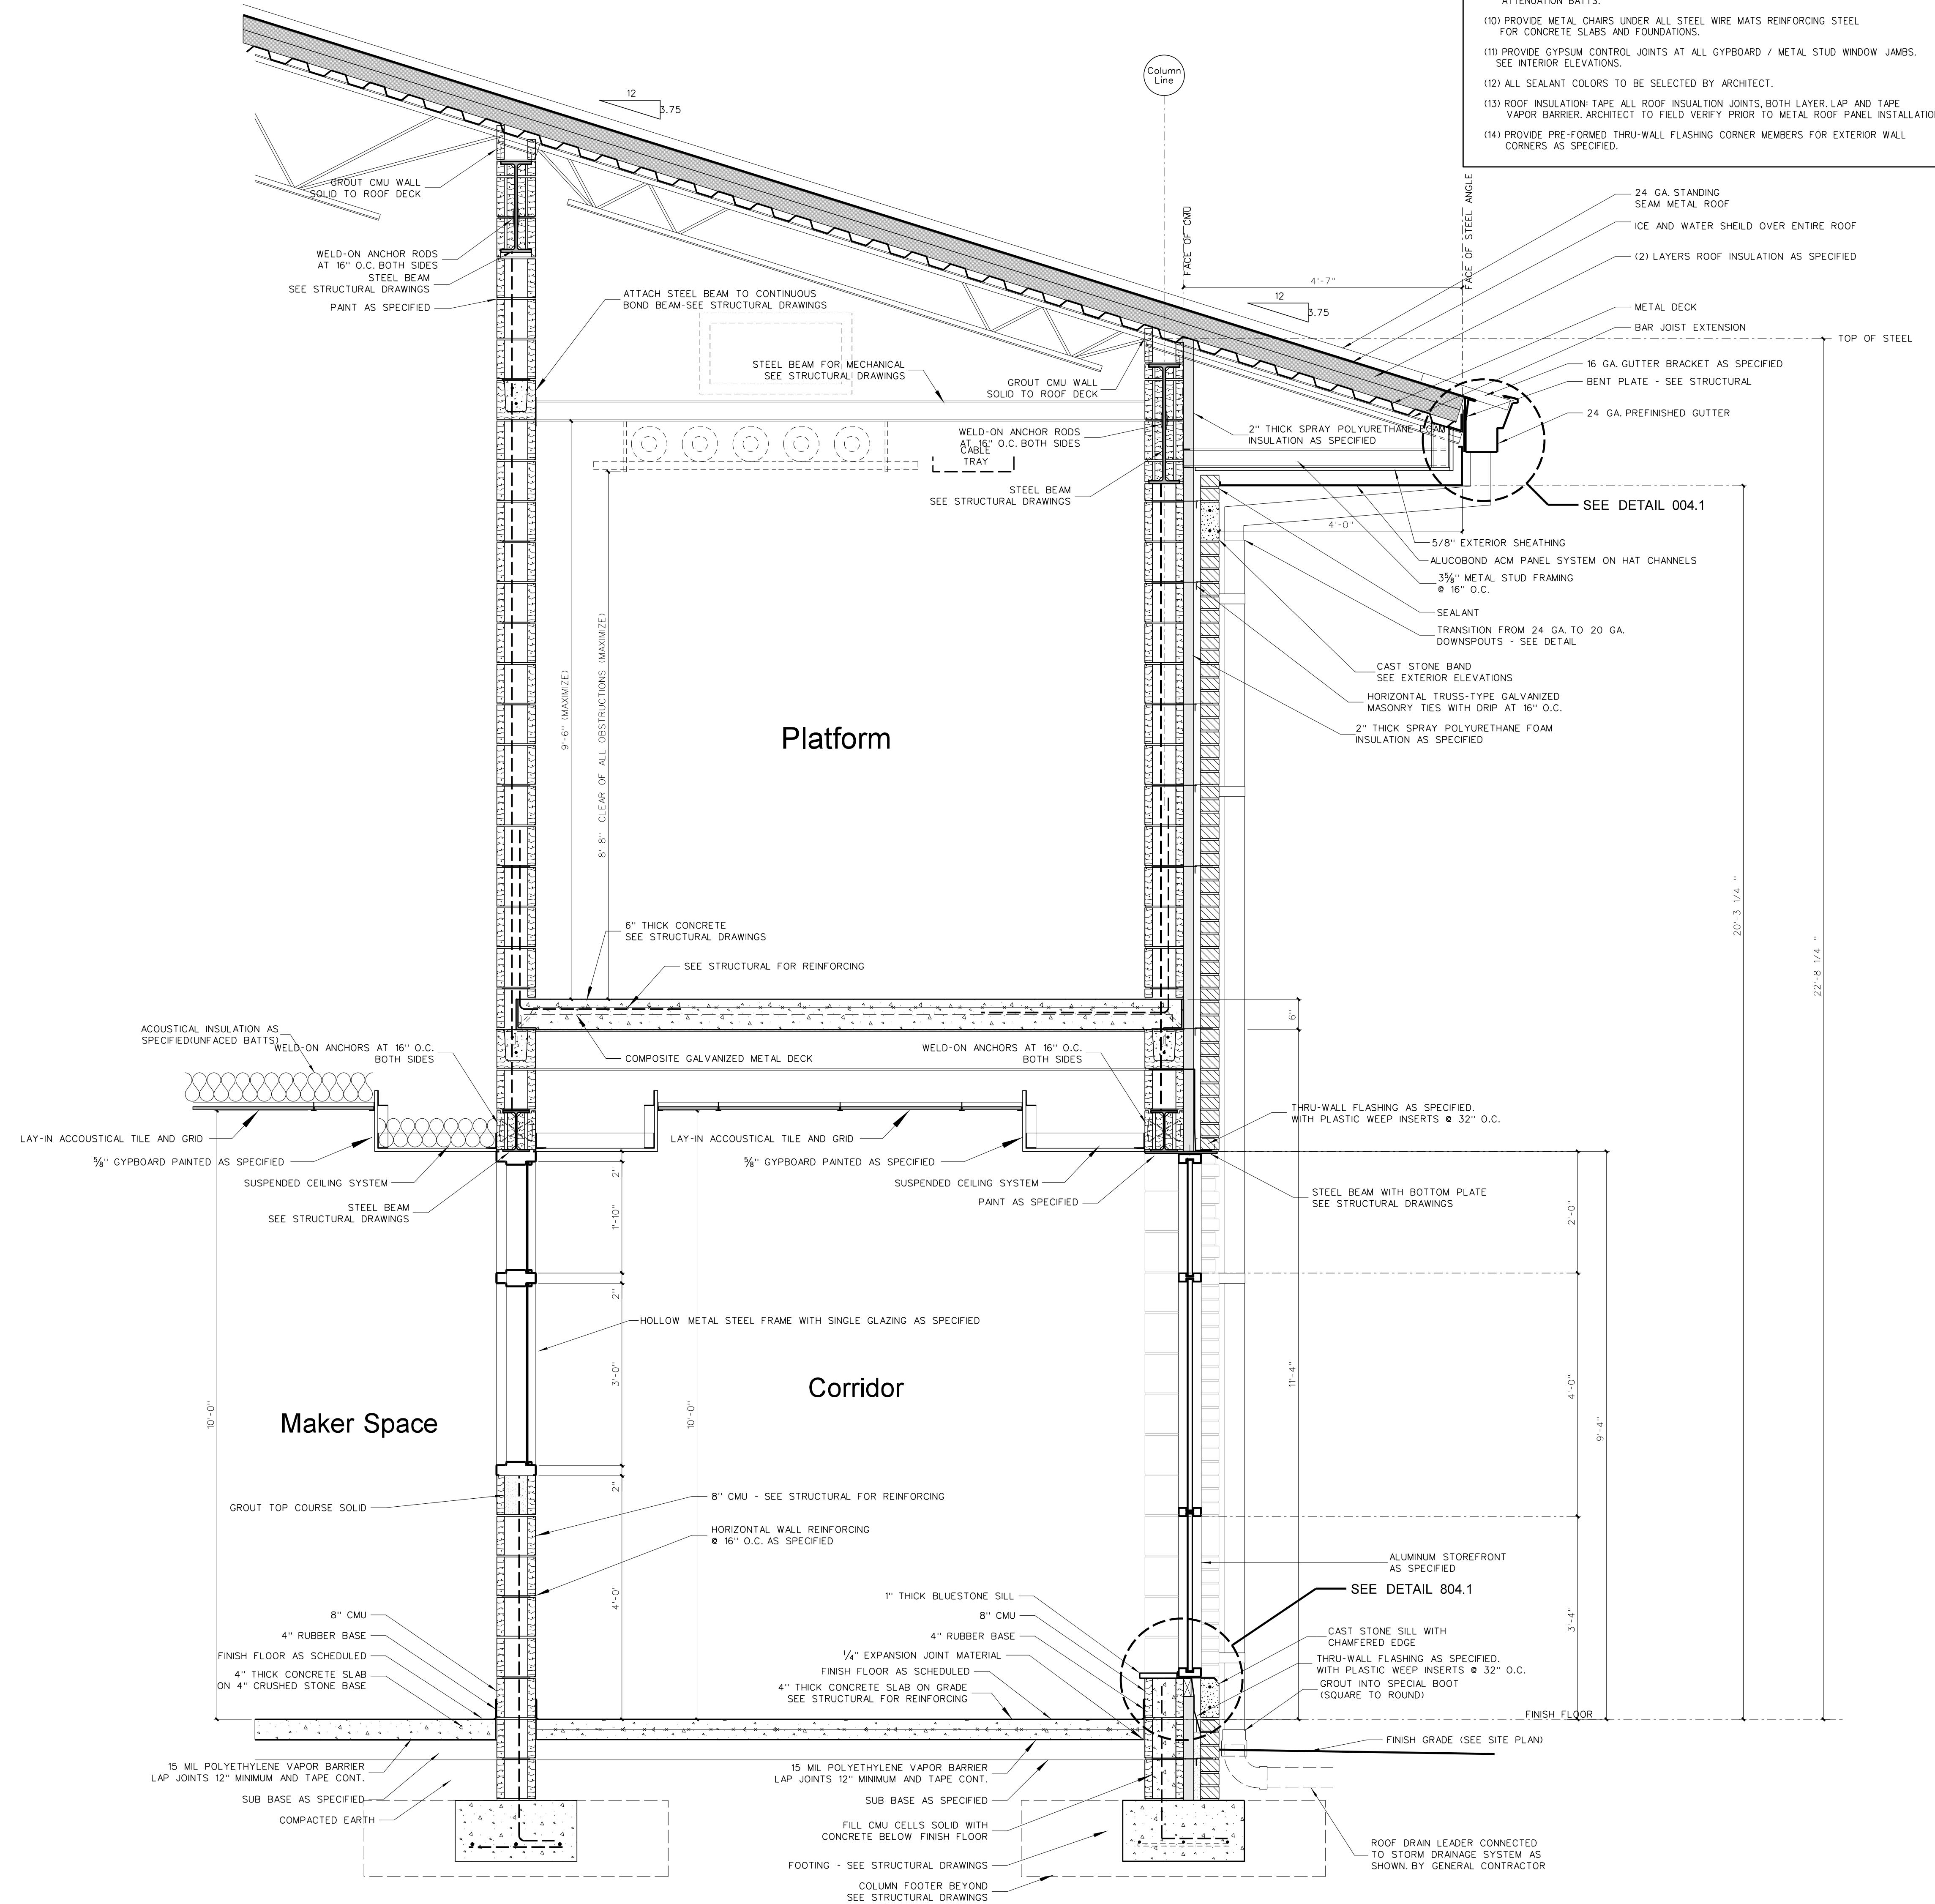

813.1 SECTION AT PLATFORM
SCALE: 3/4" = 1'-0"

No.	Date	Revision

Hite associates
ARCHITECTURE / PLANNING / TECHNOLOGY
2600 Meridian Drive / Greenville, NC 27834 / tel (252) 757-0333




Beaufort PK-3 School
BEAUFORT COUNTY SCHOOLS
Washington / North Carolina / 27889

Project No.	22344
Date:	1 July 2024
Drawing no.	A 813

General Notes for Wall Sections


- (1) SEE EXTERIOR ELEVATIONS FOR BRICK COLOR.
- (2) GENERAL CONTRACTOR SHALL VERIFY TOP OF FINISH GRADES, TOP OF CONCRETE WALKS AND TOP OF CONCRETE SLABS ADJACENT TO BUILDING AND ADJUST LOCATION OF THROUGH WALL FLASHING ACCORDINGLY.
- (3) PROVIDE PLASTIC INSERT WEEPS AT ALL AT DOOR, WINDOW AND FLOOR FLASHING.
- (4) GENERAL CONTRACTOR SHALL SLOPE CONCRETE FLOOR TO FLOOR DRAINS AS SHOWN ON PLUMBING DRAWINGS.
- (5) ALL CMU CELLS BELOW FINISH FLOOR SHALL BE FILLED WITH CONCRETE.
- (6) ALL VAPOR BARRIERS UNDER FLOOR SLABS SHALL BE LAPPED 12" MINIMUM AND TAPED CONTINUOUS AT JOINTS. GENERAL CONTRACTOR SHALL REPAIR ANY DAMAGED VAPOR BARRIER PRIOR TO PLACING CONCRETE.
- (7) PROVIDE 4" MINIMUM SPRAY POLYURETHANE INSULATION IN ALL METAL STUDS EXTERIOR WALLS. SEE WALL SECTIONS AND SPECIFICATIONS.
- (8) PROVIDE SPRAY POLYURETHANE INSULATION IN ALL NESTED METAL STUD WINDOW AND DOOR JAMBS, SILLS AND HEADS.
- (9) ALL INTERIOR METAL STUD/GYPSUM WALLBOARD PARTITIONS REQUIRE SOUND ATTENUATION BATTS.
- (10) PROVIDE METAL CHAIRS UNDER ALL STEEL WIRE MATS REINFORCING STEEL FOR CONCRETE SLABS AND FOUNDATIONS.
- (11) PROVIDE GYPSUM CONTROL JOINTS AT ALL GYPSUM / METAL STUD WINDOW JAMBS. SEE INTERIOR ELEVATIONS.
- (12) ALL SEALANT COLORS TO BE SELECTED BY ARCHITECT.
- (13) ROOF INSULATION TAPE ALL ROOF INSULATION JOINTS, BOTH LAYER LAP AND TAPE VAPOR BARRIER. ARCHITECT TO FIELD VERIFY PRIOR TO METAL ROOF PANEL INSTALLATION.
- (14) PROVIDE PRE-FORMED THRU-WALL FLASHING CORNER MEMBERS FOR EXTERIOR WALL CORNERS AS SPECIFIED.

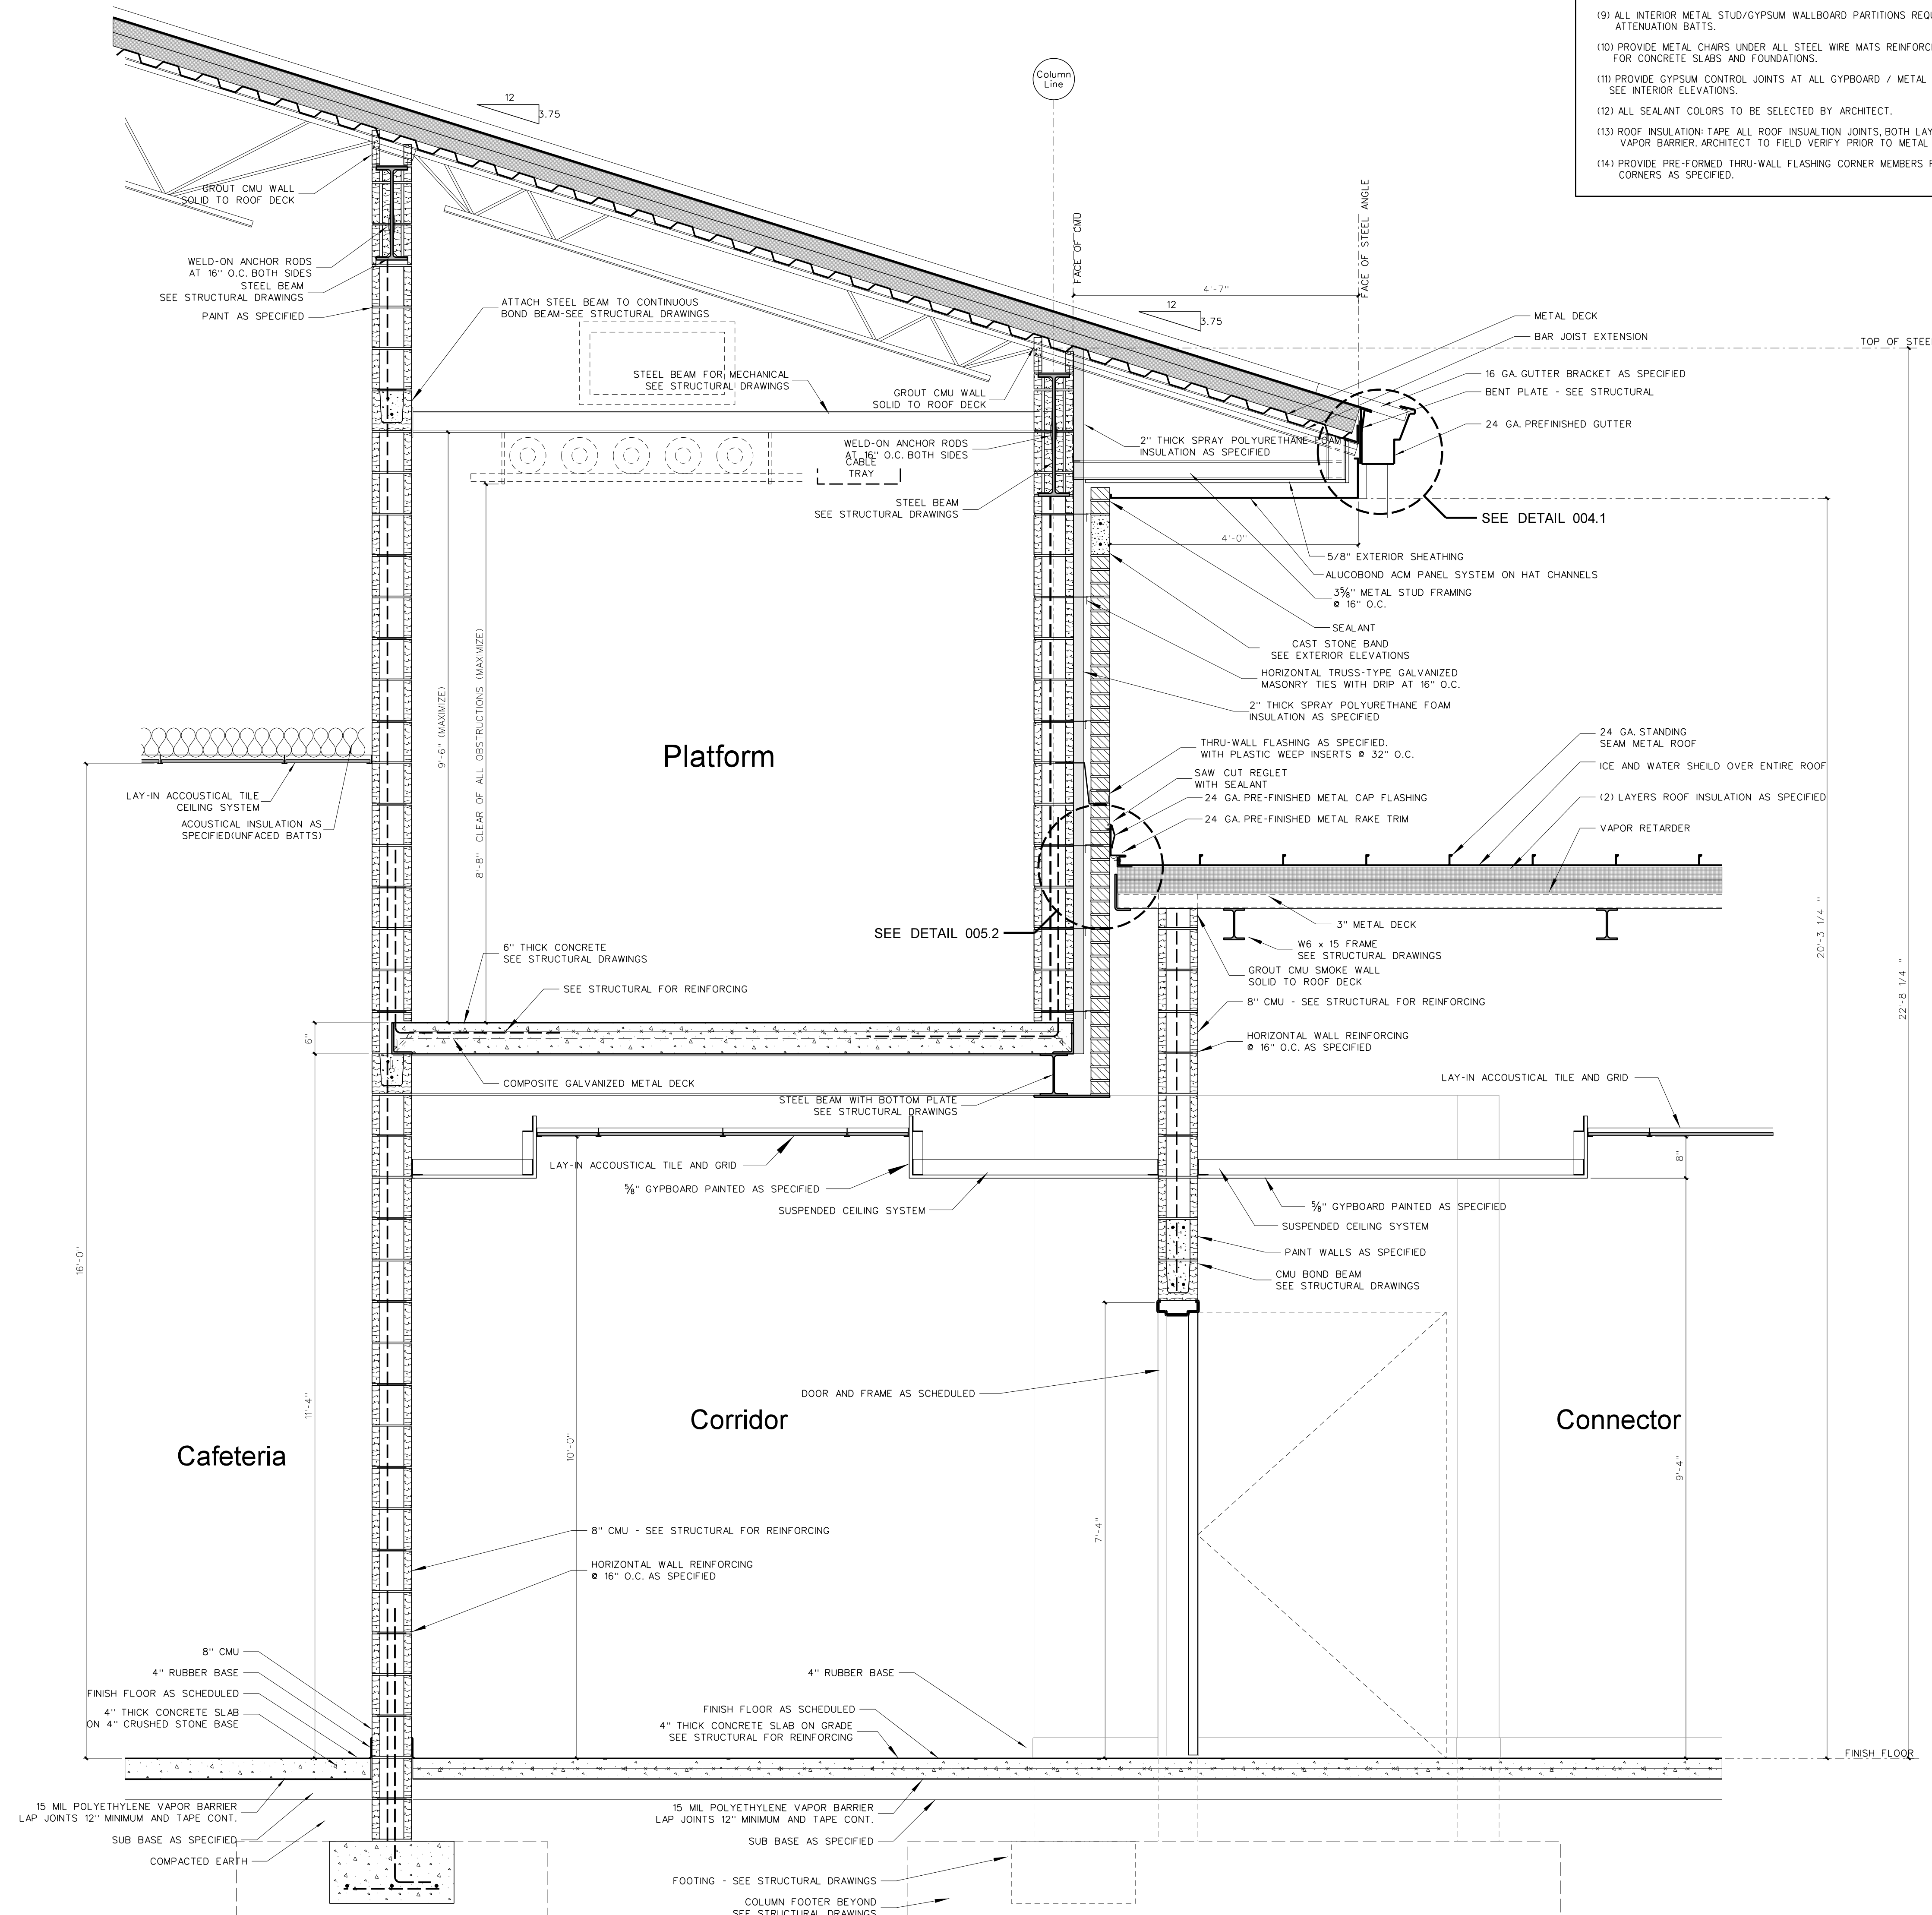

814.1 SECTION AT PLATFORM AND CONNECTOR
SCALE: 3/4" = 1'-0"

No.	Date	Revision

Hite associates
ARCHITECTURE / PLANNING / TECHNOLOGY
2600 Meridian Drive / Greenville, NC 27834 / tel (252) 757-0333

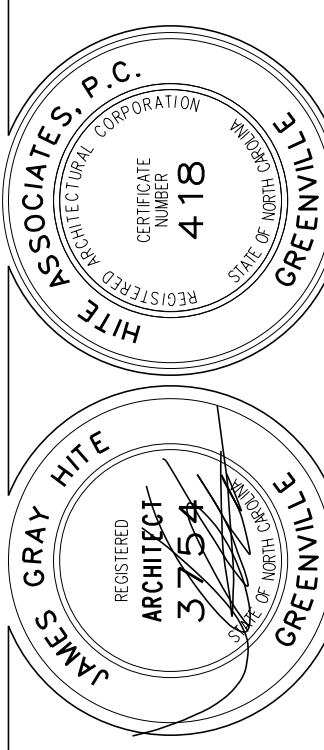


Beaufort PK-3 School
BEAUFORT COUNTY SCHOOLS
Washington / North Carolina / 727889

Project No.	22344
Date:	1 July 2024
Drawing no.	A 814

General Notes for Wall Sections


- (1) SEE EXTERIOR ELEVATIONS FOR BRICK COLOR.
- (2) GENERAL CONTRACTOR SHALL VERIFY TOP OF FINISH GRADES, TOP OF CONCRETE WALLS AND TOP OF CONCRETE SLABS ADJACENT TO BUILDING AND ADJUST LOCATION OF THROUGH WALL FLASHINGS ACCORDINGLY.
- (3) PROVIDE PLASTIC INSERT WEEPS AT ALL AT DOOR, WINDOW AND FLOOR FLASHING.
- (4) GENERAL CONTRACTOR SHALL SLOPE CONCRETE FLOOR TO FLOOR DRAINS AS SHOWN ON PLUMBING DRAWINGS.
- (5) ALL CMU CELLS BELOW FINISH FLOOR SHALL BE FILLED WITH CONCRETE.
- (6) ALL VAPOR BARRIERS UNDER FLOOR SLABS SHALL BE LAPPED 12" MINIMUM AND TAPED CONTINUOUS AT JOINTS. GENERAL CONTRACTOR SHALL REPAIR ANY DAMAGED VAPOR BARRIER PRIOR TO PLACING CONCRETE.
- (7) PROVIDE 4" MINIMUM SPRAY POLYURETHANE INSULATION IN ALL METAL STUDS EXTERIOR WALLS. SEE WALL SECTIONS AND SPECIFICATIONS.
- (8) PROVIDE SPRAY POLYURETHANE INSULATION IN ALL NESTED METAL STUD WINDOW AND DOOR JAMBS, SILLS AND HEADS.
- (9) ALL INTERIOR METAL STUD/GYPSUM WALLBOARD PARTITIONS REQUIRE SOUND ATTENUATION BATTS.
- (10) PROVIDE METAL CHAIRS UNDER ALL STEEL WIRE MATS REINFORCING STEEL FOR CONCRETE SLABS AND FOUNDATIONS.
- (11) PROVIDE GYPSUM CONTROL JOINTS AT ALL GYPSUM / METAL STUD WINDOW JAMBS. SEE INTERIOR ELEVATIONS.
- (12) ALL SEALANT COLORS TO BE SELECTED BY ARCHITECT.
- (13) ROOF INSULATION: TAPE ALL ROOF INSULATION JOINTS, BOTH LAYER LAP AND TAPE VAPOR BARRIER. ARCHITECT TO FIELD VERIFY PRIOR TO METAL ROOF PANEL INSTALLATION.
- (14) PROVIDE PRE-FORMED THRU-WALL FLASHING CORNER MEMBERS FOR EXTERIOR WALL CORNERS AS SPECIFIED.

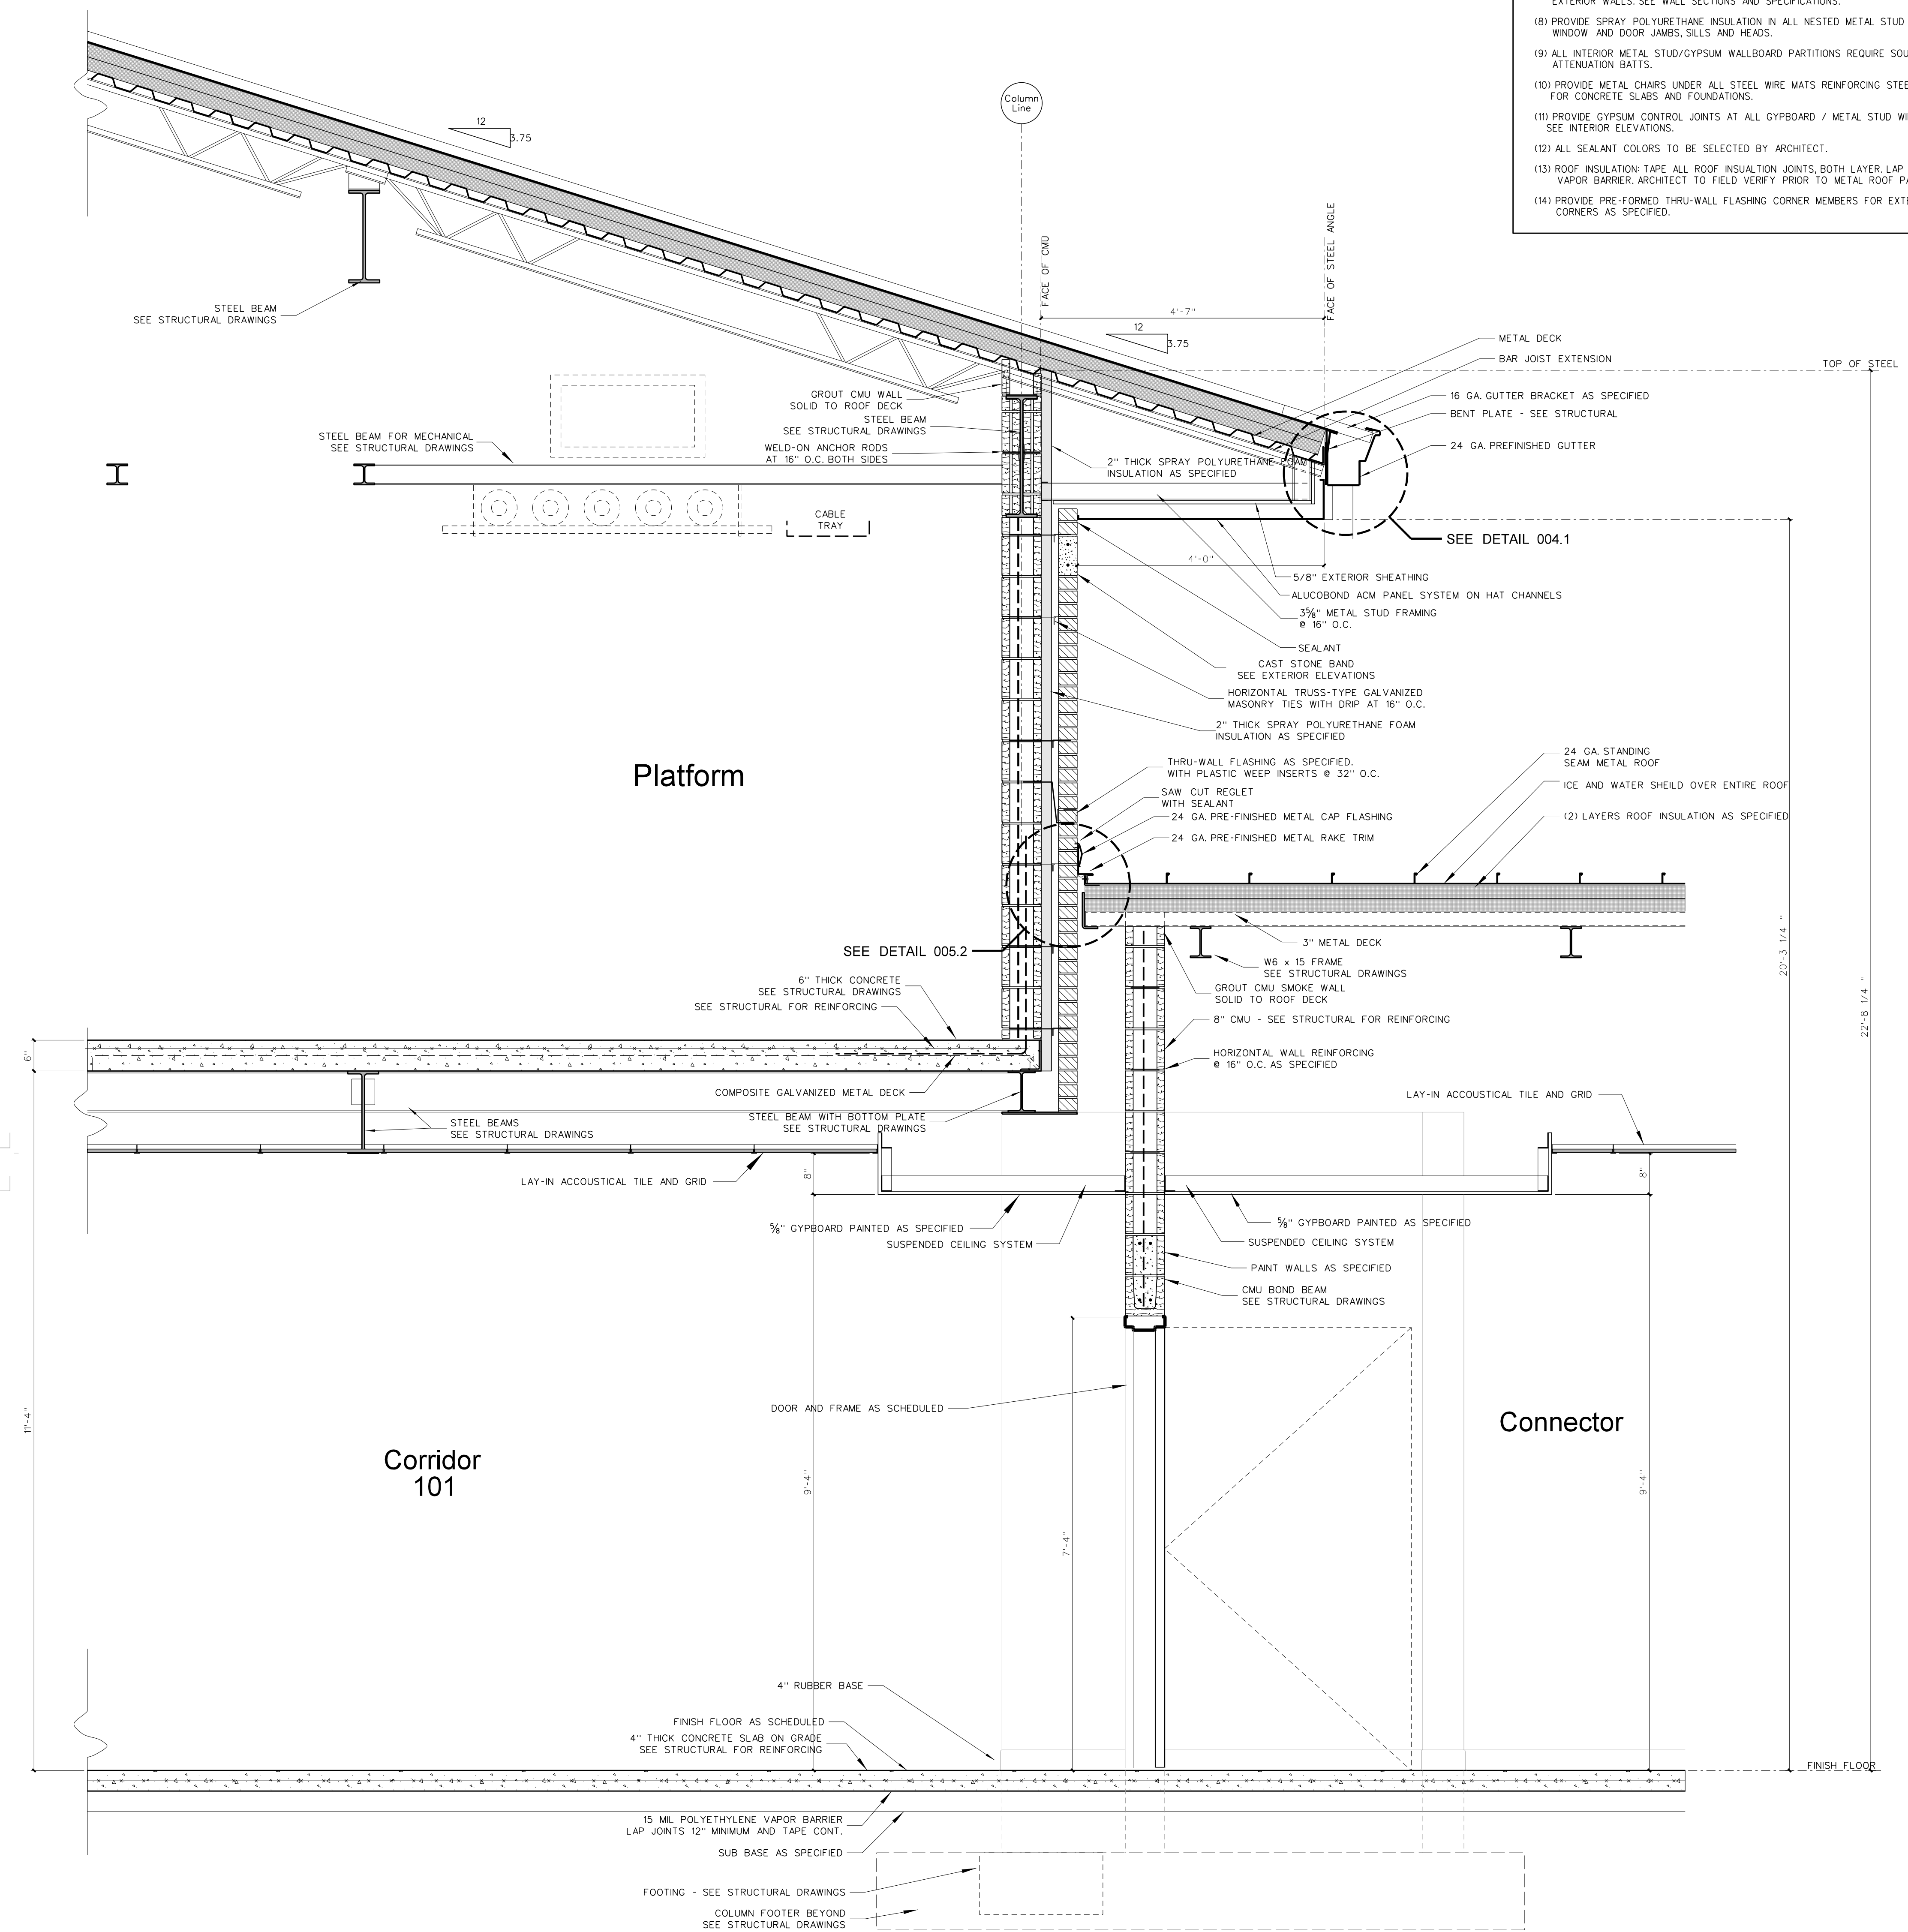

815.1 SECTION AT PLATFORM AND CONNECTOR
SCALE: 3/4" = 1'-0"

No.	Date	Revision

Hite associates
ARCHITECTURE / PLANNING / TECHNOLOGY
2600 Meridian Drive / Greenville, NC 27834 / tel (252) 757-0333

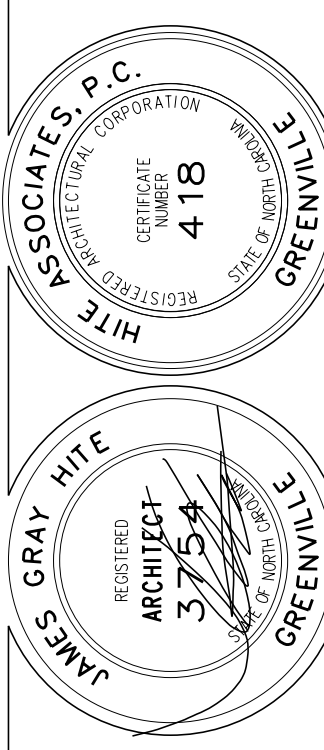

Beaufort PK-3 School
BEAUFORT COUNTY SCHOOLS
Washington / North Carolina / 27889

Project No. 22344


Date: 1 July 2024

Drawing No.

A
815

General Notes for Wall Sections


- (1) SEE EXTERIOR ELEVATIONS FOR BRICK COLOR.
- (2) GENERAL CONTRACTOR SHALL VERIFY TOP OF FINISH GRADES, TOP OF CONCRETE WALKS AND TOP OF CONCRETE SLABS ADJACENT TO BUILDING AND ADJUST LOCATION OF THROUGH WALL FLASHING ACCORDINGLY.
- (3) PROVIDE PLASTIC INSERT WEEPS AT ALL AT DOOR, WINDOW AND FLOOR FLASHING.
- (4) GENERAL CONTRACTOR SHALL SLOPE CONCRETE FLOOR TO FLOOR DRAINS AS SHOWN ON PLUMBING DRAWINGS.
- (5) ALL CMU CELLS BELOW FINISH FLOOR SHALL BE FILLED WITH CONCRETE.
- (6) ALL VAPOR BARRIERS UNDER FLOOR SLABS SHALL BE LAPPED 12" MINIMUM AND TAPED CONTINUOUS AT JOINTS. GENERAL CONTRACTOR SHALL REPAIR ANY DAMAGED VAPOR BARRIER PRIOR TO PLACING CONCRETE.
- (7) PROVIDE 4" MINIMUM SPRAY POLYURETHANE INSULATION IN ALL METAL STUDS EXTERIOR WALLS. SEE WALL SECTIONS AND SPECIFICATIONS.
- (8) PROVIDE SPRAY POLYURETHANE INSULATION IN ALL NESTED METAL STUD WINDOW AND DOOR JAMBS, SILLS AND HEADS.
- (9) ALL INTERIOR METAL STUD/GYPSUM WALLBOARD PARTITIONS REQUIRE SOUND ATTENUATION BATTS.
- (10) PROVIDE METAL CHAIRS UNDER ALL STEEL WIRE MATS REINFORCING STEEL FOR CONCRETE SLABS AND FOUNDATIONS.
- (11) PROVIDE GYPSUM CONTROL JOINTS AT ALL GYPSUM / METAL STUD WINDOW JAMBS. SEE INTERIOR ELEVATIONS.
- (12) ALL SEALANT COLORS TO BE SELECTED BY ARCHITECT.
- (13) ROOF INSULATION TAPE ALL ROOF INSULATION JOINTS, BOTH LAYER LAP AND TAPE VAPOR BARRIER ARCHITECT TO FIELD VERIFY PRIOR TO METAL ROOF PANEL INSTALLATION.
- (14) PROVIDE PRE-FORMED THRU-WALL FLASHING CORNER MEMBERS FOR EXTERIOR WALL CORNERS AS SPECIFIED.

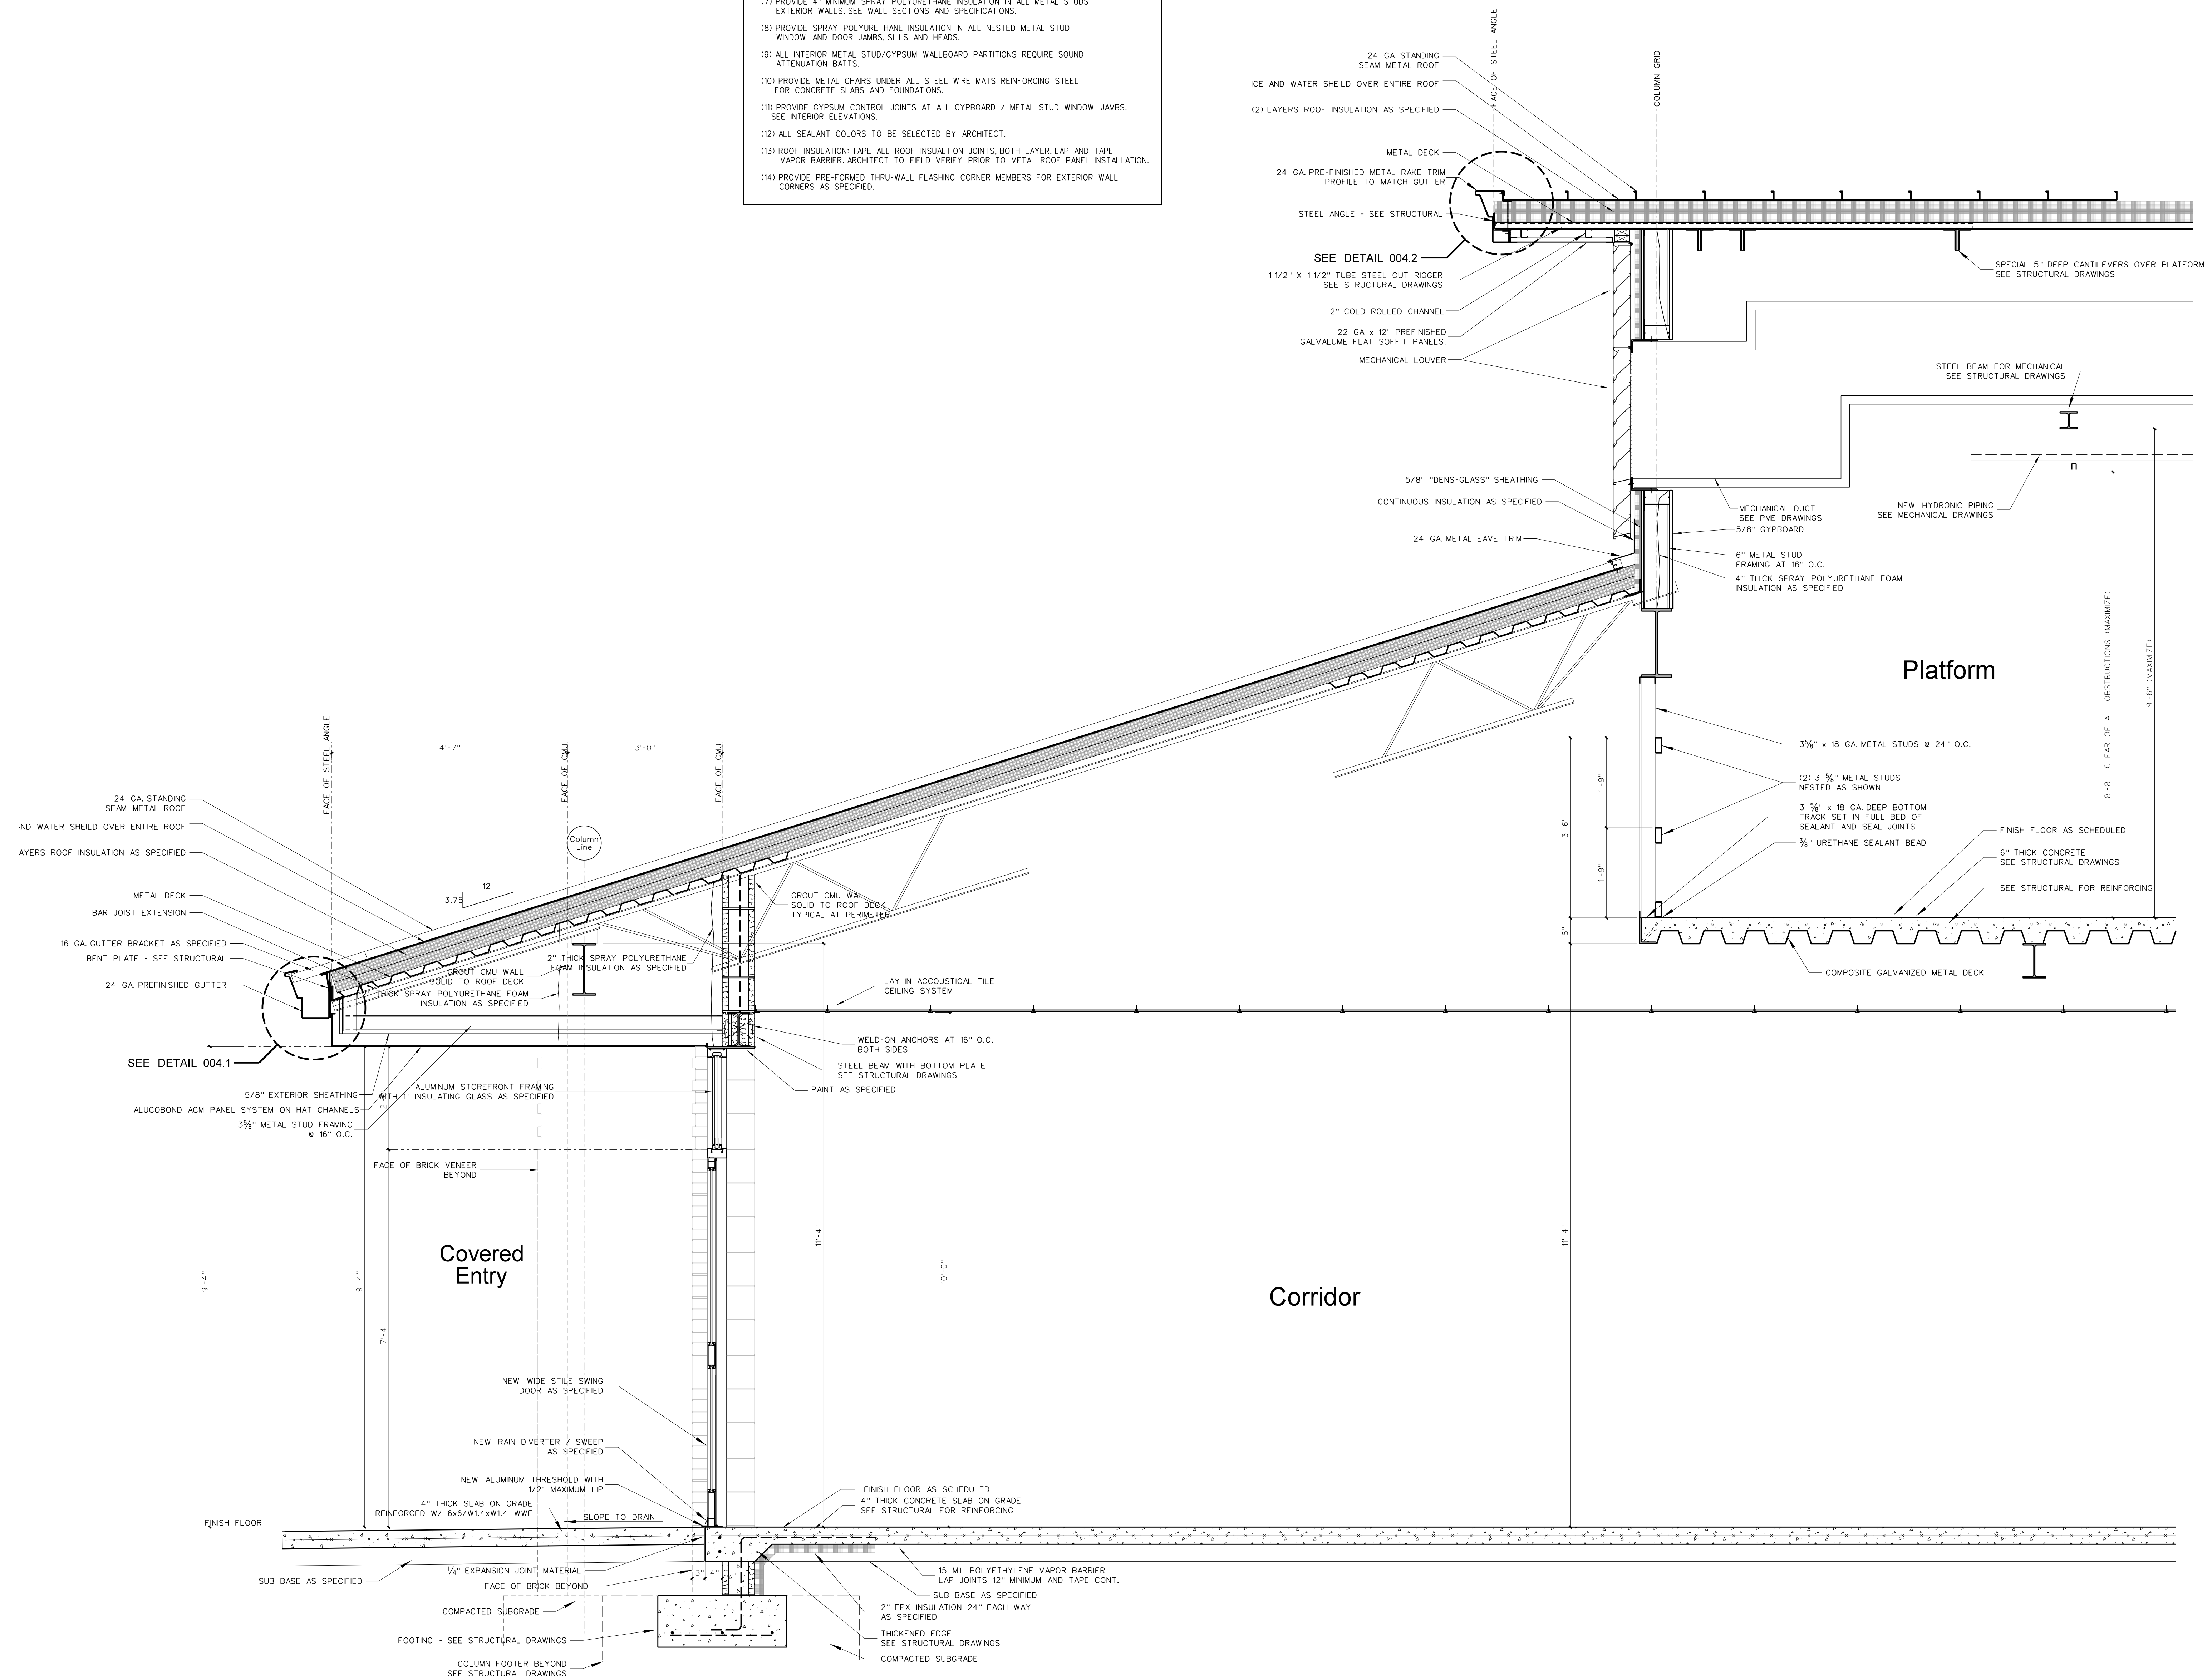

816.1 SECTION AT PLATFORM END WALL
SCALE: 3/4" = 1'-0"

No.	Date	Revision


Hite associates
ARCHITECTURE / PLANNING / TECHNOLOGY
2600 Meridian Drive / Greenville, NC 27834 / tel (252) 757-0333

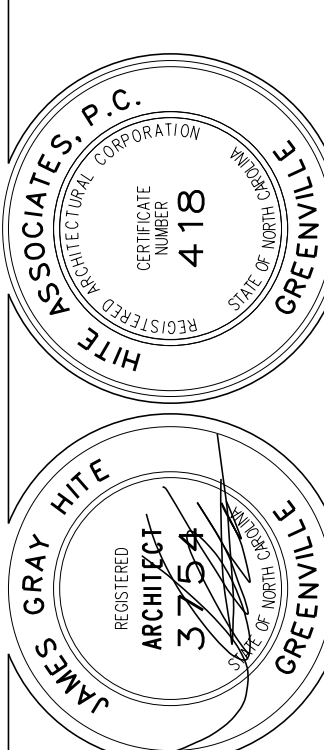


Beaufort PK-3 School
BEAUFORT COUNTY SCHOOLS
Washington / North Carolina / 27889

Project No.	22344
Date:	1 July 2024
Drawing no.	A 816


- General Notes for Wall Sections**
- (1) SEE EXTERIOR ELEVATIONS FOR BRICK COLOR.
 - (2) GENERAL CONTRACTOR SHALL VERIFY TOP OF FINISH GRADES, TOP OF CONCRETE WALKS AND TOP OF CONCRETE SLABS ADJACENT TO BUILDING AND ADJUST LOCATION OF THROUGH WALL FLASHING ACCORDINGLY.
 - (3) PROVIDE PLASTIC INSERT WEEPS AT ALL AT DOOR, WINDOW AND FLOOR FLASHING.
 - (4) GENERAL CONTRACTOR SHALL SLOPE CONCRETE FLOOR TO FLOOR DRAINS AS SHOWN ON PLUMBING DRAWINGS.
 - (5) ALL CMU CELLS BELOW FINISH FLOOR SHALL BE FILLED WITH CONCRETE.
 - (6) ALL VAPOR BARRIERS UNDER FLOOR SLABS SHALL BE LAPPED 12" MINIMUM AND TAPED CONTINUOUS AT JOINTS. GENERAL CONTRACTOR SHALL REPAIR ANY DAMAGED VAPOR BARRIER PRIOR TO PLACING CONCRETE.
 - (7) PROVIDE 4" MINIMUM SPRAY POLYURETHANE INSULATION IN ALL METAL STUDS EXTERIOR WALLS. SEE WALL SECTIONS AND SPECIFICATIONS.
 - (8) PROVIDE SPRAY POLYURETHANE INSULATION IN ALL NESTED METAL STUD WINDOW AND DOOR JAMBS, SILLS AND HEADS.
 - (9) ALL INTERIOR METAL STUD/GYPSUM WALLBOARD PARTITIONS REQUIRE SOUND ATTENUATION BATTS.
 - (10) PROVIDE METAL CHAIRS UNDER ALL STEEL WIRE MATS REINFORCING STEEL FOR CONCRETE SLABS AND FOUNDATIONS.
 - (11) PROVIDE GYPSUM CONTROL JOINTS AT ALL GYPSUM / METAL STUD WINDOW JAMBS. SEE INTERIOR ELEVATIONS.
 - (12) ALL SEALANT COLORS TO BE SELECTED BY ARCHITECT.
 - (13) ROOF INSULATION TAPE ALL ROOF INSULATION JOINTS, BOTH LAYER, LAP AND TAPE VAPOR BARRIER. ARCHITECT TO FIELD VERIFY PRIOR TO METAL ROOF PANEL INSTALLATION.
 - (14) PROVIDE PRE-FORMED THRU-WALL FLASHING CORNER MEMBERS FOR EXTERIOR WALL CORNERS AS SPECIFIED.

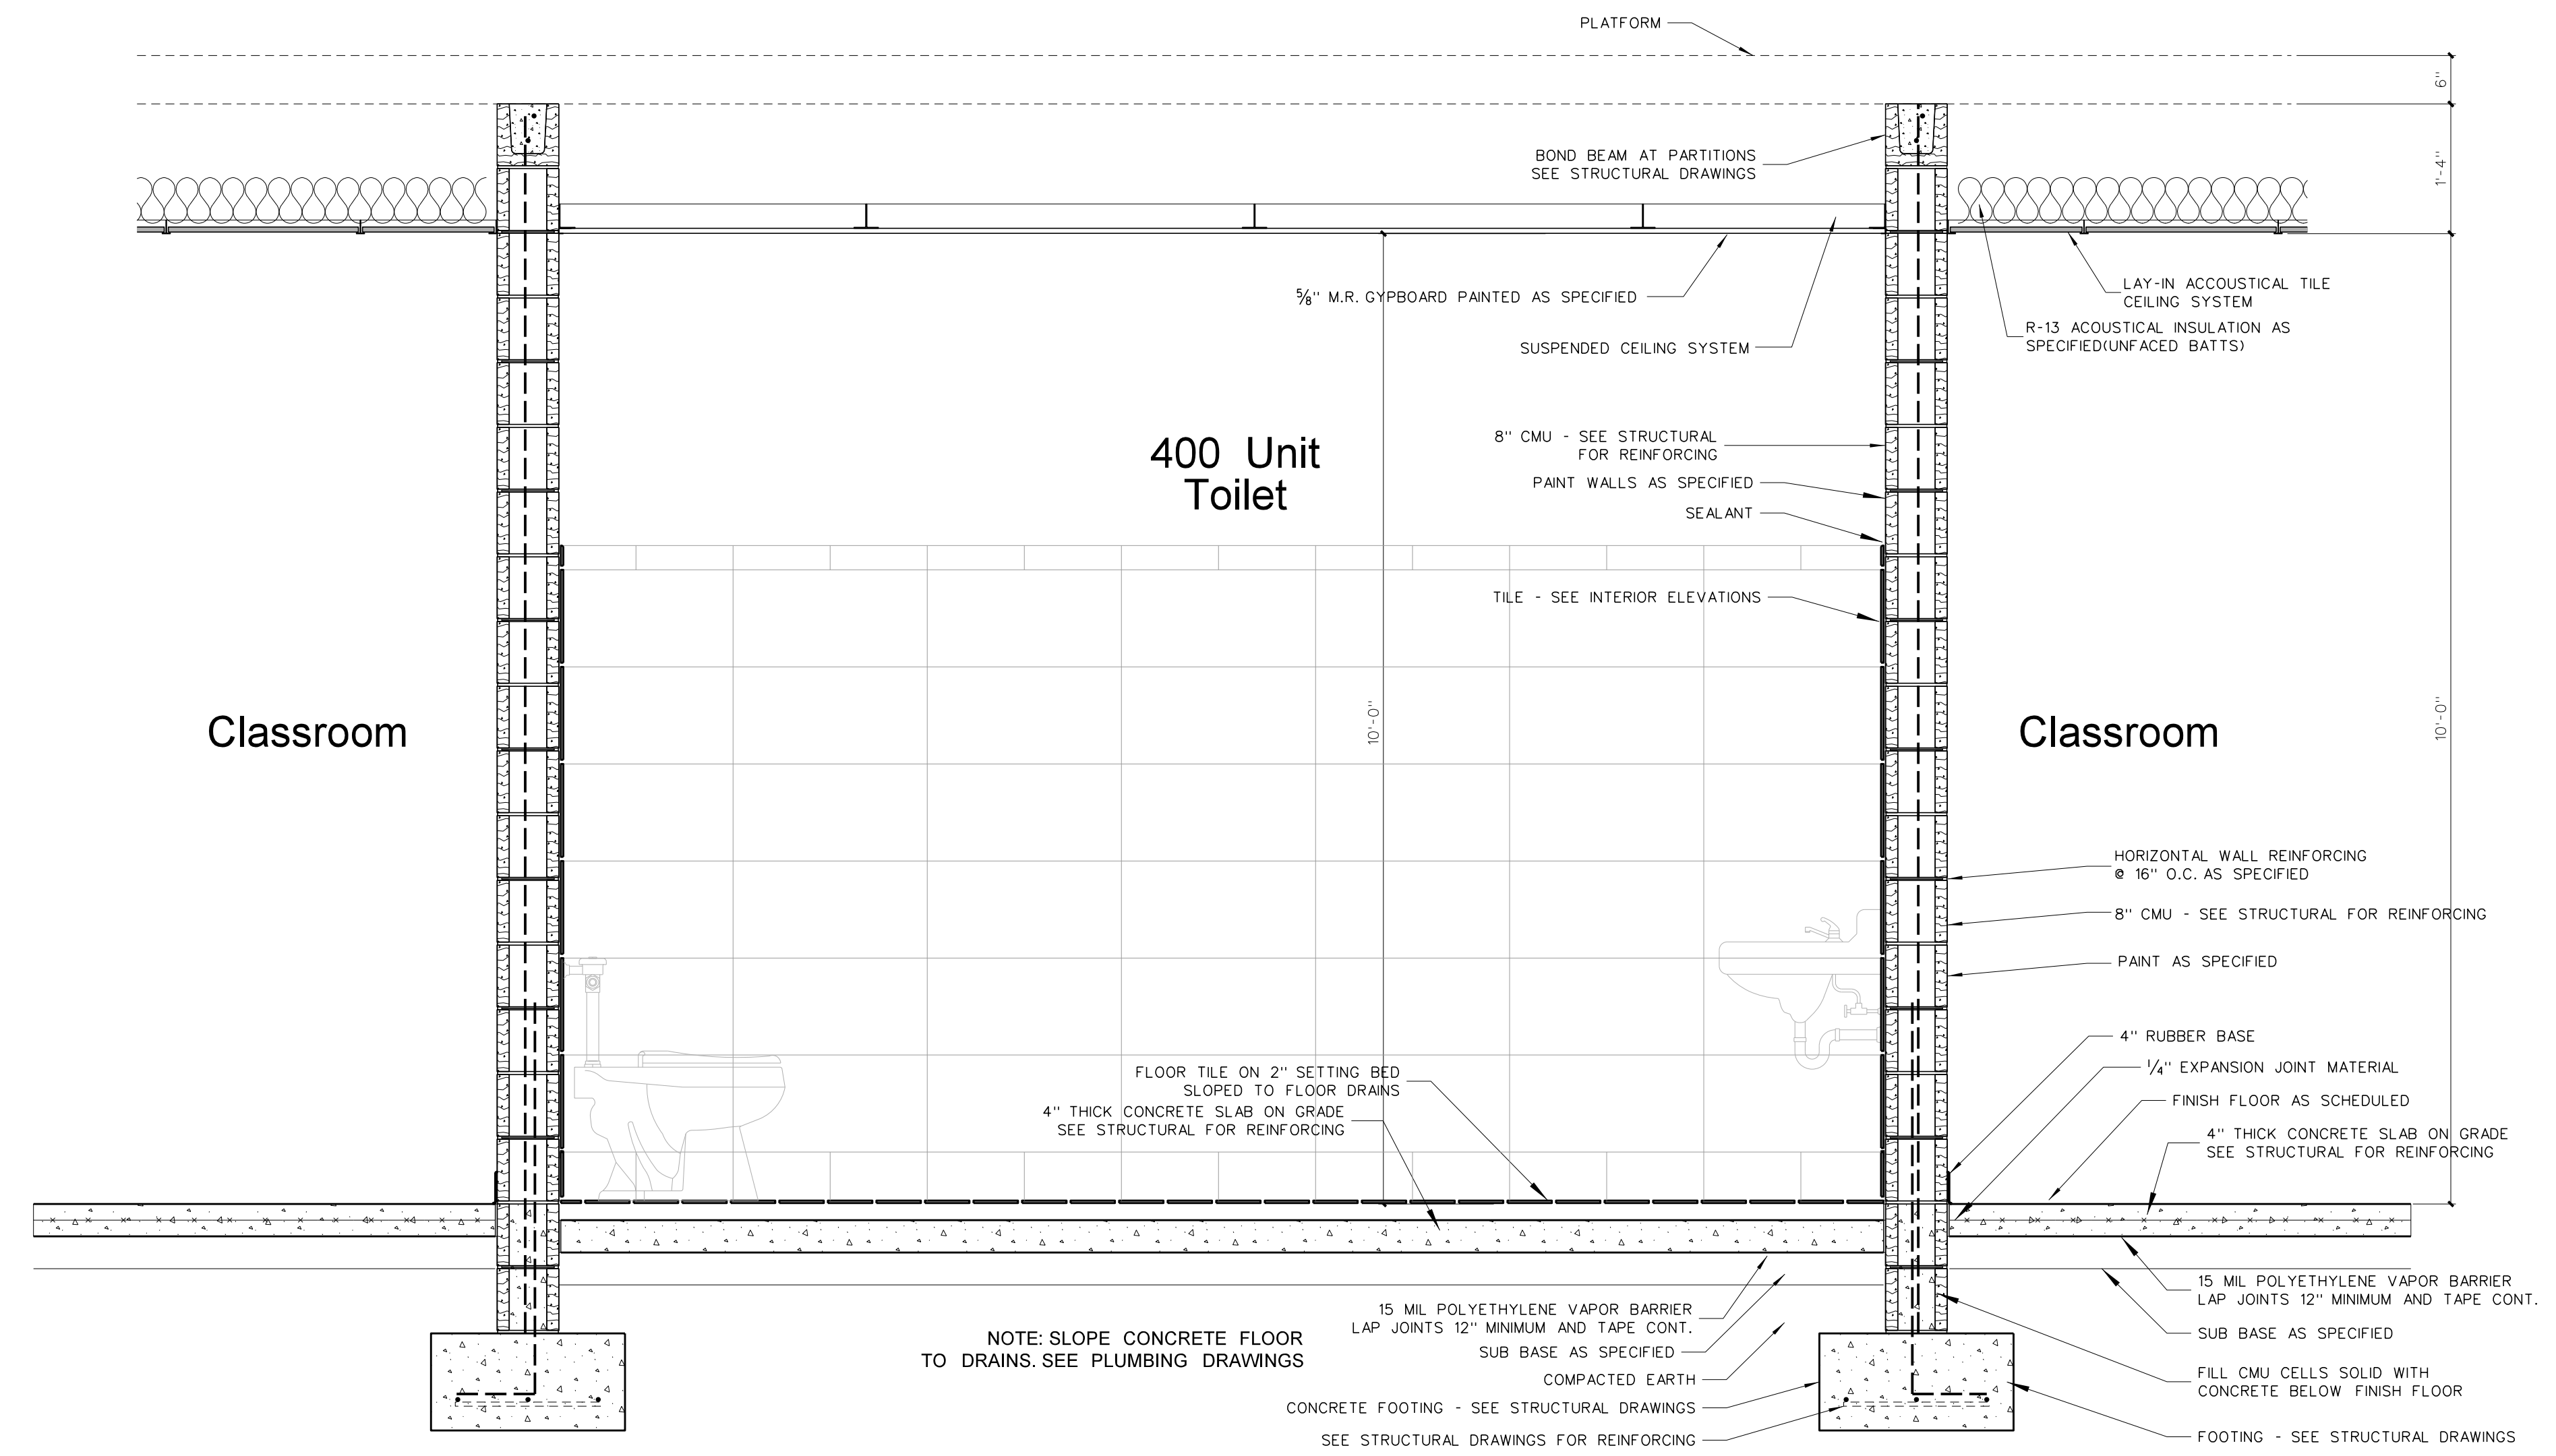

817.3 SECTION AT 400 UNIT TOILET
SCALE: 3/4" = 1'-0"

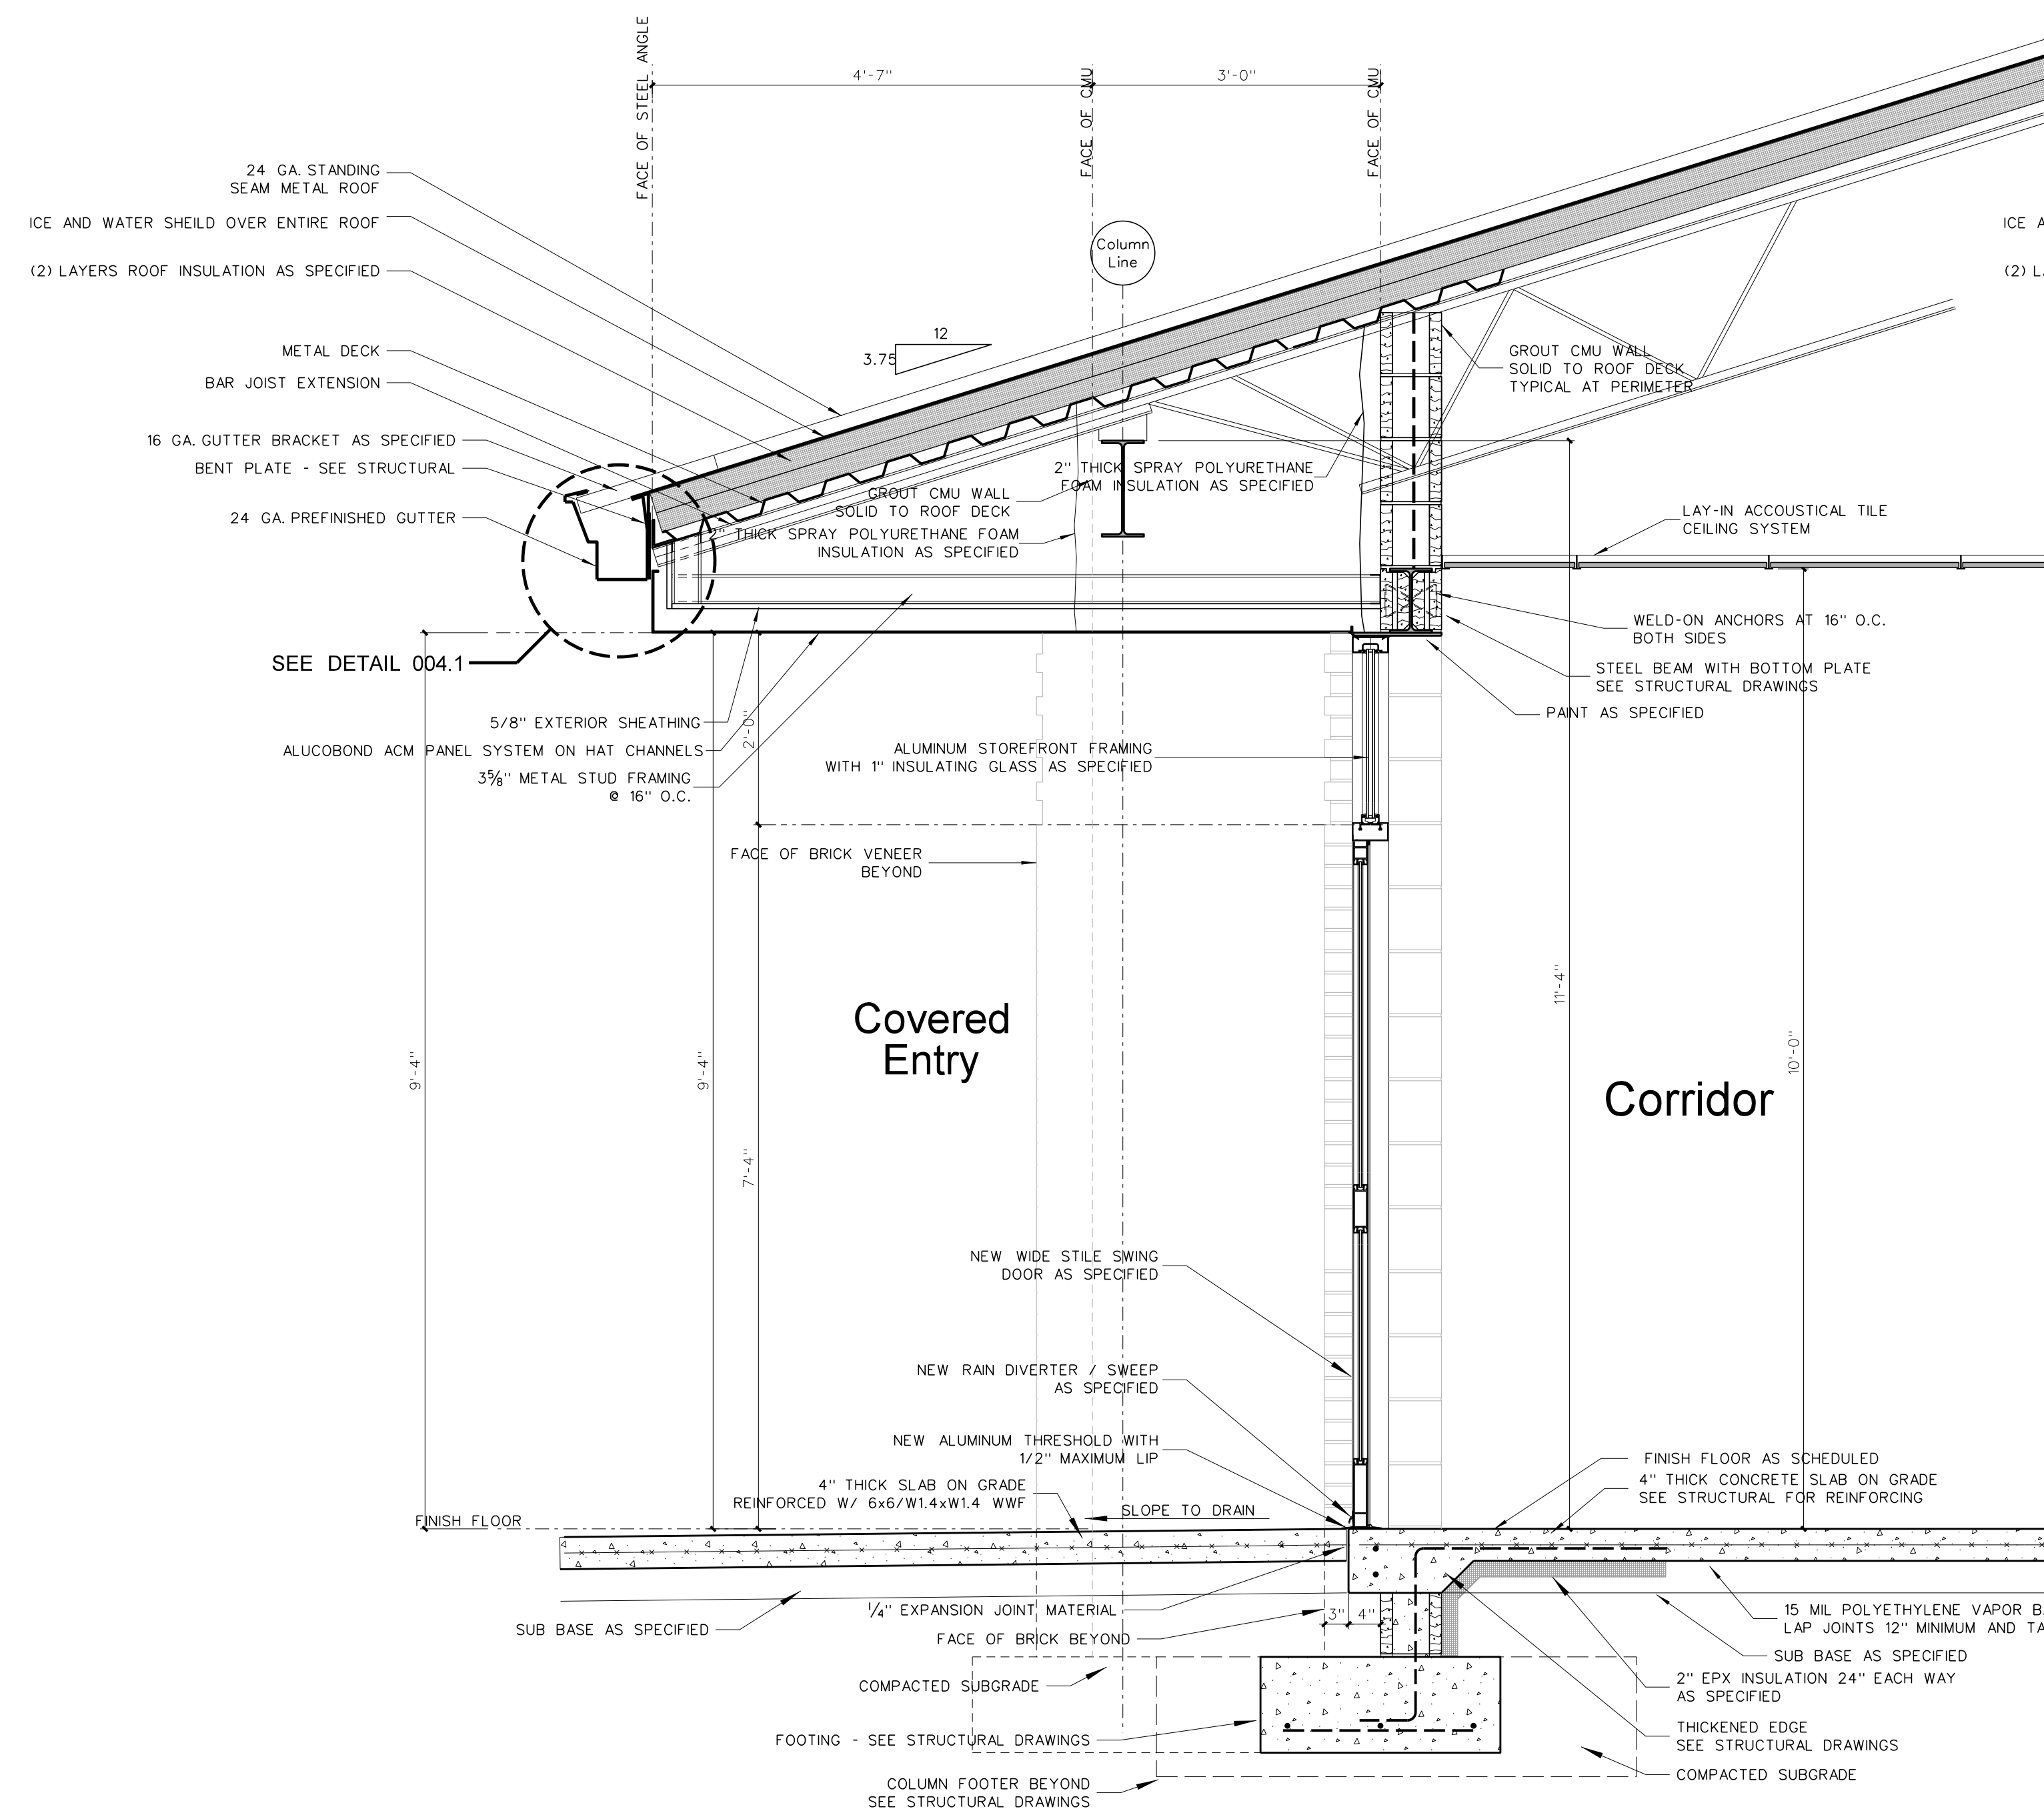


817.2 WALL SECTION AT ENTRY
SCALE: 3/4" = 1'-0"

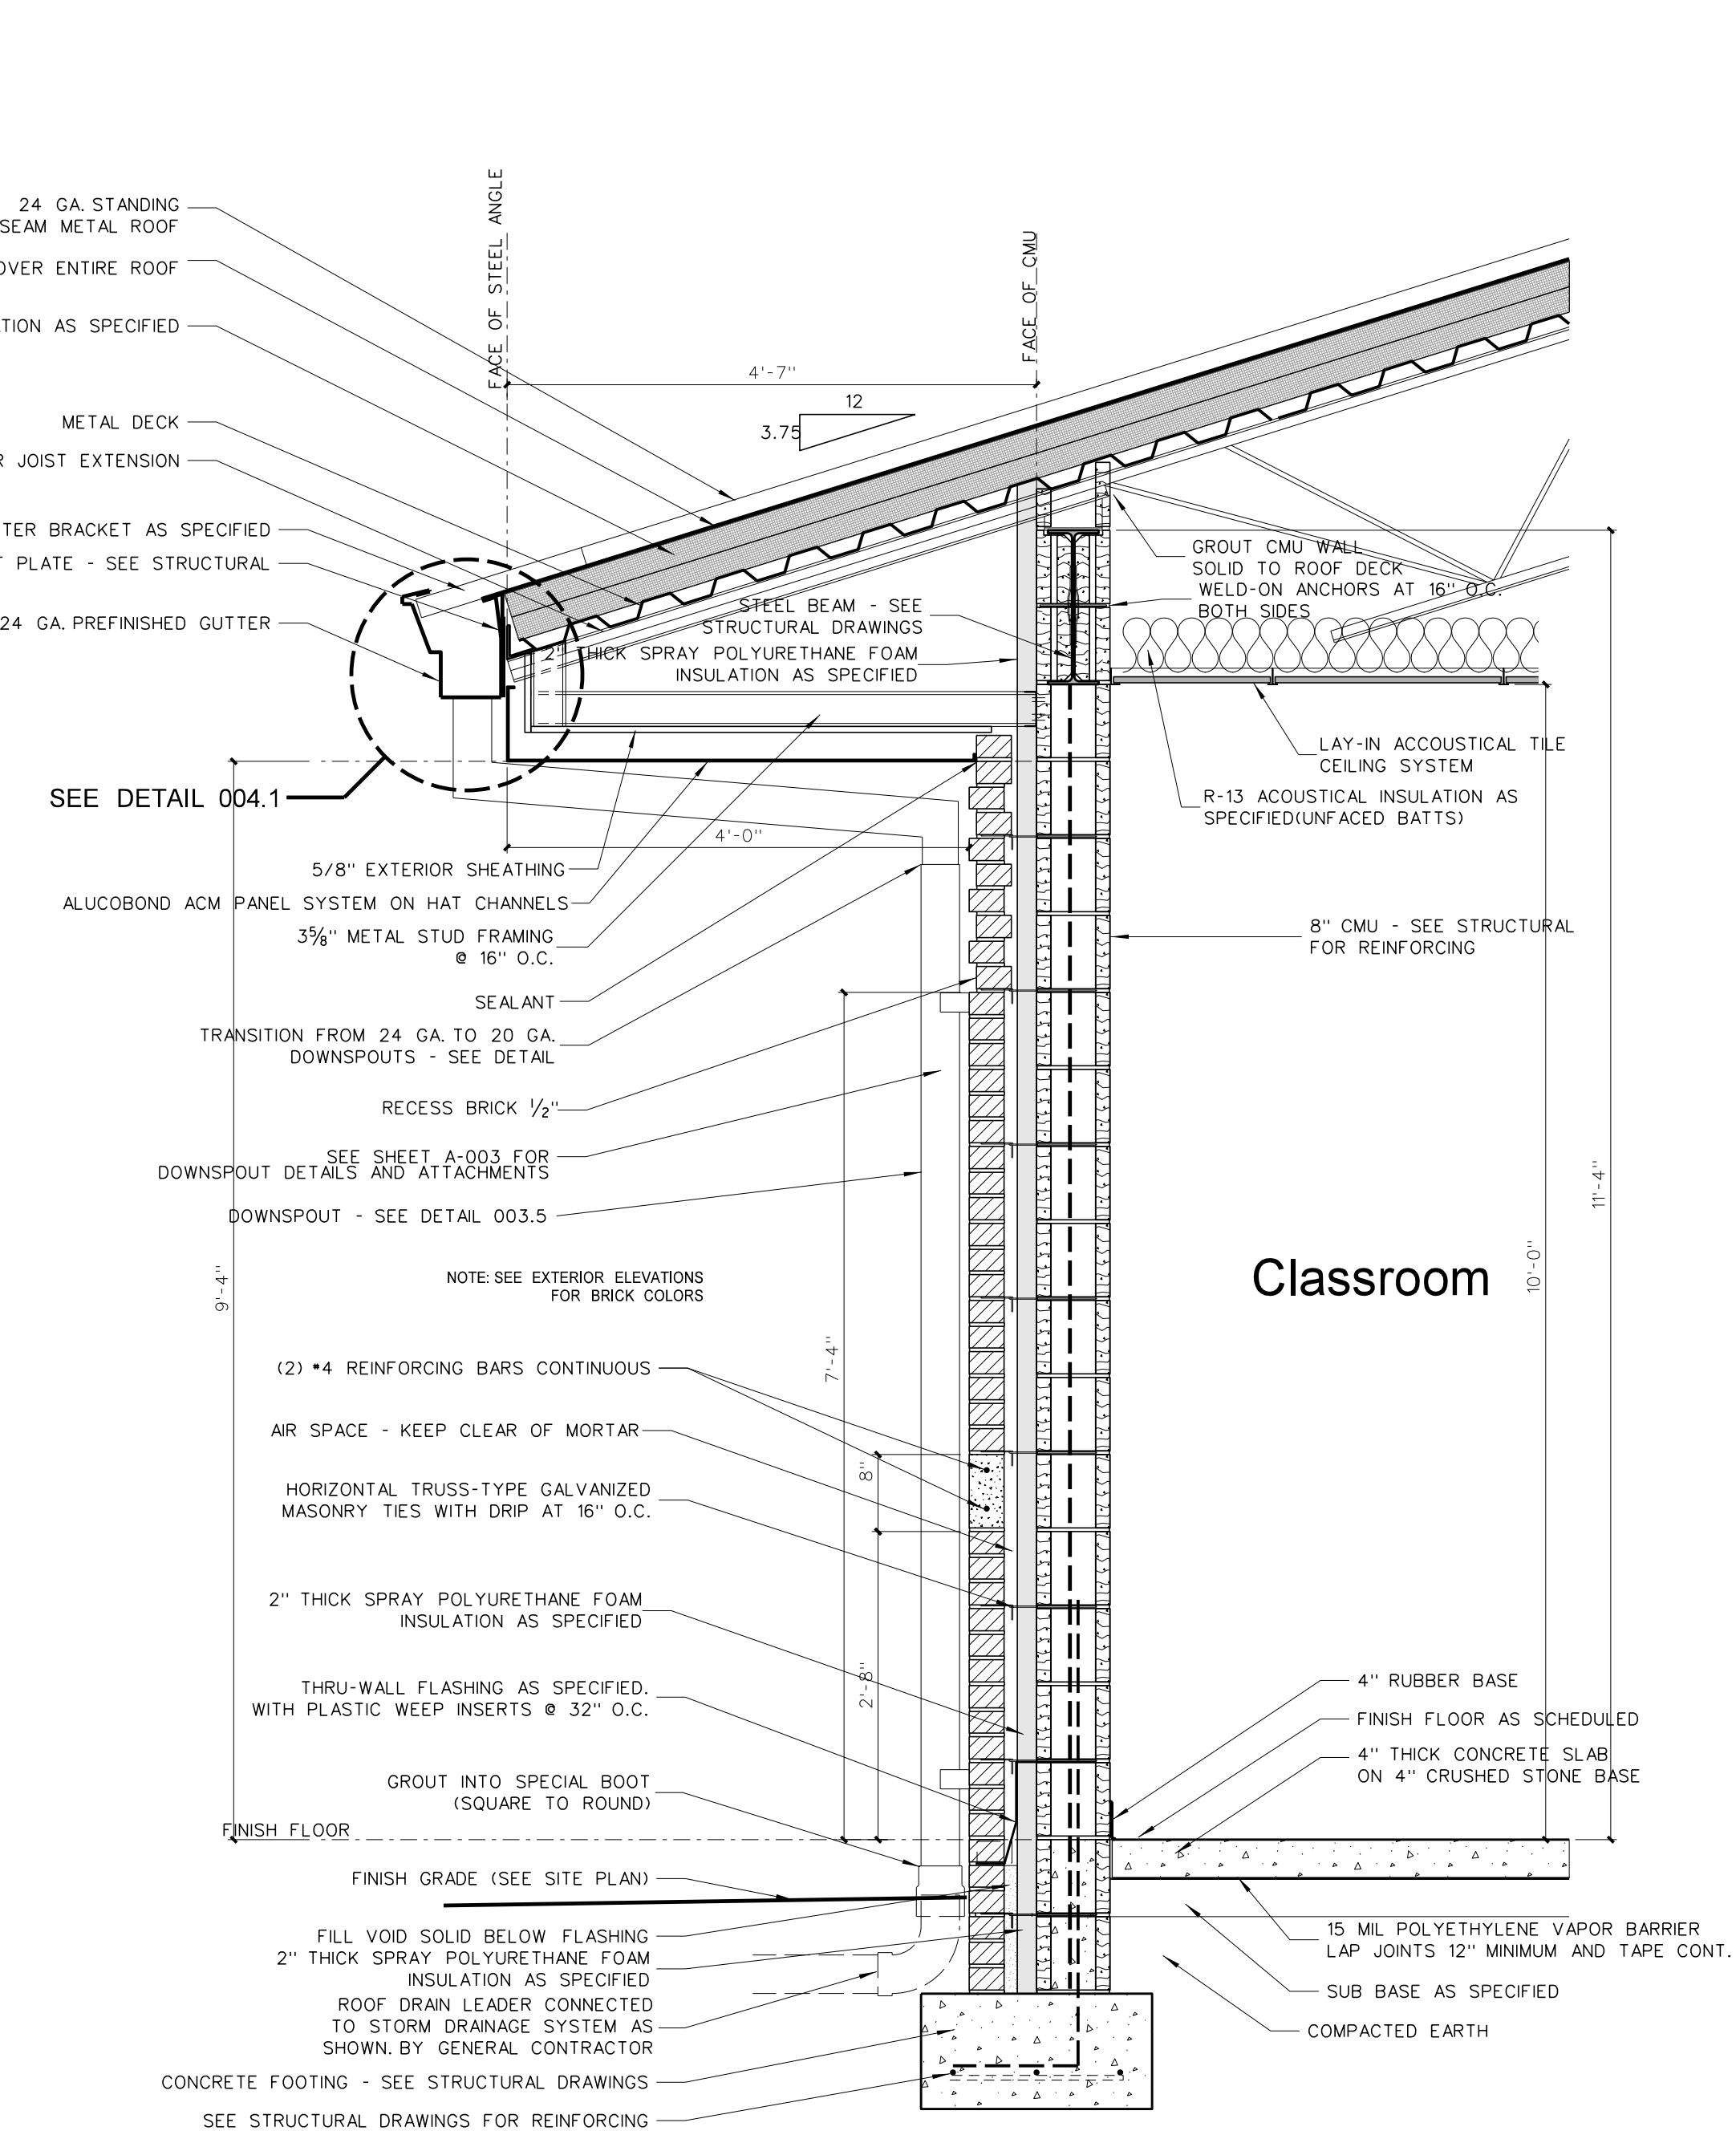

817.1 WALL SECTION
SCALE: 3/4" = 1'-0"

No.	Date	Revision

Hite associates
ARCHITECTURE / PLANNING / TECHNOLOGY
2600 Meridian Drive / Greenville, NC 27834 / tel (252) 757-0333

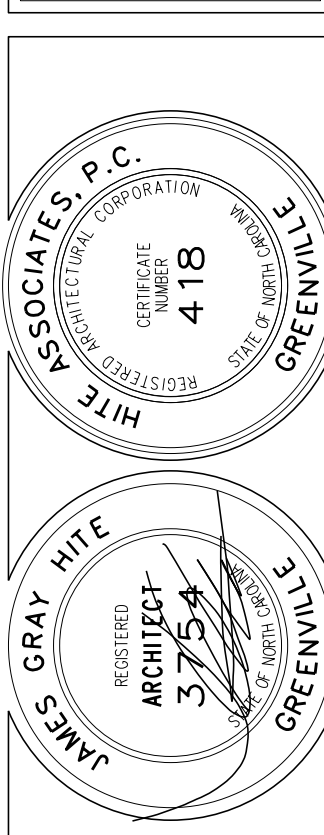


Beaufort PK-3 School
BEAUFORT COUNTY SCHOOLS
Washington / North Carolina / 727889

Project No.	22344
Date:	1 July 2024
Drawing no.	A 817

General Notes for Wall Sections


- (1) SEE EXTERIOR ELEVATIONS FOR BRICK COLOR.
- (2) GENERAL CONTRACTOR SHALL VERIFY TOP OF FINISH GRADES, TOP OF CONCRETE WALKS AND TOP OF CONCRETE SLABS ADJACENT TO BUILDING AND ADJUST LOCATION OF THROUGH WALL FLASHING ACCORDINGLY.
- (3) PROVIDE PLASTIC INSERT WEEPS AT ALL AT DOOR, WINDOW AND FLOOR FLASHING.
- (4) GENERAL CONTRACTOR SHALL SLOPE CONCRETE FLOOR TO FLOOR DRAINS AS SHOWN ON PLUMBING DRAWINGS.
- (5) ALL CMU CELLS BELOW FINISH FLOOR SHALL BE FILLED WITH CONCRETE.
- (6) ALL VAPOR BARRIERS UNDER FLOOR SLABS SHALL BE LAPPED 12" MINIMUM AND TAPED CONTINUOUS AT JOINTS. GENERAL CONTRACTOR SHALL REPAIR ANY DAMAGED VAPOR BARRIER PRIOR TO PLACING CONCRETE.
- (7) PROVIDE 4" MINIMUM SPRAY POLYURETHANE INSULATION IN ALL METAL STUDS EXTERIOR WALLS. SEE WALL SECTIONS AND SPECIFICATIONS.
- (8) PROVIDE SPRAY POLYURETHANE INSULATION IN ALL NESTED METAL STUD WINDOW AND DOOR JAMBS, SILLS AND HEADS.
- (9) ALL INTERIOR METAL STUD/GYPSUM WALLBOARD PARTITIONS REQUIRE SOUND ATTENUATION BATT.
- (10) PROVIDE METAL CHAIRS UNDER ALL STEEL WIRE MATS REINFORCING STEEL FOR CONCRETE SLABS AND FOUNDATIONS.
- (11) PROVIDE GYPSUM CONTROL JOINTS AT ALL GYPBOARD / METAL STUD WINDOW JAMBS. SEE INTERIOR ELEVATIONS.
- (12) ALL SEALANT COLORS TO BE SELECTED BY ARCHITECT.
- (13) ROOF INSULATION TAPE ALL ROOF INSULATION JOINTS, BOTH LAYER, LAP AND TAPE VAPOR BARRIER ARCHITECT TO FIELD VERIFY PRIOR TO METAL ROOF PANEL INSTALLATION.
- (14) PROVIDE PRE-FORMED THRU-WALL FLASHING CORNER MEMBERS FOR EXTERIOR WALL CORNERS AS SPECIFIED.

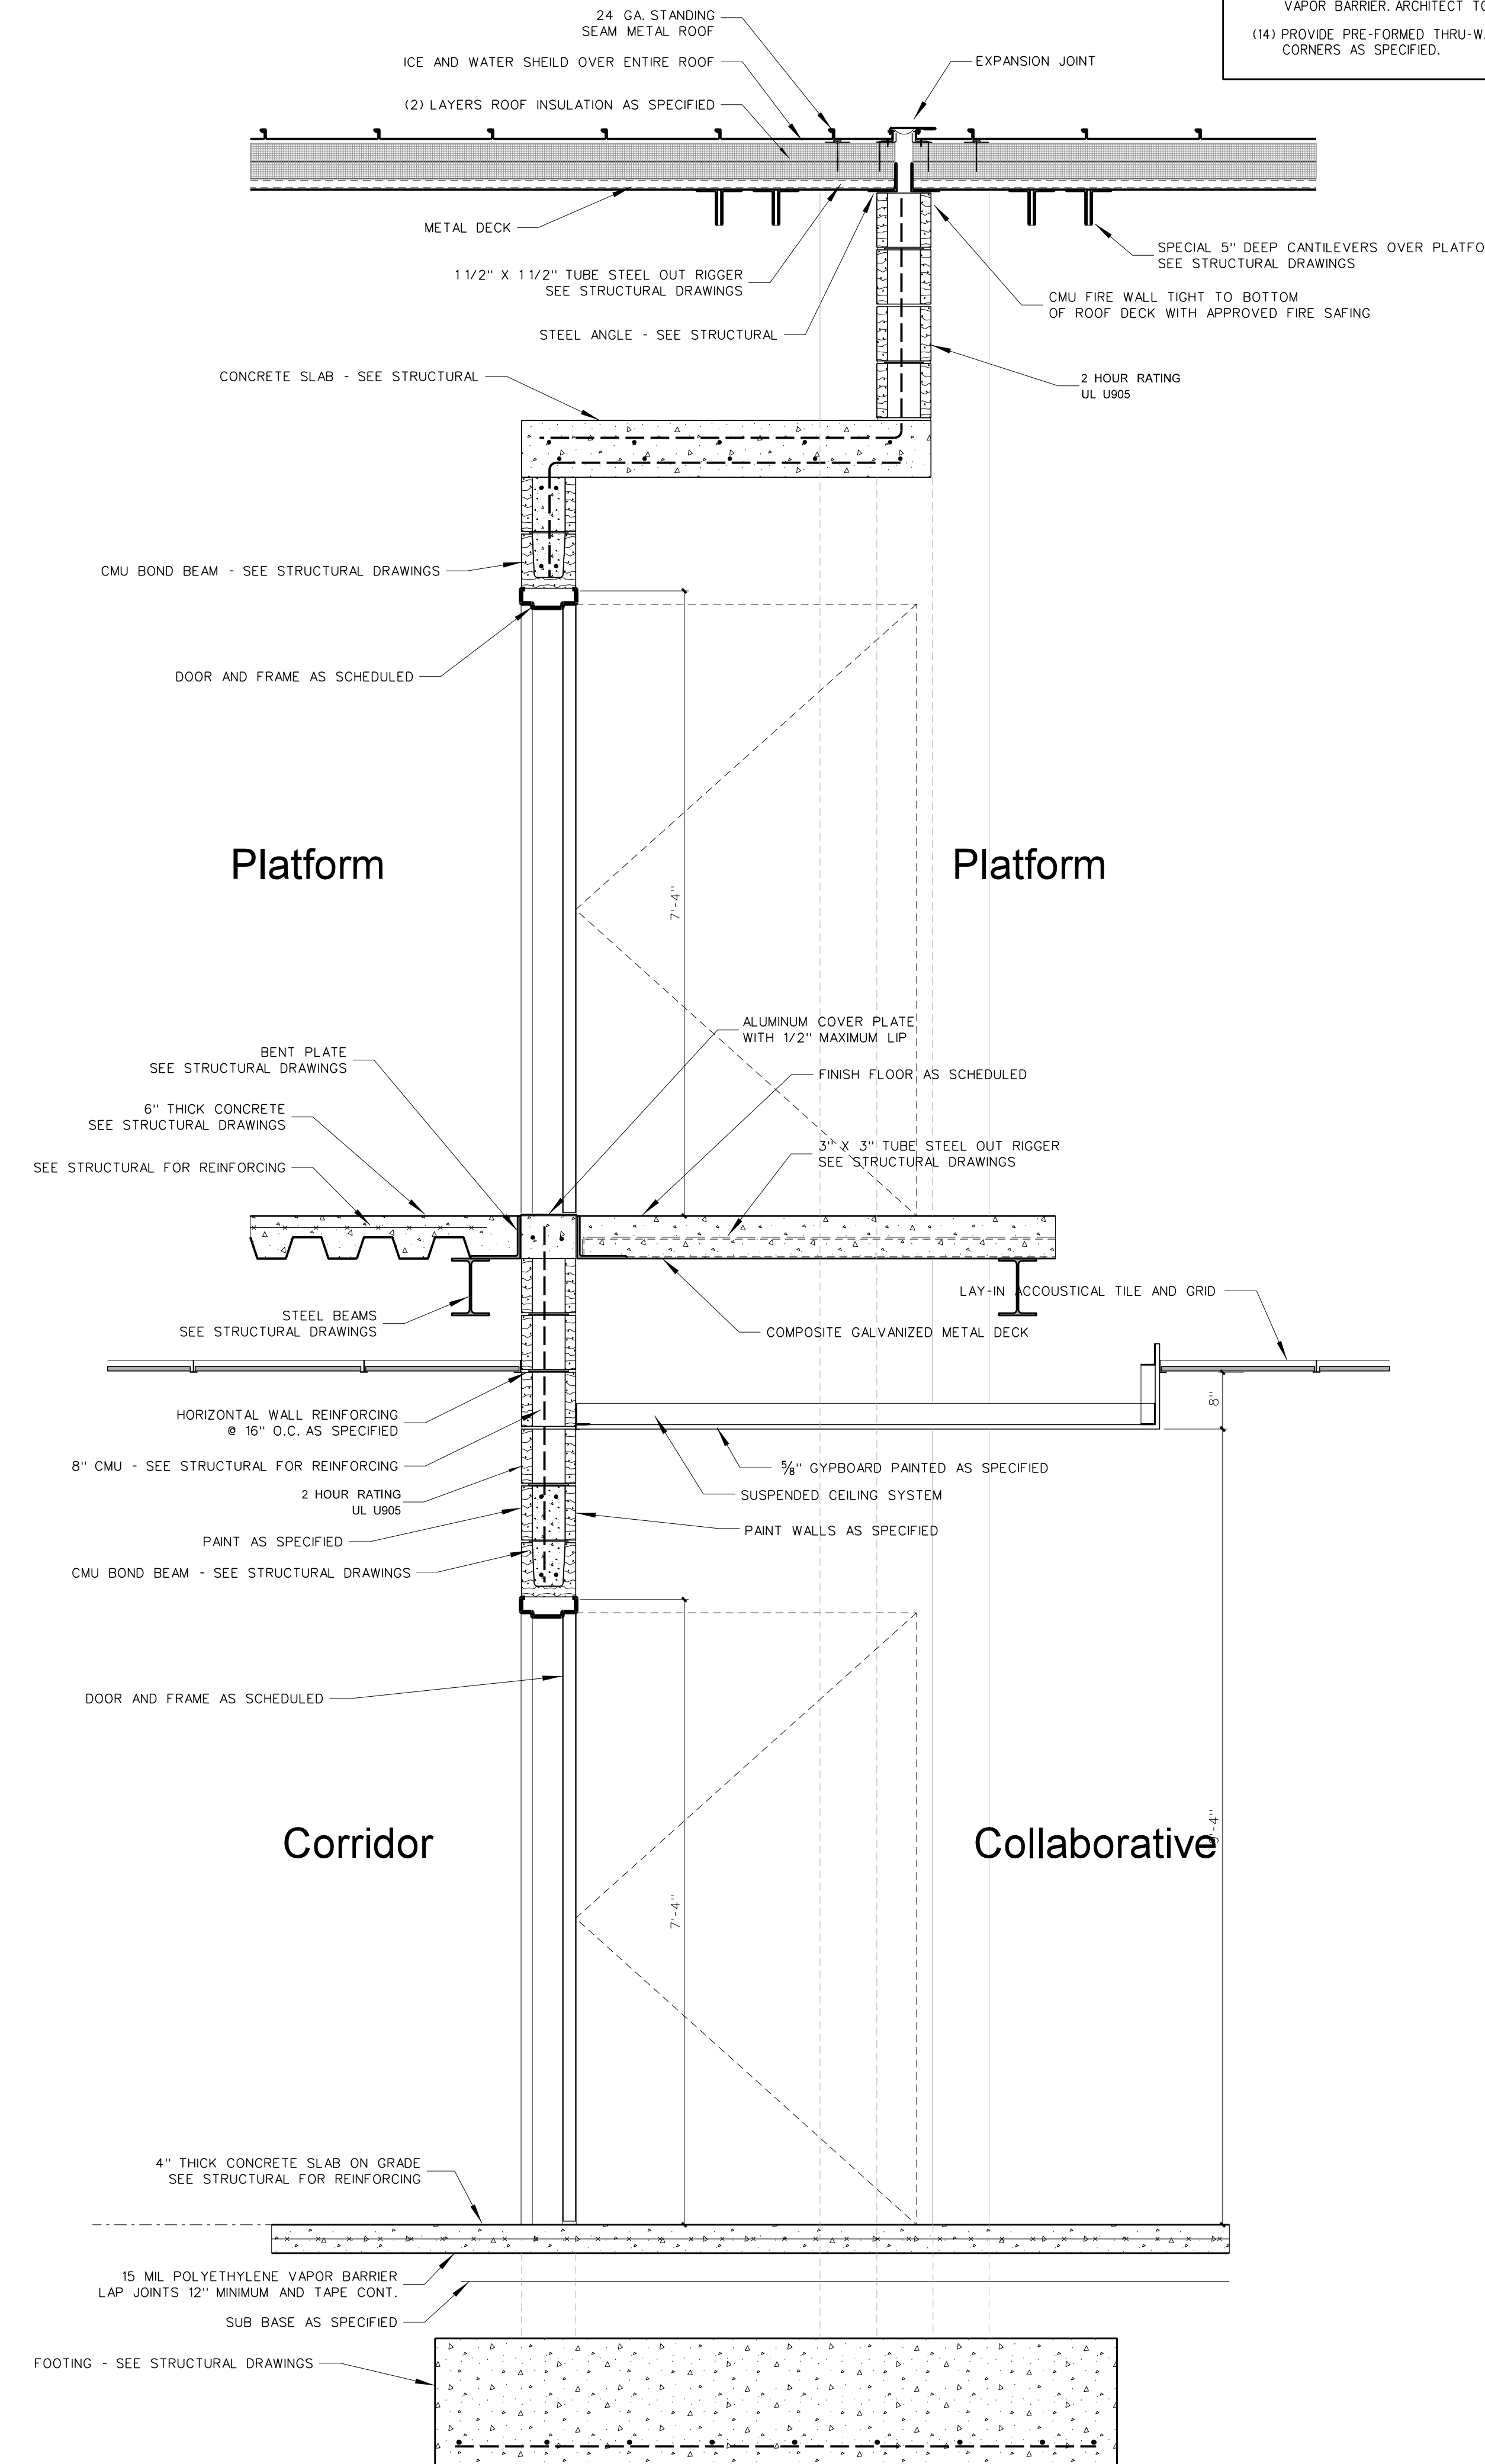

818.1 WALL SECTION AT FIRE WALL
SCALE: 3/4" = 1'-0"

No.	Date	Revision

Hite associates
ARCHITECTURE / PLANNING / TECHNOLOGY
2600 Meridian Drive / Greenville, NC 27834 / tel/(252) 757-0333





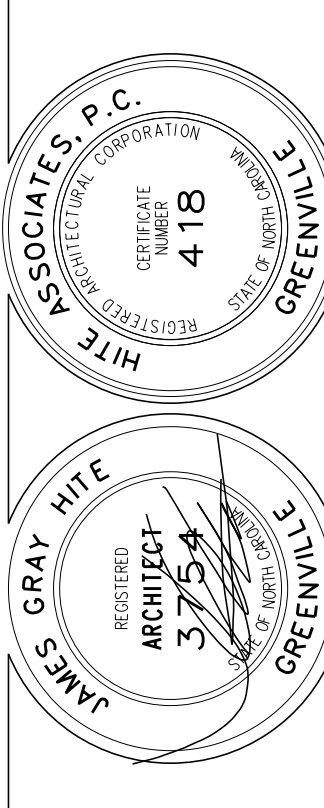


Beaufort PK-3 School
BEAUFORT COUNTY SCHOOLS
Washington / North Carolina / 727889

Project No.	22344
Date:	1 July 2024
Drawing no.	A 818

General Notes for Wall Sections

- (1) SEE EXTERIOR ELEVATIONS FOR BRICK COLOR.
- (2) GENERAL CONTRACTOR SHALL VERIFY TOP OF FINISH GRADES, TOP OF CONCRETE WALKS AND TOP OF CONCRETE SLABS ADJACENT TO BUILDING AND ADJUST LOCATION OF THROUGH WALL FLASHING ACCORDINGLY.
- (3) PROVIDE PLASTIC INSERT WEEPS AT ALL AT DOOR, WINDOW AND FLOOR FLASHING.
- (4) GENERAL CONTRACTOR SHALL SLOPE CONCRETE FLOOR TO FLOOR DRAINS AS SHOWN ON PLUMBING DRAWINGS.
- (5) ALL CMU CELLS BELOW FINISH FLOOR SHALL BE FILLED WITH CONCRETE.
- (6) ALL VAPOR BARRIERS UNDER FLOOR SLABS SHALL BE LAPPED 12" MINIMUM AND TAPED CONTINUOUS AT JOINTS. GENERAL CONTRACTOR SHALL REPAIR ANY DAMAGED VAPOR BARRIER PRIOR TO PLACING CONCRETE.
- (7) PROVIDE 4" MINIMUM SPRAY POLYURETHANE INSULATION IN ALL METAL STUDS EXTERIOR WALLS. SEE WALL SECTIONS AND SPECIFICATIONS.
- (8) PROVIDE SPRAY POLYURETHANE INSULATION IN ALL NESTED METAL STUD WINDOW AND DOOR JAMBS, SILLS AND HEADS.
- (9) ALL INTERIOR METAL STUD/GYPSUM WALLBOARD PARTITIONS REQUIRE SOUND ATTENUATION BATTS.
- (10) PROVIDE METAL CHAIRS UNDER ALL STEEL WIRE MATS REINFORCING STEEL FOR CONCRETE SLABS AND FOUNDATIONS.
- (11) PROVIDE GYPSUM CONTROL JOINTS AT ALL GYPSUM BOARD / METAL STUD WINDOW JAMBS. SEE INTERIOR ELEVATIONS.
- (12) ALL SEALANT COLORS TO BE SELECTED BY ARCHITECT.
- (13) ROOF INSULATION: TAPE ALL ROOF INSULATION JOINTS, BOTH LAYER, LAP AND TAPE VAPOR BARRIER. ARCHITECT TO FIELD VERIFY PRIOR TO METAL ROOF PANEL INSTALLATION.
- (14) PROVIDE PRE-FORMED THRU-WALL FLASHING CORNER MEMBERS FOR EXTERIOR WALL CORNERS AS SPECIFIED.

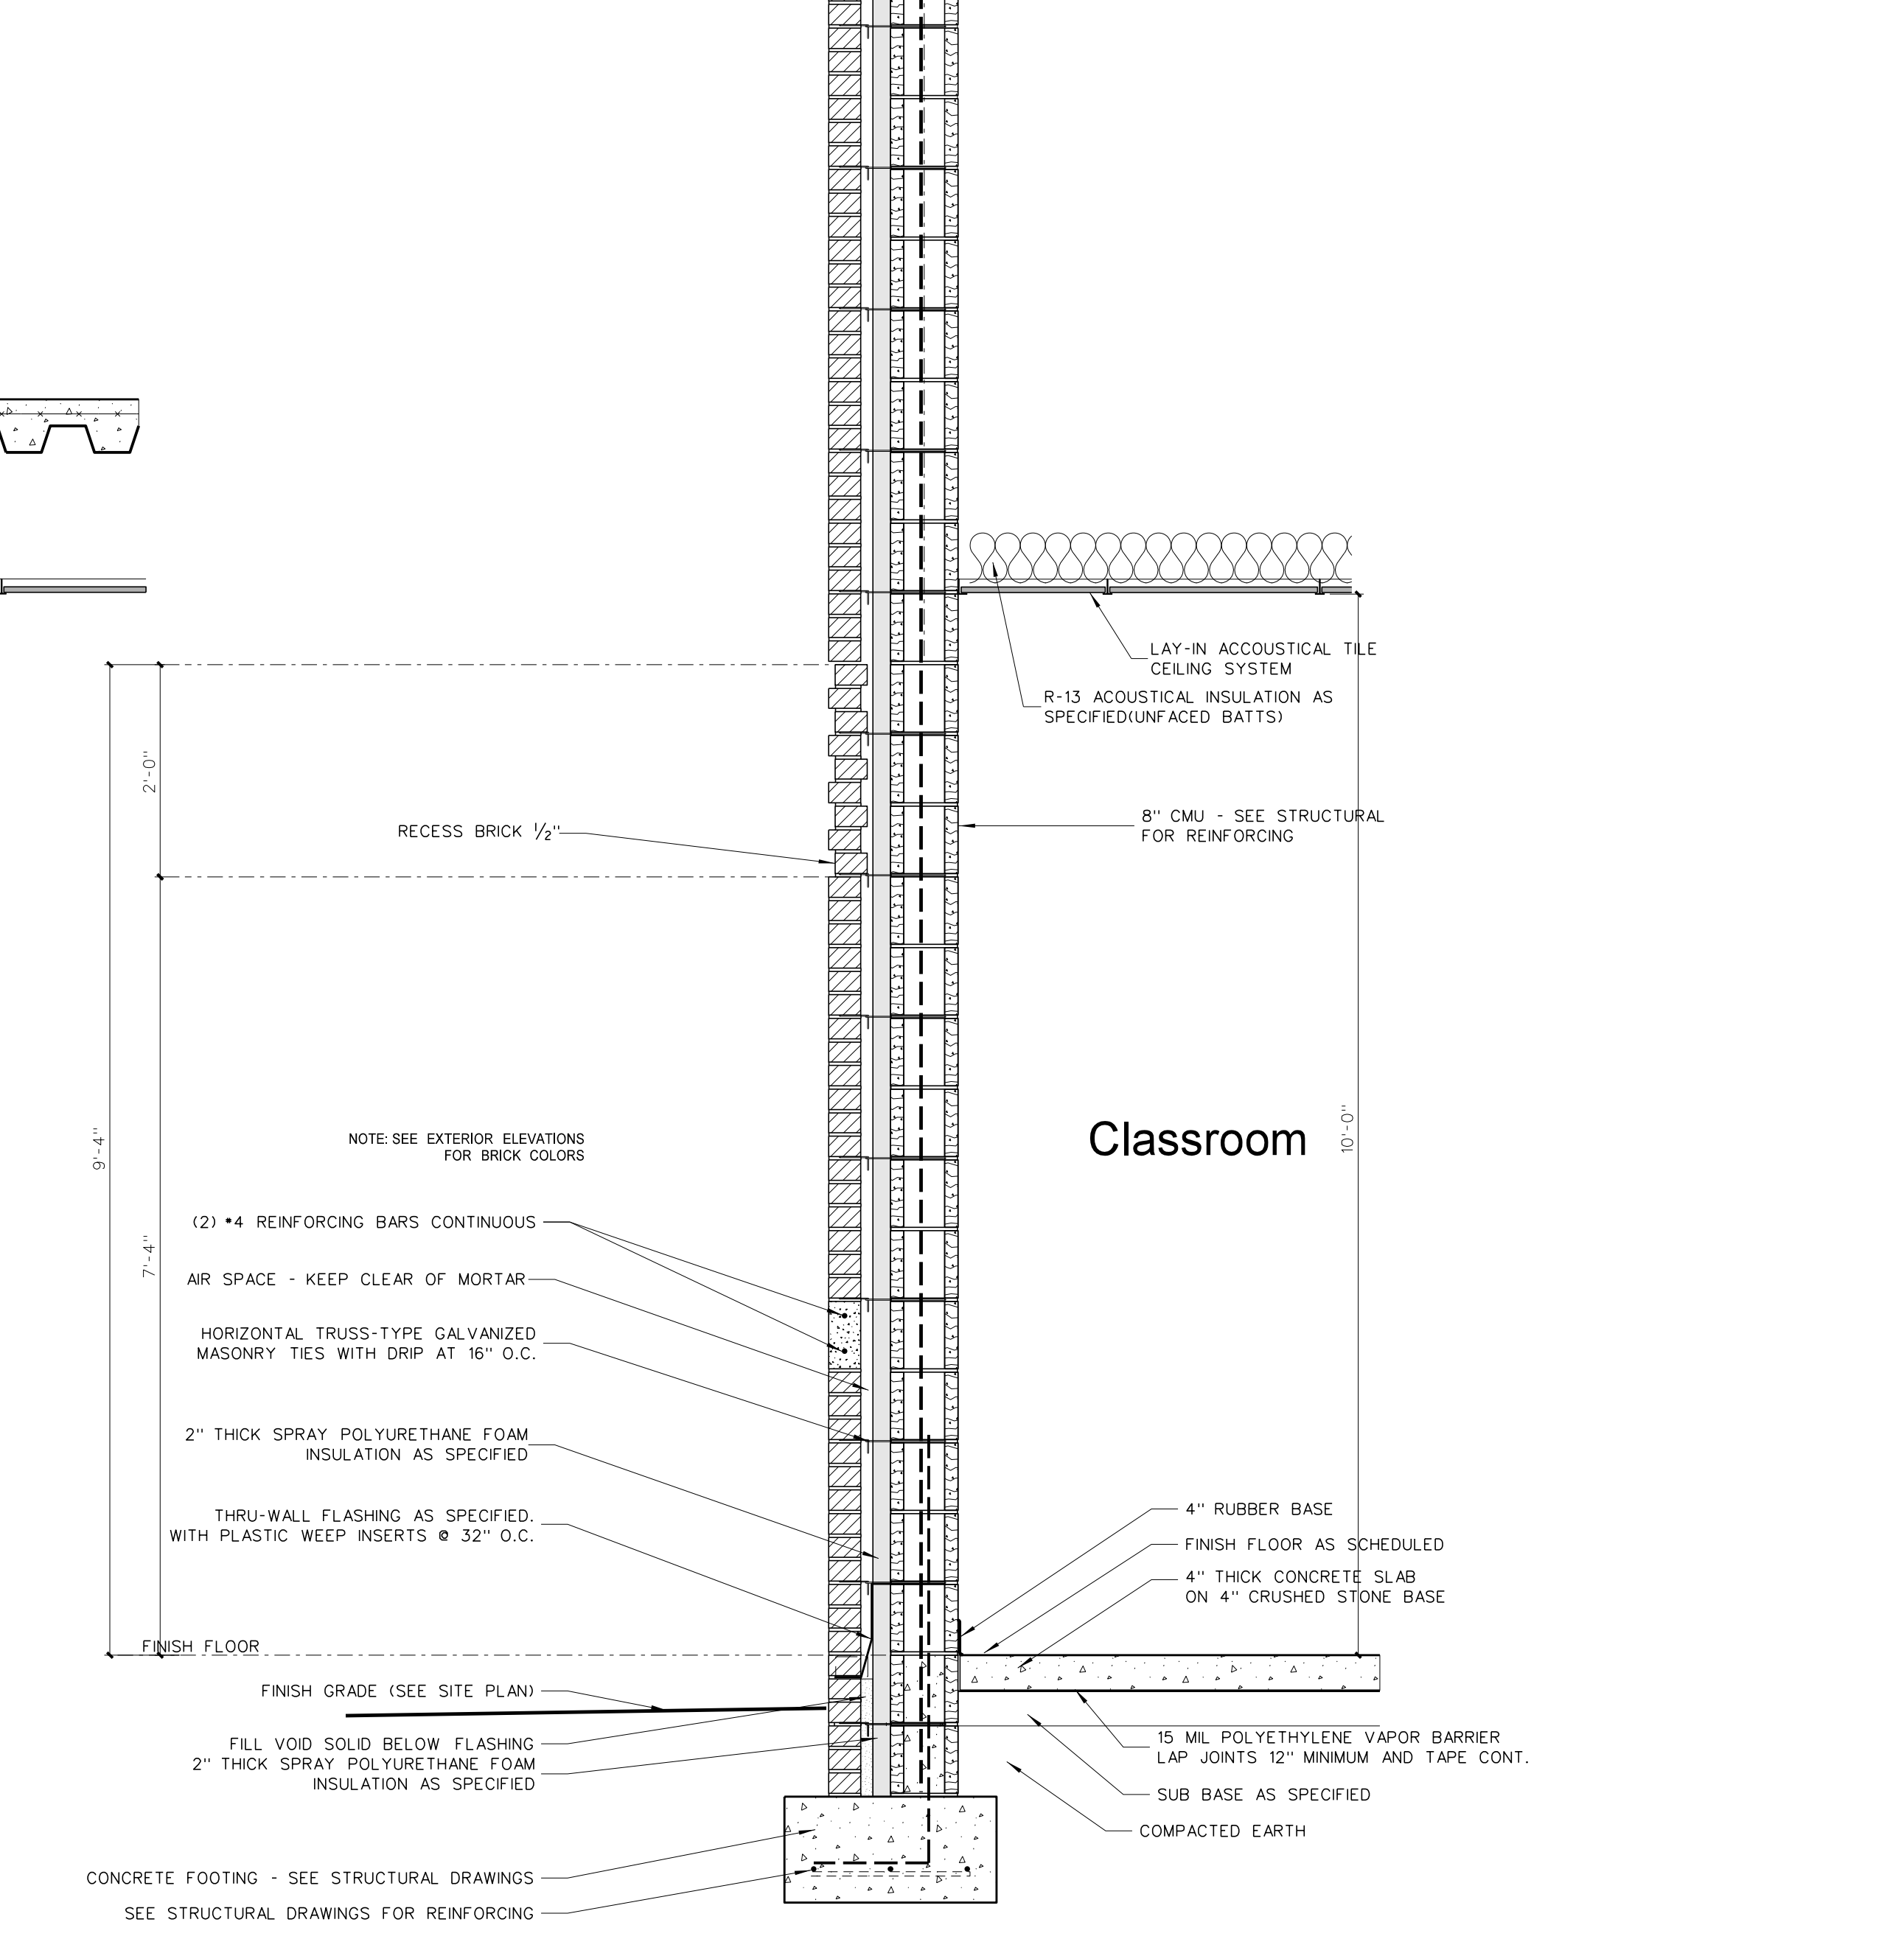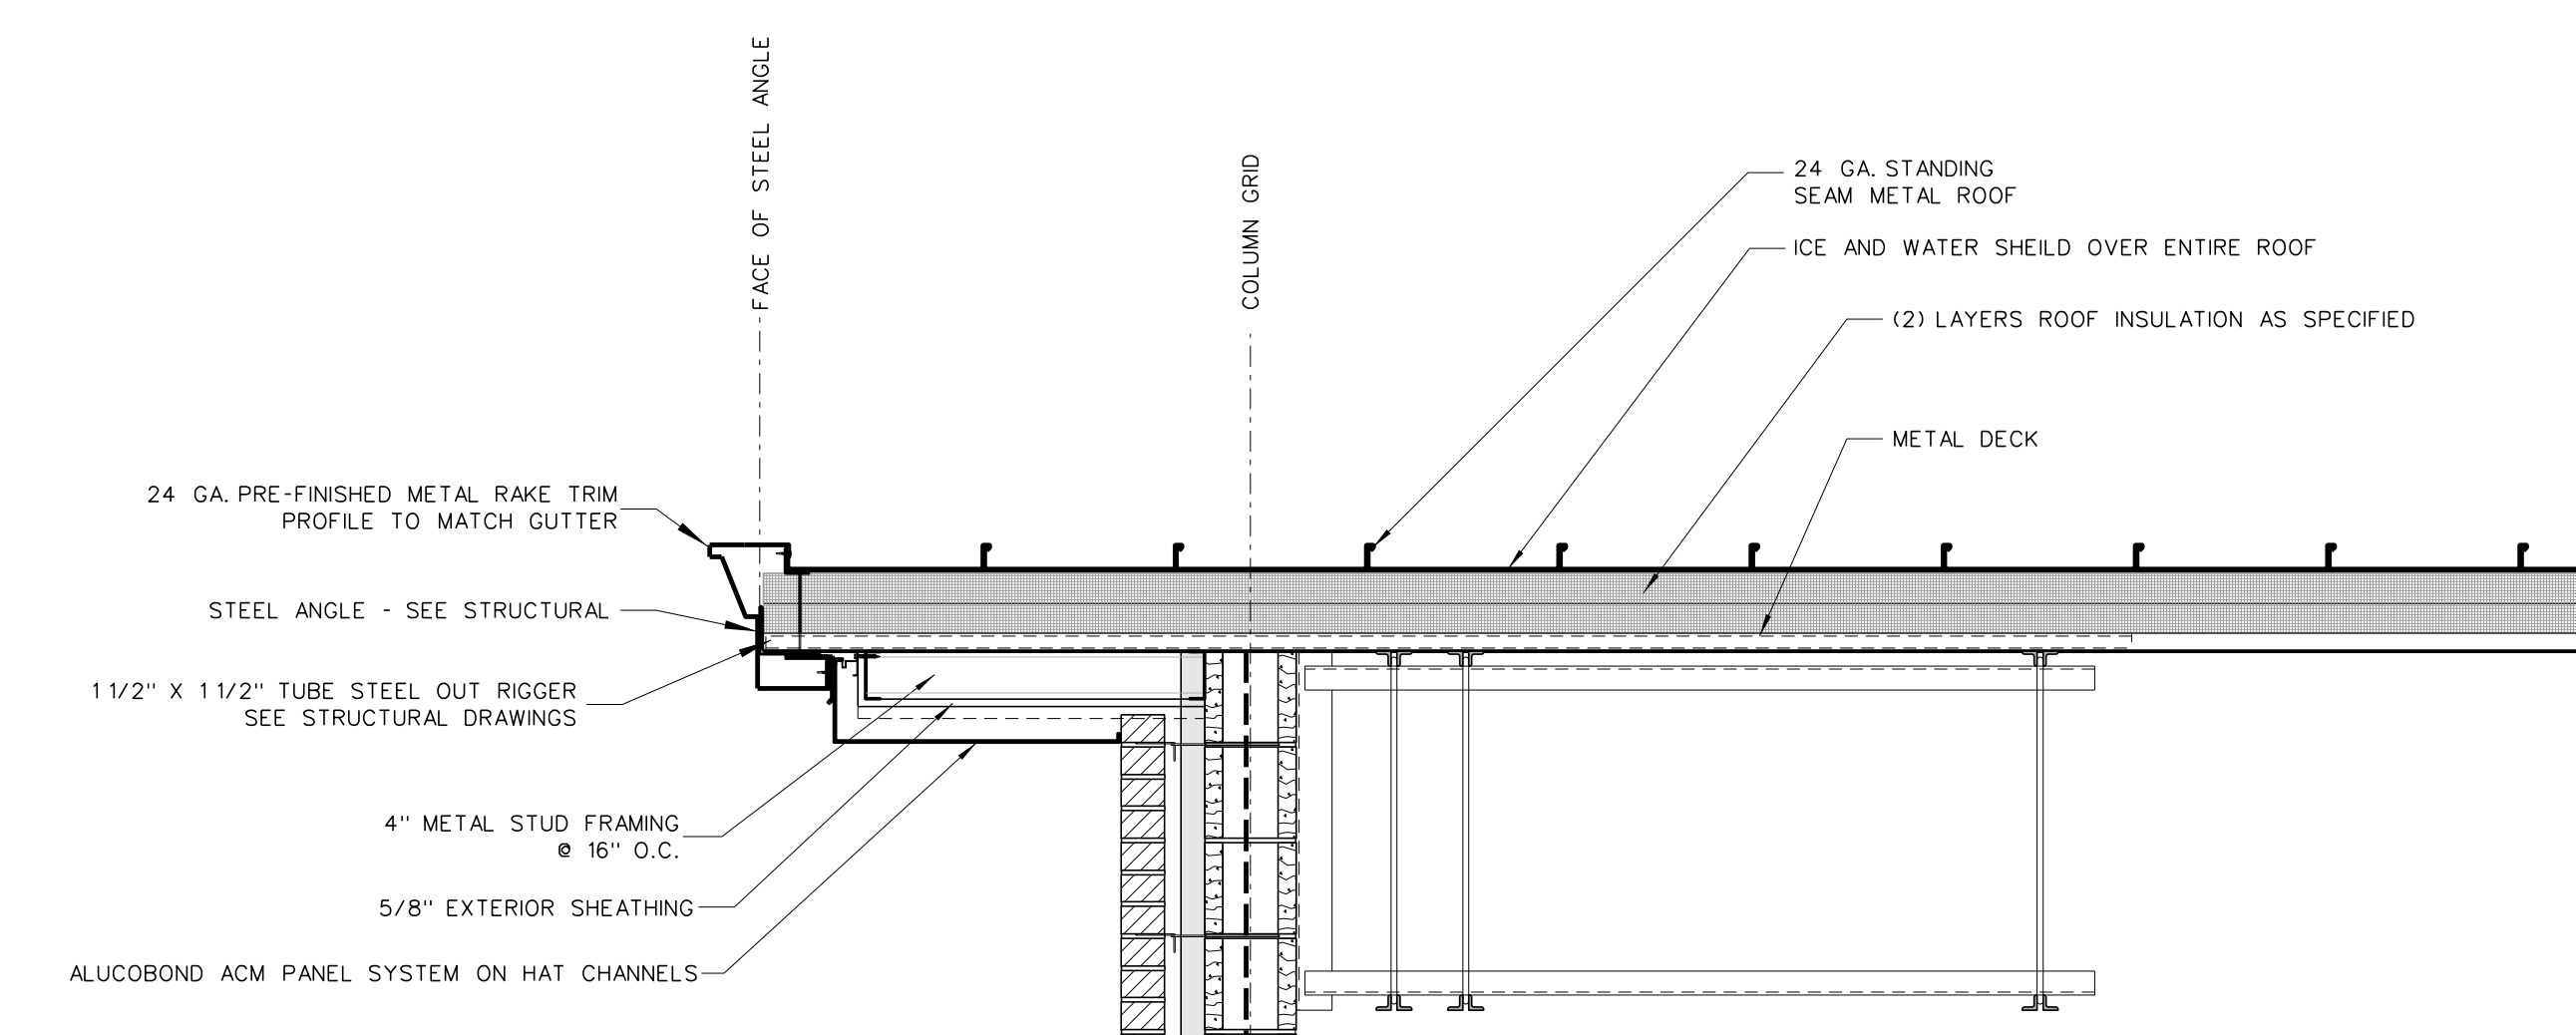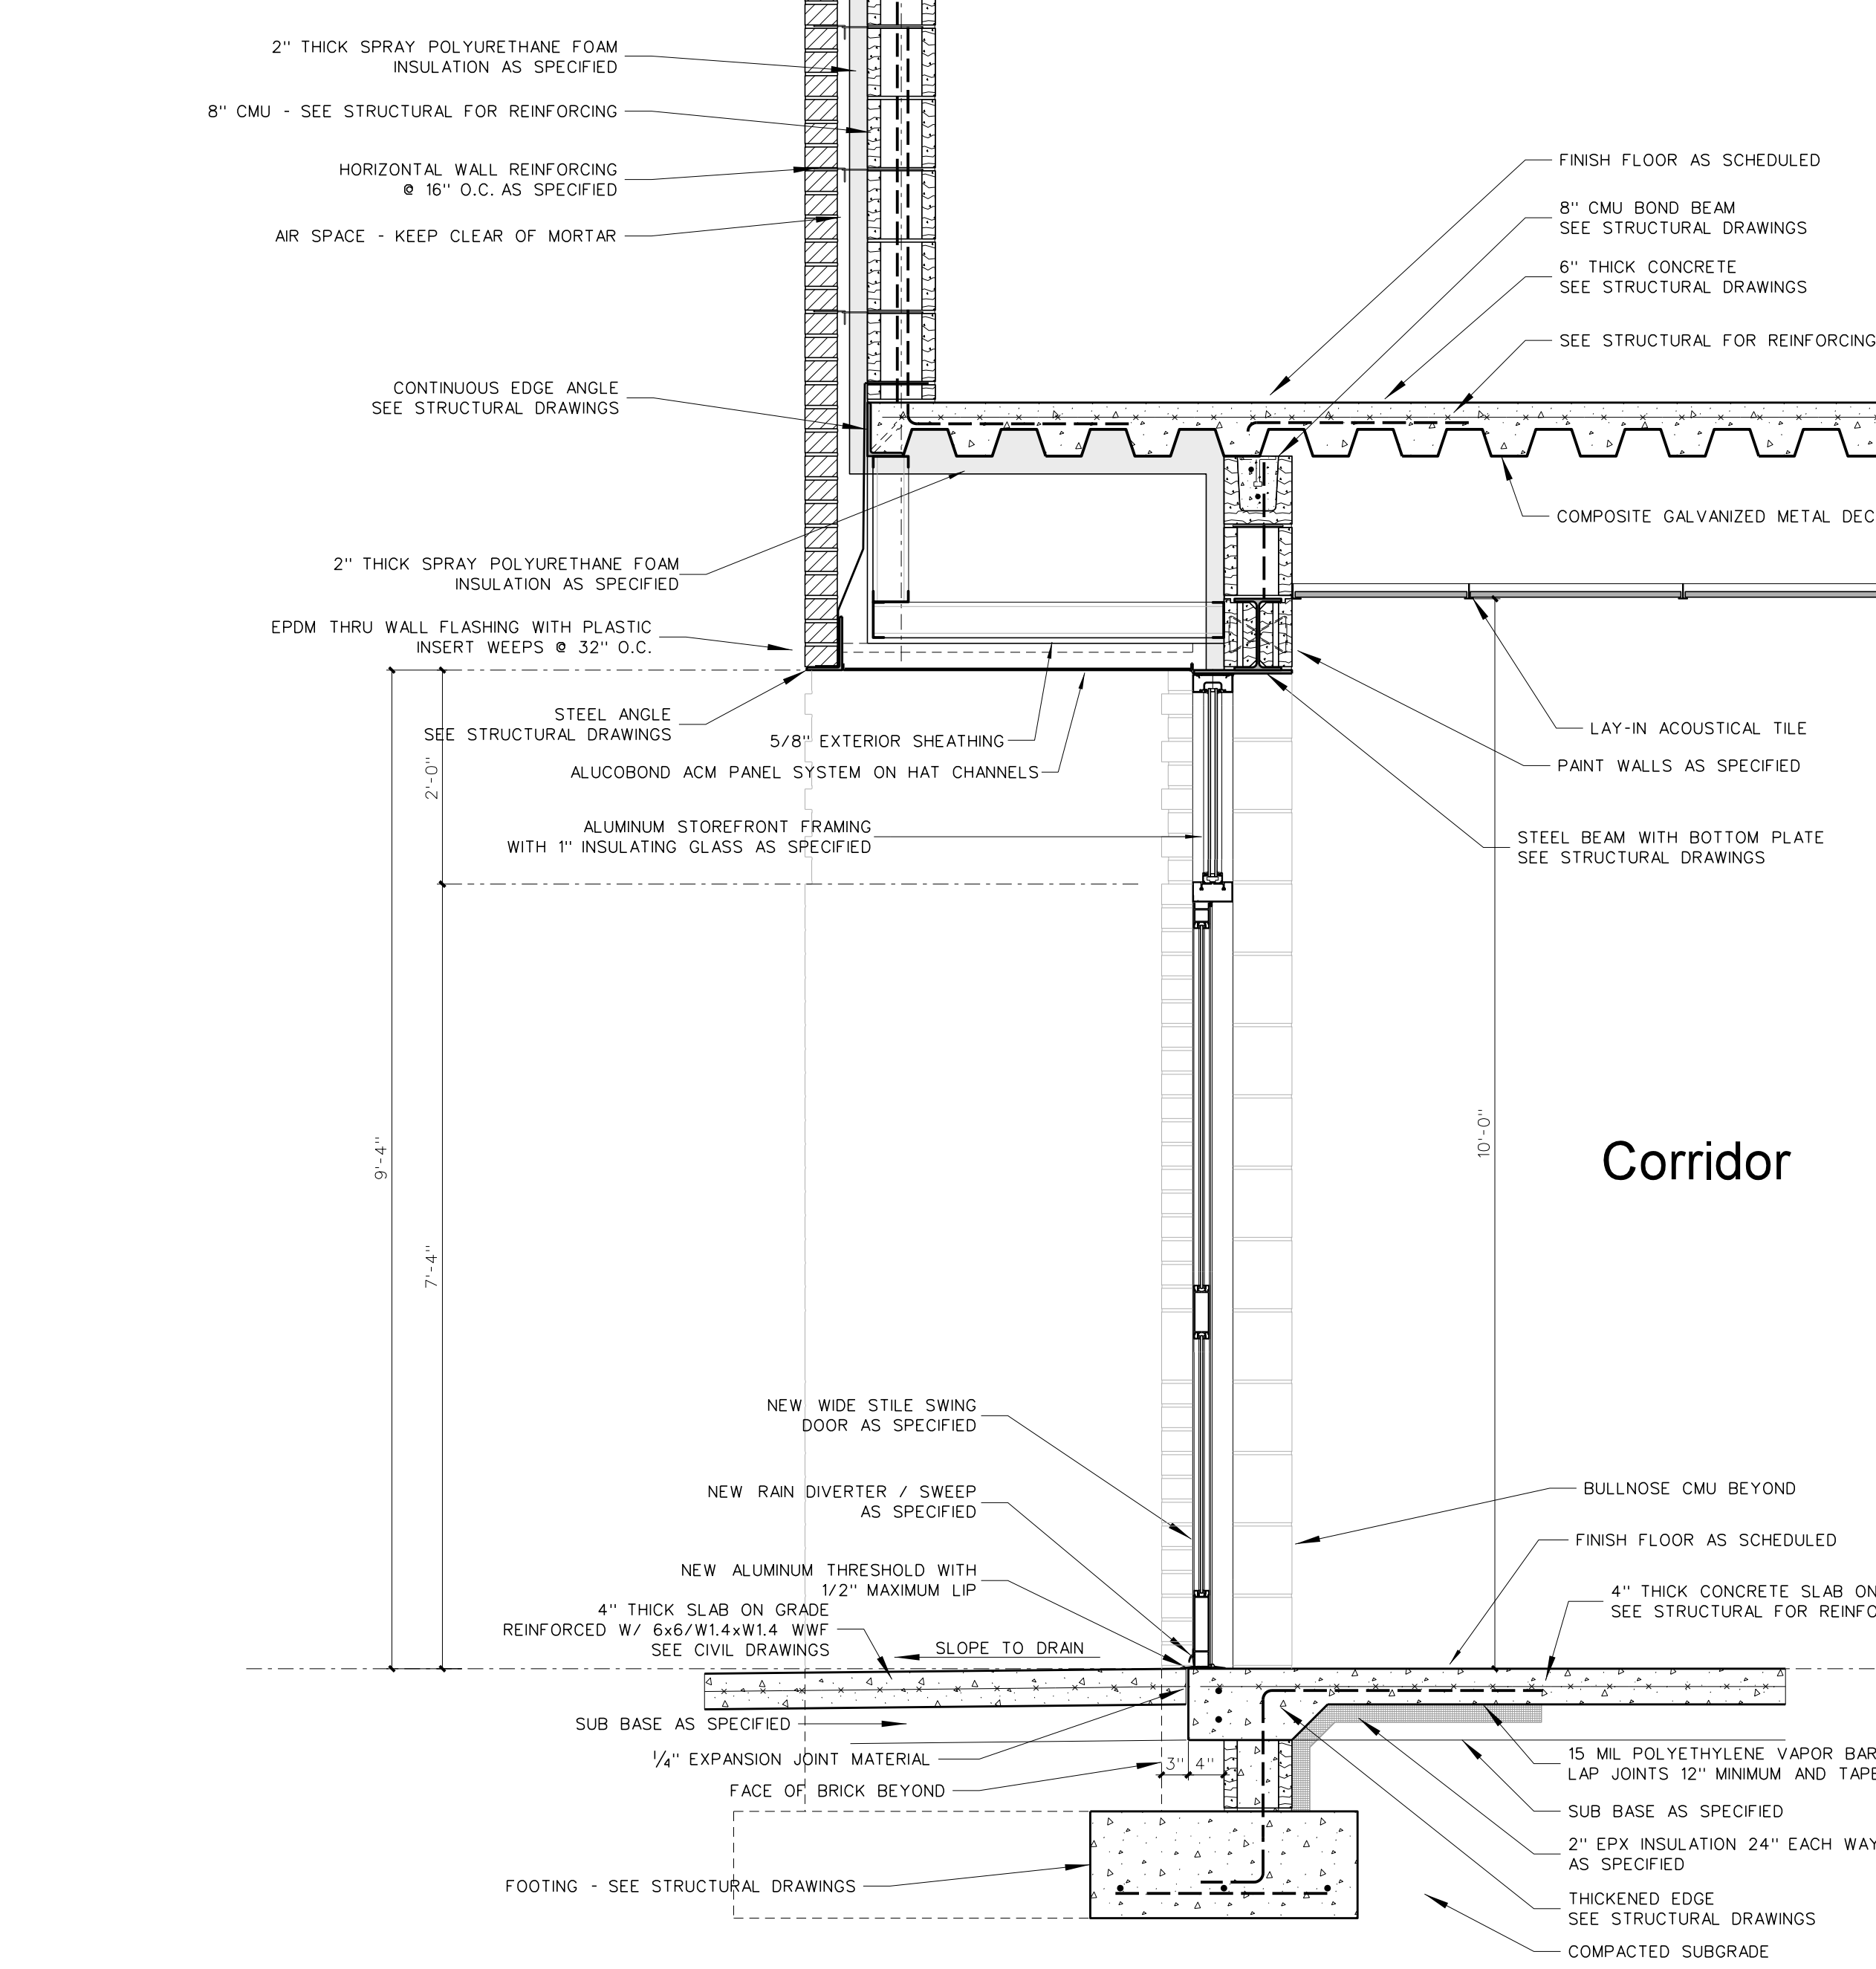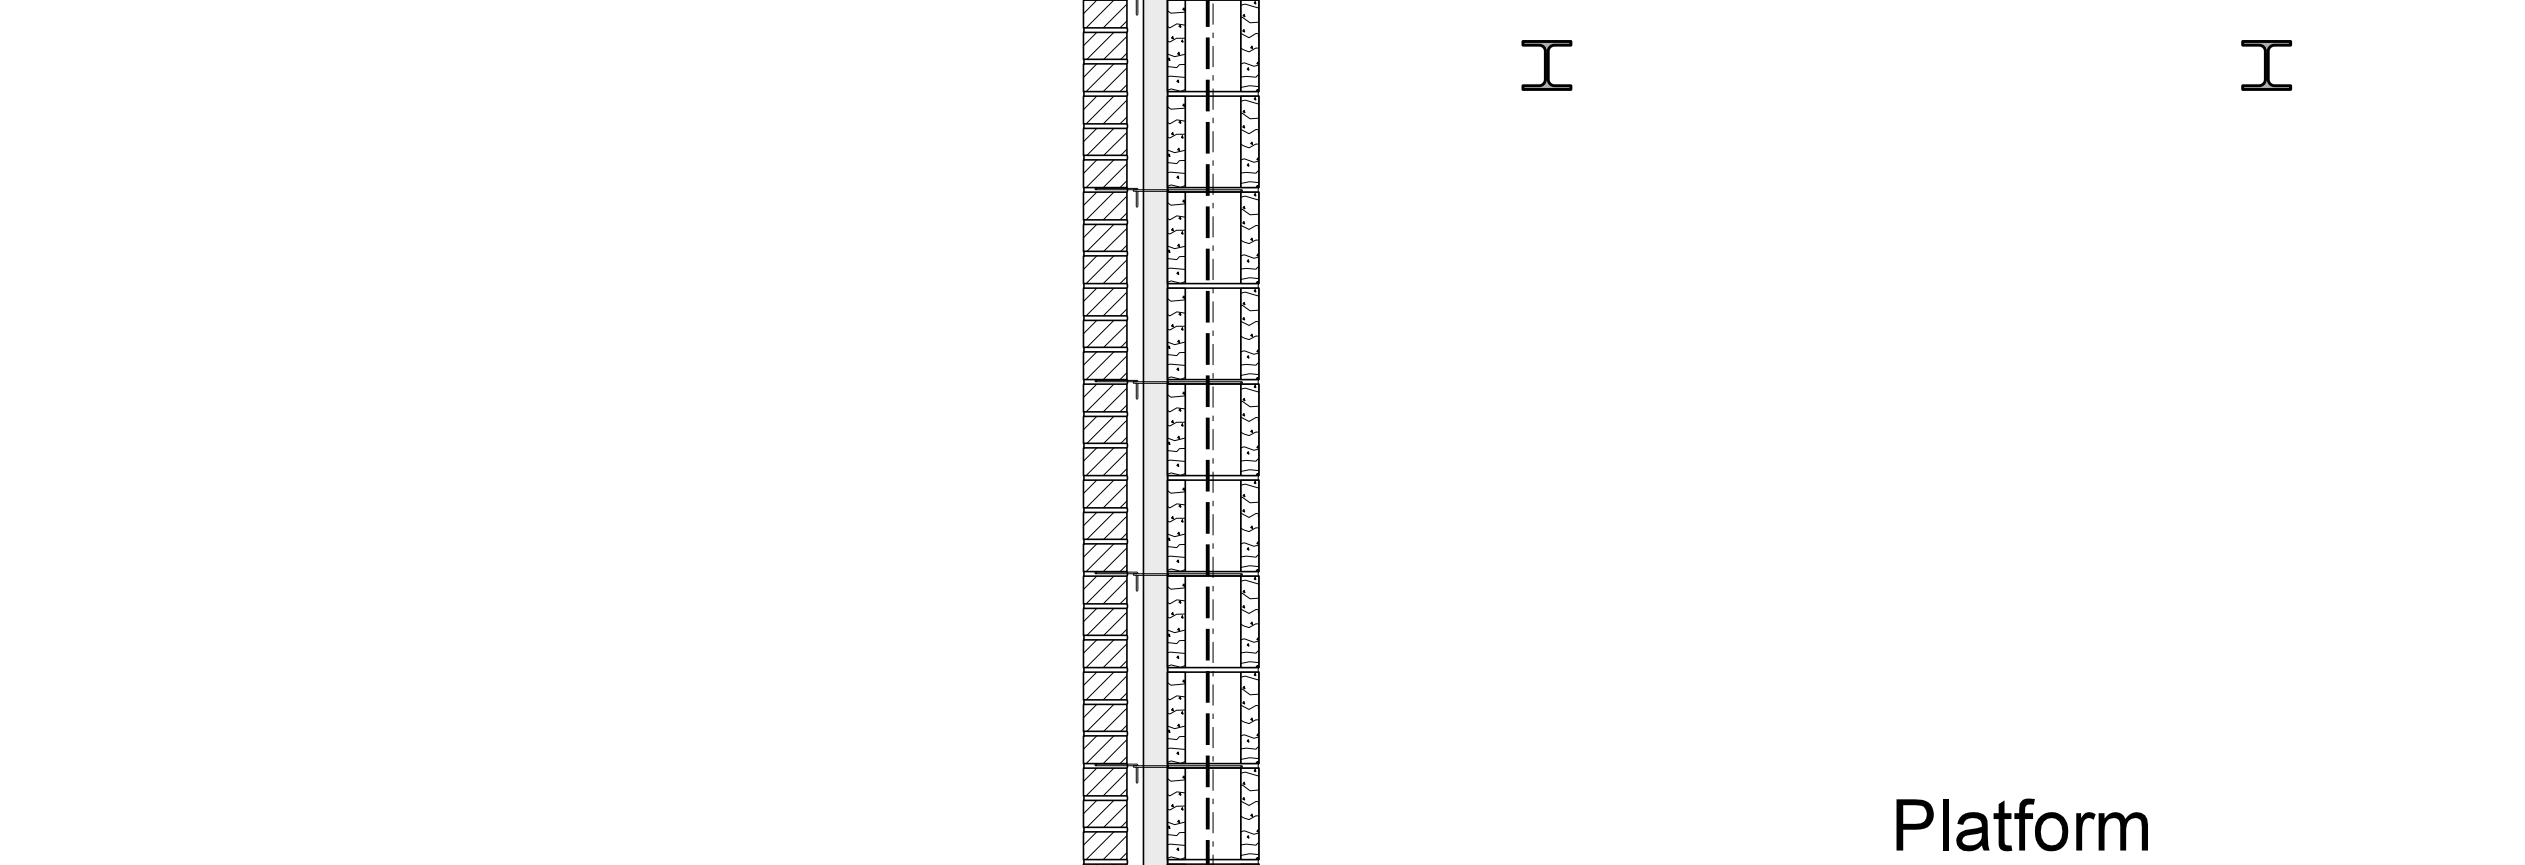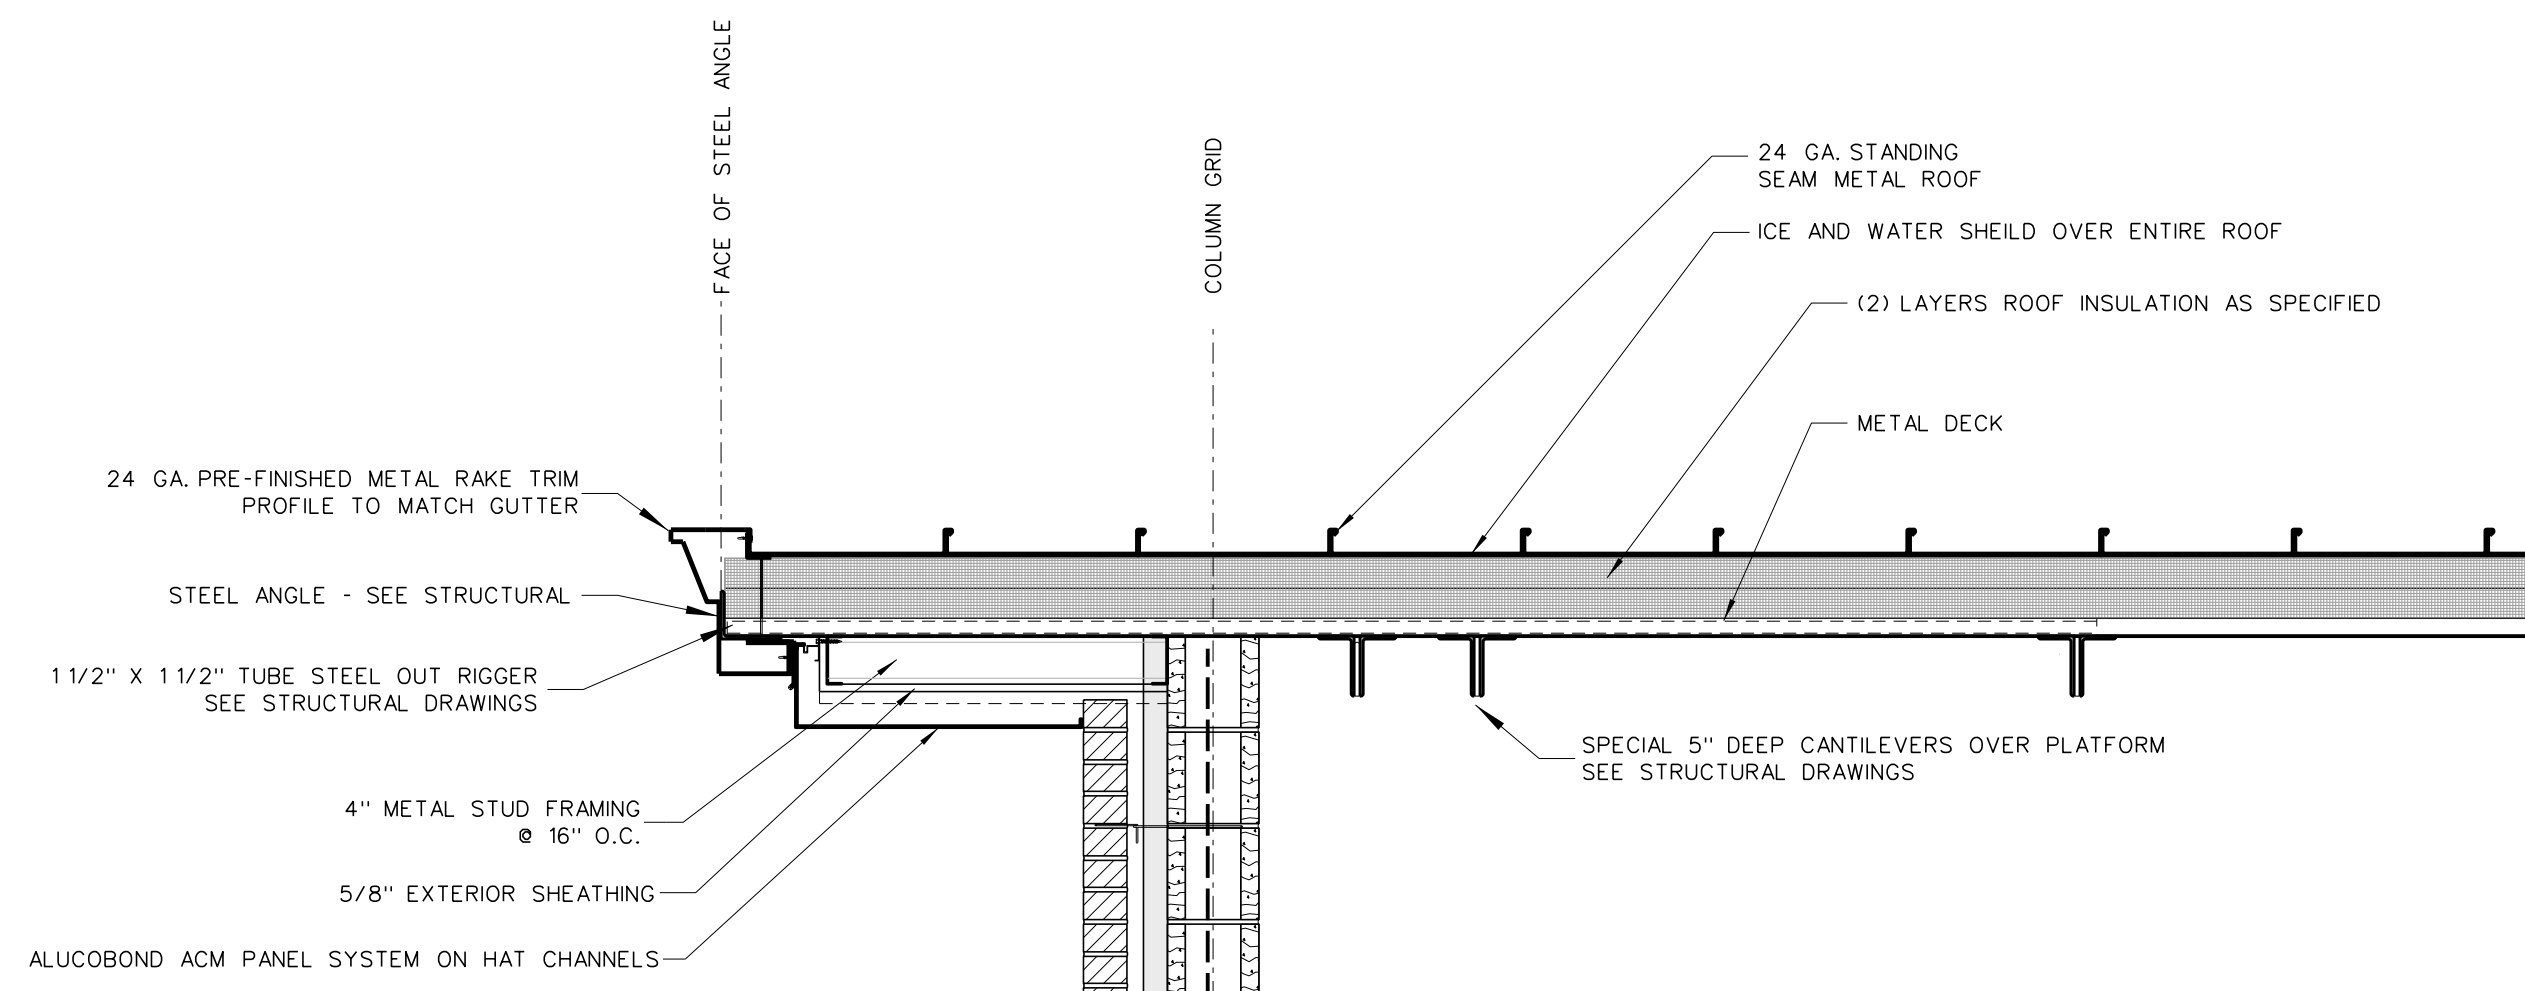


819.2 WALL SECTION AT END WALL ENTRY
SCALE: 3/4" = 1'-0"

819.1 WALL SECTION AT END WALL
SCALE: 3/4" = 1'-0"

No.	Date	Revision

Hite associates
ARCHITECTURE / PLANNING / TECHNOLOGY
2600 Meridian Drive / Greenville, NC 27834 / tel (252) 757-0333


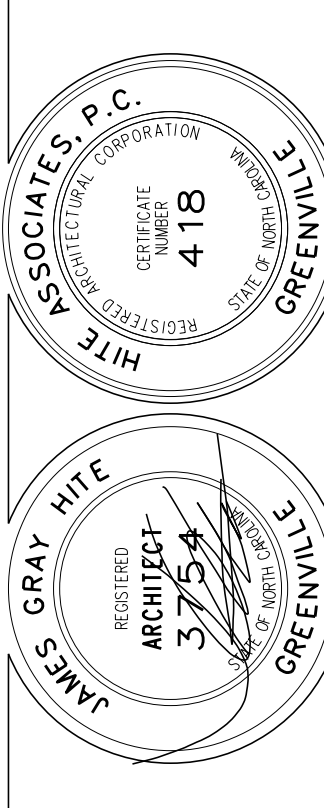


Beaufort PK-3 School
BEAUFORT COUNTY SCHOOLS
Washington / North Carolina / 727889

Project No. 22344
Date: 1 July 2024
Drawing no. **A 819**

General Notes for Wall Sections

- (1) SEE EXTERIOR ELEVATIONS FOR BRICK COLOR.
- (2) GENERAL CONTRACTOR SHALL VERIFY TOP OF FINISH GRADES, TOP OF CONCRETE WALKS AND TOP OF CONCRETE SLABS ADJACENT TO BUILDING AND ADJUST LOCATION OF THROUGH WALL FLASHING ACCORDINGLY.
- (3) PROVIDE PLASTIC INSERT WEEPS AT ALL AT DOOR, WINDOW AND FLOOR FLASHING.
- (4) GENERAL CONTRACTOR SHALL SLOPE CONCRETE FLOOR TO FLOOR DRAINS AS SHOWN ON PLUMBING DRAWINGS.
- (5) ALL CMU CELLS BELOW FINISH FLOOR SHALL BE FILLED WITH CONCRETE.
- (6) ALL VAPOR BARRIERS UNDER FLOOR SLABS SHALL BE LAPPED 12" MINIMUM AND TAPED CONTINUOUS AT JOINTS. GENERAL CONTRACTOR SHALL REPAIR ANY DAMAGED VAPOR BARRIER PRIOR TO PLACING CONCRETE.
- (7) PROVIDE 4" MINIMUM SPRAY POLYURETHANE INSULATION IN ALL METAL STUDS EXTERIOR WALLS. SEE WALL SECTIONS AND SPECIFICATIONS.
- (8) PROVIDE SPRAY POLYURETHANE INSULATION IN ALL NESTED METAL STUD WINDOW AND DOOR JAMBS, SILLS AND HEADS.
- (9) ALL INTERIOR METAL STUD/GYPSUM WALLBOARD PARTITIONS REQUIRE SOUND ATTENUATION BATTS.
- (10) PROVIDE METAL CHAIRS UNDER ALL STEEL WIRE MATS REINFORCING STEEL FOR CONCRETE SLABS AND FOUNDATIONS.
- (11) PROVIDE GYPSUM CONTROL JOINTS AT ALL GYPSUM / METAL STUD WINDOW JAMBS. SEE INTERIOR ELEVATIONS.
- (12) ALL SEALANT COLORS TO BE SELECTED BY ARCHITECT.
- (13) ROOF INSULATION TAPE ALL ROOF INSULATION JOINTS, BOTH LAYER, LAP AND TAPED VAPOR BARRIER ARCHITECT TO FIELD VERIFY PRIOR TO METAL ROOF PANEL INSTALLATION.
- (14) PROVIDE PRE-FORMED THRU-WALL FLASHING CORNER MEMBERS FOR EXTERIOR WALL CORNERS AS SPECIFIED.

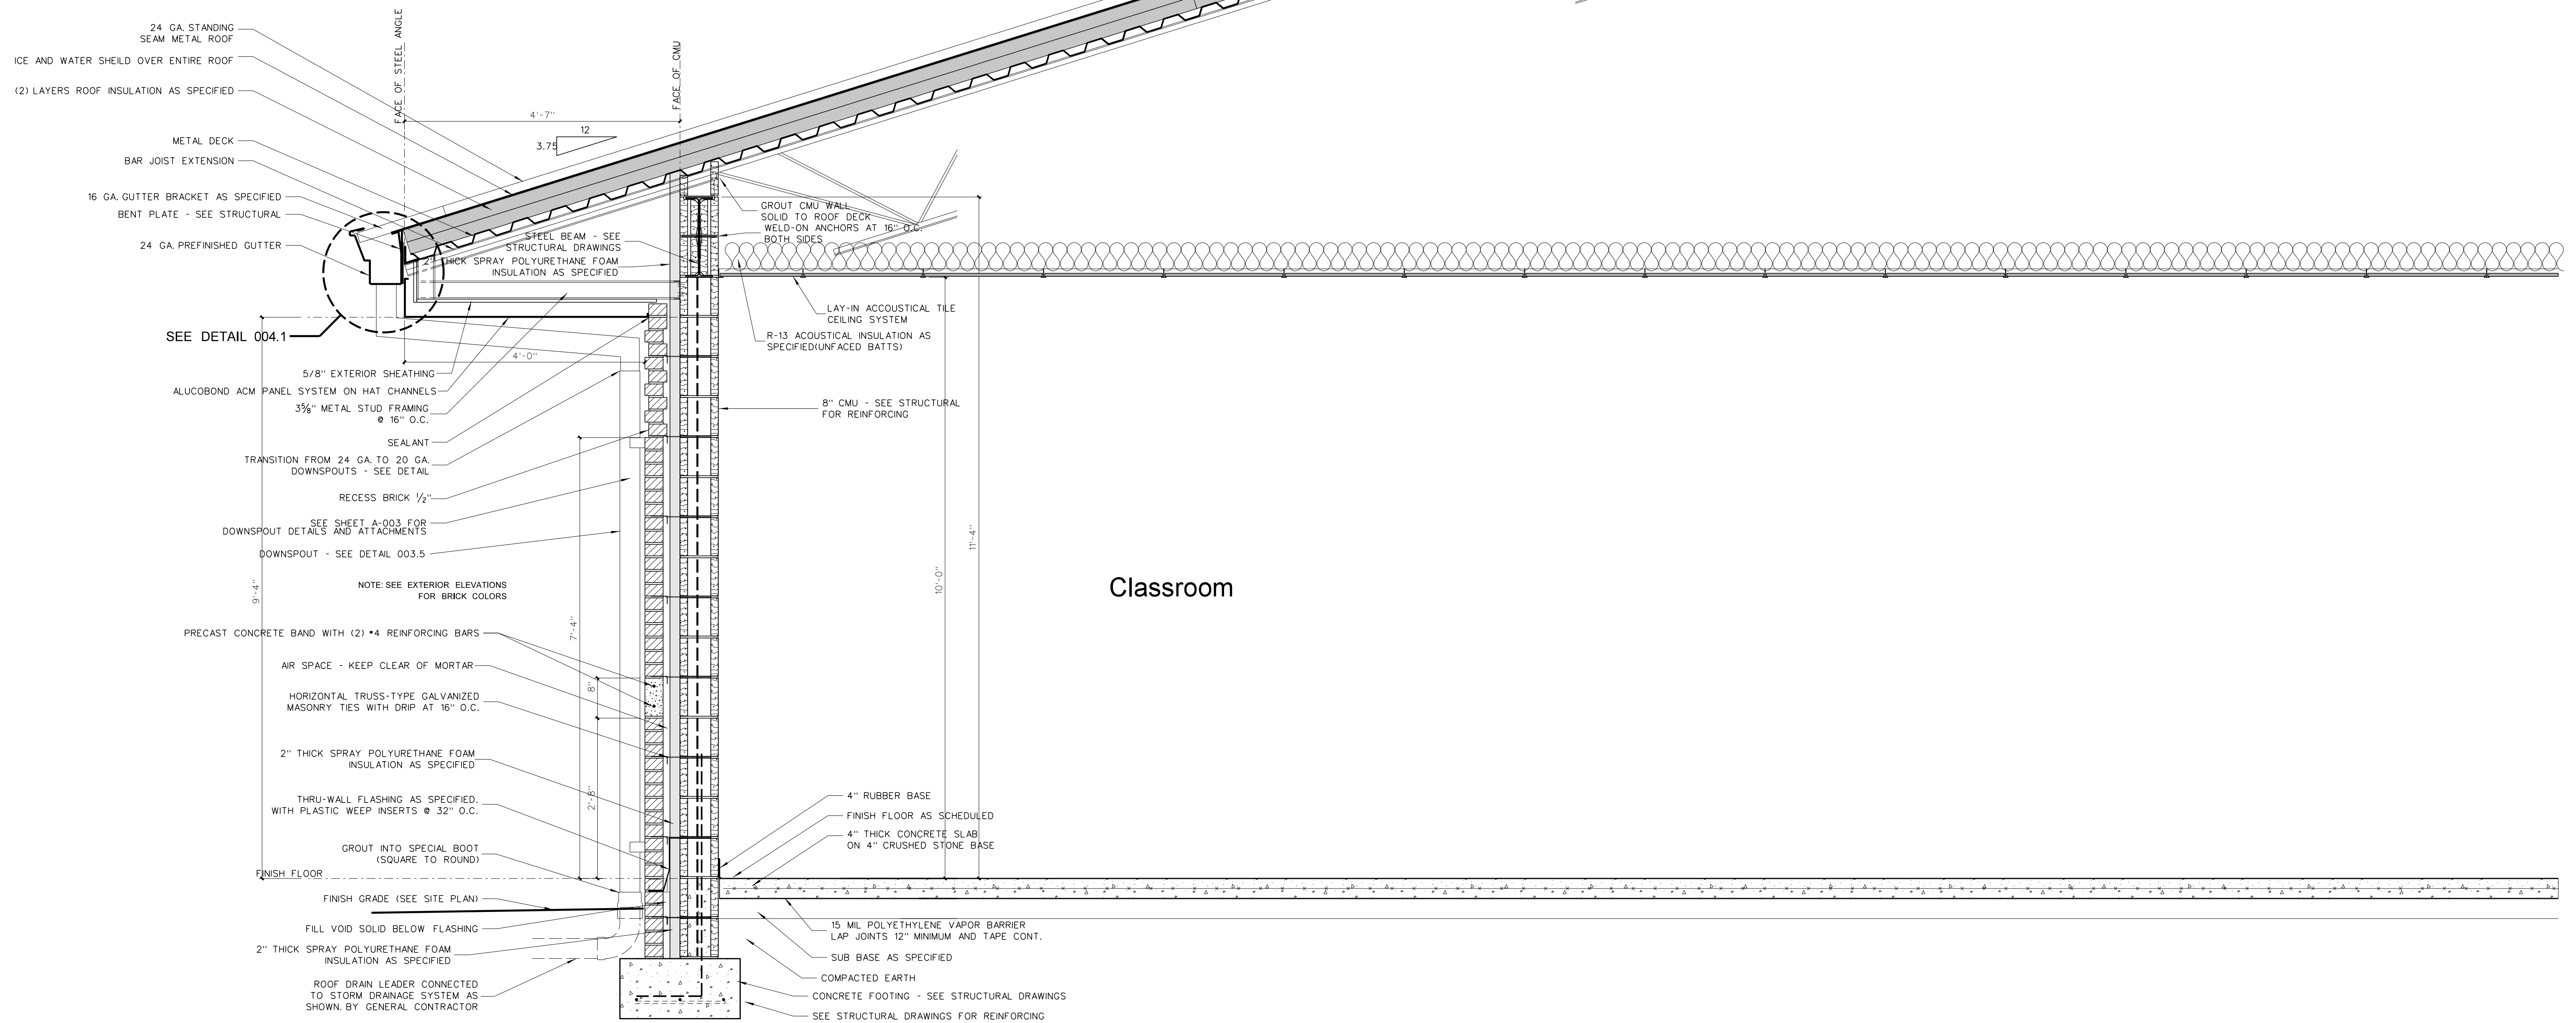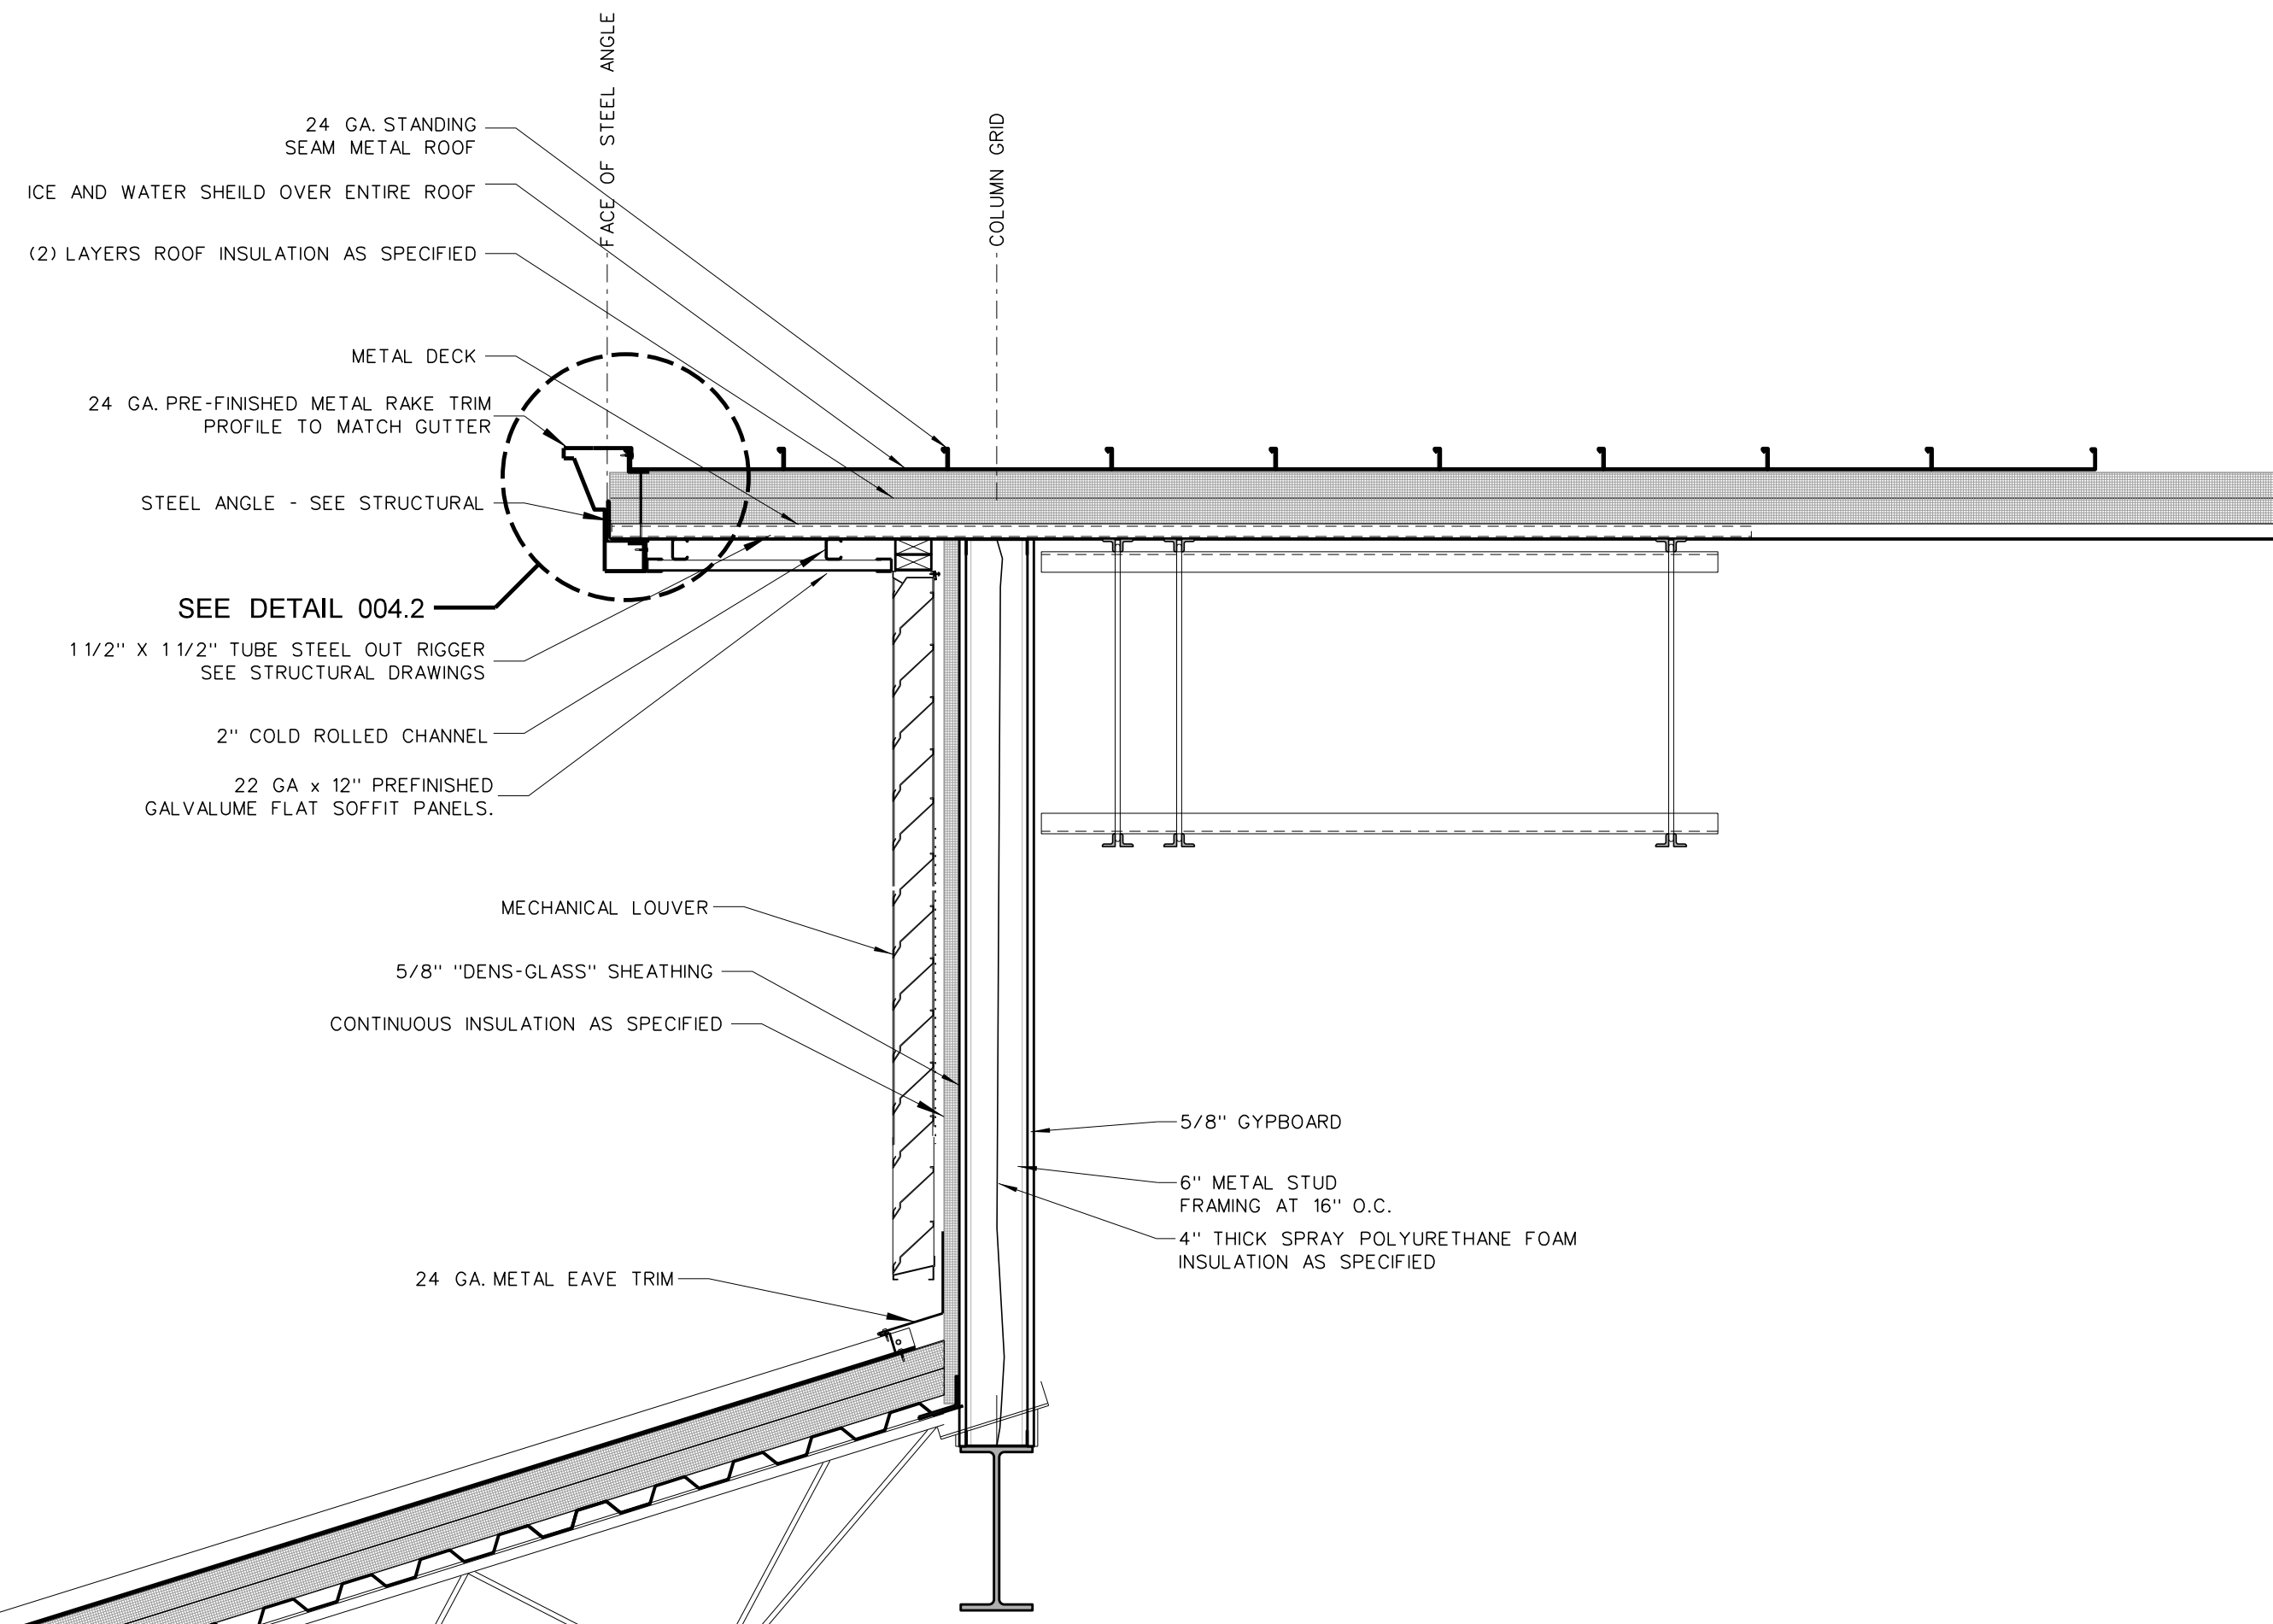


Classroom

820.1 WALL SECTION AT END WALL
SCALE: 3/4" = 1'-0"

No.	Date	Revision

Hite associates
ARCHITECTURE / PLANNING / TECHNOLOGY
2600 Meridian Drive / Greenville, NC 27834 / tel (252) 757-0333

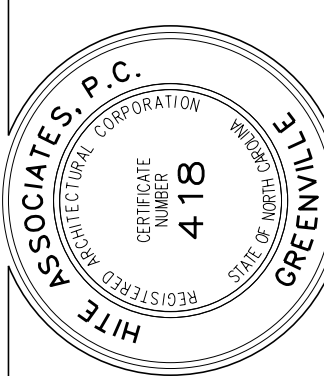

Beaufort PK-3 School
BEAUFORT COUNTY SCHOOLS
Washington / North Carolina / 27889

Project No. 22344

Date: 1 July 2024


Drawing no. A

820

- ### General Notes for Wall Sections
- (1) SEE EXTERIOR ELEVATIONS FOR BRICK COLOR.
 - (2) GENERAL CONTRACTOR SHALL VERIFY TOP OF FINISH GRADES, TOP OF CONCRETE WALLS AND TOP OF CONCRETE SLABS ADJACENT TO BUILDING AND ADJUST LOCATION OF THROUGH WALL FLASHING ACCORDINGLY.
 - (3) PROVIDE PLASTIC INSERT WEEPS AT ALL AT DOOR, WINDOW AND FLOOR FLASHING.
 - (4) GENERAL CONTRACTOR SHALL SLOPE CONCRETE FLOOR TO FLOOR DRAINS AS SHOWN ON PLUMBING DRAWINGS.
 - (5) ALL CMU CELLS BELOW FINISH FLOOR SHALL BE FILLED WITH CONCRETE.
 - (6) ALL VAPOR BARRIERS UNDER FLOOR SLABS SHALL BE LAPPED 12" MINIMUM AND TAPED CONTINUOUS AT JOINTS. GENERAL CONTRACTOR SHALL REPAIR ANY DAMAGED VAPOR BARRIER PRIOR TO PLACING CONCRETE.
 - (7) PROVIDE 4" MINIMUM SPRAY POLYURETHANE INSULATION IN ALL METAL STUDS EXTERIOR WALLS. SEE WALL SECTIONS AND SPECIFICATIONS.
 - (8) PROVIDE SPRAY POLYURETHANE INSULATION IN ALL NESTED METAL STUD WINDOW AND DOOR JAMBS, SILLS AND HEADS.
 - (9) ALL INTERIOR METAL STUD/GYPSUM WALLBOARD PARTITIONS REQUIRE SOUND ATTENUATION BATTS.
 - (10) PROVIDE METAL CHAIRS UNDER ALL STEEL WIRE MATS REINFORCING STEEL FOR CONCRETE SLABS AND FOUNDATIONS.
 - (11) PROVIDE GYPSUM CONTROL JOINTS AT ALL GYPSUM / METAL STUD WINDOW JAMBS. SEE INTERIOR ELEVATIONS.
 - (12) ALL SEALANT COLORS TO BE SELECTED BY ARCHITECT.
 - (13) ROOF INSULATION: TAPE ALL ROOF INSULATION JOINTS, BOTH LAYER LAP AND TAPE VAPOR BARRIER ARCHITECT TO FIELD VERIFY PRIOR TO METAL ROOF PANEL INSTALLATION.
 - (14) PROVIDE PRE-FORMED THRU-WALL FLASHING CORNER MEMBERS FOR EXTERIOR WALL CORNERS AS SPECIFIED.




No.	Date	Revision

Hite associates
 ARCHITECTURE / PLANNING / TECHNOLOGY
 2600 Meridian Drive / Greenville, NC 27834 / tel (252) 757-0333

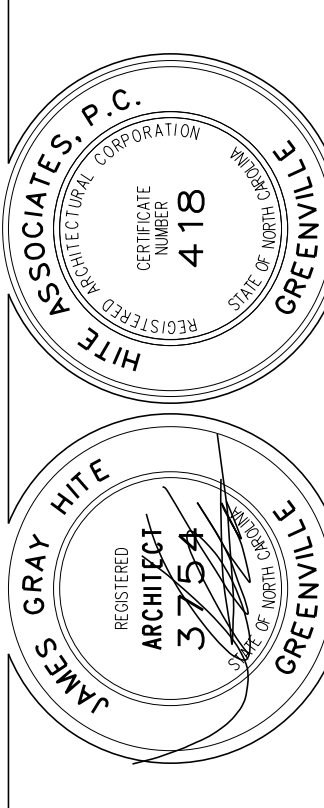

Beaufort PK-3 School
 BEAUFORT COUNTY SCHOOLS
 Washington / North Carolina / 27889


Project No. 22344
 Date: 1 July 2024
 Drawing No. **A 821**

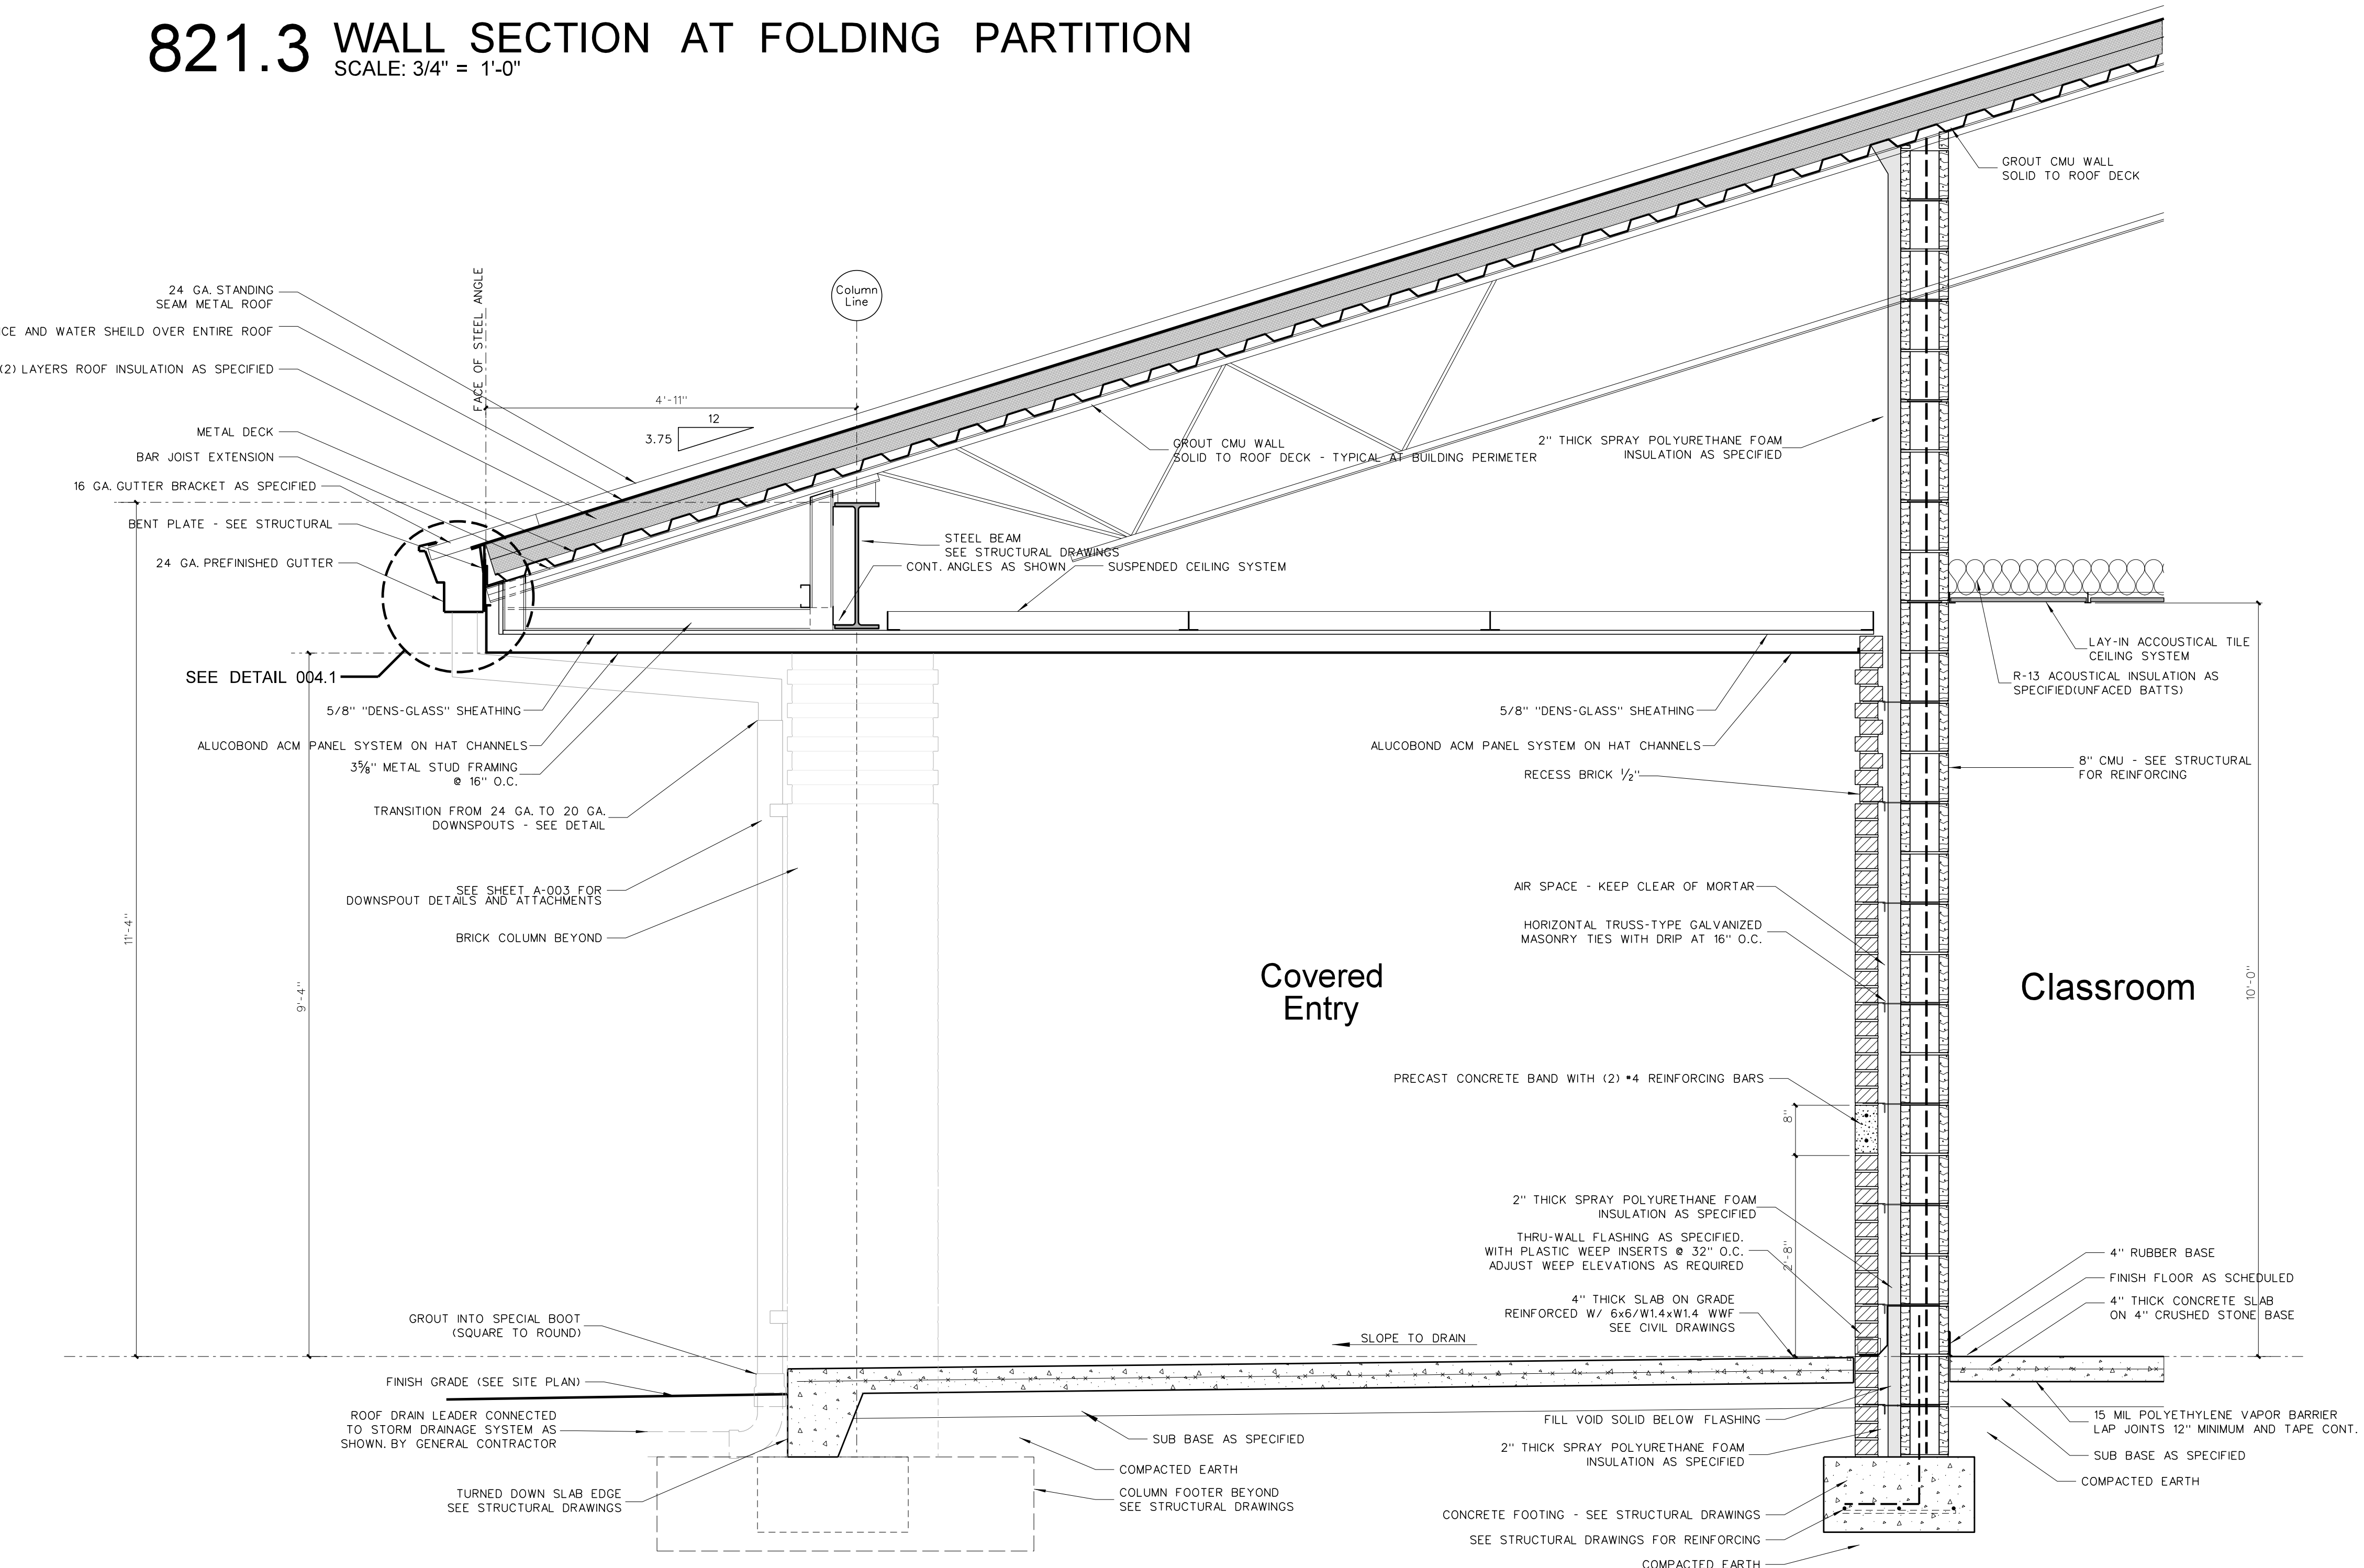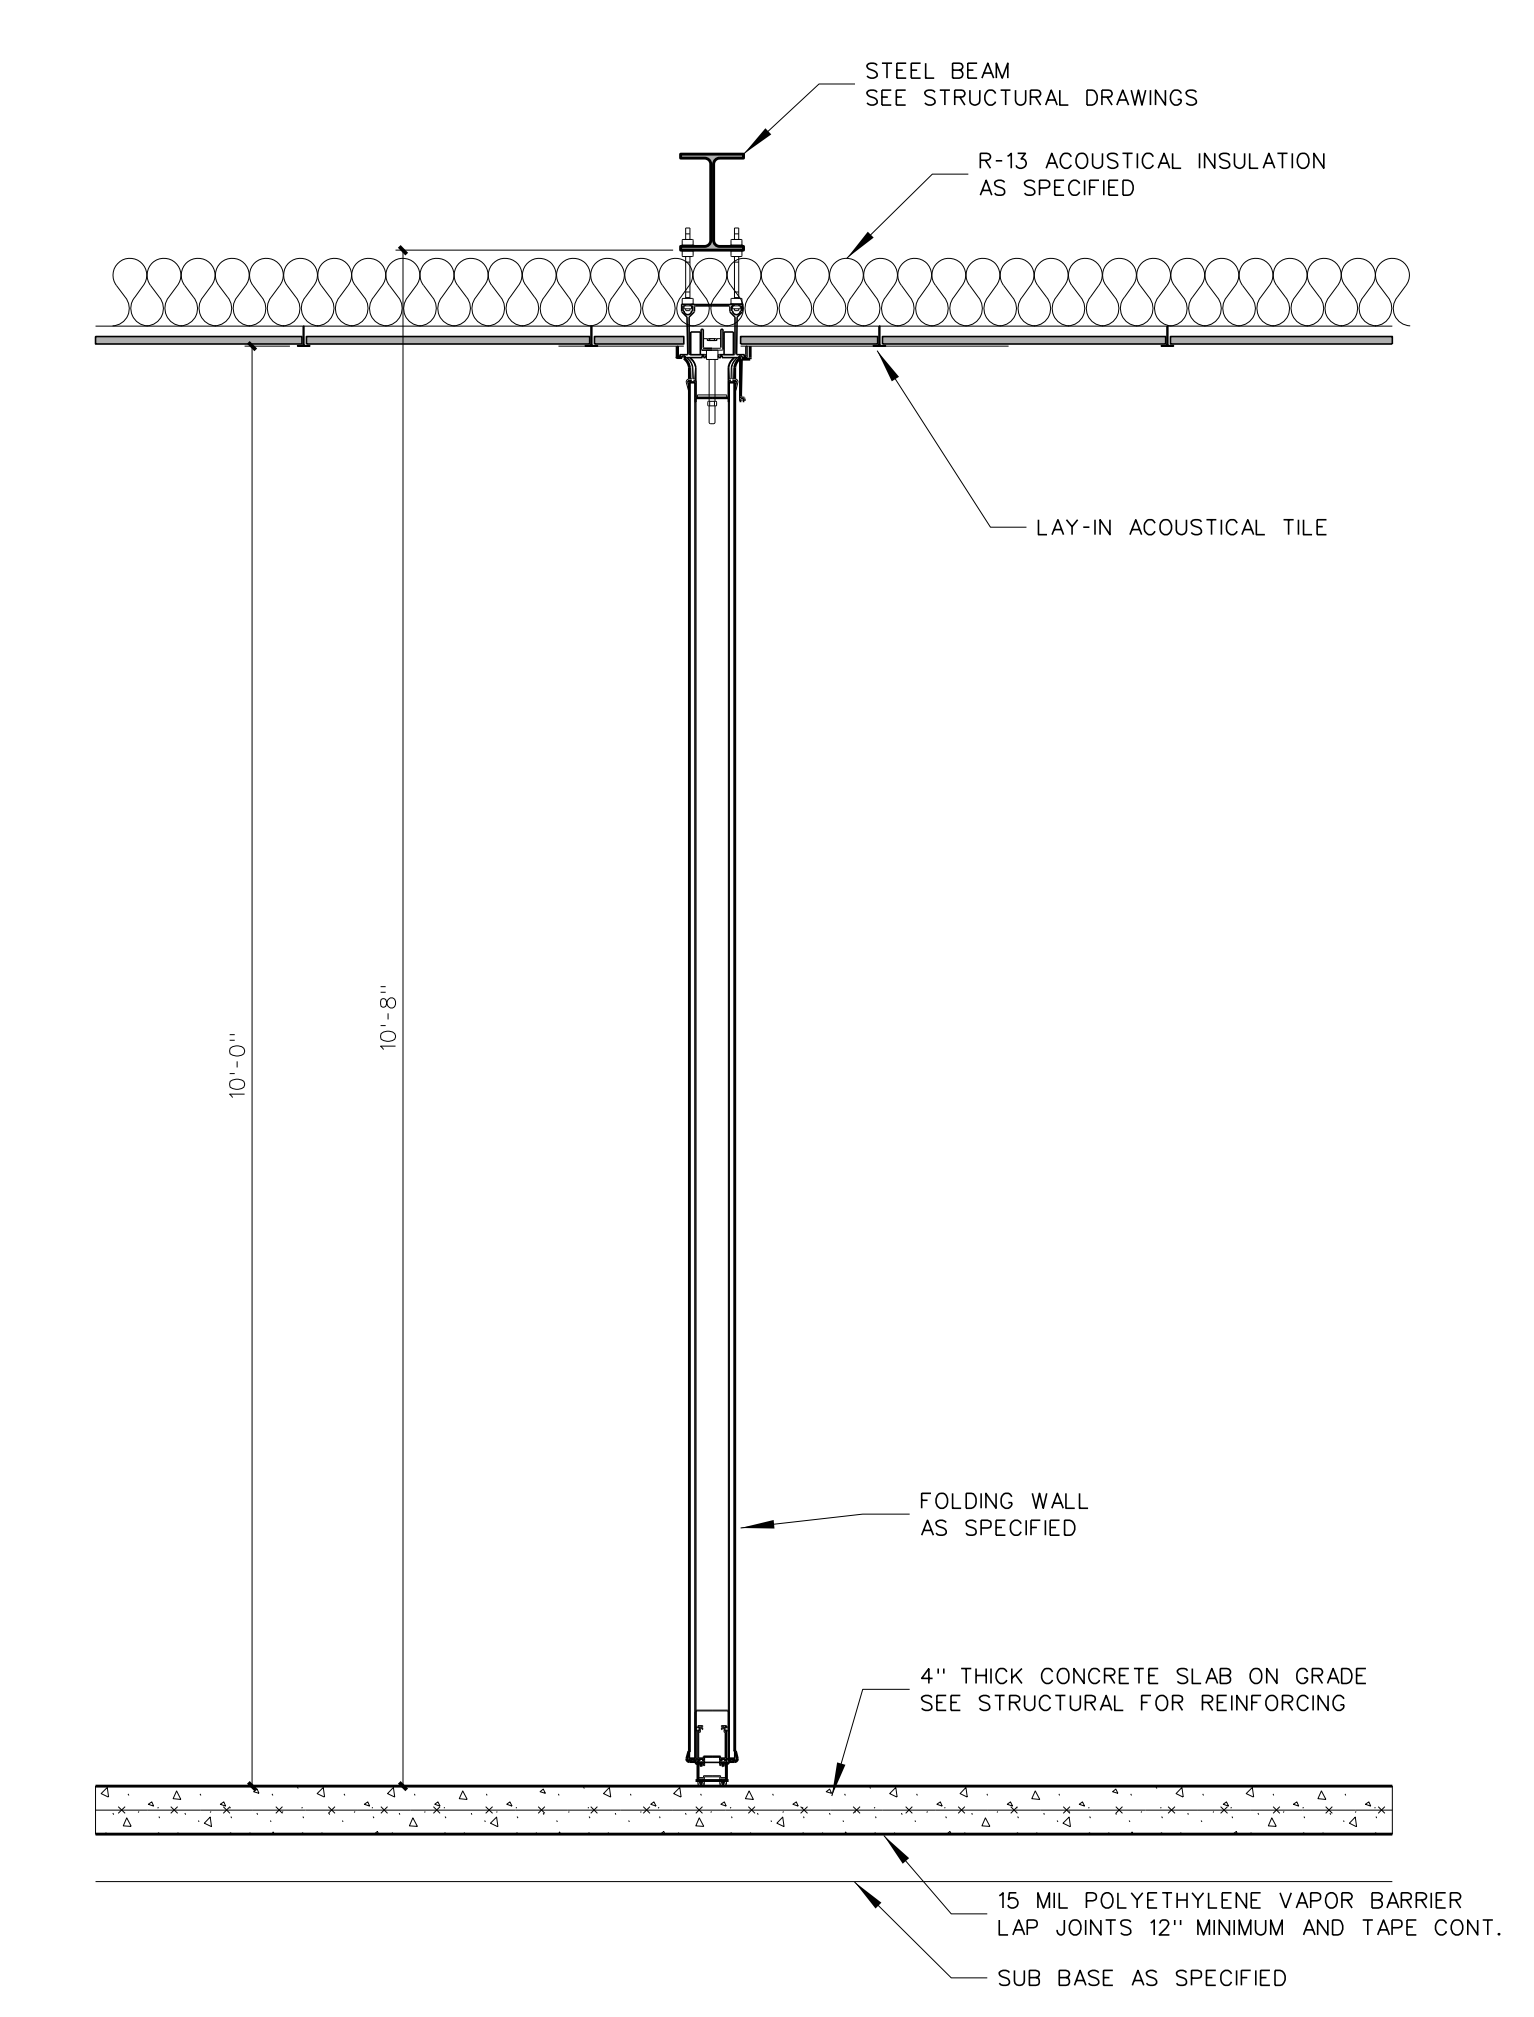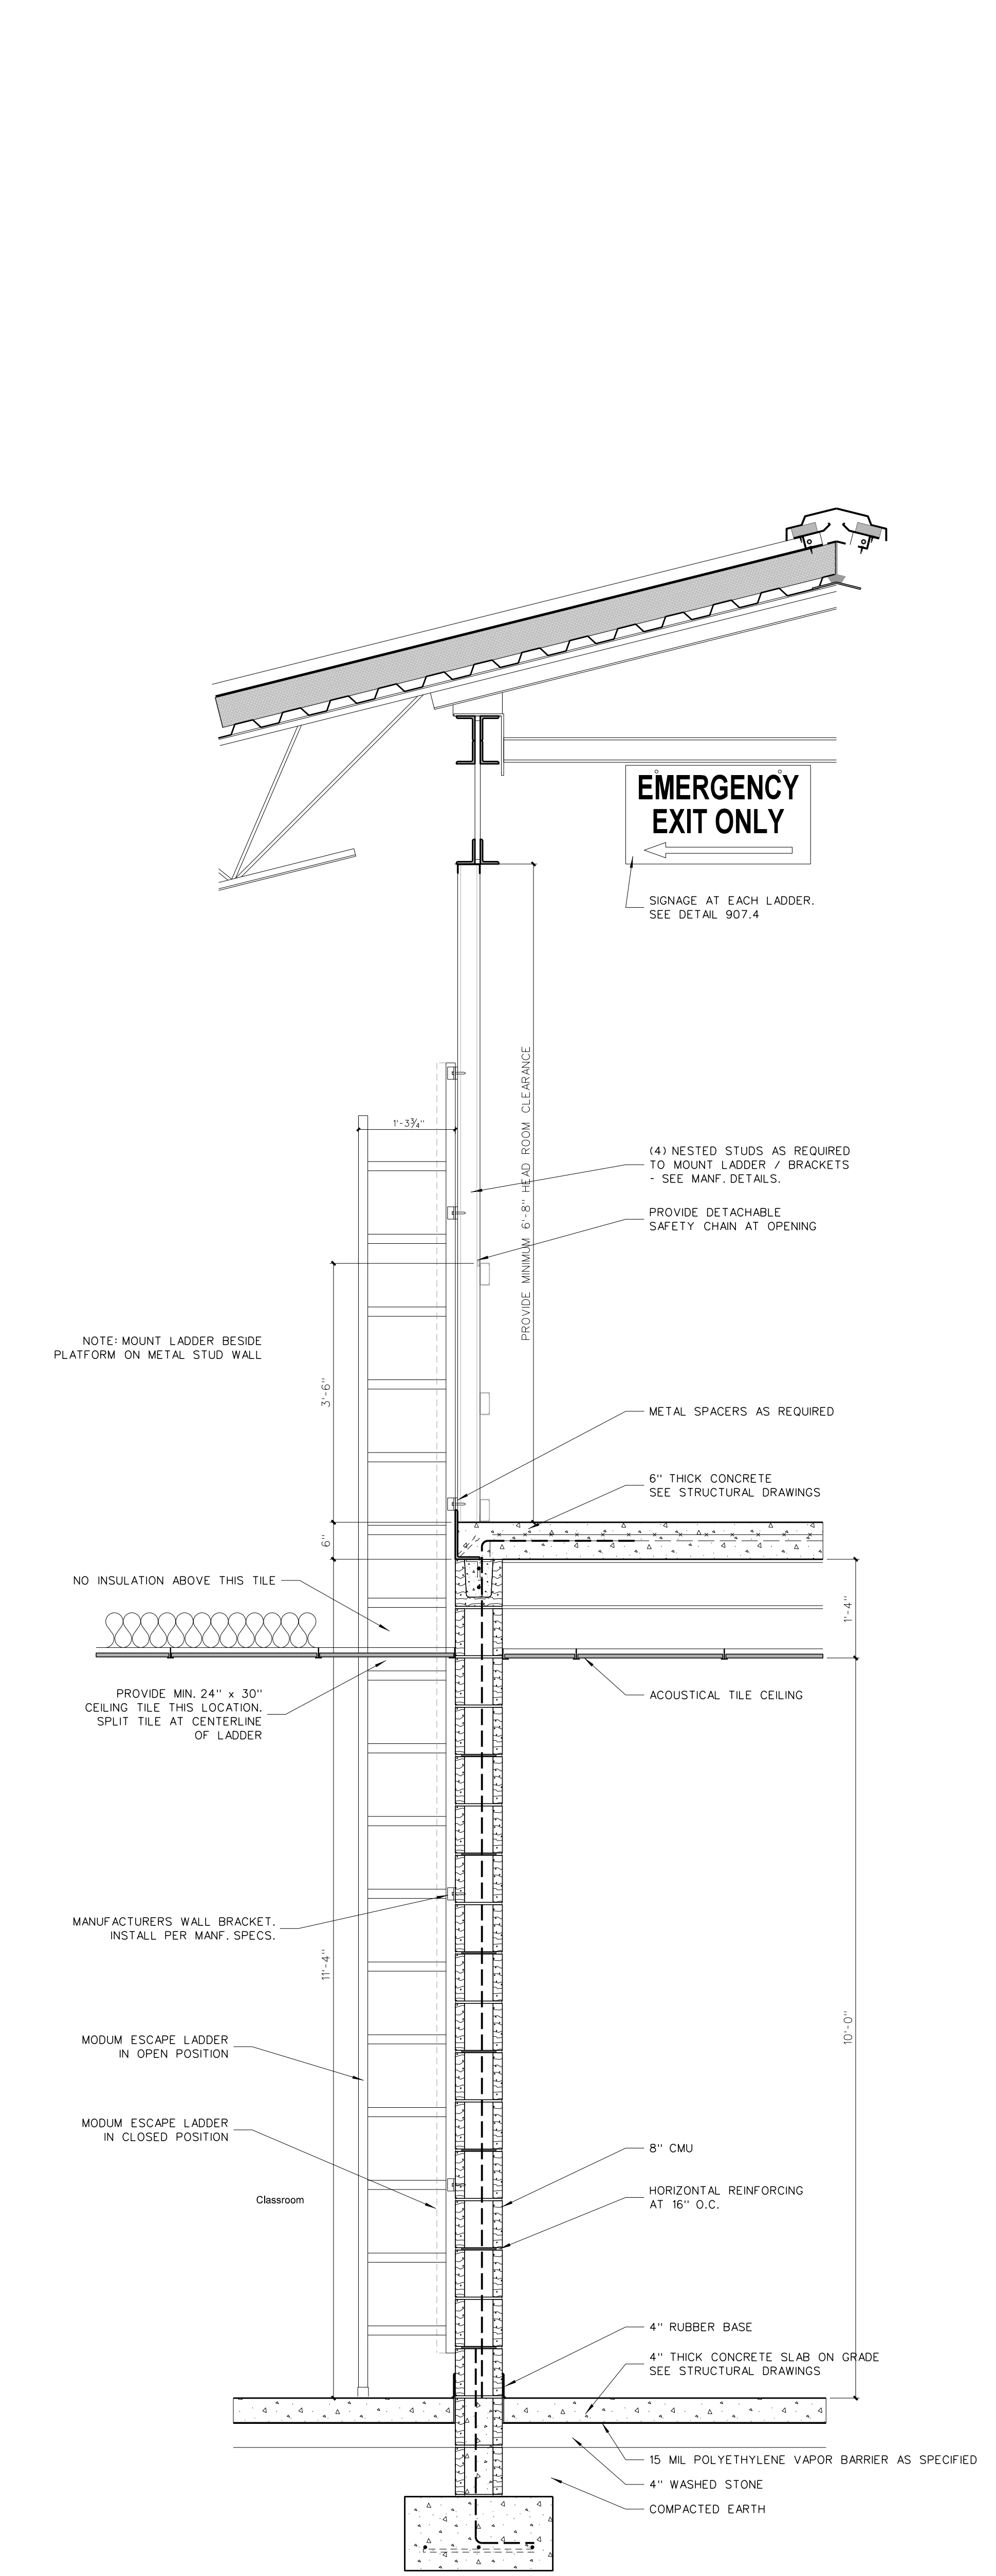

821.2 WALL SECTION AT EGRESS LADDER
 SCALE: 3/4" = 1'-0"

821.1 WALL SECTION AT BUS LOADING
 SCALE: 3/4" = 1'-0"

- ### General Notes for Wall Sections
- (1) SEE EXTERIOR ELEVATIONS FOR BRICK COLOR.
 - (2) GENERAL CONTRACTOR SHALL VERIFY TOP OF FINISH GRADES, TOP OF CONCRETE WALLS AND TOP OF CONCRETE SLABS ADJACENT TO BUILDING AND ADJUST LOCATION OF THROUGH WALL FLASHING ACCORDINGLY.
 - (3) PROVIDE PLASTIC INSERT WEEPS AT ALL AT DOOR, WINDOW AND FLOOR DRAINS AS SHOWN ON PLUMBING DRAWINGS.
 - (4) GENERAL CONTRACTOR SHALL SLOPE CONCRETE FLOOR TO FLOOR DRAINS AS SHOWN ON PLUMBING DRAWINGS.
 - (5) ALL CMU CELLS BELOW FINISH FLOOR SHALL BE FILLED WITH CONCRETE.
 - (6) ALL VAPOR BARRIERS UNDER FLOOR SLABS SHALL BE LAPPED 12" MINIMUM AND TAPED CONTINUOUS AT JOINTS. GENERAL CONTRACTOR SHALL REPAIR ANY DAMAGED VAPOR BARRIER PRIOR TO PLACING CONCRETE.
 - (7) PROVIDE 4" MINIMUM SPRAY POLYURETHANE INSULATION IN ALL METAL STUDS EXTERIOR WALLS. SEE WALL SECTIONS AND SPECIFICATIONS.
 - (8) PROVIDE SPRAY POLYURETHANE INSULATION IN ALL NESTED METAL STUD WINDOW AND DOOR JAMBS, SILLS AND HEADS.
 - (9) ALL INTERIOR METAL STUD/GYPSUM WALLBOARD PARTITIONS REQUIRE SOUND ATTENUATION BATS.
 - (10) PROVIDE METAL CHAIRS UNDER ALL STEEL WIRE MATS REINFORCING STEEL FOR CONCRETE SLABS AND FOUNDATIONS.
 - (11) PROVIDE GYPSUM CONTROL JOINTS AT ALL GYPBOARD / METAL STUD WINDOW JAMBS. SEE INTERIOR ELEVATIONS.
 - (12) ALL SEALANT COLORS TO BE SELECTED BY ARCHITECT.
 - (13) ROOF INSULATION: TAPE ALL ROOF INSULATION JOINTS, BOTH LAYER LAP AND TAPE VAPOR BARRIER. ARCHITECT TO FIELD VERIFY PRIOR TO METAL ROOF PANEL INSTALLATION.
 - (14) PROVIDE PRE-FORMED THRU-WALL FLASHING CORNER MEMBERS FOR EXTERIOR WALL CORNERS AS SPECIFIED.

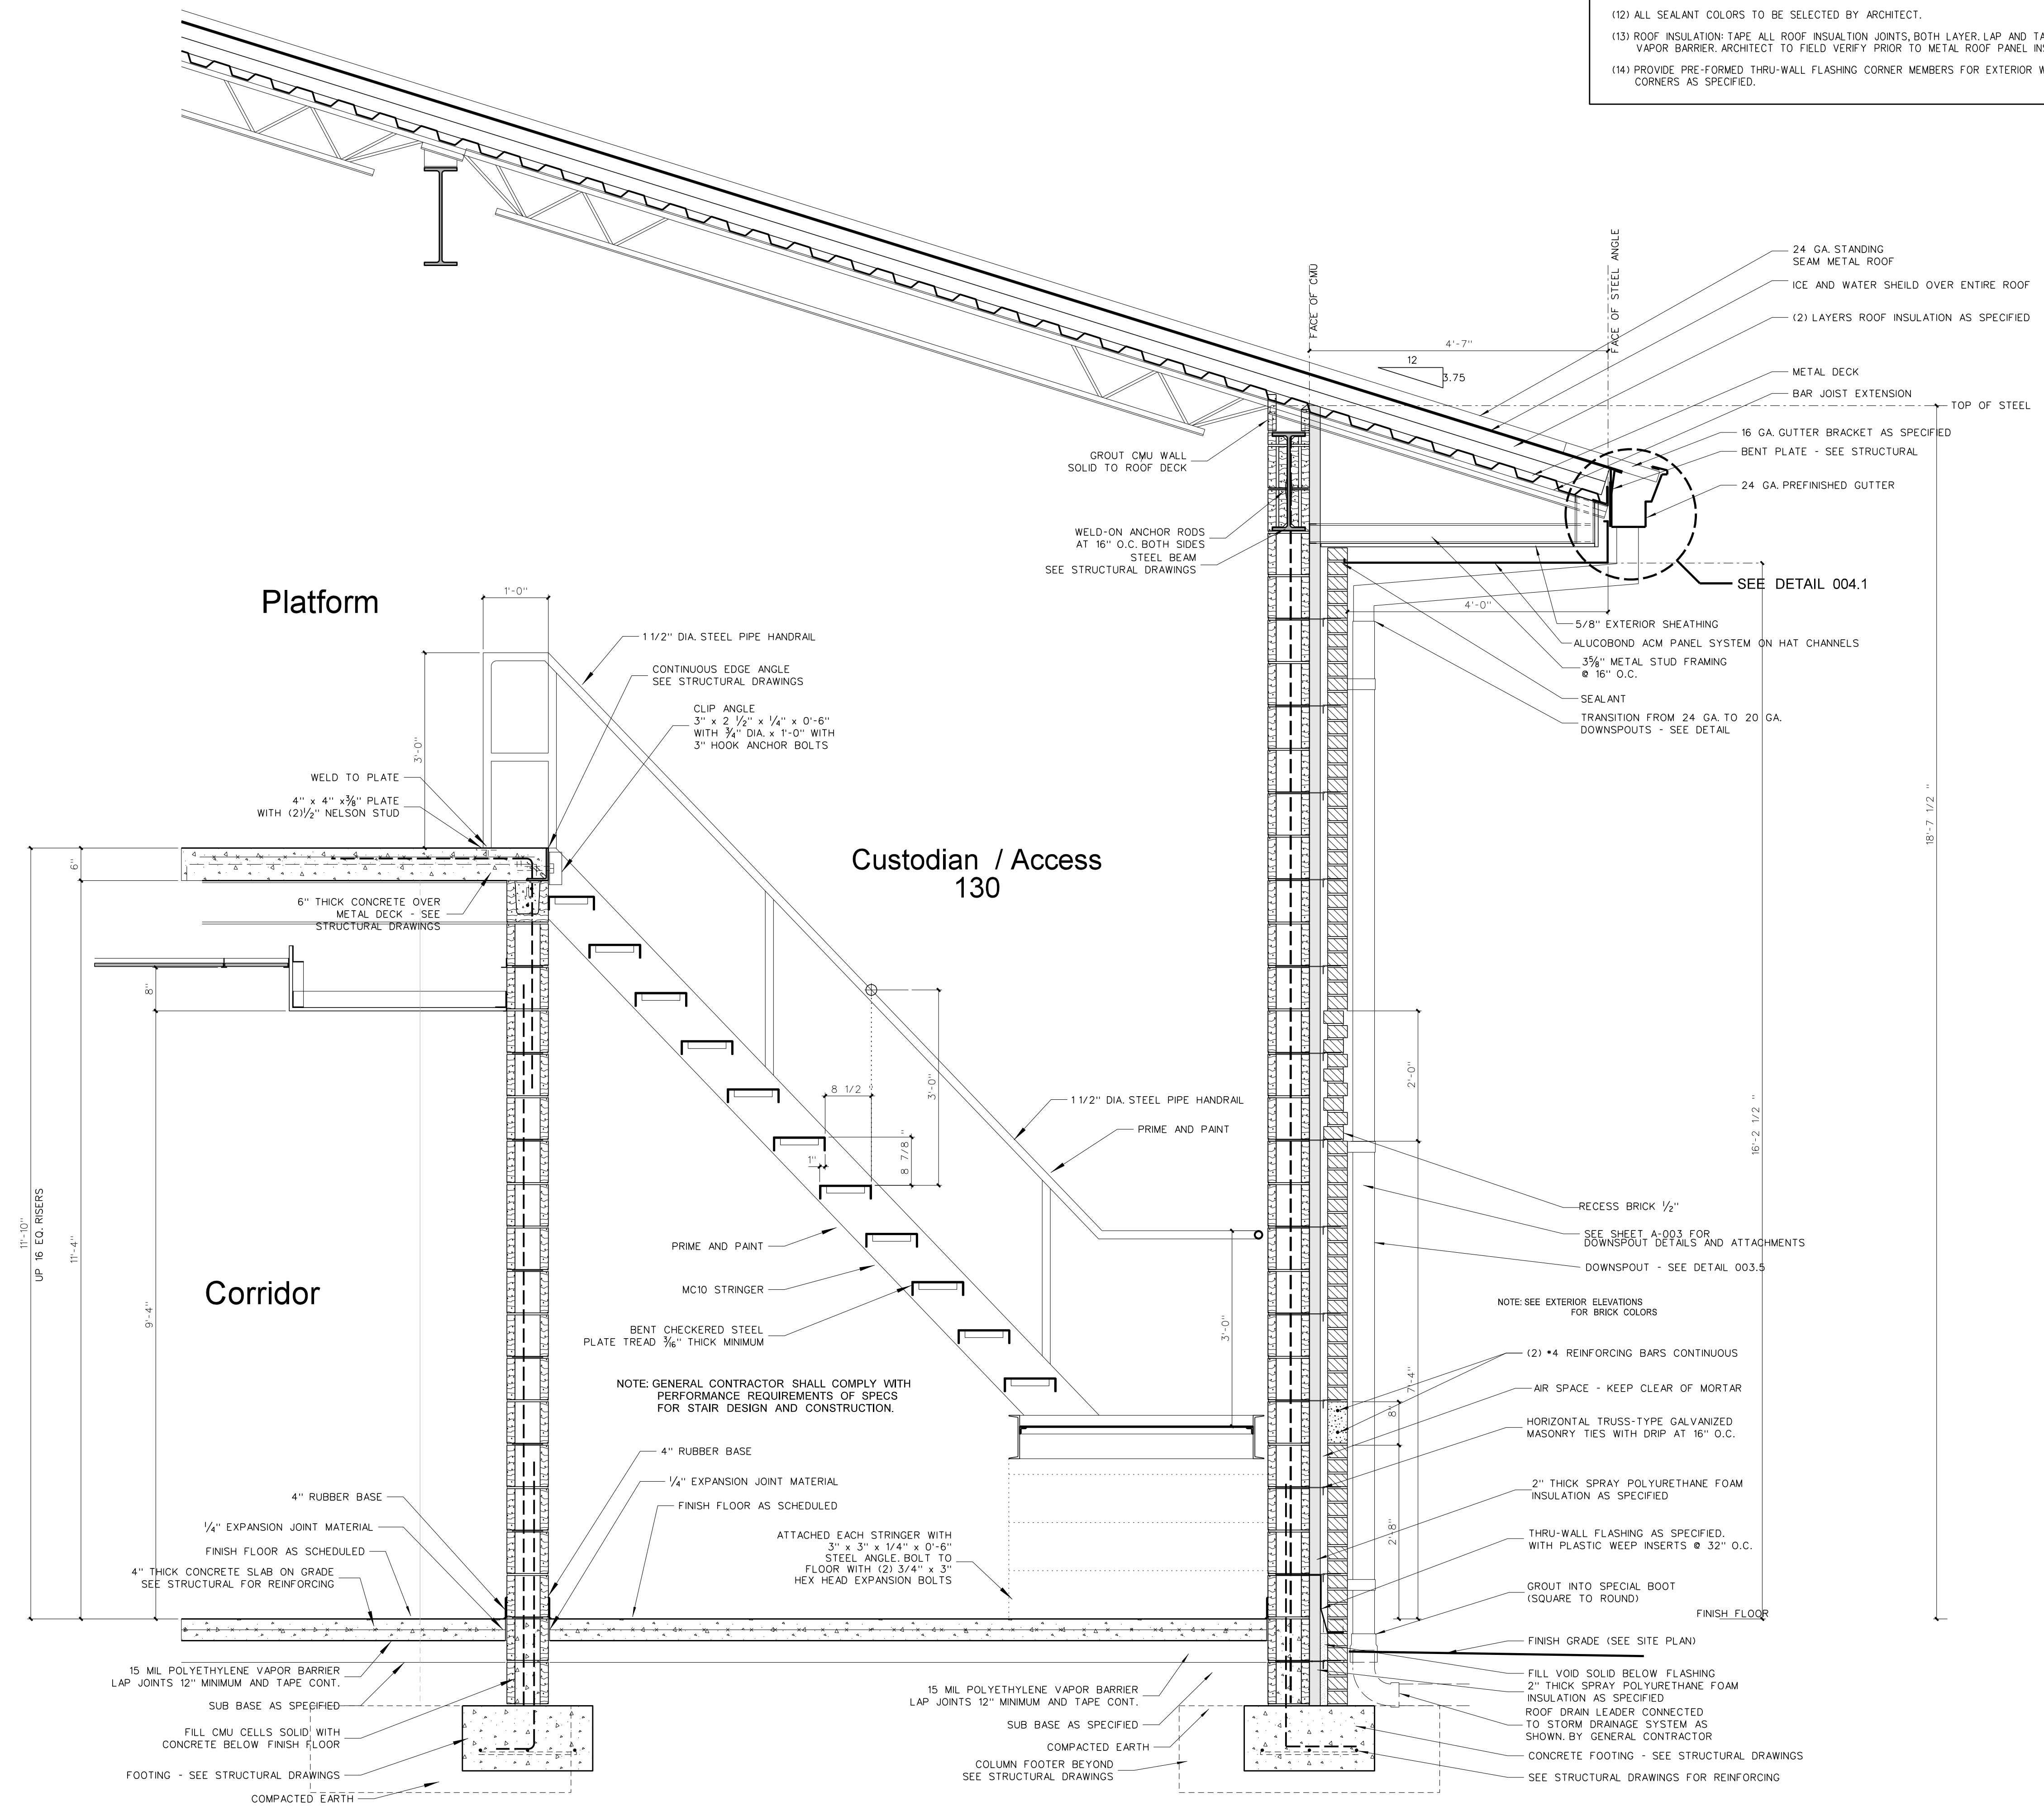


822.1 WALL SECTION AT PLATFORM ACCESS

SCALE: 3/4" = 1'-0"

No.	Date	Revision

Hite associates
 ARCHITECTURE / PLANNING / TECHNOLOGY
 2600 Meridian Drive / Greenville, NC 27834 / tel (252) 757-0333



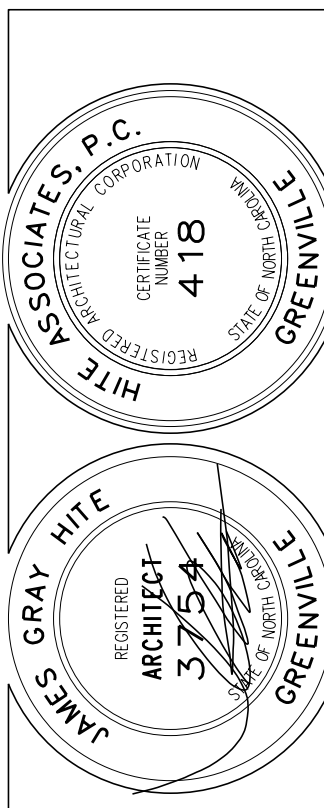


Beaufort PK-3 School
 BEAUFORT COUNTY SCHOOLS
 Washington / North Carolina / 27889

Project No.	22344
Date:	1 July 2024
Drawing no.	A 822

General Notes for Wall Sections

- (1) SEE EXTERIOR ELEVATIONS FOR BRICK COLOR.
- (2) GENERAL CONTRACTOR SHALL VERIFY TOP OF FINISH GRADES, TOP OF CONCRETE WALKS AND TOP OF CONCRETE SLABS ADJACENT TO BUILDING AND ADJUST LOCATION OF THROUGH WALL FLASHING ACCORDINGLY.
- (3) PROVIDE PLASTIC INSERT WEEPS AT ALL AT DOOR, WINDOW AND FLOOR FLASHING.
- (4) GENERAL CONTRACTOR SHALL SLOPE CONCRETE FLOOR TO FLOOR DRAINS AS SHOWN ON PLUMBING DRAWINGS.
- (5) ALL CMU CELLS BELOW FINISH FLOOR SHALL BE FILLED WITH CONCRETE.
- (6) ALL VAPOR BARRIERS UNDER FLOOR SLABS SHALL BE LAPPED 12" MINIMUM AND TAPED CONTINUOUS AT JOINTS. GENERAL CONTRACTOR SHALL REPAIR ANY DAMAGED VAPOR BARRIER PRIOR TO PLACING CONCRETE.
- (7) PROVIDE 4" MINIMUM SPRAY POLYURETHANE INSULATION IN ALL METAL STUDS EXTERIOR WALLS. SEE WALL SECTIONS AND SPECIFICATIONS.
- (8) PROVIDE SPRAY POLYURETHANE INSULATION IN ALL NESTED METAL STUD WINDOW AND DOOR JAMBS, SILLS AND HEADS.
- (9) ALL INTERIOR METAL STUD/GYPSUM PARTITIONS REQUIRE SOUND ATTENUATION BATTS.
- (10) PROVIDE METAL CHAIRS UNDER ALL STEEL WIRE MATS REINFORCING STEEL FOR CONCRETE SLABS AND FOUNDATIONS.
- (11) PROVIDE GYPSUM CONTROL JOINTS AT ALL GYPBOARD / METAL STUD WINDOW JAMBS. SEE INTERIOR ELEVATIONS.
- (12) ALL SEALANT COLORS TO BE SELECTED BY ARCHITECT.
- (13) ROOF INSULATION TAPE ALL ROOF INSULATION JOINTS, BOTH LAYER LAP AND TAPE VAPOR BARRIER ARCHITECT TO FIELD VERIFY PRIOR TO METAL ROOF PANEL INSTALLATION.
- (14) PROVIDE PRE-FORMED THRU-WALL FLASHING CORNER MEMBERS FOR EXTERIOR WALL CORNERS AS SPECIFIED.

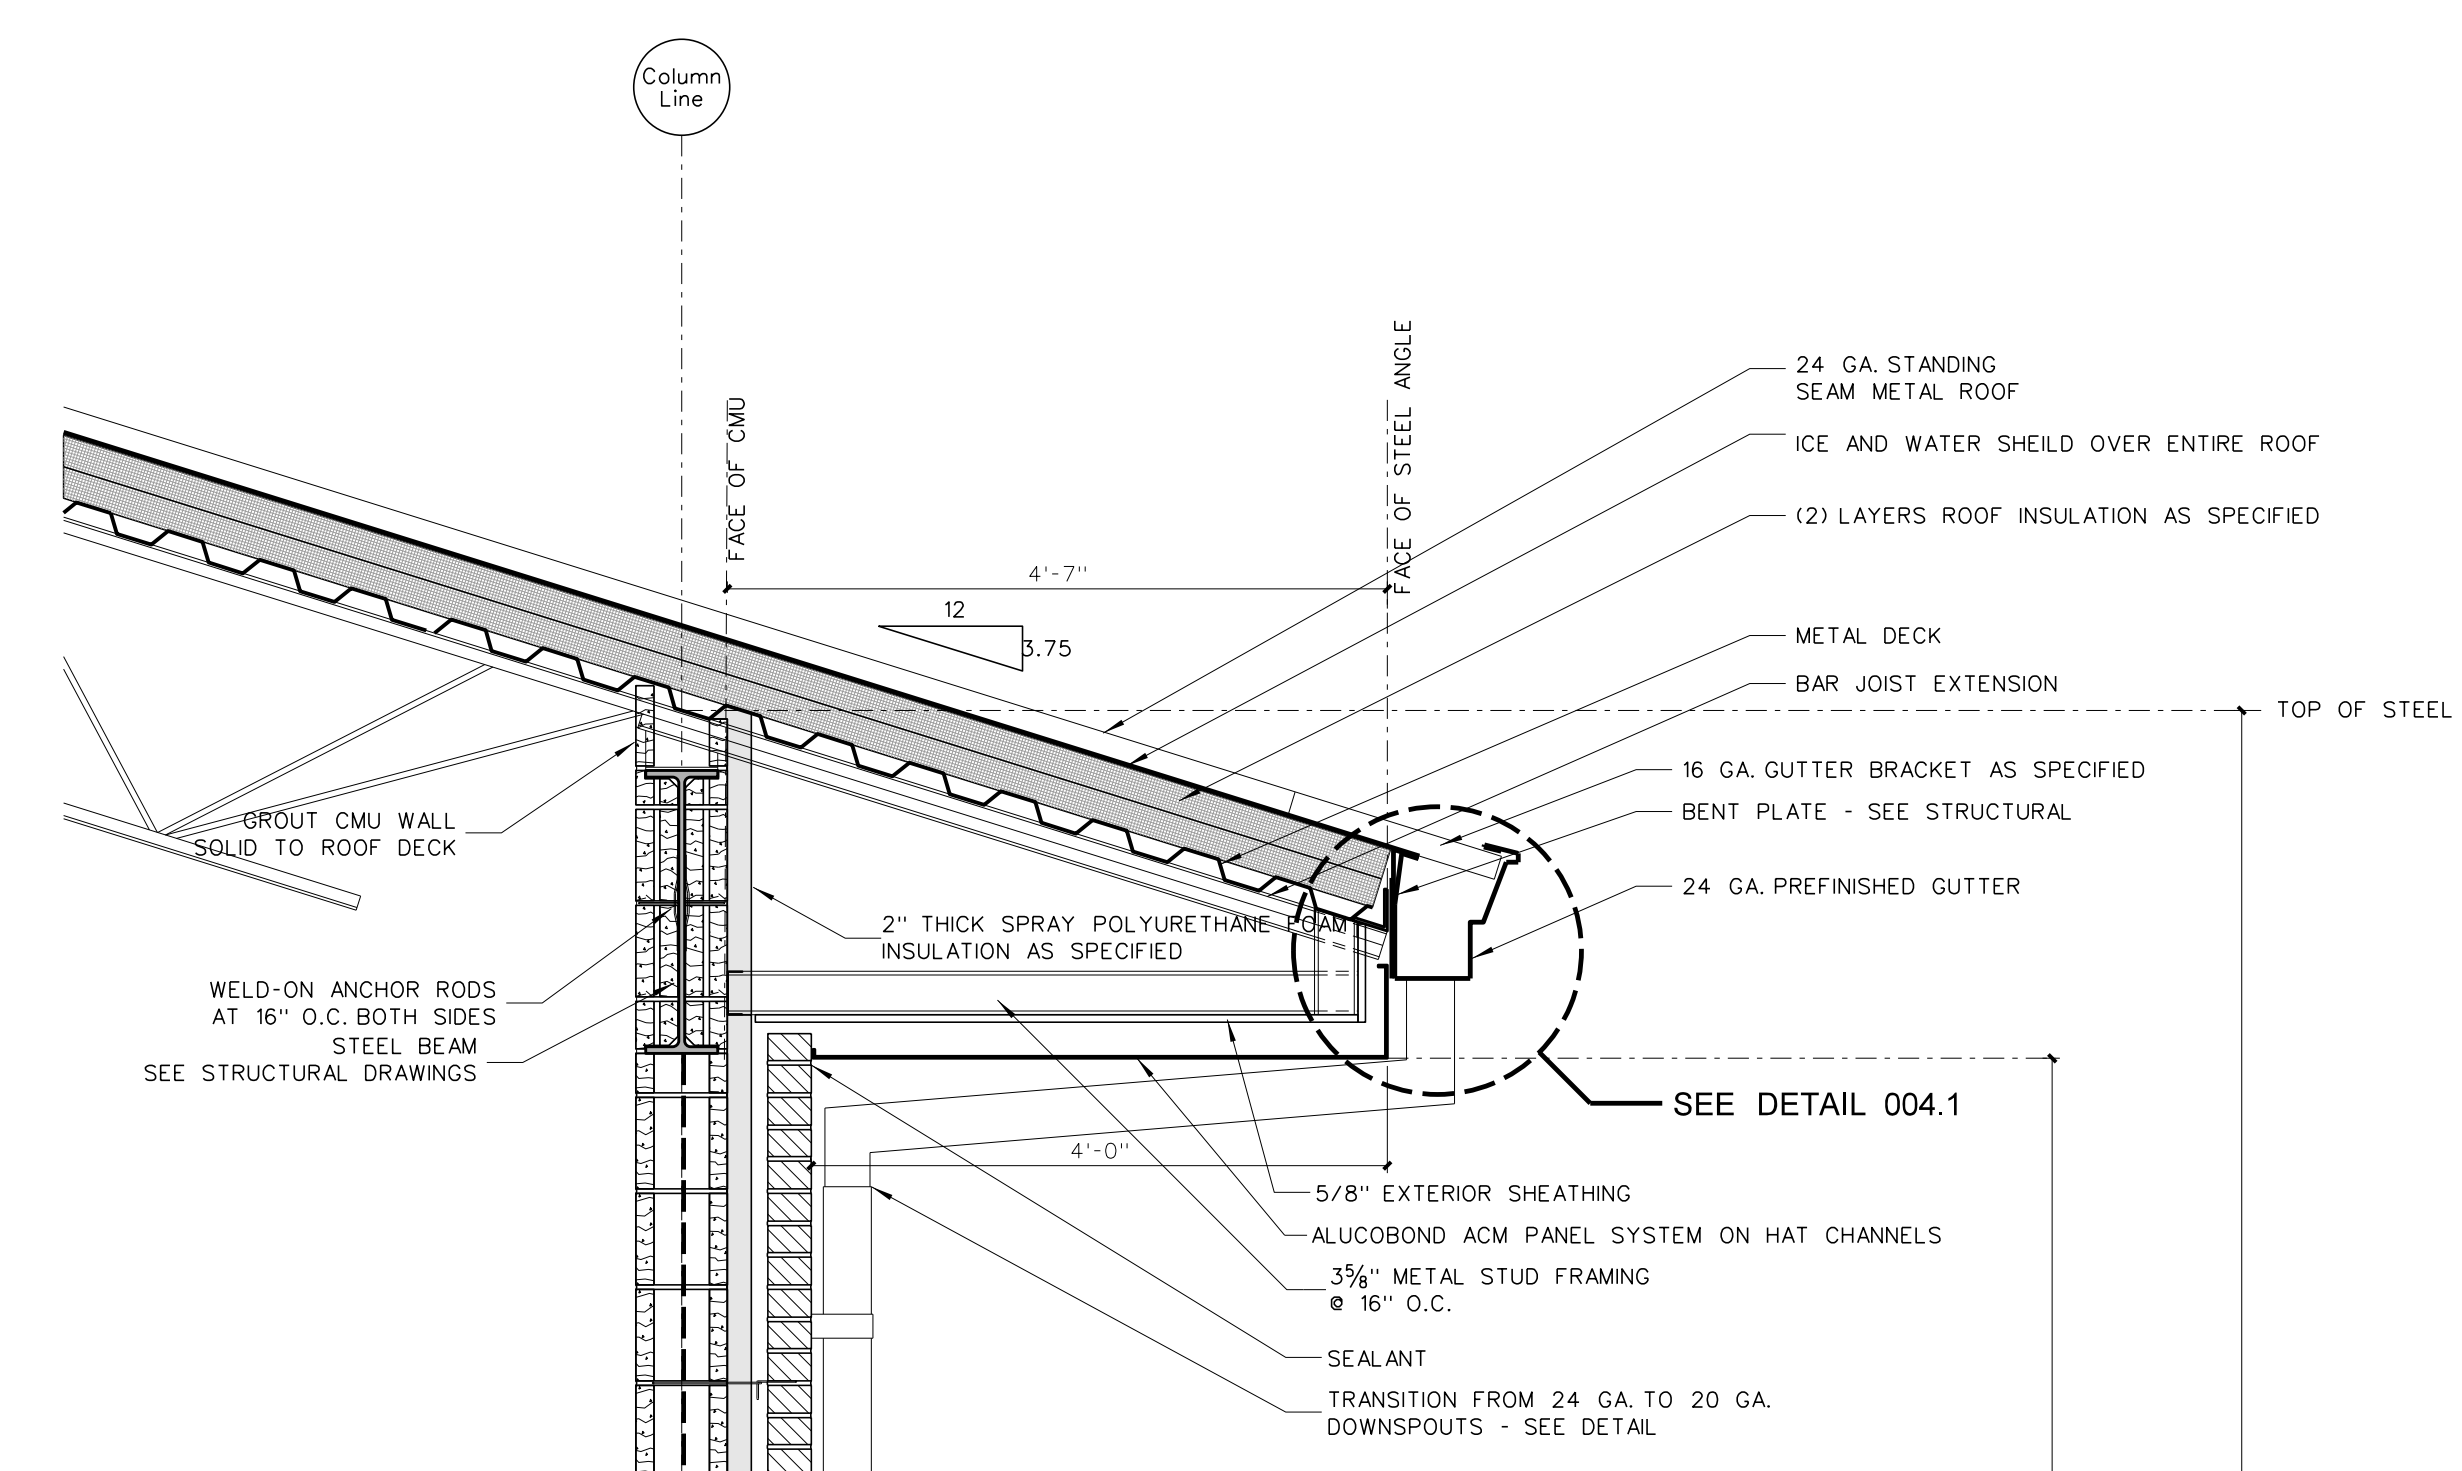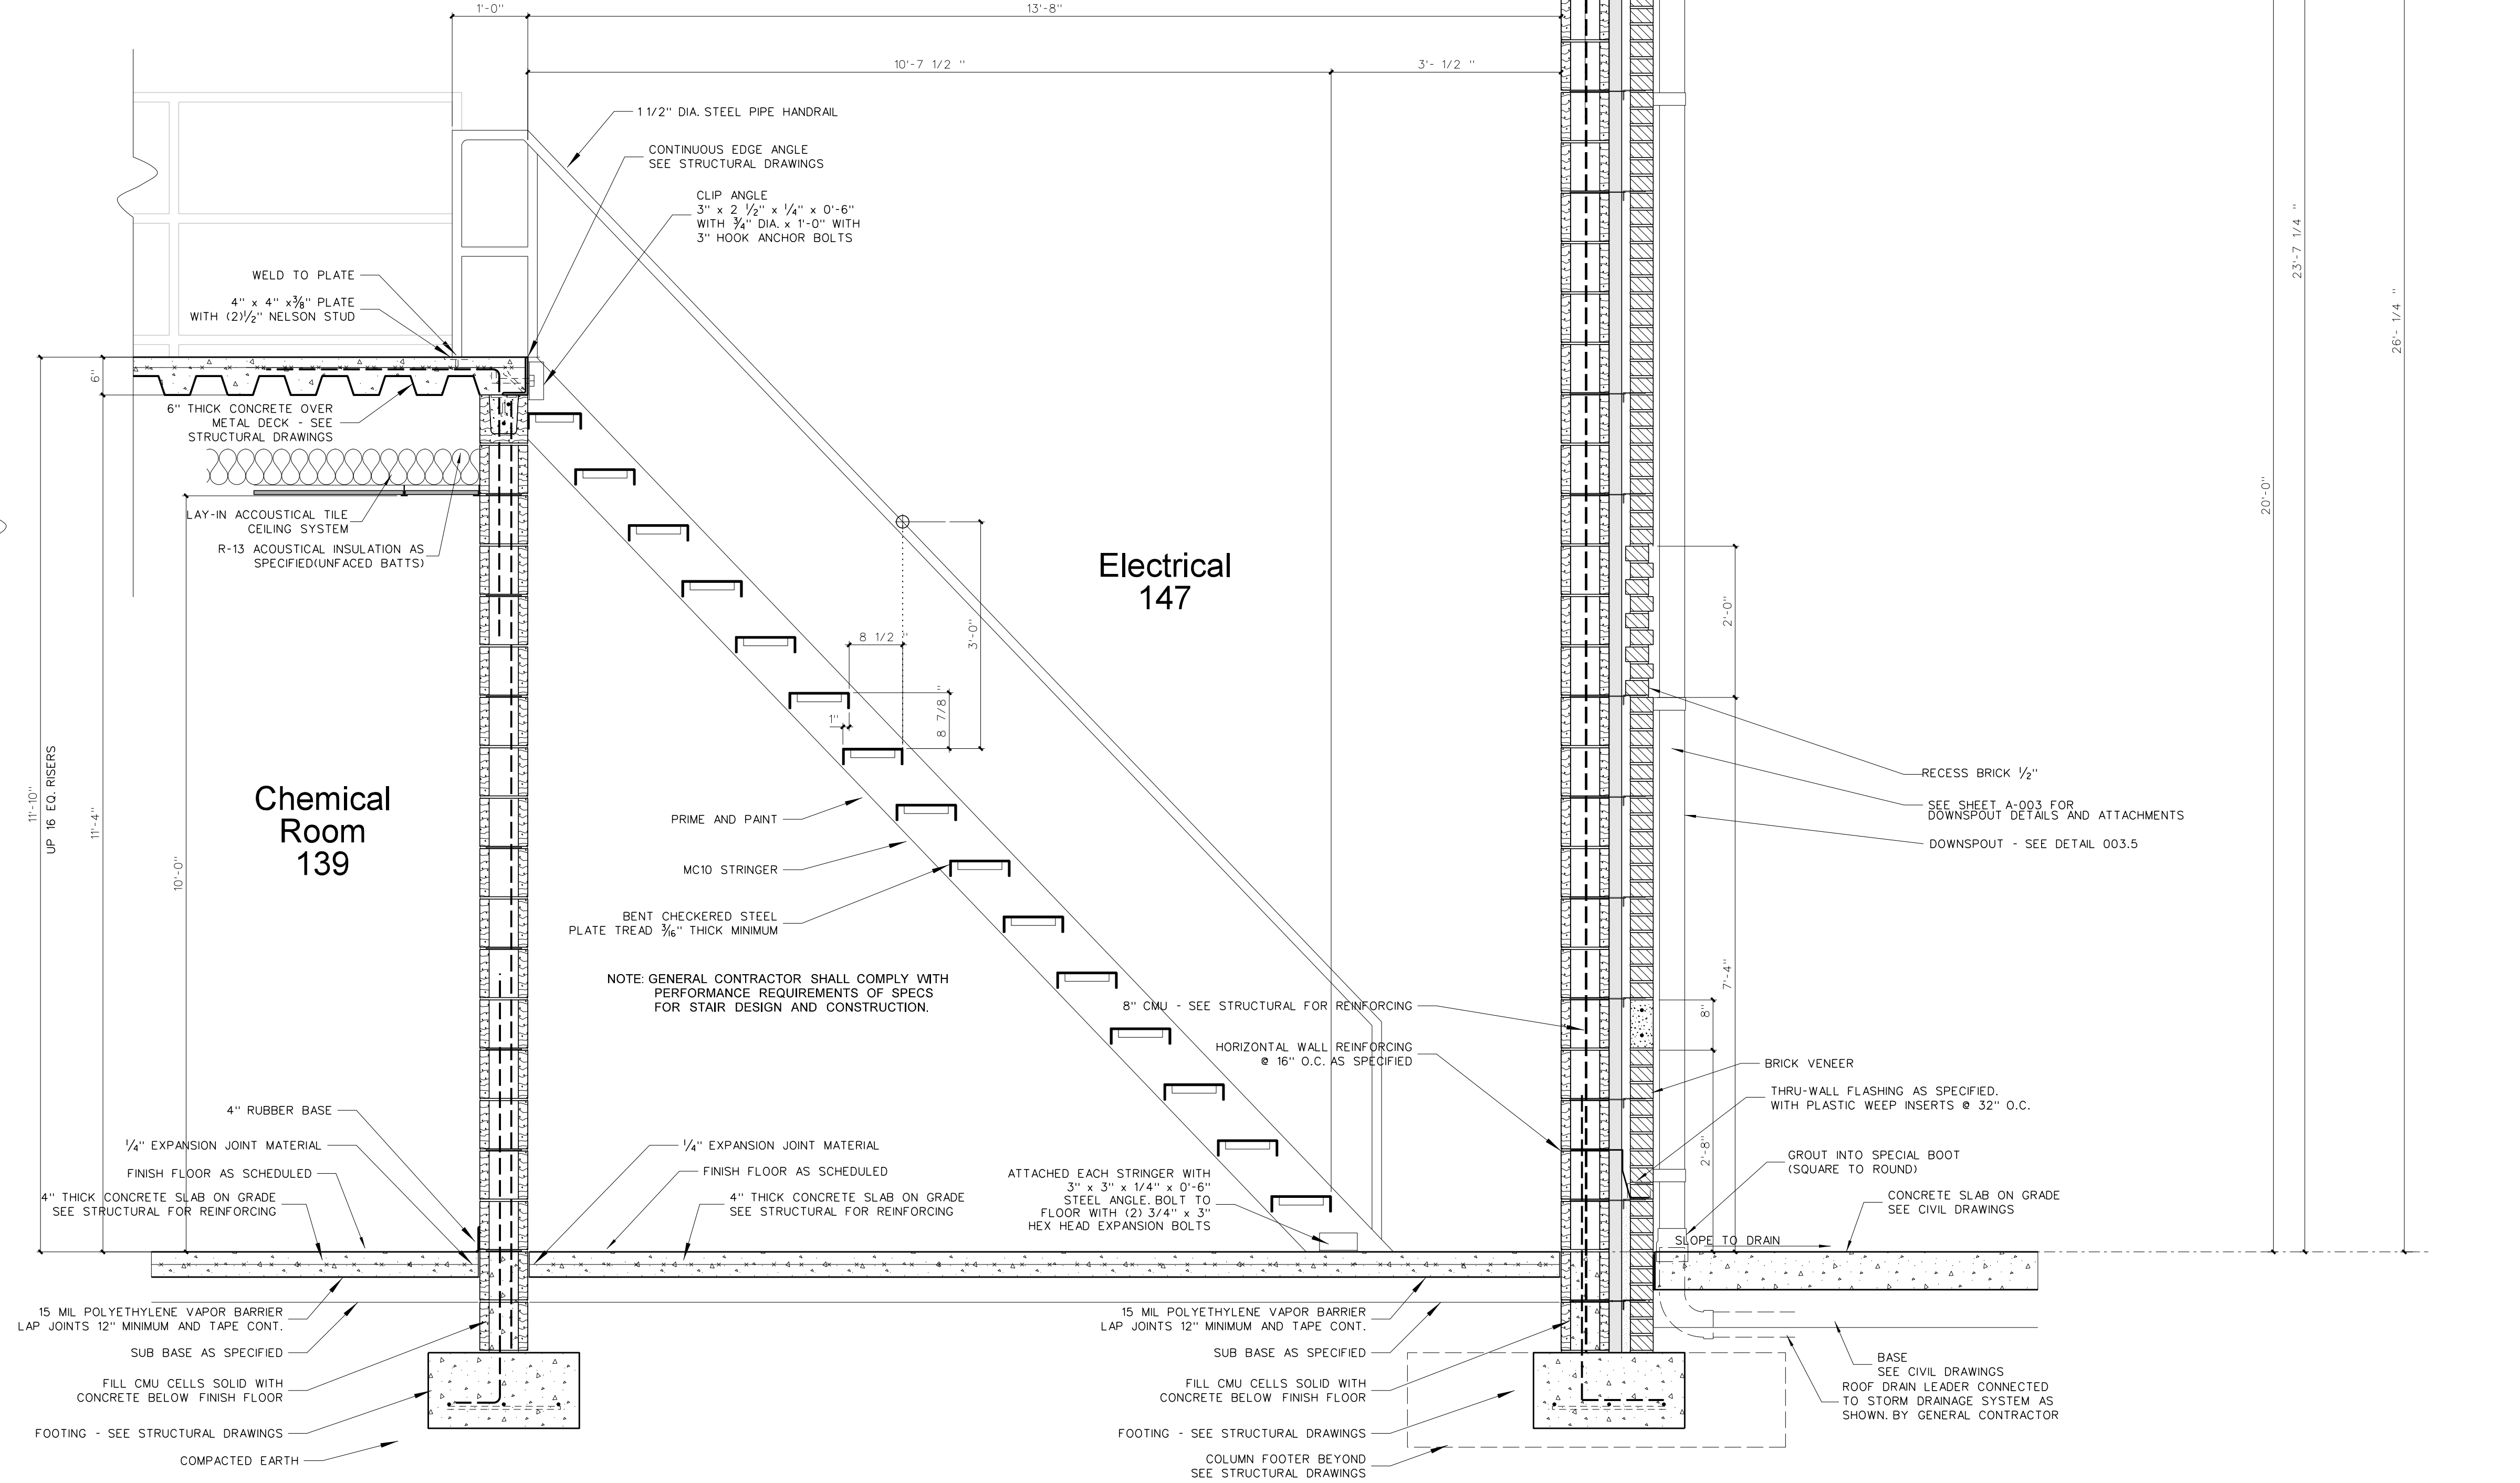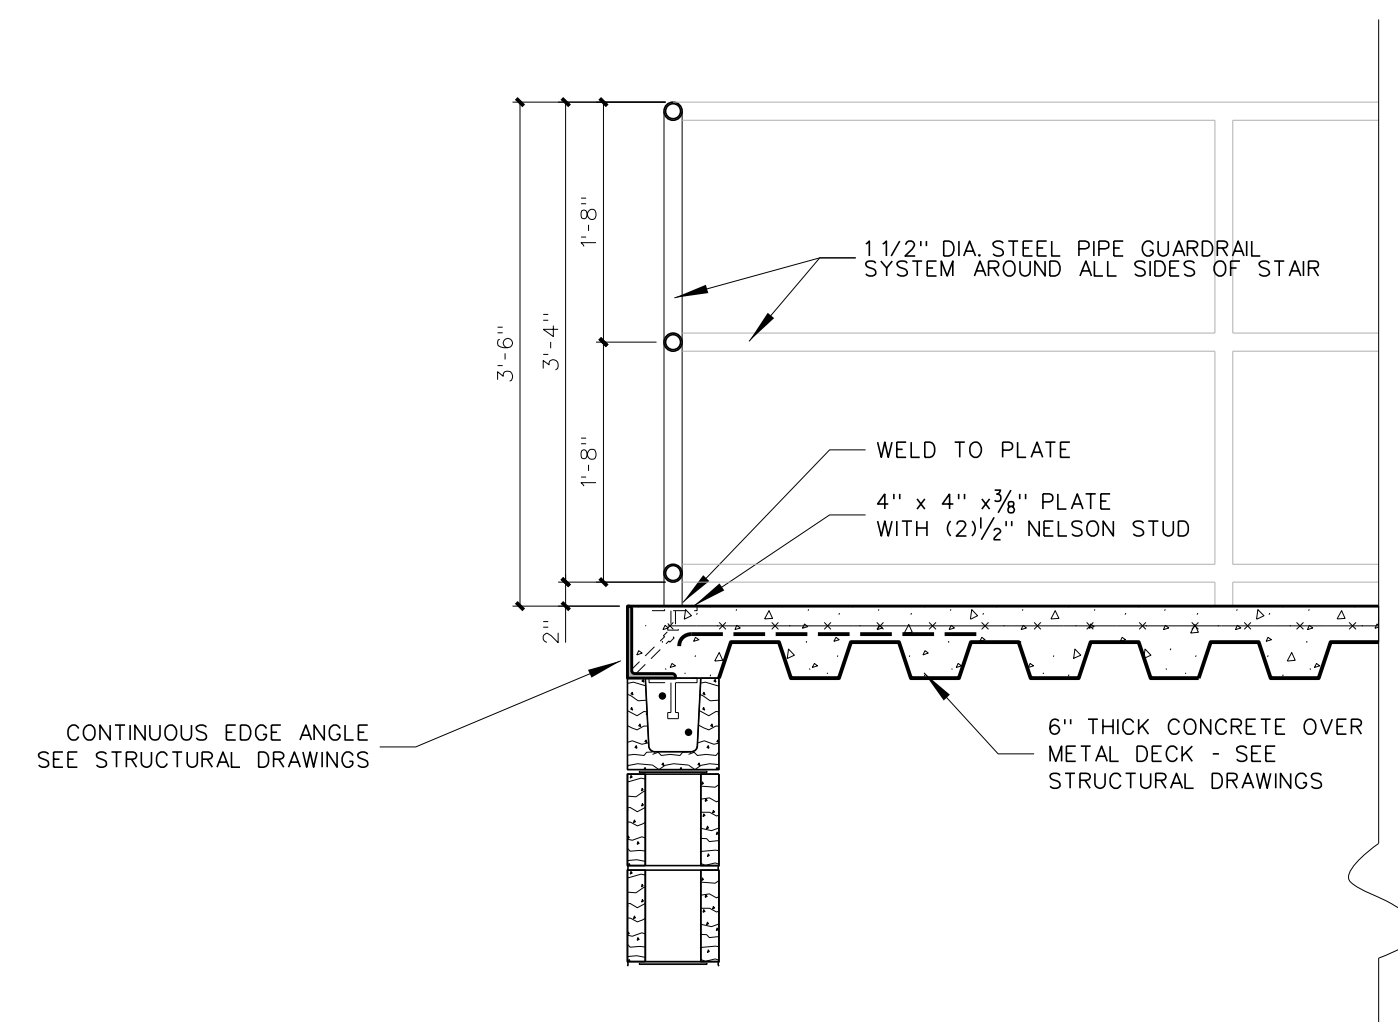

823.1 WALL SECTION AT PLATFORM ACCESS
SCALE: 3/4" = 1'-0"

No.	Date	Revision

Hite associates
ARCHITECTURE / PLANNING / TECHNOLOGY
2600 Meridian Drive / Greenville, NC 27834 / tel (252) 757-0333



Beaufort PK-3 School
BEAUFORT COUNTY SCHOOLS
Washington / North Carolina / 27889

Project No. 22344


Date: 1 July 2024

Drawing no.

A
823

General Notes for Wall Sections


- (1) SEE EXTERIOR ELEVATIONS FOR BRICK COLOR.
- (2) GENERAL CONTRACTOR SHALL VERIFY TOP OF FINISH GRADES, TOP OF CONCRETE WALKS AND TOP OF CONCRETE SLABS ADJACENT TO BUILDING AND ADJUST LOCATION OF THROUGH WALL FLASHING ACCORDINGLY.
- (3) PROVIDE PLASTIC INSERT WEEPS AT ALL AT DOOR, WINDOW AND FLOOR FLASHING.
- (4) GENERAL CONTRACTOR SHALL SLOPE CONCRETE FLOOR TO FLOOR DRAINS AS SHOWN ON PLUMBING DRAWINGS.
- (5) ALL CMU CELLS BELOW FINISH FLOOR SHALL BE FILLED WITH CONCRETE.
- (6) ALL VAPOR BARRIERS UNDER FLOOR SLABS SHALL BE LAPPED 12" MINIMUM AND TAPED CONTIGUOUS AT JOINTS. GENERAL CONTRACTOR SHALL REPAIR ANY DAMAGED VAPOR BARRIER PRIOR TO PLACING CONCRETE.
- (7) PROVIDE 4" MINIMUM SPRAY POLYURETHANE INSULATION IN ALL METAL STUDS EXTERIOR WALLS. SEE WALL SECTIONS AND SPECIFICATIONS.
- (8) PROVIDE SPRAY POLYURETHANE INSULATION IN ALL NESTED METAL STUD WINDOW AND DOOR JAMBS, SILLS AND HEADS.
- (9) ALL INTERIOR METAL STUD/GYPSUM WALLBOARD PARTITIONS REQUIRE SOUND ATTENUATION BATTS.
- (10) PROVIDE METAL CHAIRS UNDER ALL STEEL WIRE MATS REINFORCING STEEL FOR CONCRETE SLABS AND FOUNDATIONS.
- (11) PROVIDE GYPSUM CONTROL JOINTS AT ALL GYPBOARD / METAL STUD WINDOW JAMBS. SEE INTERIOR ELEVATIONS.
- (12) ALL SEALANT COLORS TO BE SELECTED BY ARCHITECT.
- (13) ROOF INSULATION TAKE ALL ROOF INSULATION JOINTS, BOTH LAYER, LAP AND TAP VAPOR BARRIER ARCHITECT TO FIELD VERIFY PRIOR TO METAL ROOF PANEL INSTALLATION.
- (14) PROVIDE PRE-FORMED THRU-WALL FLASHING CORNER MEMBERS FOR EXTERIOR WALL CORNERS AS SPECIFIED.

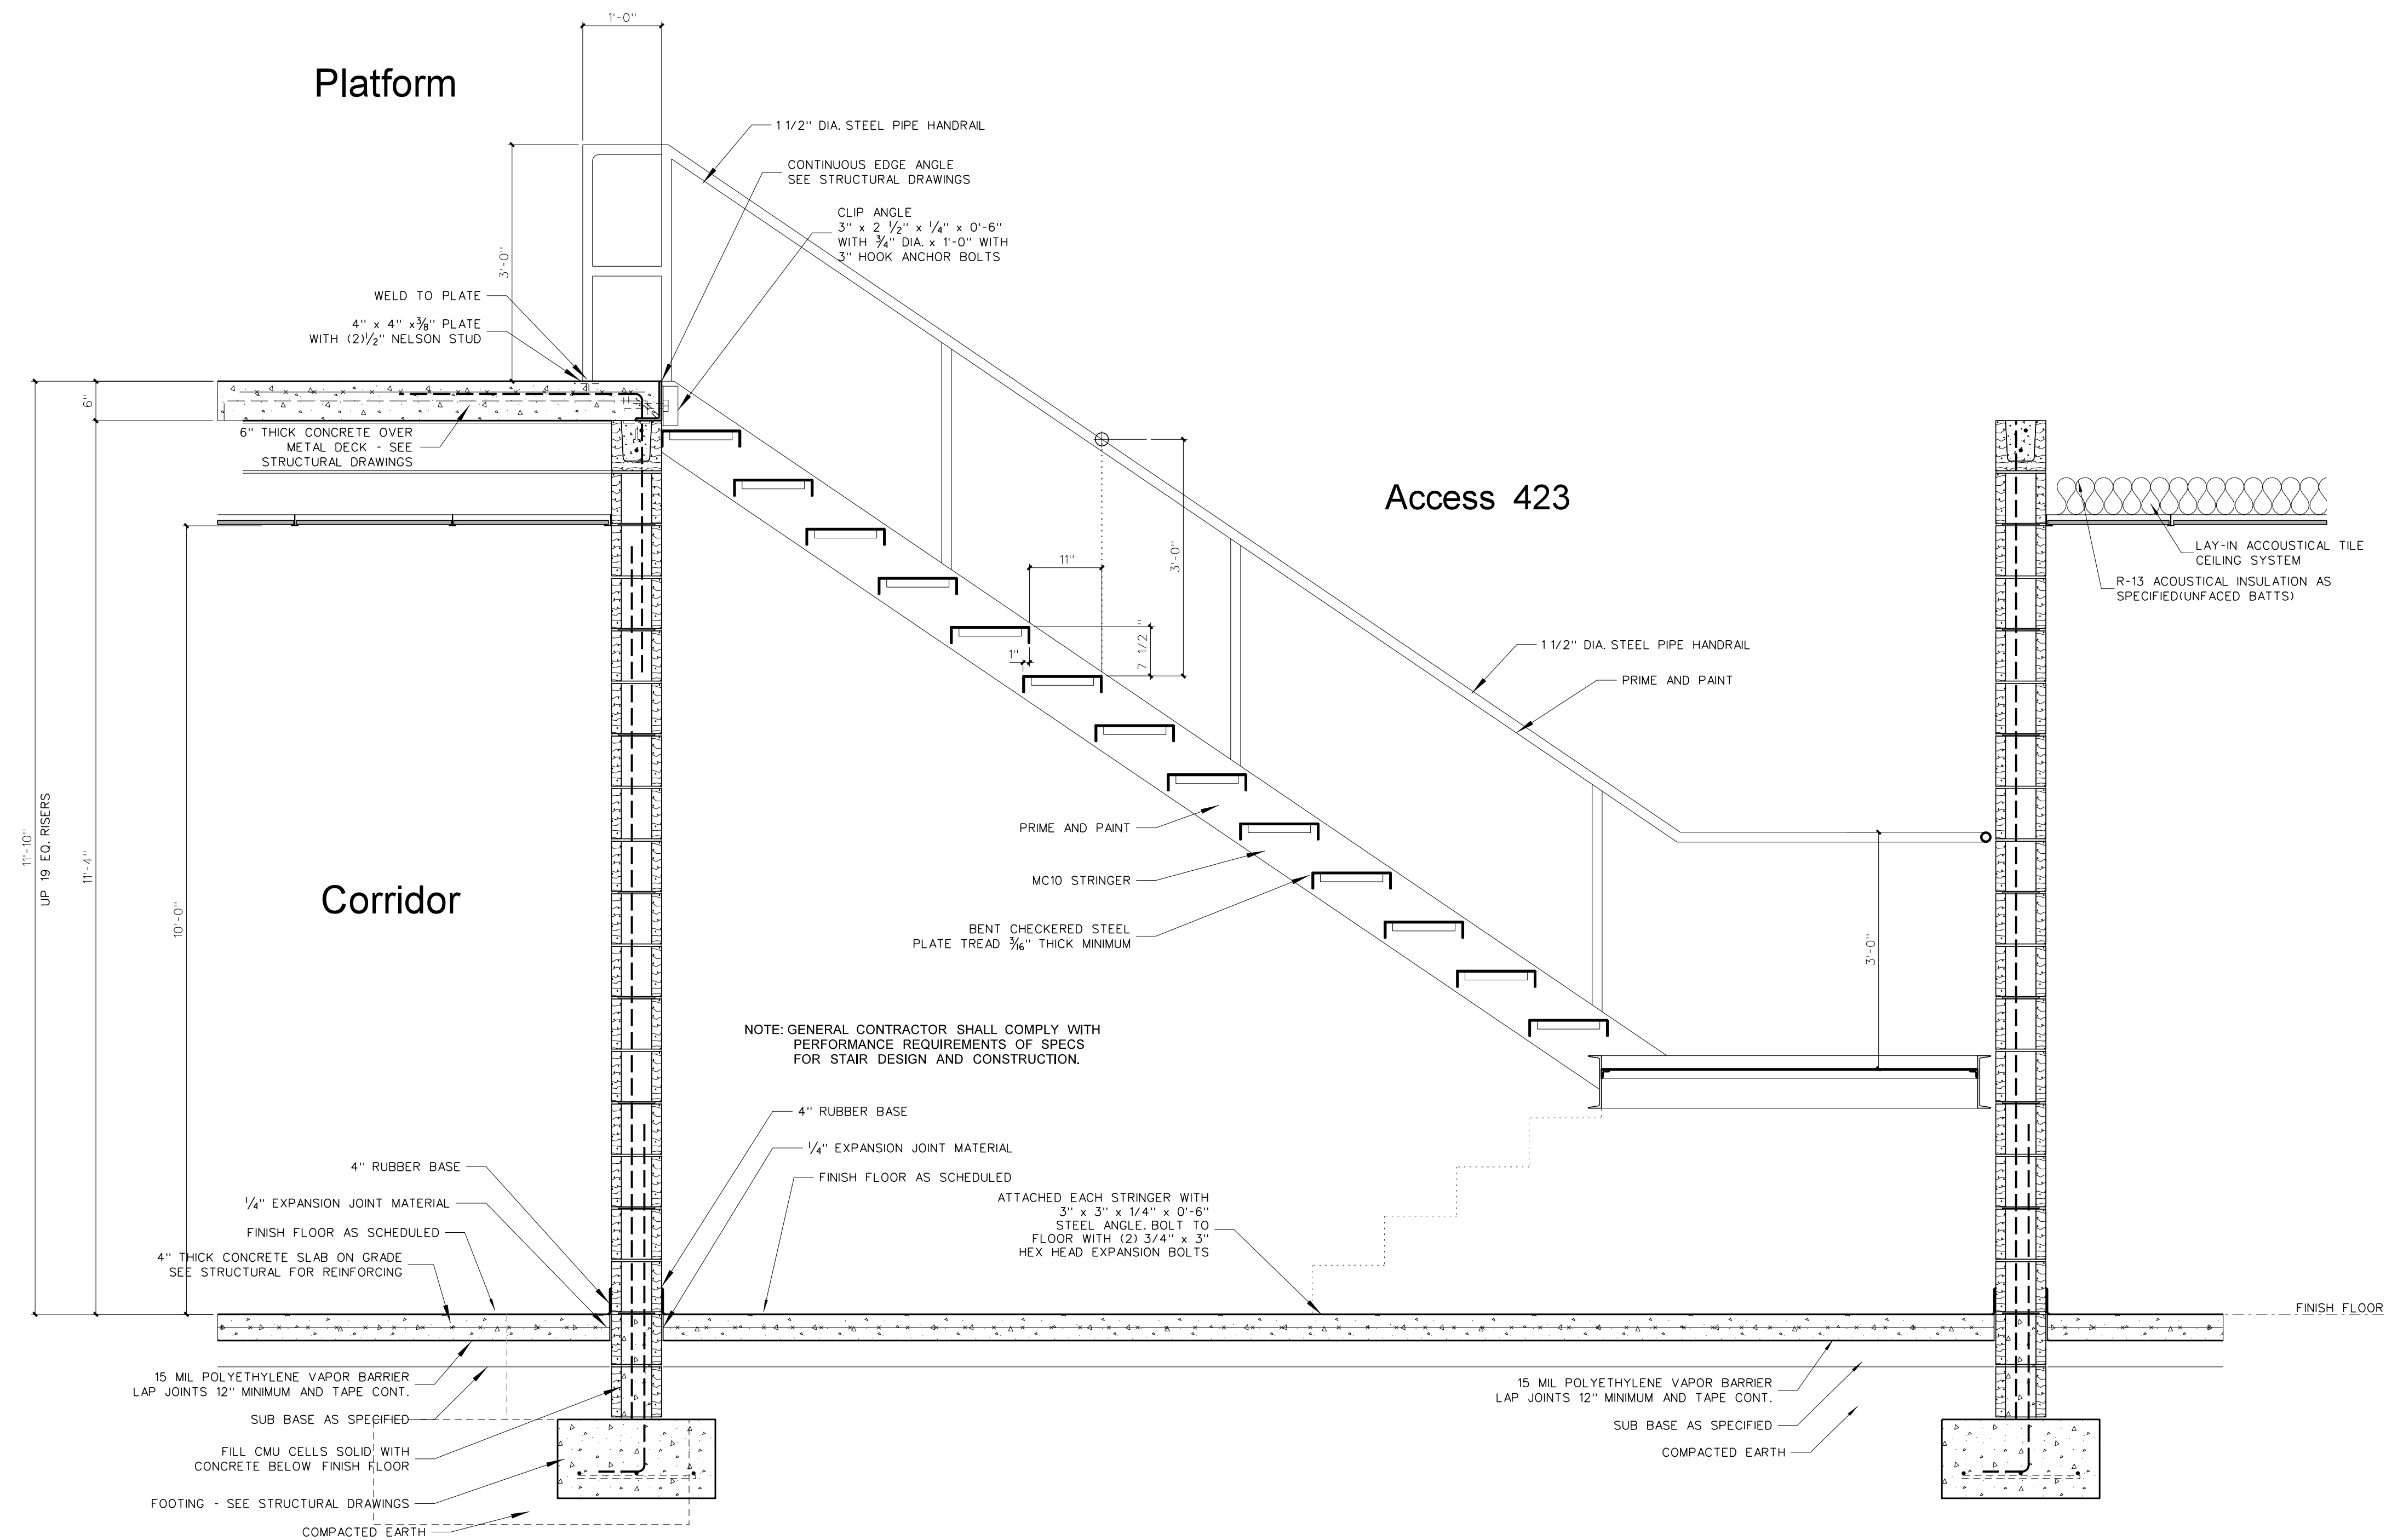

824.1 WALL SECTION AT PLATFORM ACCESS
SCALE: 3/4" = 1'-0"

No.	Date	Revision


Hite associates
ARCHITECTURE / PLANNING / TECHNOLOGY
2600 Meridian Drive / Greenville, NC 27834 / tel (252) 757-0333

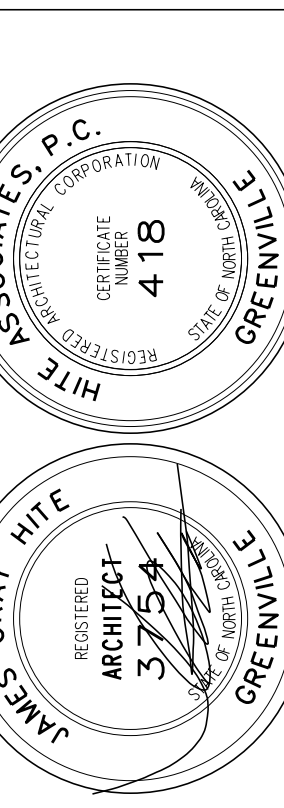

Beaufort PK-3 School
BEAUFORT COUNTY SCHOOLS
Washington / North Carolina / 27889

Project No. 22344
Date: 1 July 2024
Drawing no. **A 824**

- General Notes for Wall Sections**
- (1) SEE EXTERIOR ELEVATIONS FOR BRICK COLOR.
 - (2) GENERAL CONTRACTOR SHALL VERIFY TOP OF FINISH GRADES, TOP OF CONCRETE WALKS AND TOP OF CONCRETE SLABS ADJACENT TO BUILDING AND ADJUST LOCATION OF THROUGH WALL FLASHING ACCORDINGLY.
 - (3) PROVIDE PLASTIC INSERT WEEPS AT ALL AT DOOR, WINDOW AND FLOOR FLASHING.
 - (4) GENERAL CONTRACTOR SHALL SLOPE CONCRETE FLOOR TO FLOOR DRAINS AS SHOWN ON PLUMBING DRAWINGS.
 - (5) ALL CMU CELLS BELOW FINISH FLOOR SHALL BE FILLED WITH CONCRETE.
 - (6) ALL VAPOR BARRIERS UNDER FLOOR SLABS SHALL BE LAPPED 12" MINIMUM AND TAPED CONTIGUOUS AT JOINTS. GENERAL CONTRACTOR SHALL REPAIR ANY DAMAGED VAPOR BARRIER PRIOR TO PLACING CONCRETE.
 - (7) PROVIDE 4" MINIMUM SPRAY POLYURETHANE INSULATION IN ALL METAL STUDS EXTERIOR WALLS. SEE WALL SECTIONS AND SPECIFICATIONS.
 - (8) PROVIDE SPRAY POLYURETHANE INSULATION IN ALL NESTED METAL STUD WINDOW AND DOOR JAMBS, SILLS AND HEADS.
 - (9) ALL INTERIOR METAL STUD/GYPSUM WALLBOARD PARTITIONS REQUIRE SOUND ATTENUATION BATTS.
 - (10) PROVIDE METAL CHAIRS UNDER ALL STEEL WIRE MATS REINFORCING STEEL FOR CONCRETE SLABS AND FOUNDATIONS.
 - (11) PROVIDE GYPSUM CONTROL JOINTS AT ALL GYPSUM / METAL STUD WINDOW JAMBS. SEE INTERIOR ELEVATIONS.
 - (12) ALL SEALANT COLORS TO BE SELECTED BY ARCHITECT.
 - (13) ROOF INSULATION TAPE ALL ROOF INSULATION JOINTS, BOTH LAYER, LAP AND TAPE VAPOR BARRIER ARCHITECT TO FIELD VERIFY PRIOR TO METAL ROOF PANEL INSTALLATION.
 - (14) PROVIDE PRE-FORMED THRU-WALL FLASHING CORNER MEMBERS FOR EXTERIOR WALL CORNERS AS SPECIFIED.

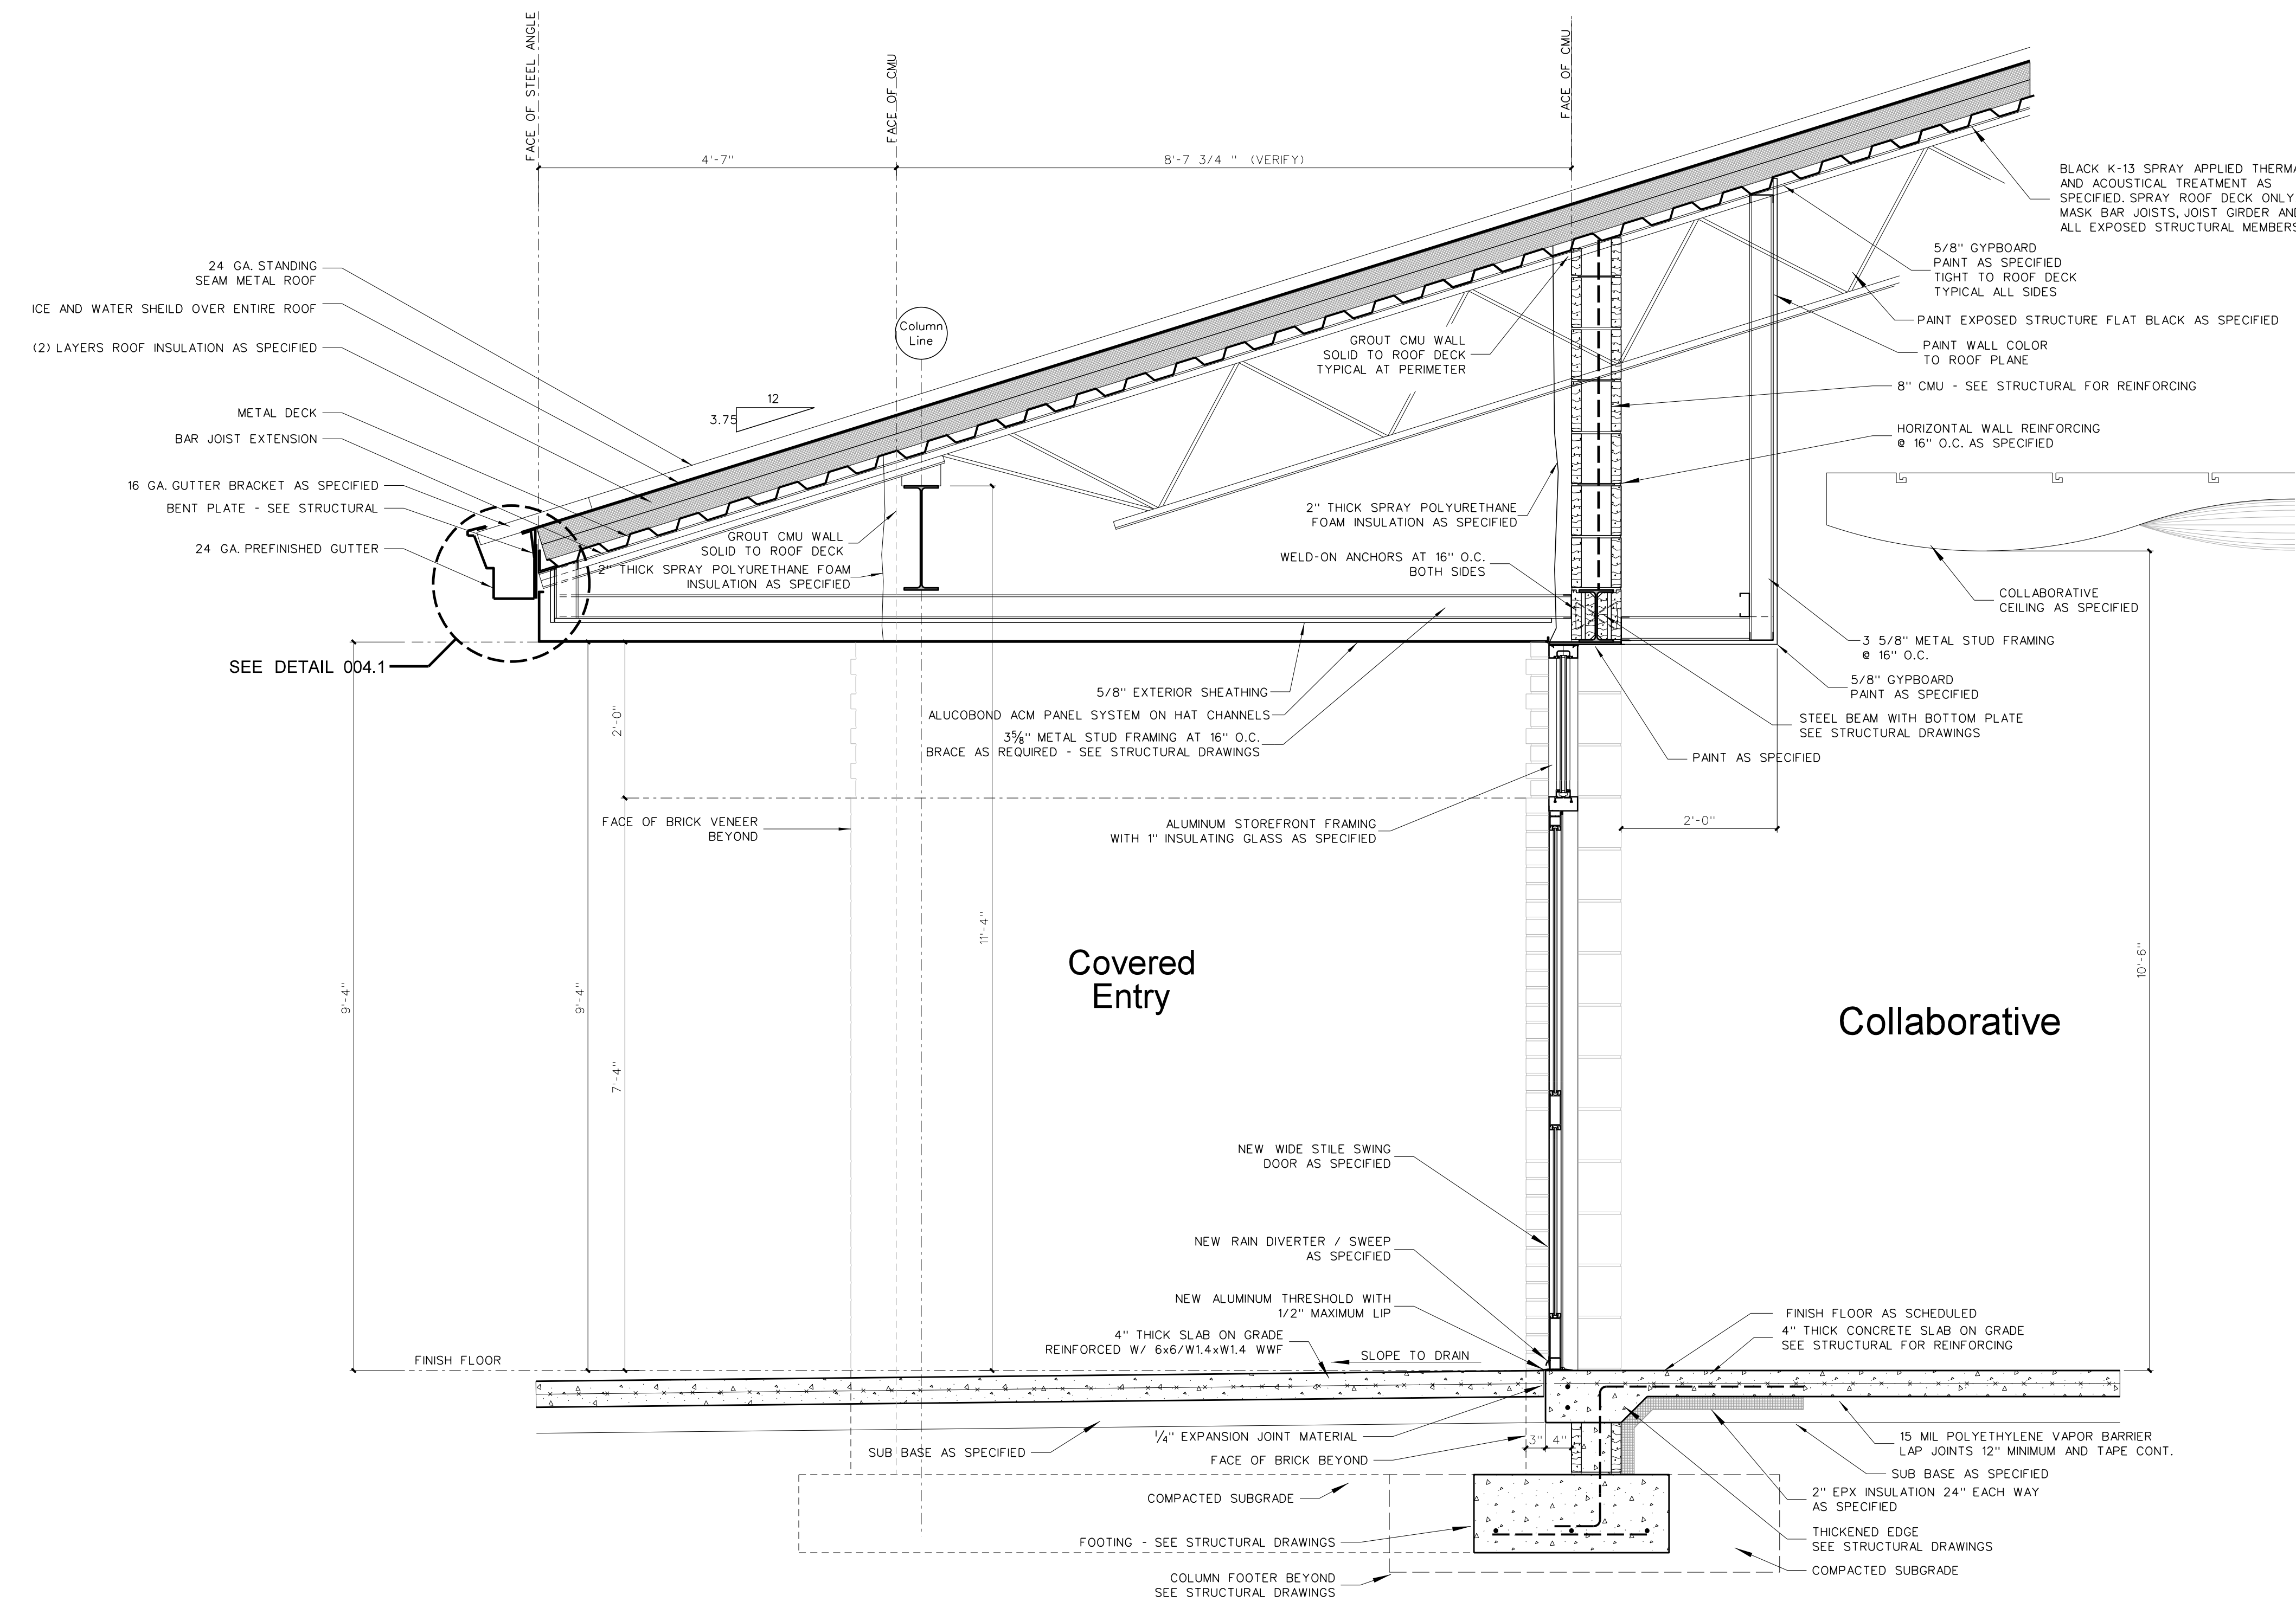

825.1 WALL SECTION AT ENTRY
SCALE: 3/4" = 1'-0"

No.	Date	Revision


Hite associates
ARCHITECTURE / PLANNING / TECHNOLOGY
2600 Meridian Drive / Greenville, NC 27834 / tel (252) 757-0333



Beaufort PK-3 School
BEAUFORT COUNTY SCHOOLS
Washington / North Carolina / 27889

Project No.	22344
Date:	1 July 2024
Drawing no.	A 825

- ### General Notes for Wall Sections
- (1) SEE EXTERIOR ELEVATIONS FOR BRICK COLOR.
 - (2) GENERAL CONTRACTOR SHALL VERIFY TOP OF FINISH GRADES, TOP OF OF CONCRETE WALKS AND TOP OF CONCRETE SLABS ADJACENT TO BUILDING AND ADJUST LOCATION OF THROUGH WALL FLASHING ACCORDINGLY.
 - (3) PROVIDE PLASTIC INSERT WEEPS AT ALL AT DOOR, WINDOW AND FLOOR FLASHING.
 - (4) GENERAL CONTRACTOR SHALL SLOPE CONCRETE FLOOR TO FLOOR DRAINS AS SHOWN ON PLUMBING DRAWINGS.
 - (5) ALL CMU CELLS BELOW FINISH FLOOR SHALL BE FILLED WITH CONCRETE.
 - (6) ALL VAPOR BARRIERS UNDER FLOOR SLABS SHALL BE LAPPED 12" MINIMUM AND TAPED CONTINUOUS AT JOINTS. GENERAL CONTRACTOR SHALL REPAIR ANY DAMAGED VAPOR BARRIER PRIOR TO PLACING CONCRETE.
 - (7) PROVIDE 4" MINIMUM SPRAY POLYURETHANE INSULATION IN ALL METAL STUDS EXTERIOR WALLS. SEE WALL SECTIONS AND SPECIFICATIONS.
 - (8) PROVIDE SPRAY POLYURETHANE INSULATION IN ALL NESTED METAL STUD WINDOW AND DOOR JAMBS, SILLS AND HEADS.
 - (9) ALL INTERIOR METAL STUD/GYPSUM WALLBOARD PARTITIONS REQUIRE SOUND ATTENUATION BATTS.
 - (10) PROVIDE METAL CHAIRS UNDER ALL STEEL WIRE MATS REINFORCING STEEL FOR CONCRETE SLABS AND FOUNDATIONS.
 - (11) PROVIDE GYPSUM CONTROL JOINTS AT ALL GYPSUM / METAL STUD WINDOW JAMBS. SEE INTERIOR ELEVATIONS.
 - (12) ALL SEALANT COLORS TO BE SELECTED BY ARCHITECT.
 - (13) ROOF INSULATION TAPE ALL ROOF INSULATION JOINTS, BOTH LAYER, LAP AND TAPE VAPOR BARRIER. ARCHITECT TO FIELD VERIFY PRIOR TO METAL ROOF PANEL INSTALLATION.
 - (14) PROVIDE PRE-FORMED THRU-WALL FLASHING CORNER MEMBERS FOR EXTERIOR WALL CORNERS AS SPECIFIED.

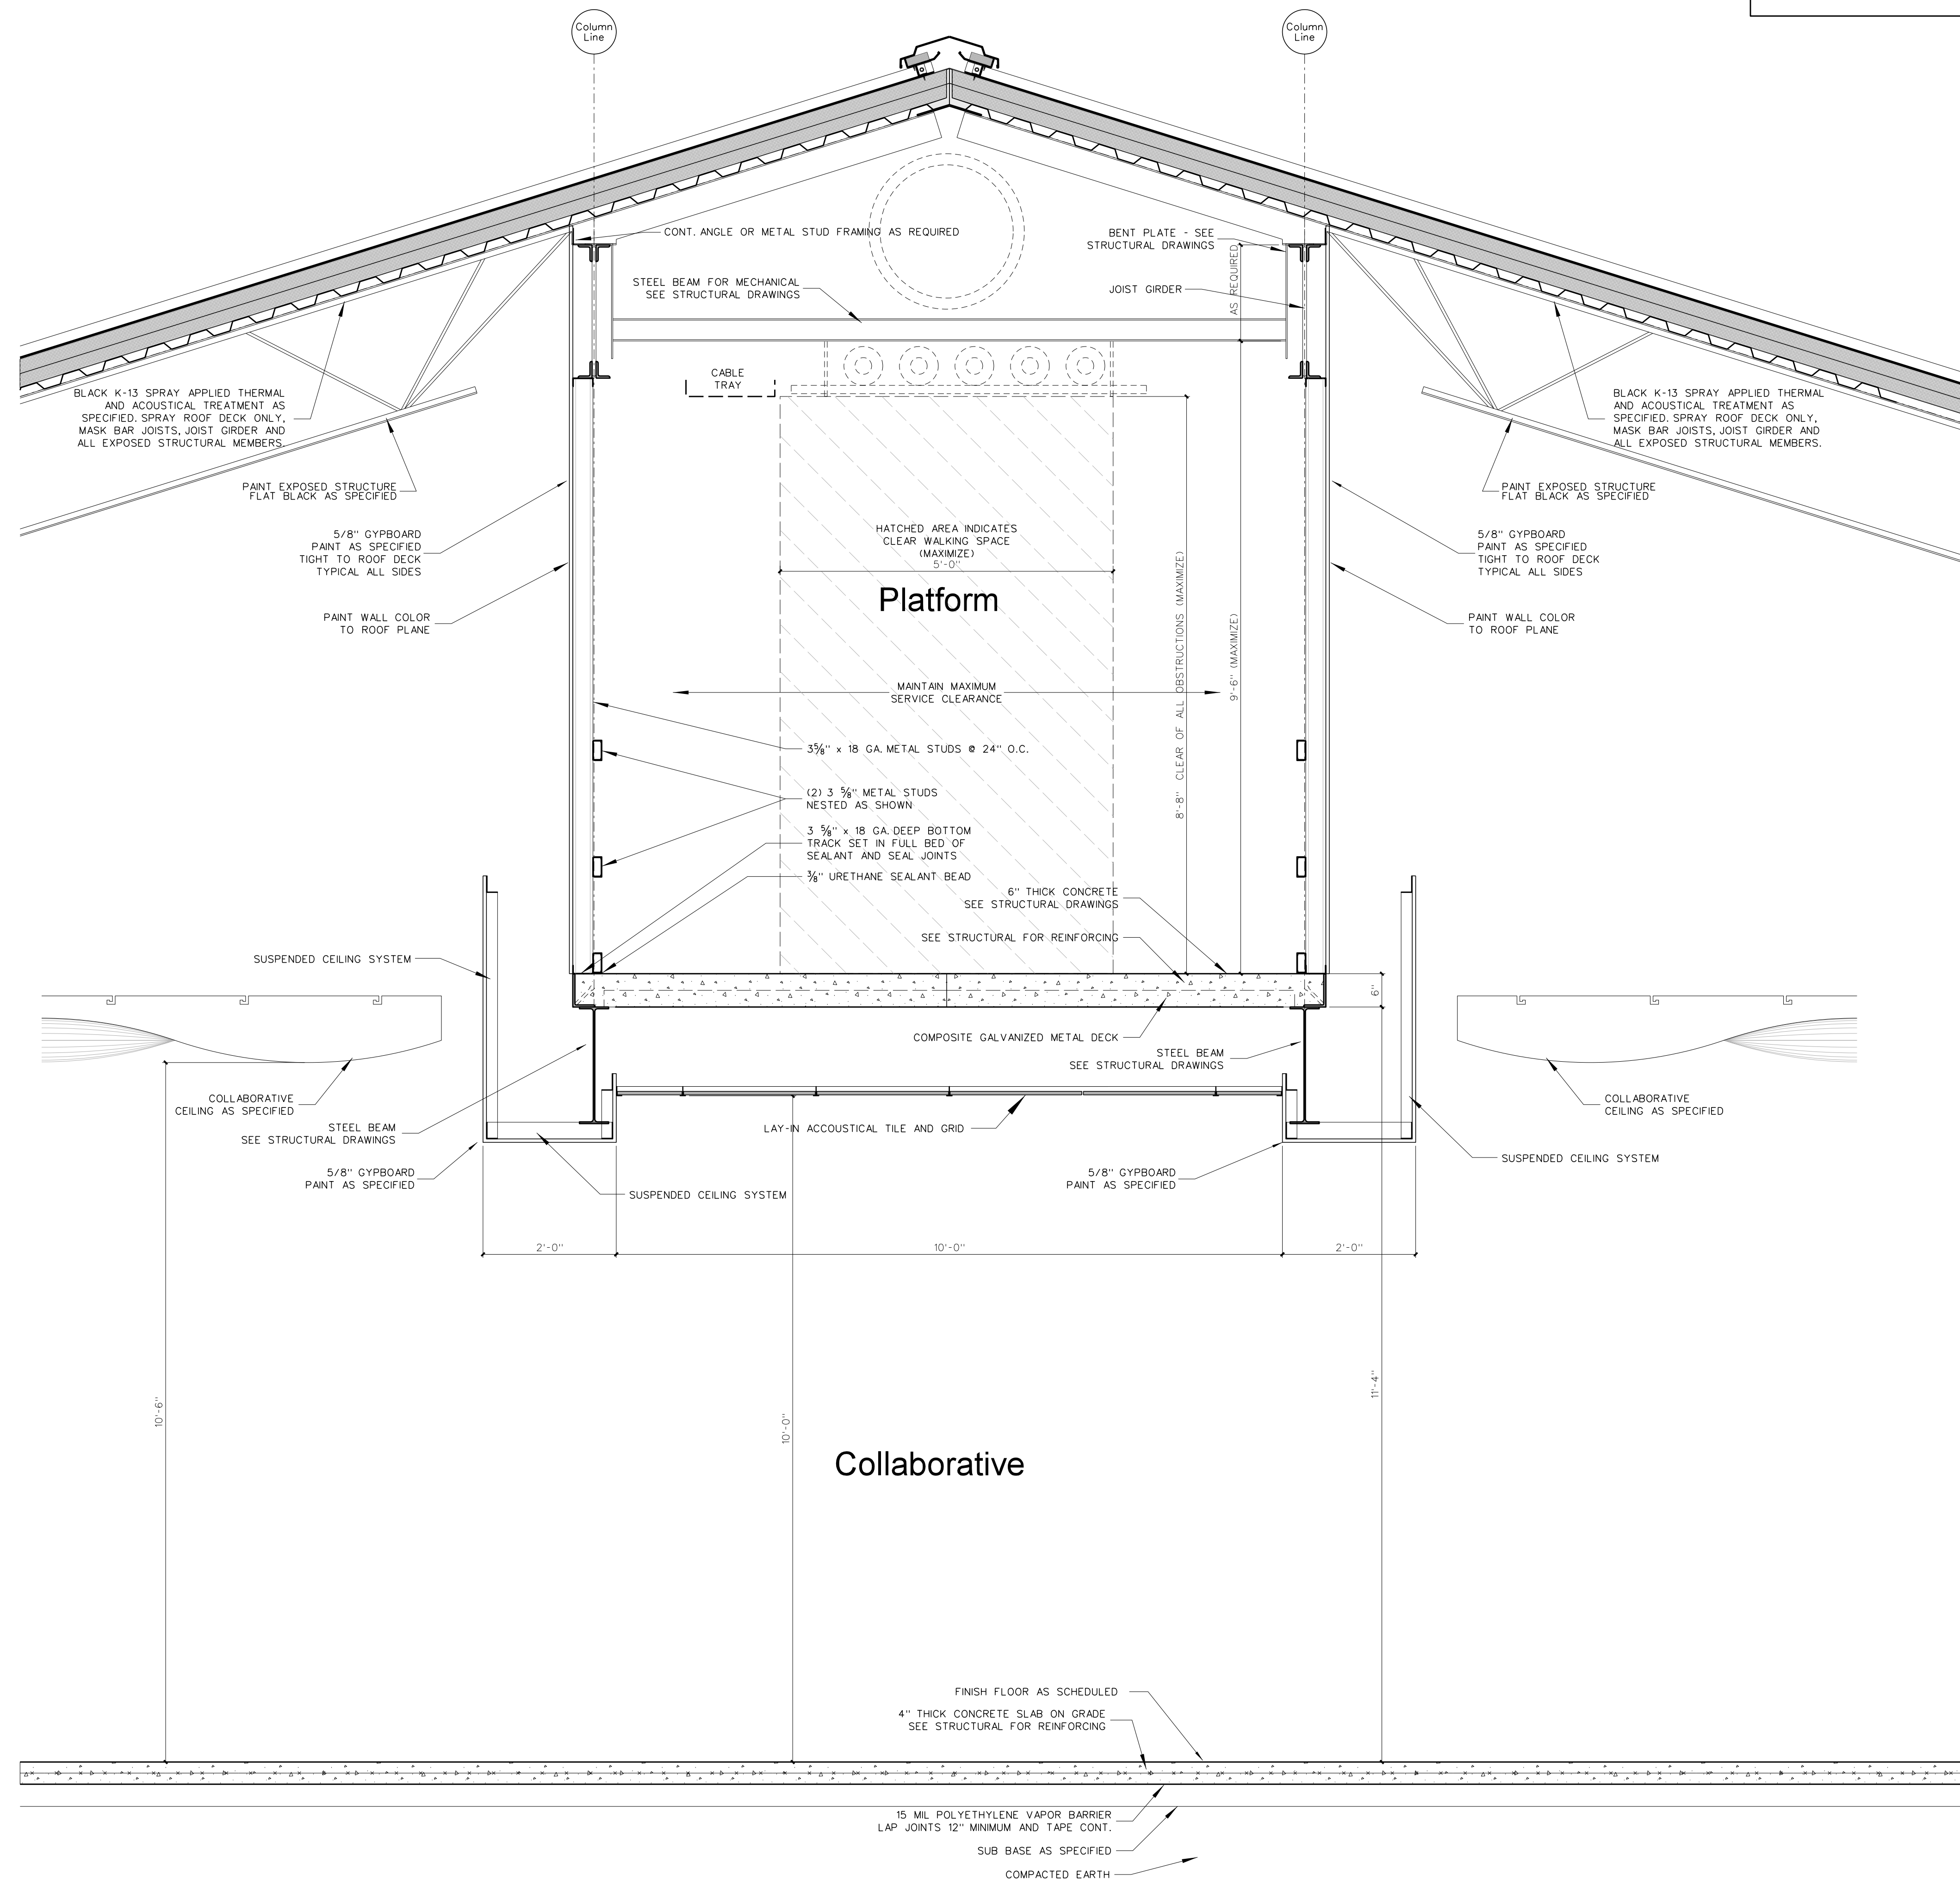

826.1 WALL SECTION AT COLLABORATIVE SPACE
SCALE: 3/4" = 1'-0"

No.	Date	Revision

Hite associates
ARCHITECTURE / PLANNING / TECHNOLOGY
2600 Meridian Drive / Greenville, NC 27834 / tel (252) 757-0333




Beaufort PK-3 School
BEAUFORT COUNTY SCHOOLS
Washington / North Carolina / 27889

Project No.	22344
Date:	1 July 2024
Drawing no.	A 826


No.	Date	Revision

Hite associates
 ARCHITECTURE / PLANNING / TECHNOLOGY
 2600 Meridian Drive / Greenville, NC 27834 / tel (252) 757-0333

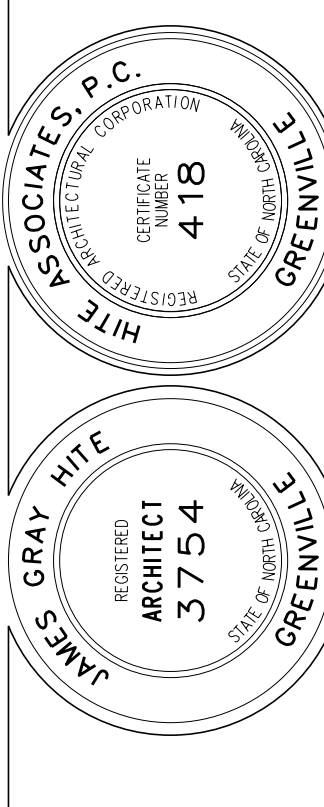


Beaufort PK-3 School
 BEAUFORT COUNTY SCHOOLS
 Washington / North Carolina / 27889


Project No. 22344
 Date: 1 July 2024
 Drawing no. **A 901**

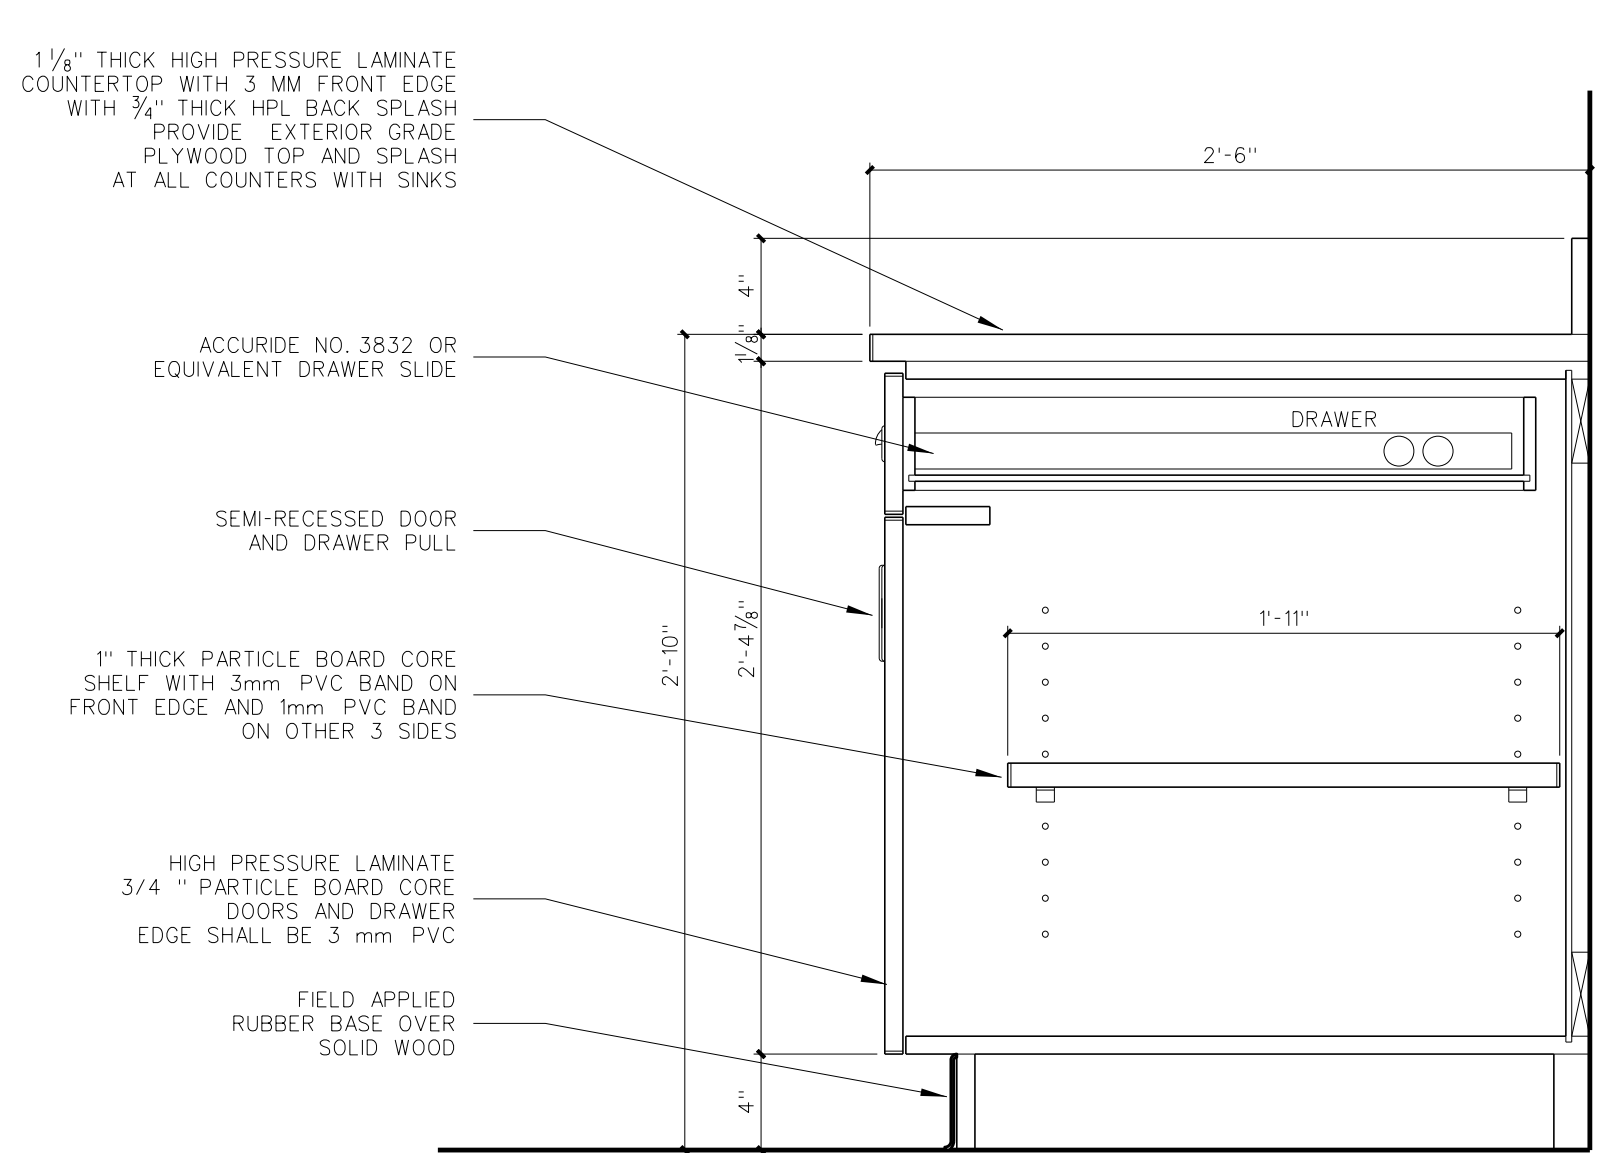


901.6 34" BASE CABINET
 SCALE: 1 1/2" = 1'-0"

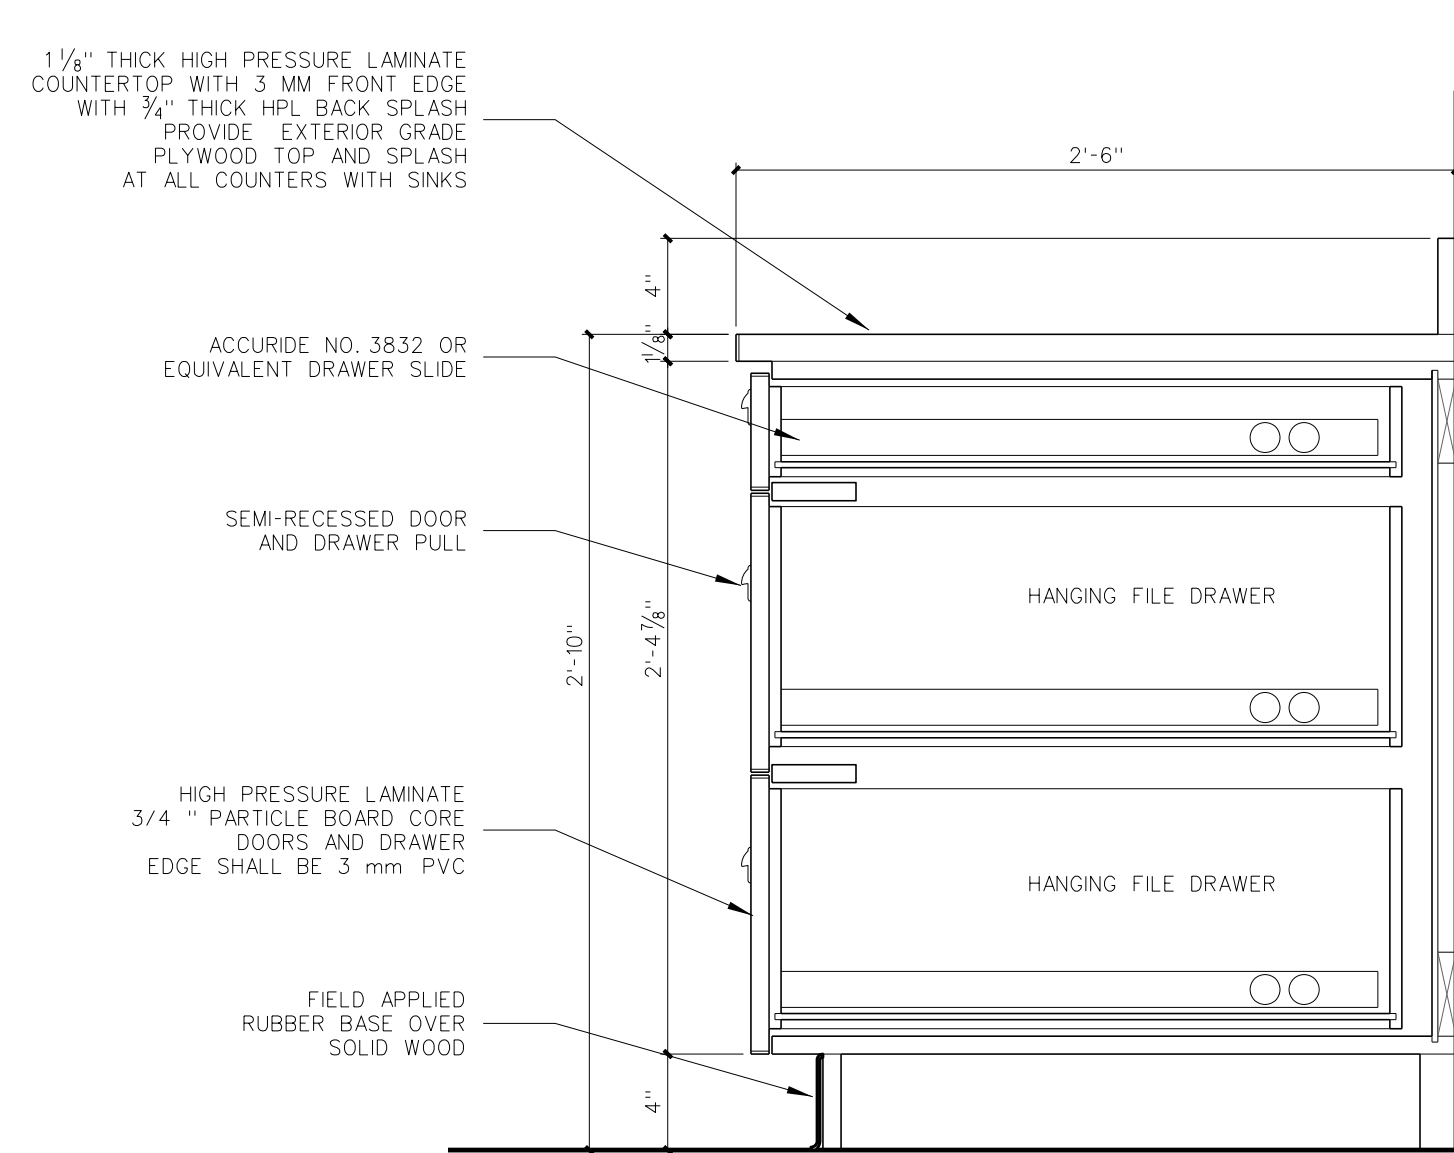


901.5 34" BASE CABINET
 24" DEEP
 SCALE: 1 1/2" = 1'-0"

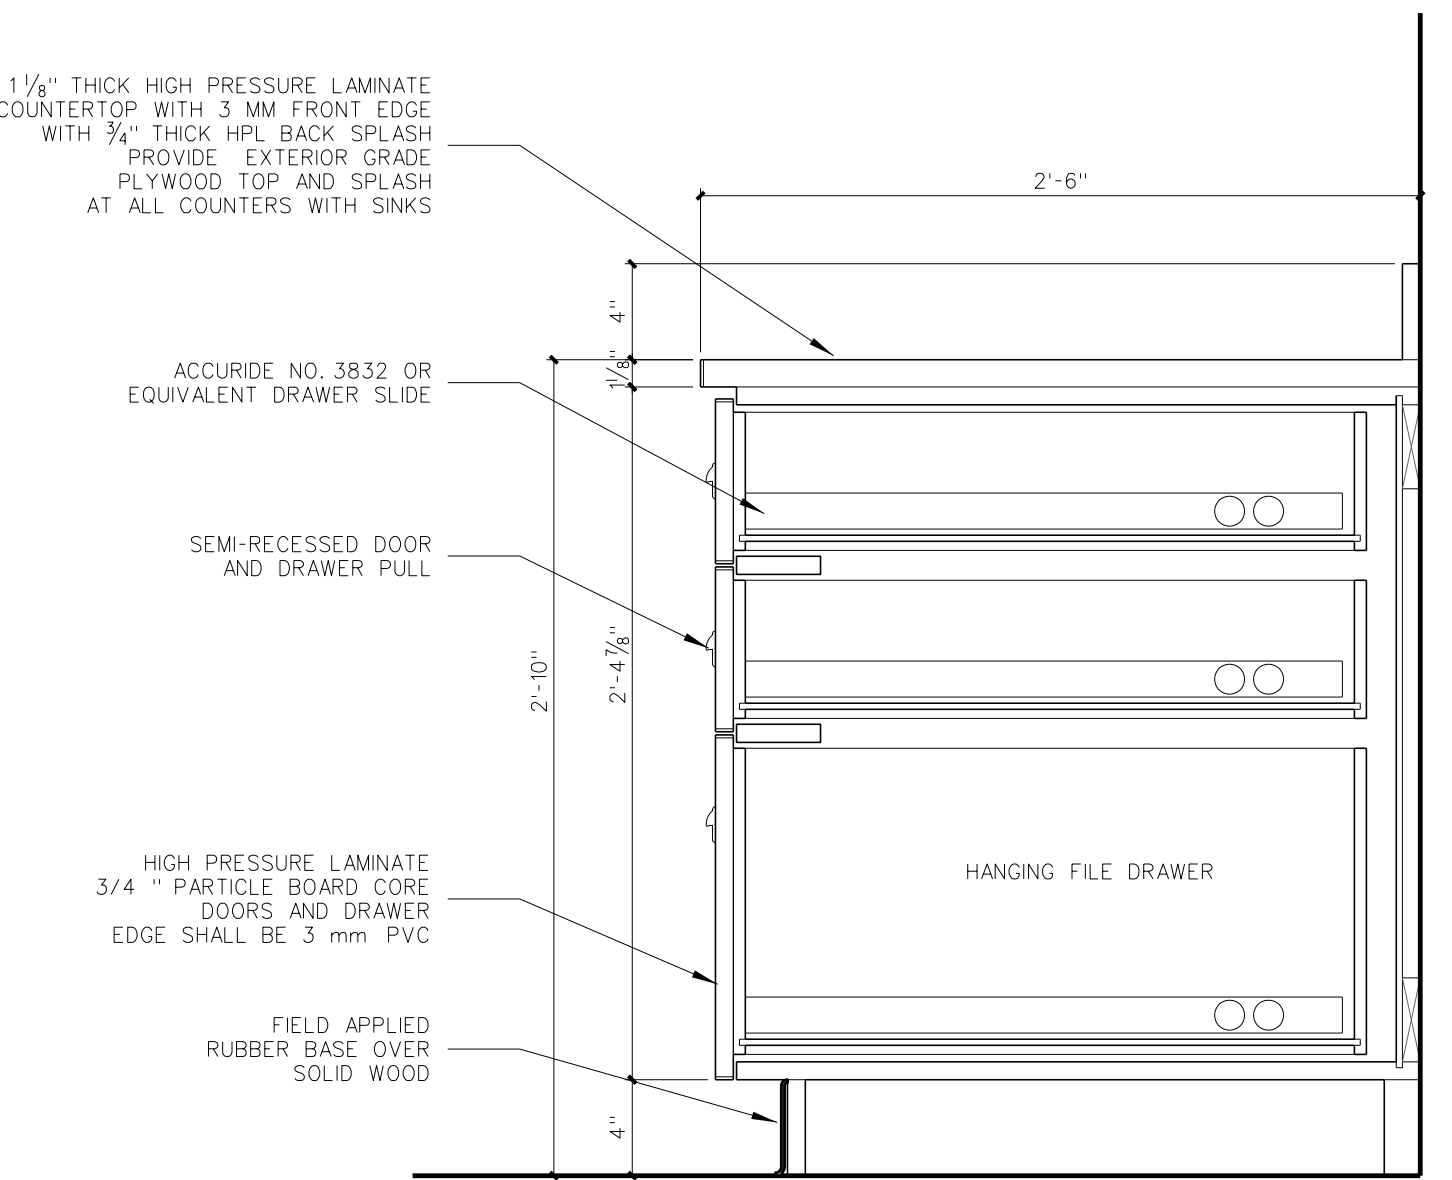


901.4 34" BASE CABINET @
TEACHER PLANNING
 30" DEEP
 SCALE: 1 1/2" = 1'-0"

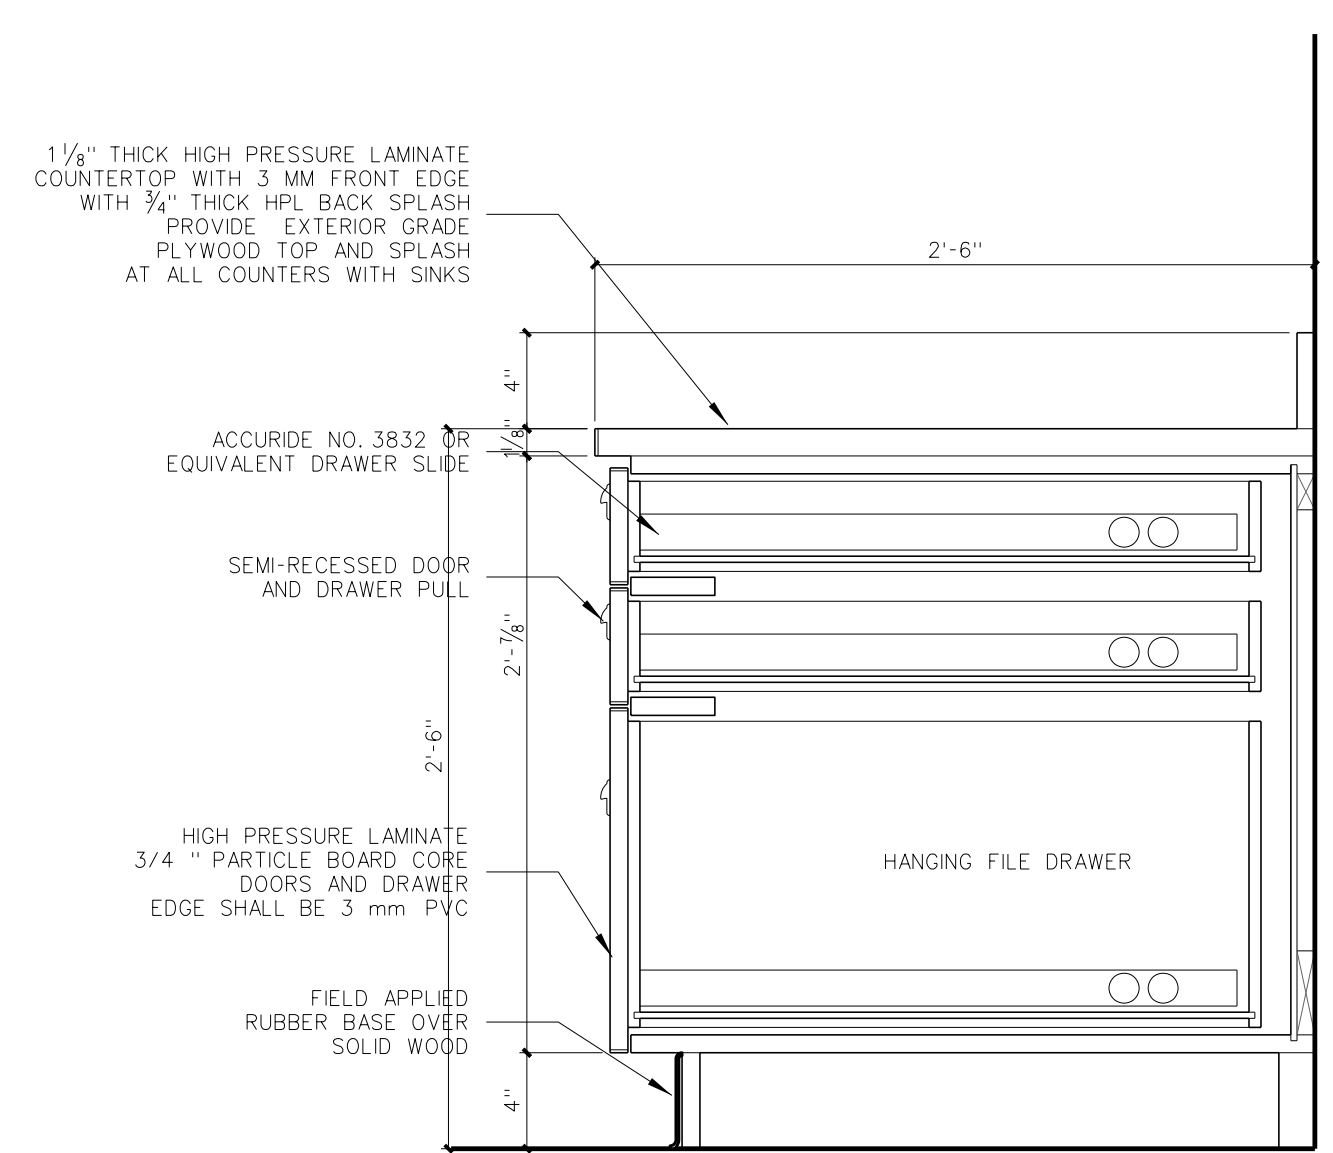


901.3 30" BASE CABINET
 24" DEEP
 SCALE: 1 1/2" = 1'-0"

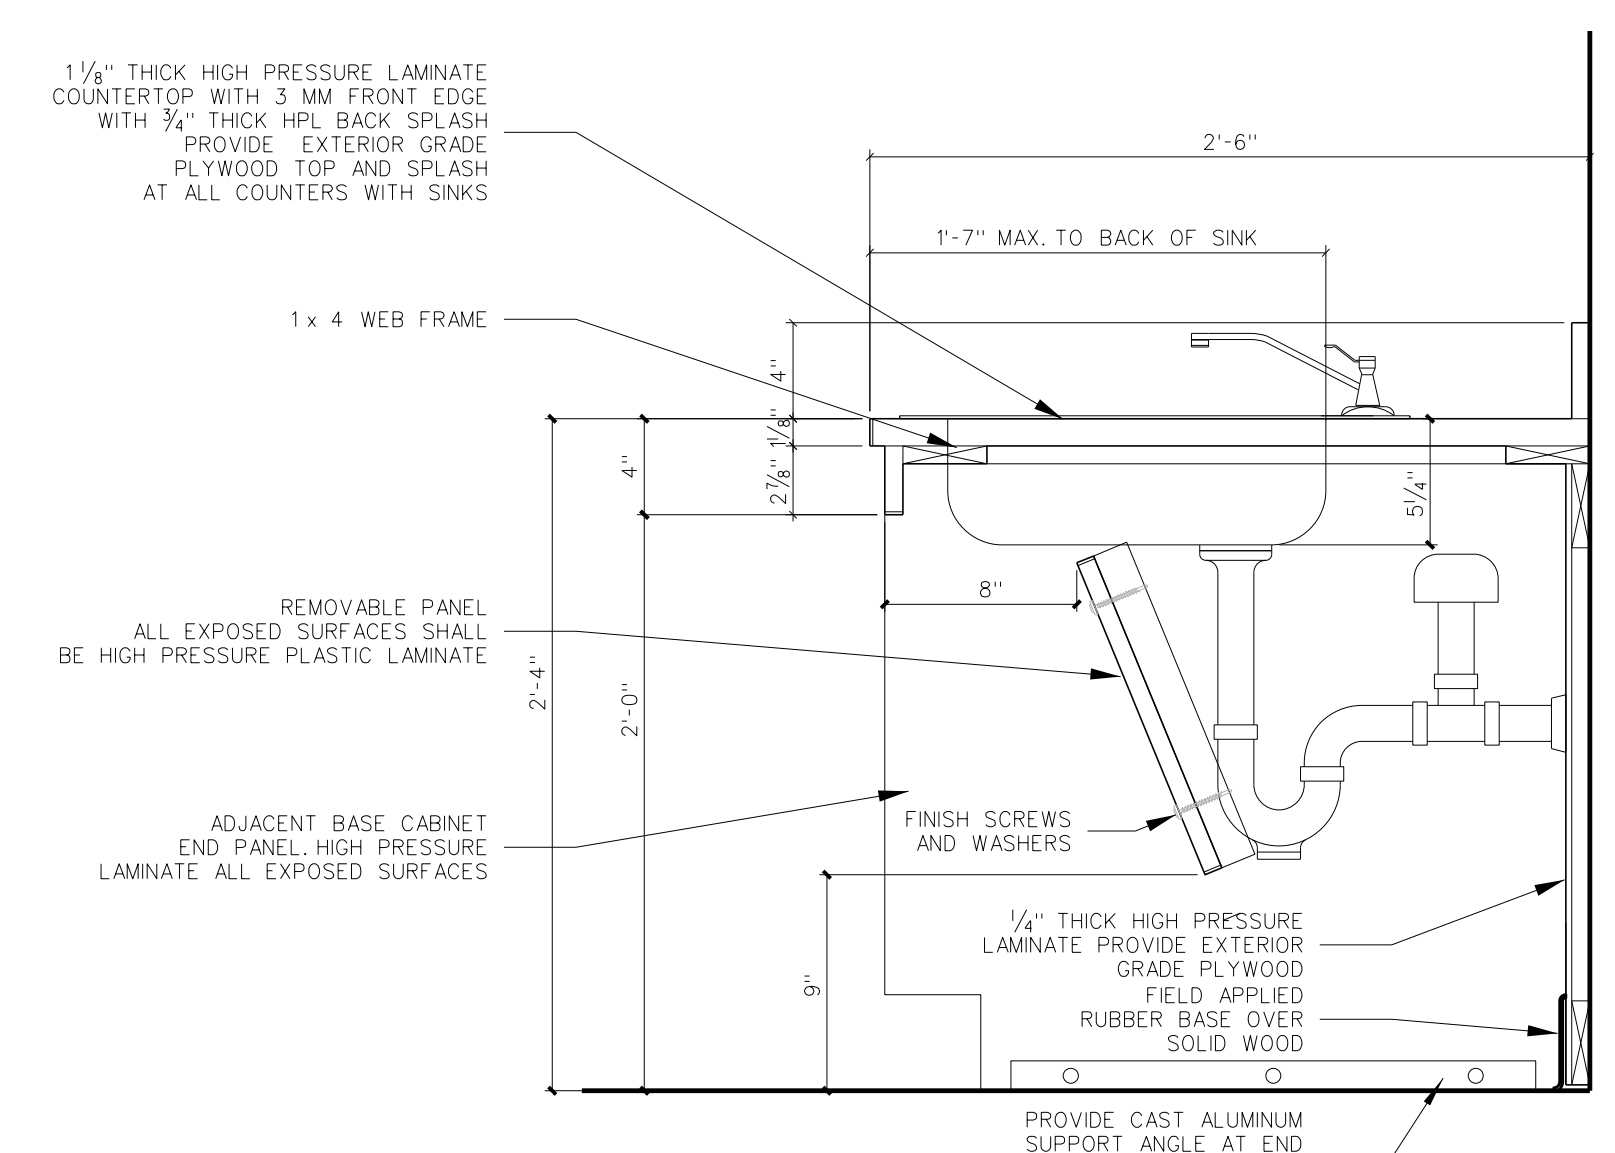


901.2 28" H/C BASE CABINET
 SCALE: 1 1/2" = 1'-0"

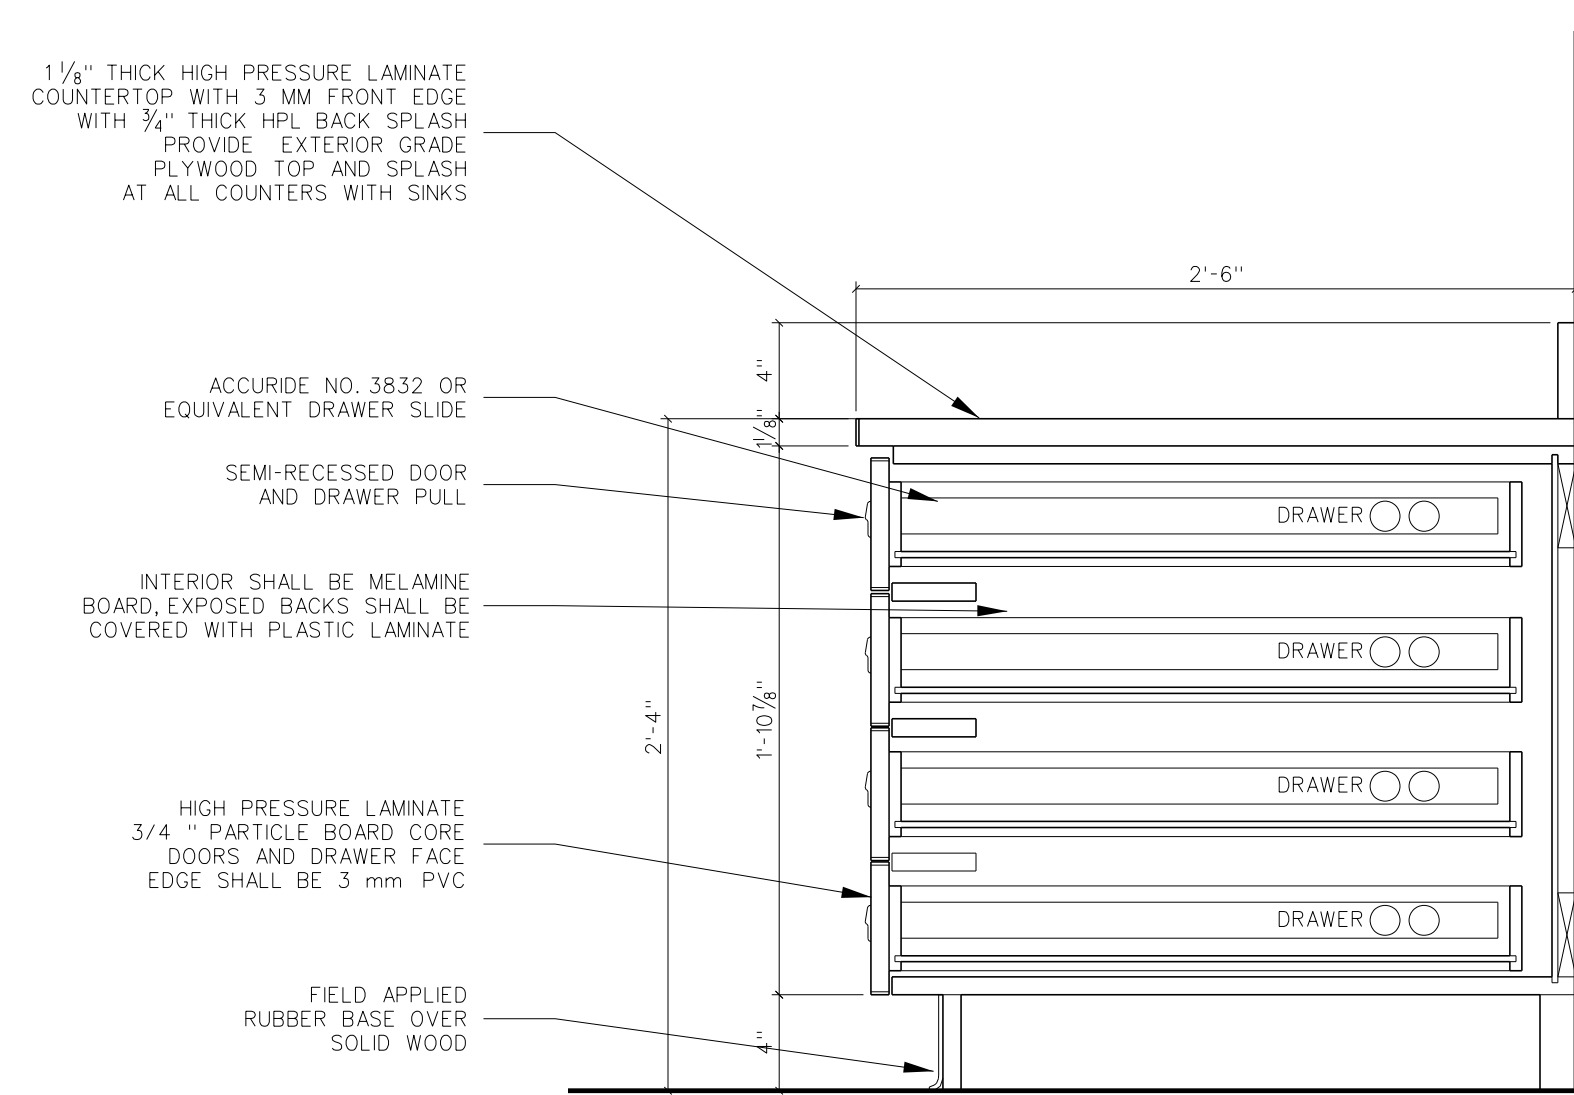


901.1 28" BASE CABINET
 NOTE: 30" DEEP
 SCALE: 1 1/2" = 1'-0"

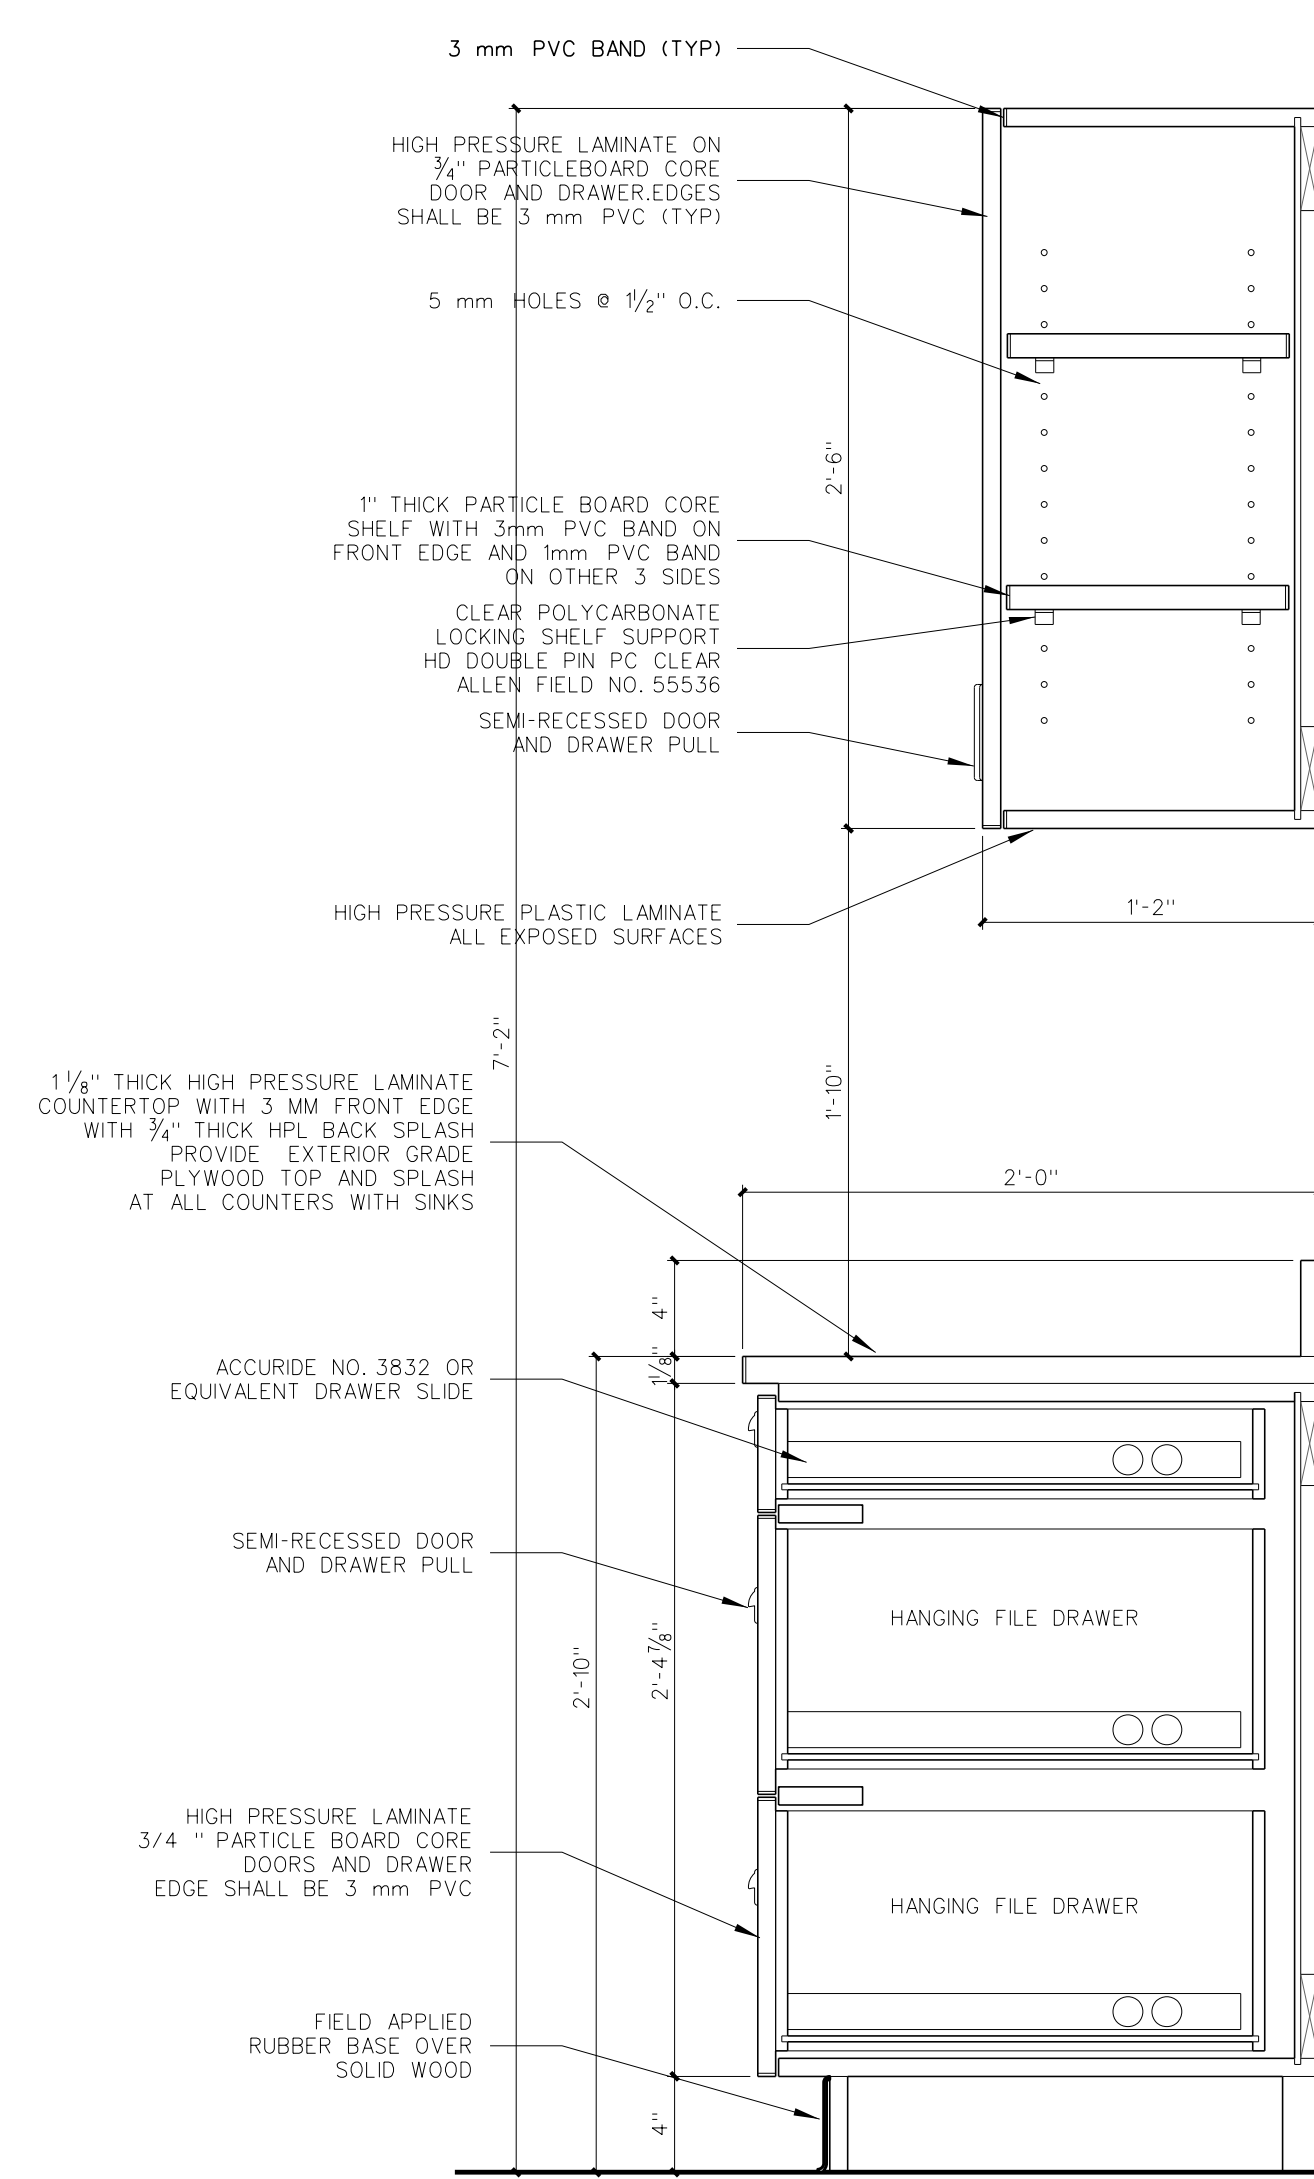


902.8 34" BASE CABINET
24" DEEP
SCALE: 1 1/2" = 1'-0"

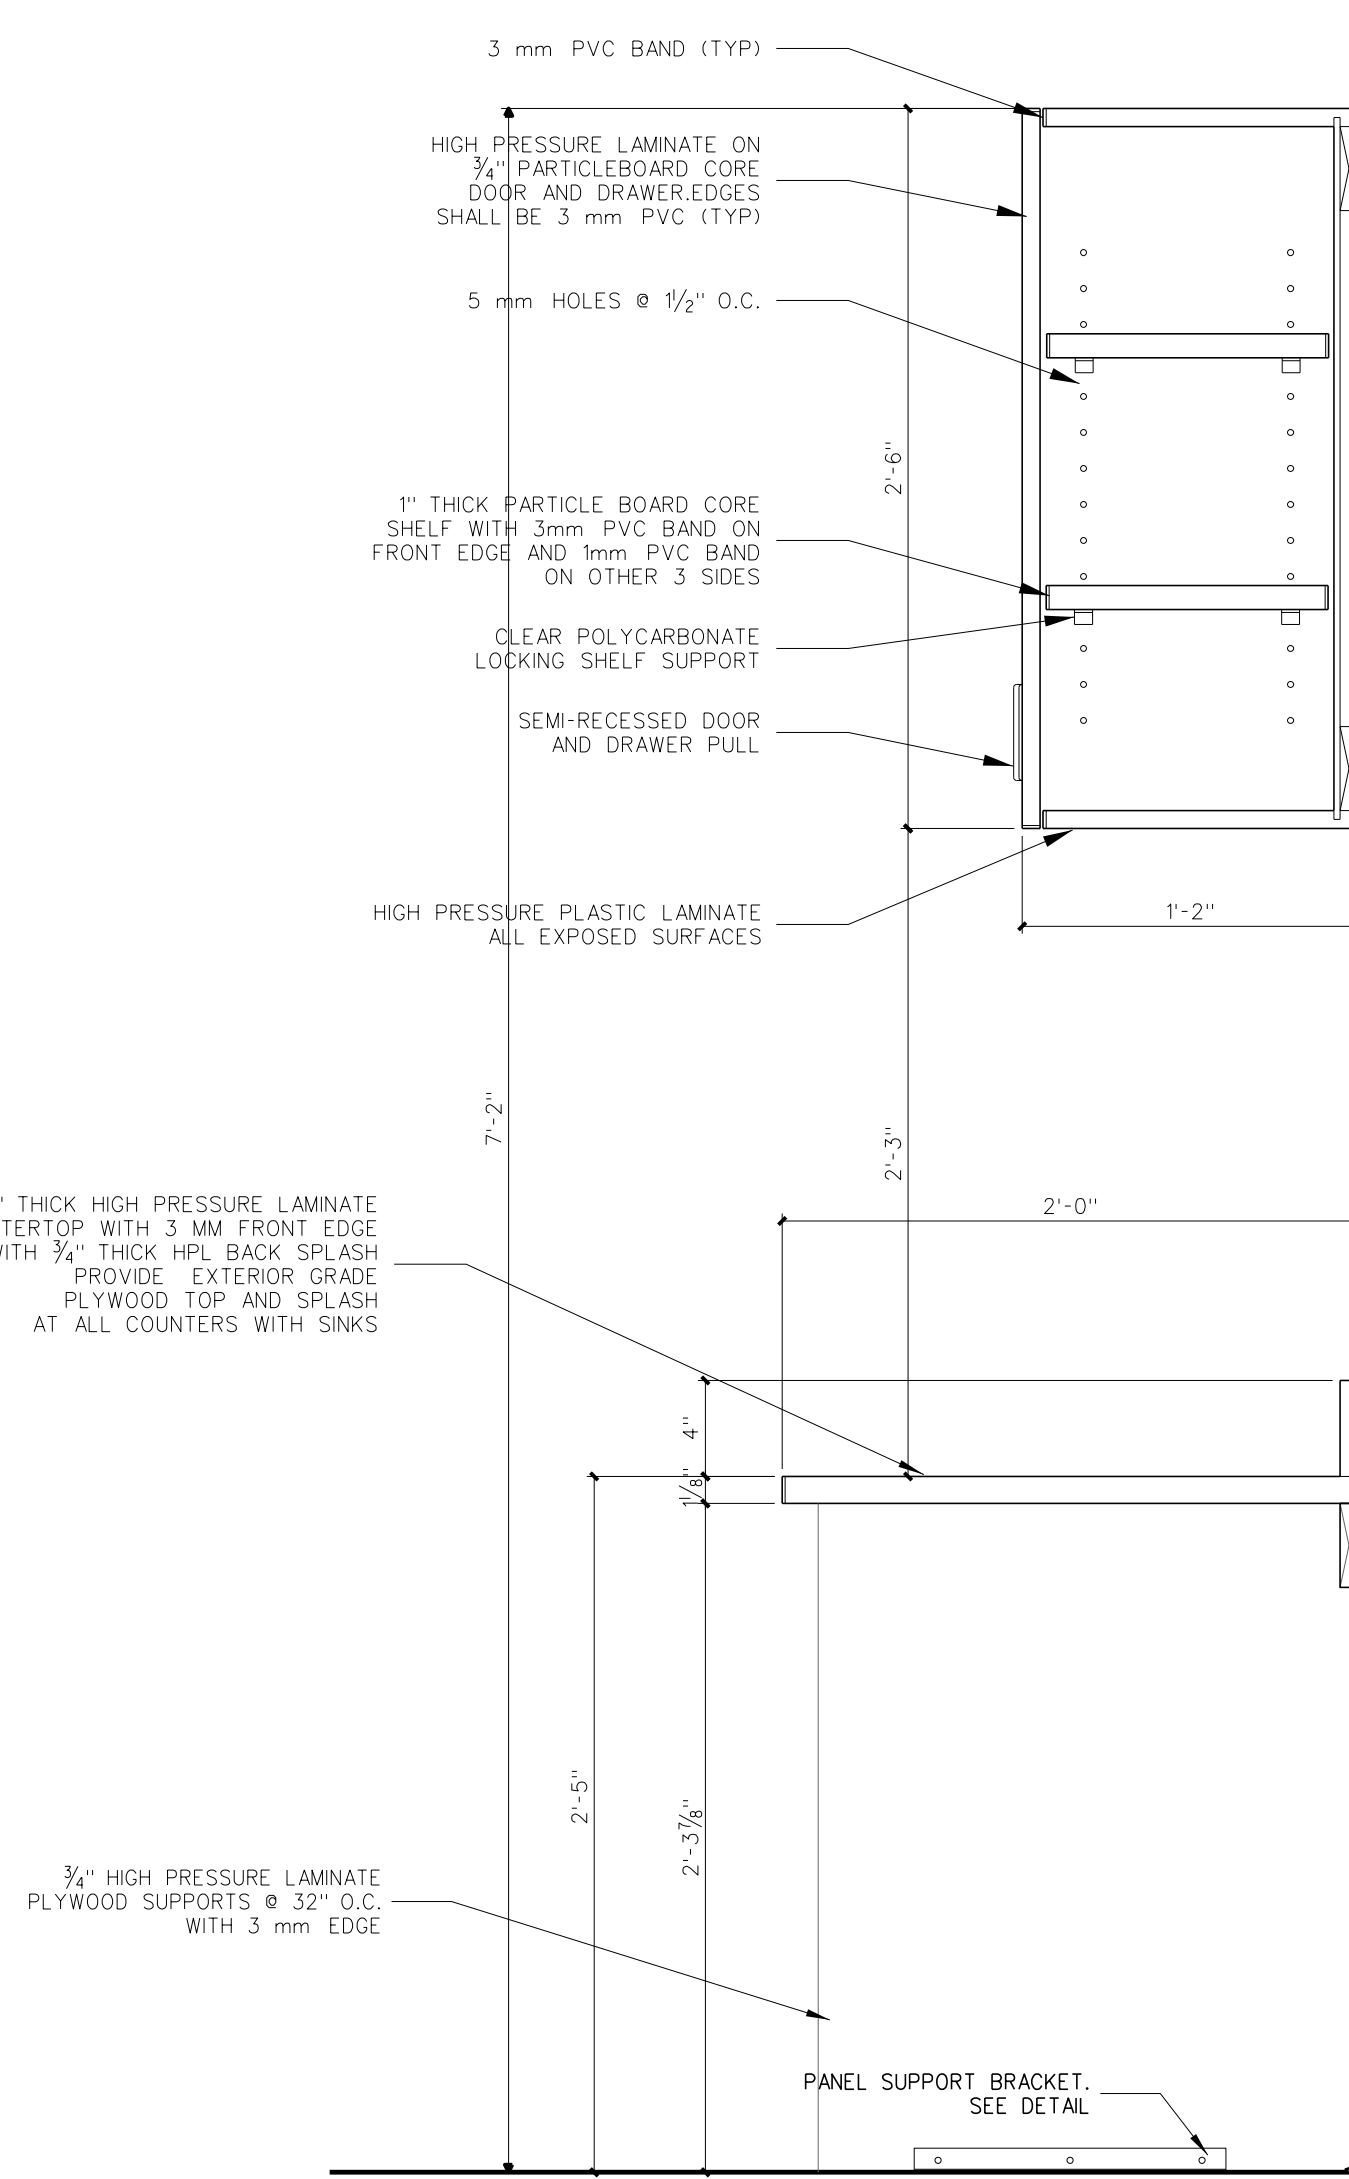


902.7 NURSE'S STATION KNEE SPACE
SCALE: 1 1/2" = 1'-0"

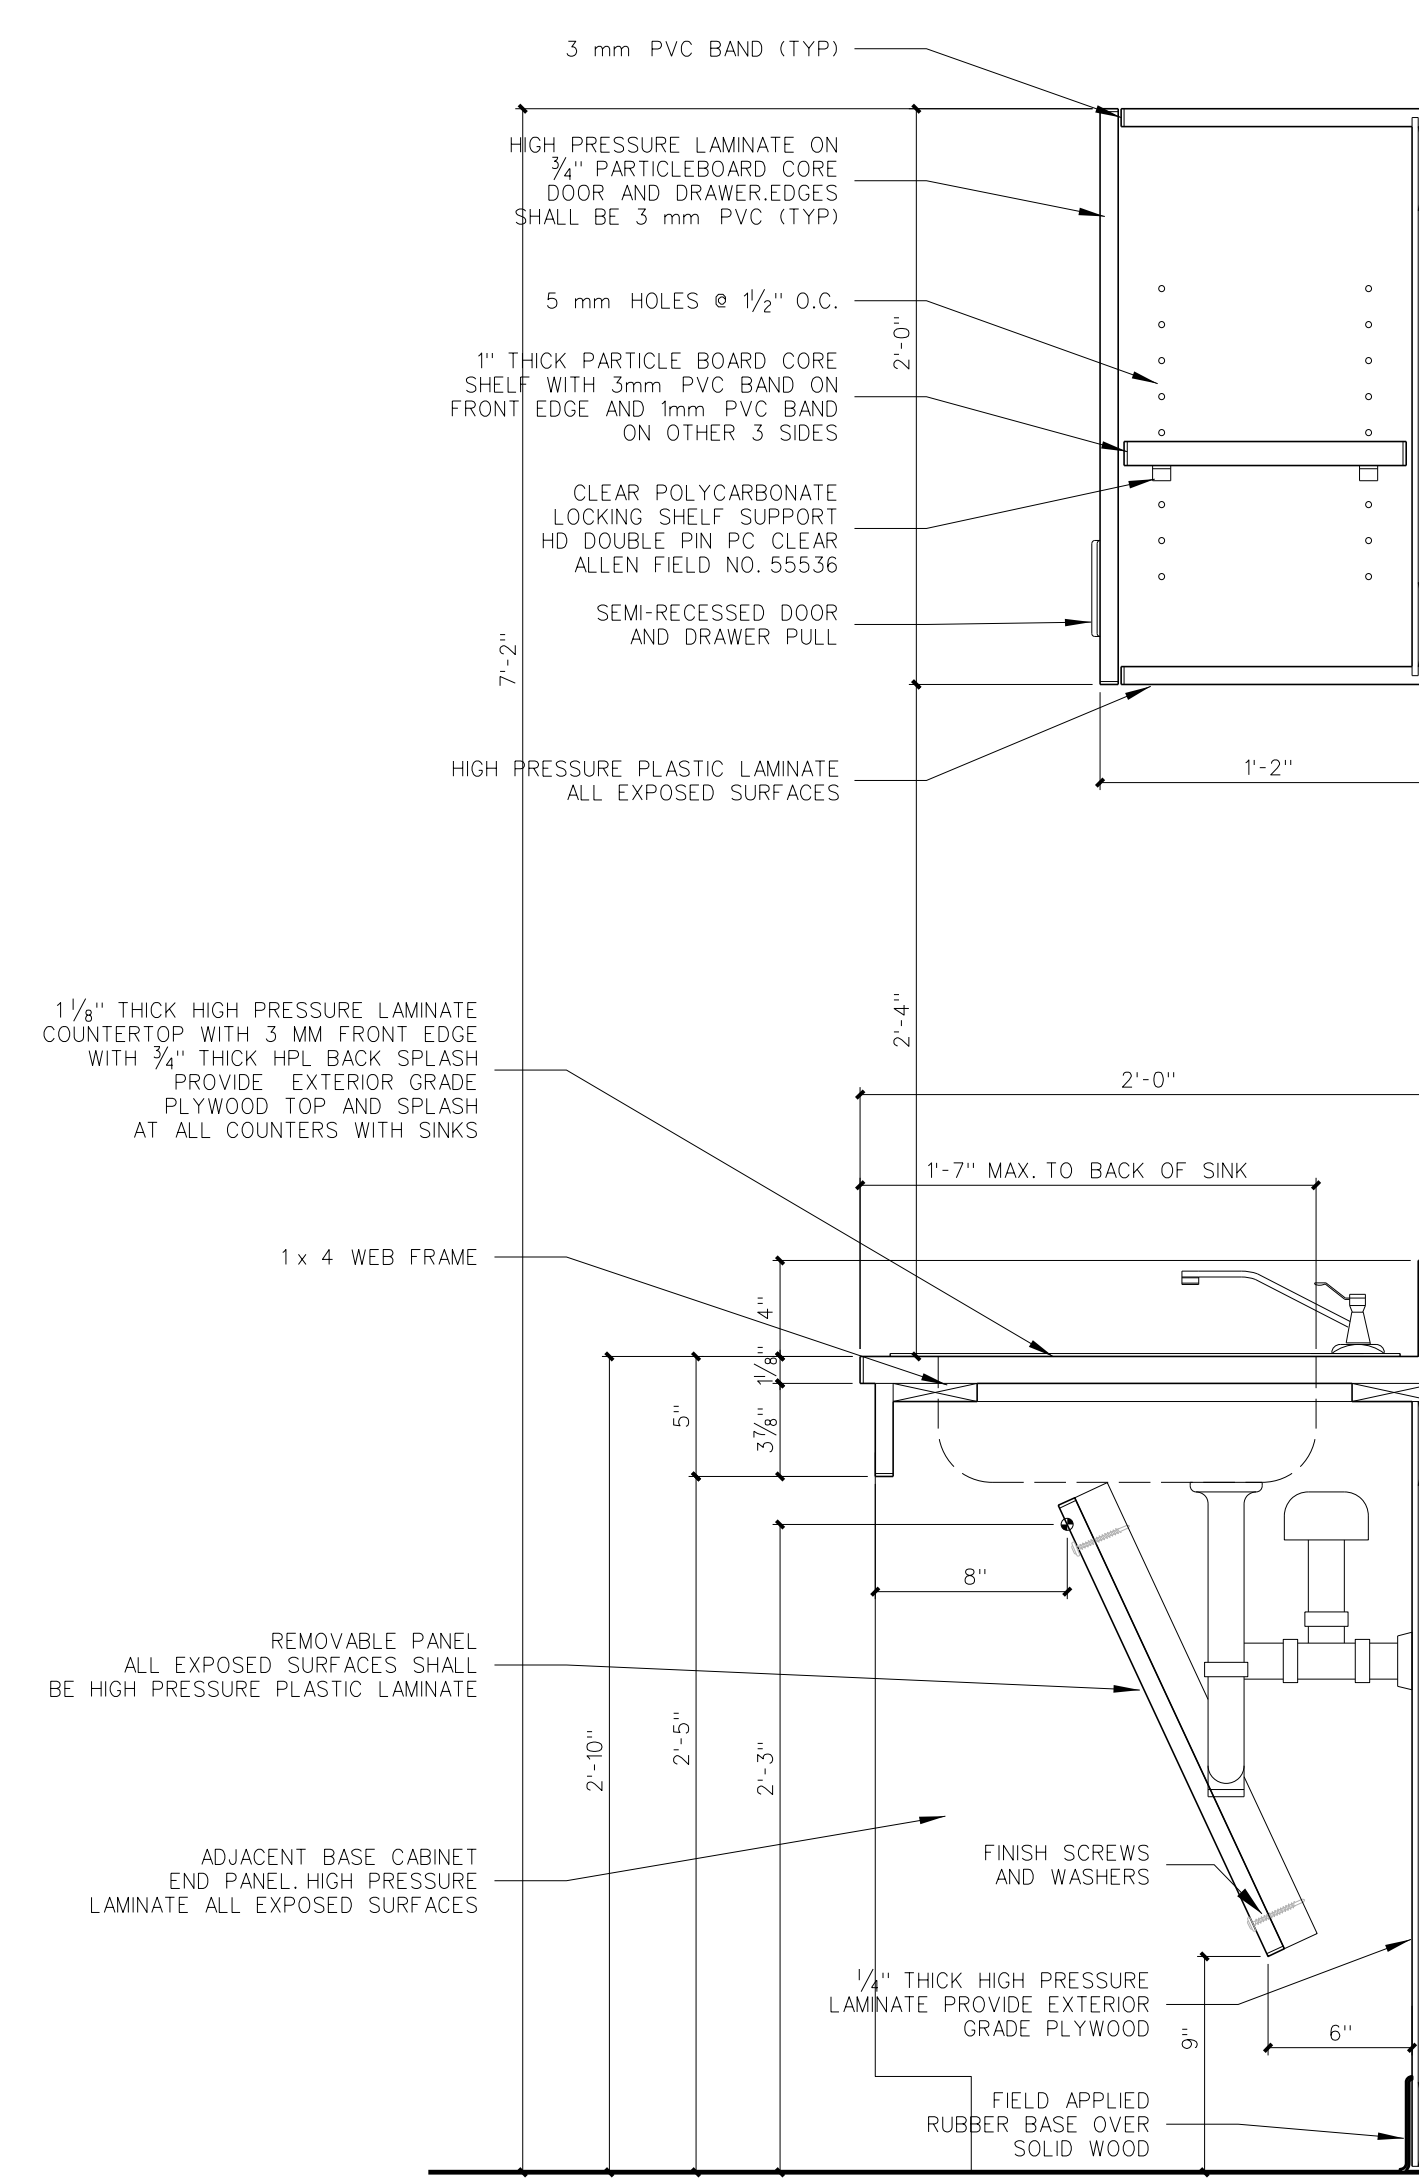


902.6 34" H/C BASE CABINET
24" DEEP
SCALE: 1 1/2" = 1'-0"

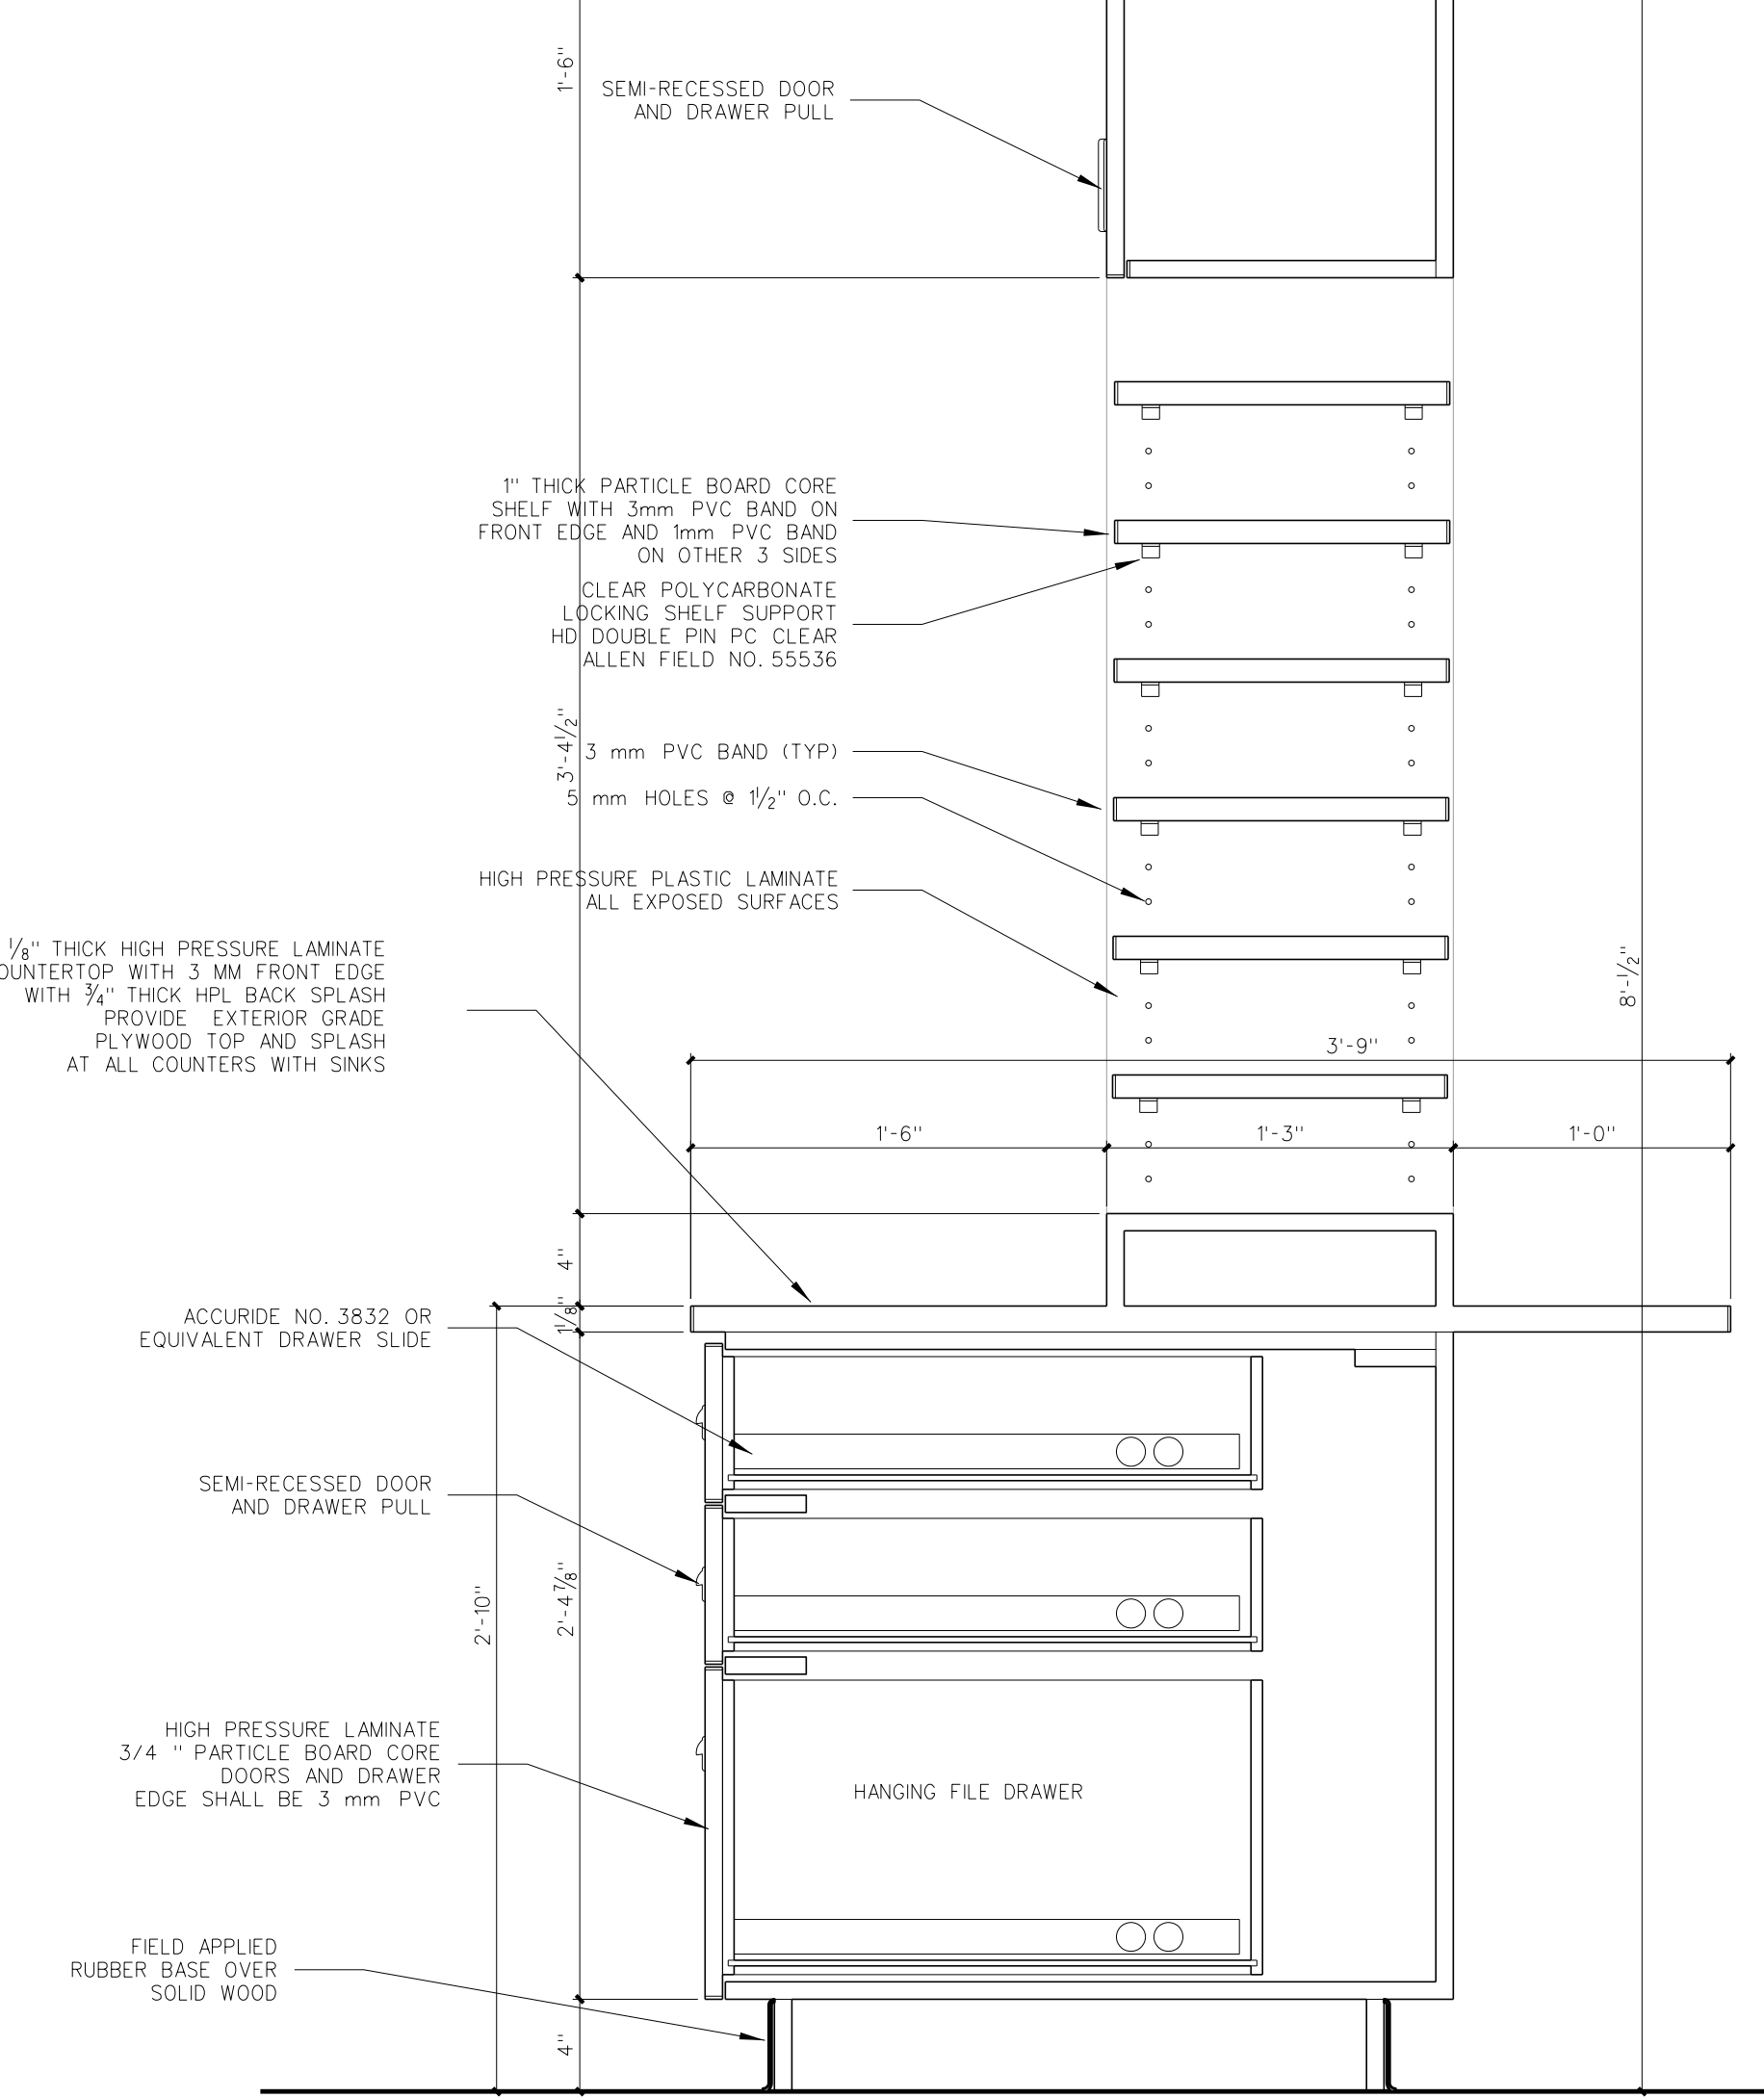


902.5 34" BASE / MAIL SLOTS
SCALE: 1 1/2" = 1'-0"

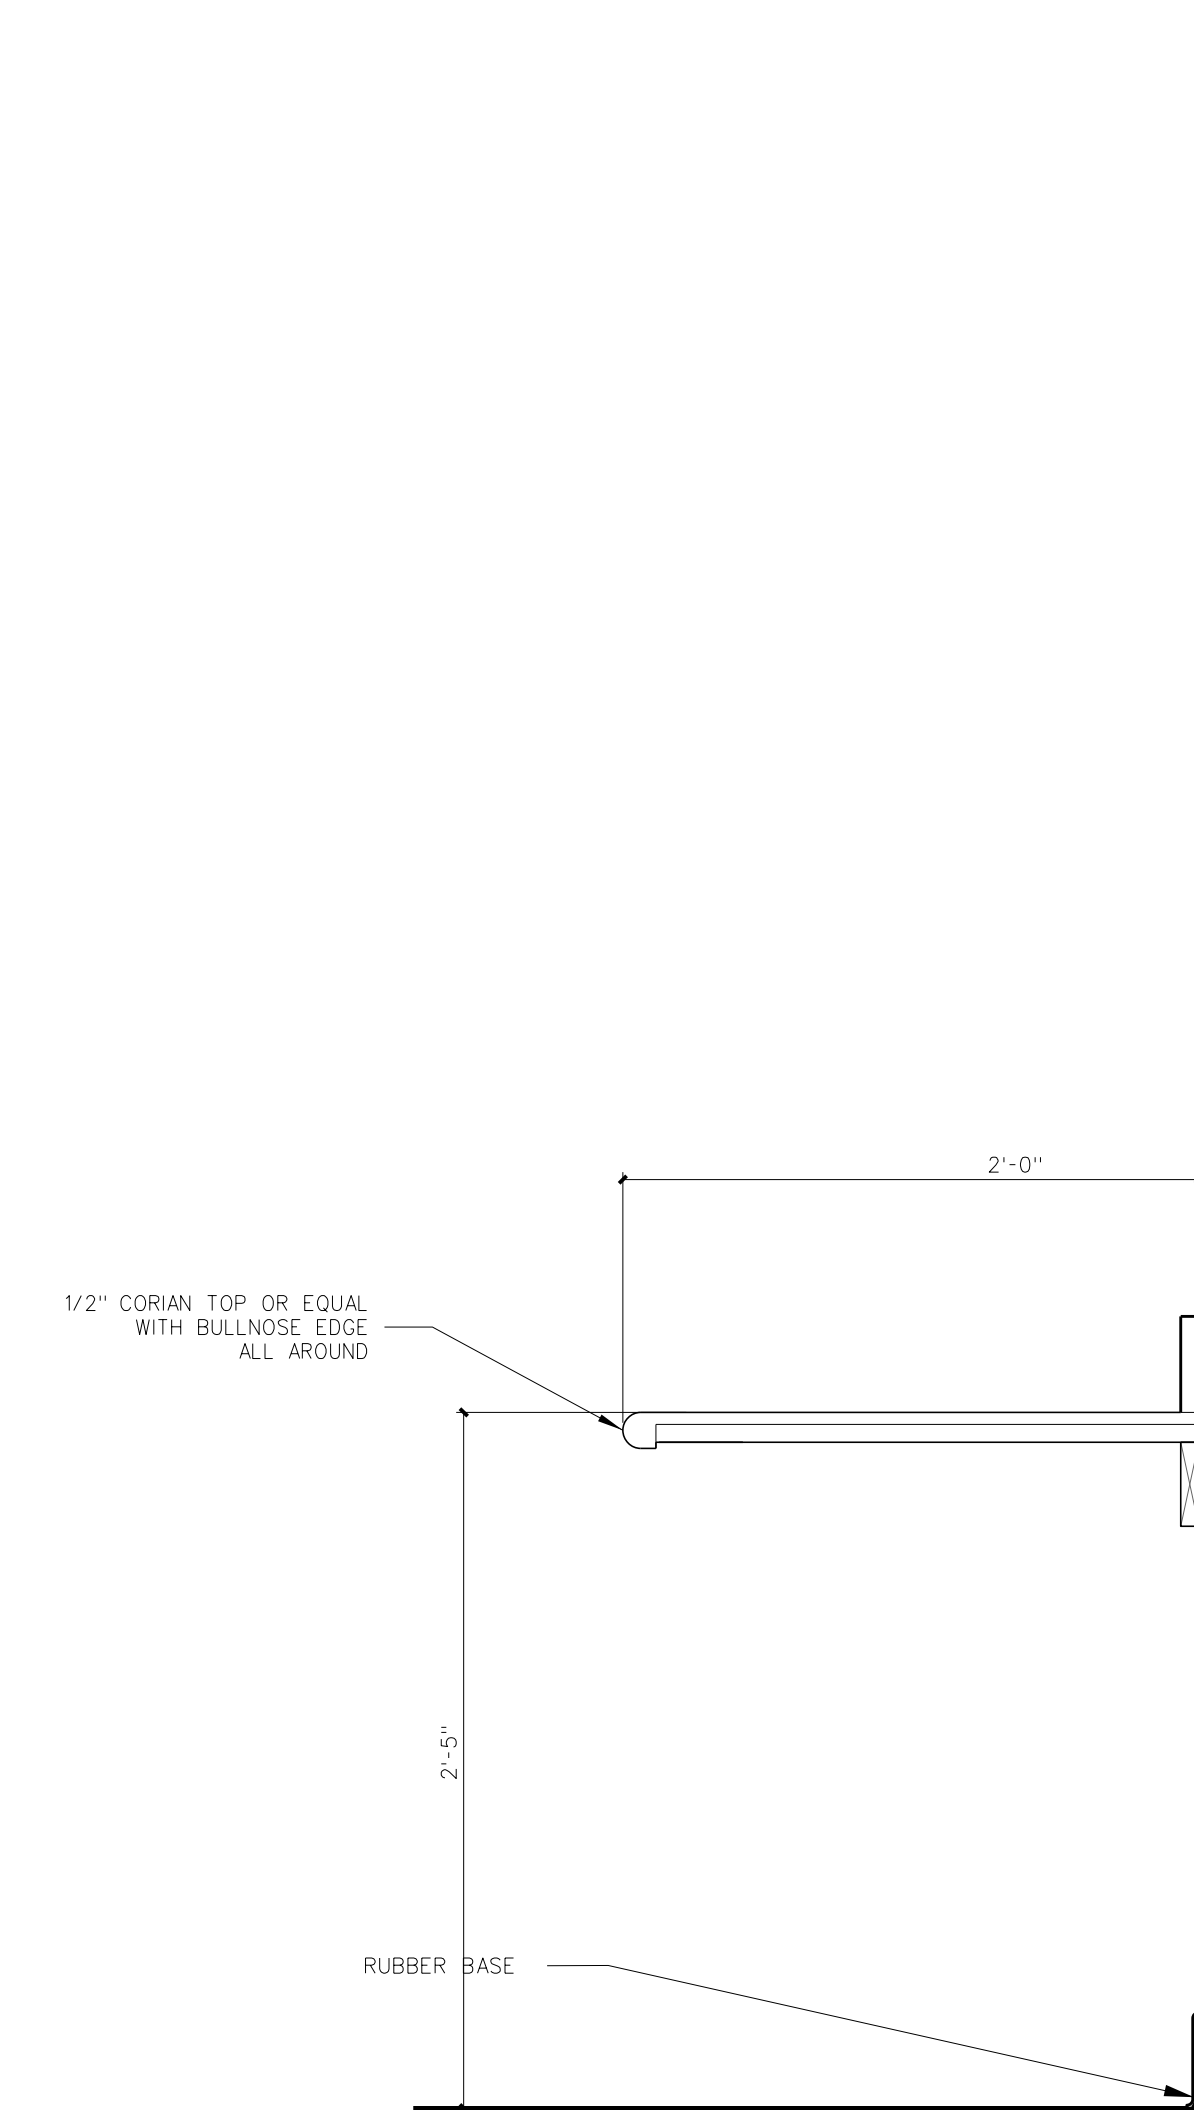


902.4 29" KNEE SPACE @ RECEPTION
SCALE: 1 1/2" = 1'-0"

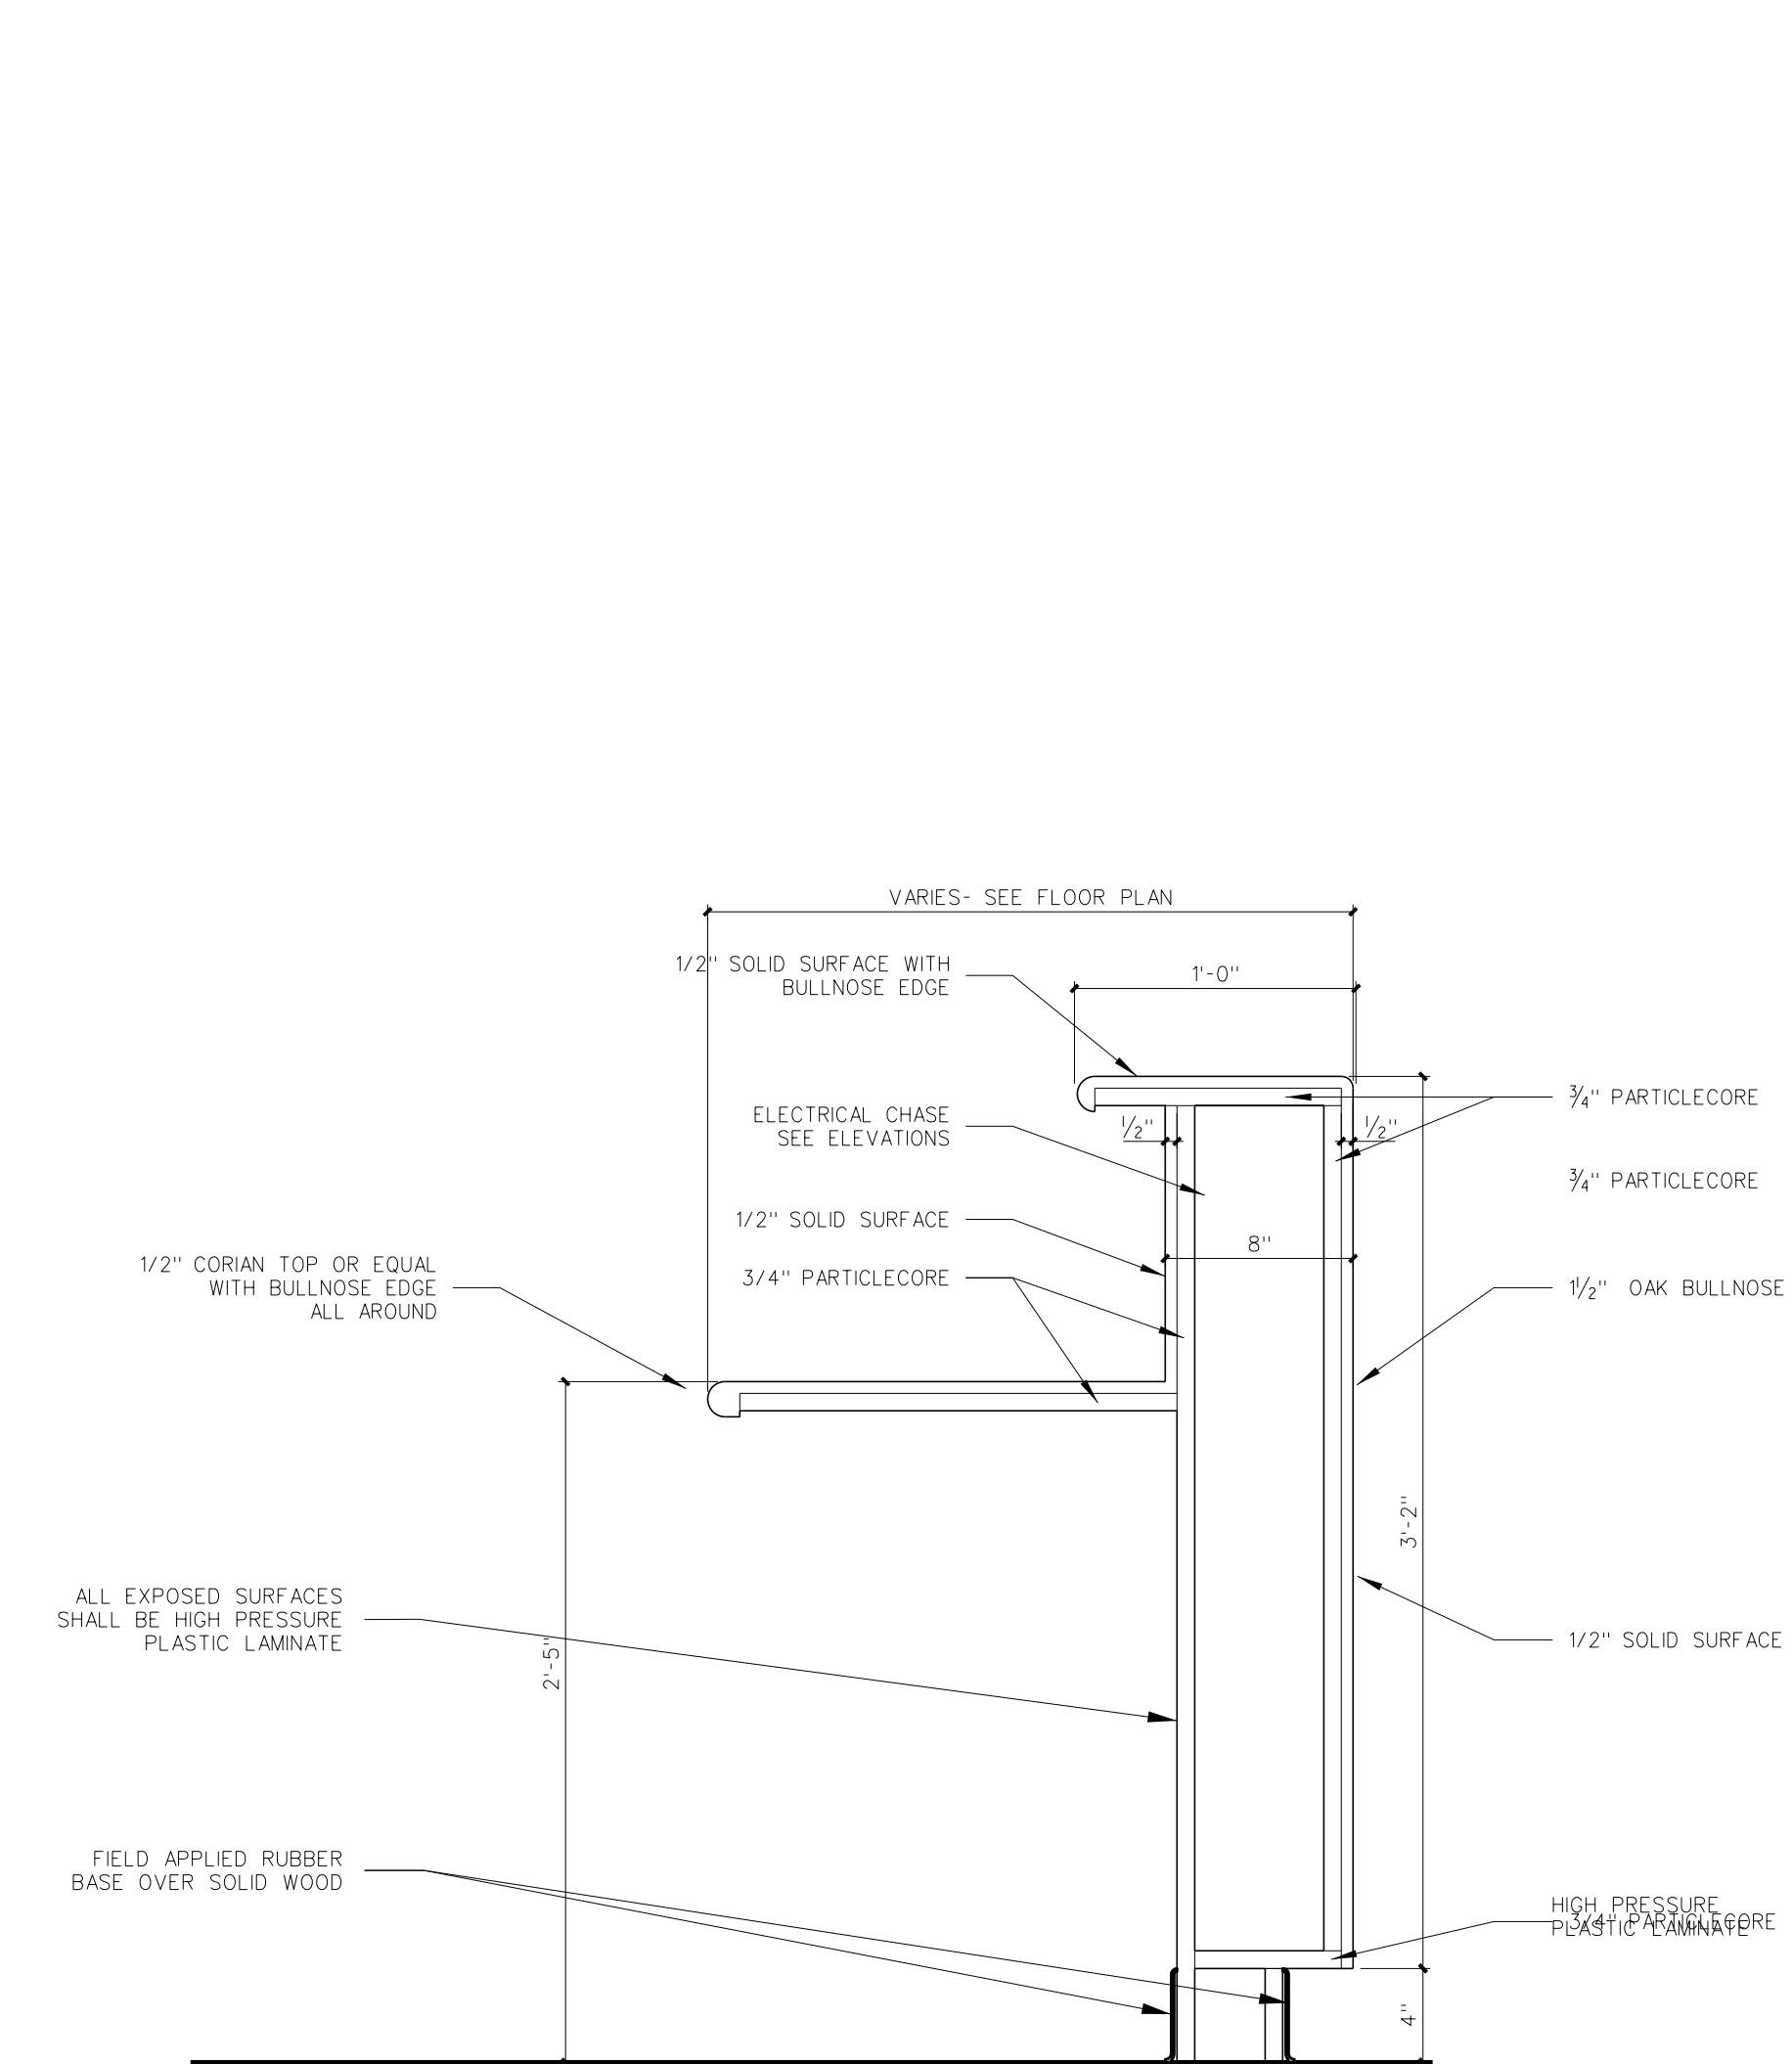

902.3 29" BASE CABINET
SCALE: 1 1/2" = 1'-0"

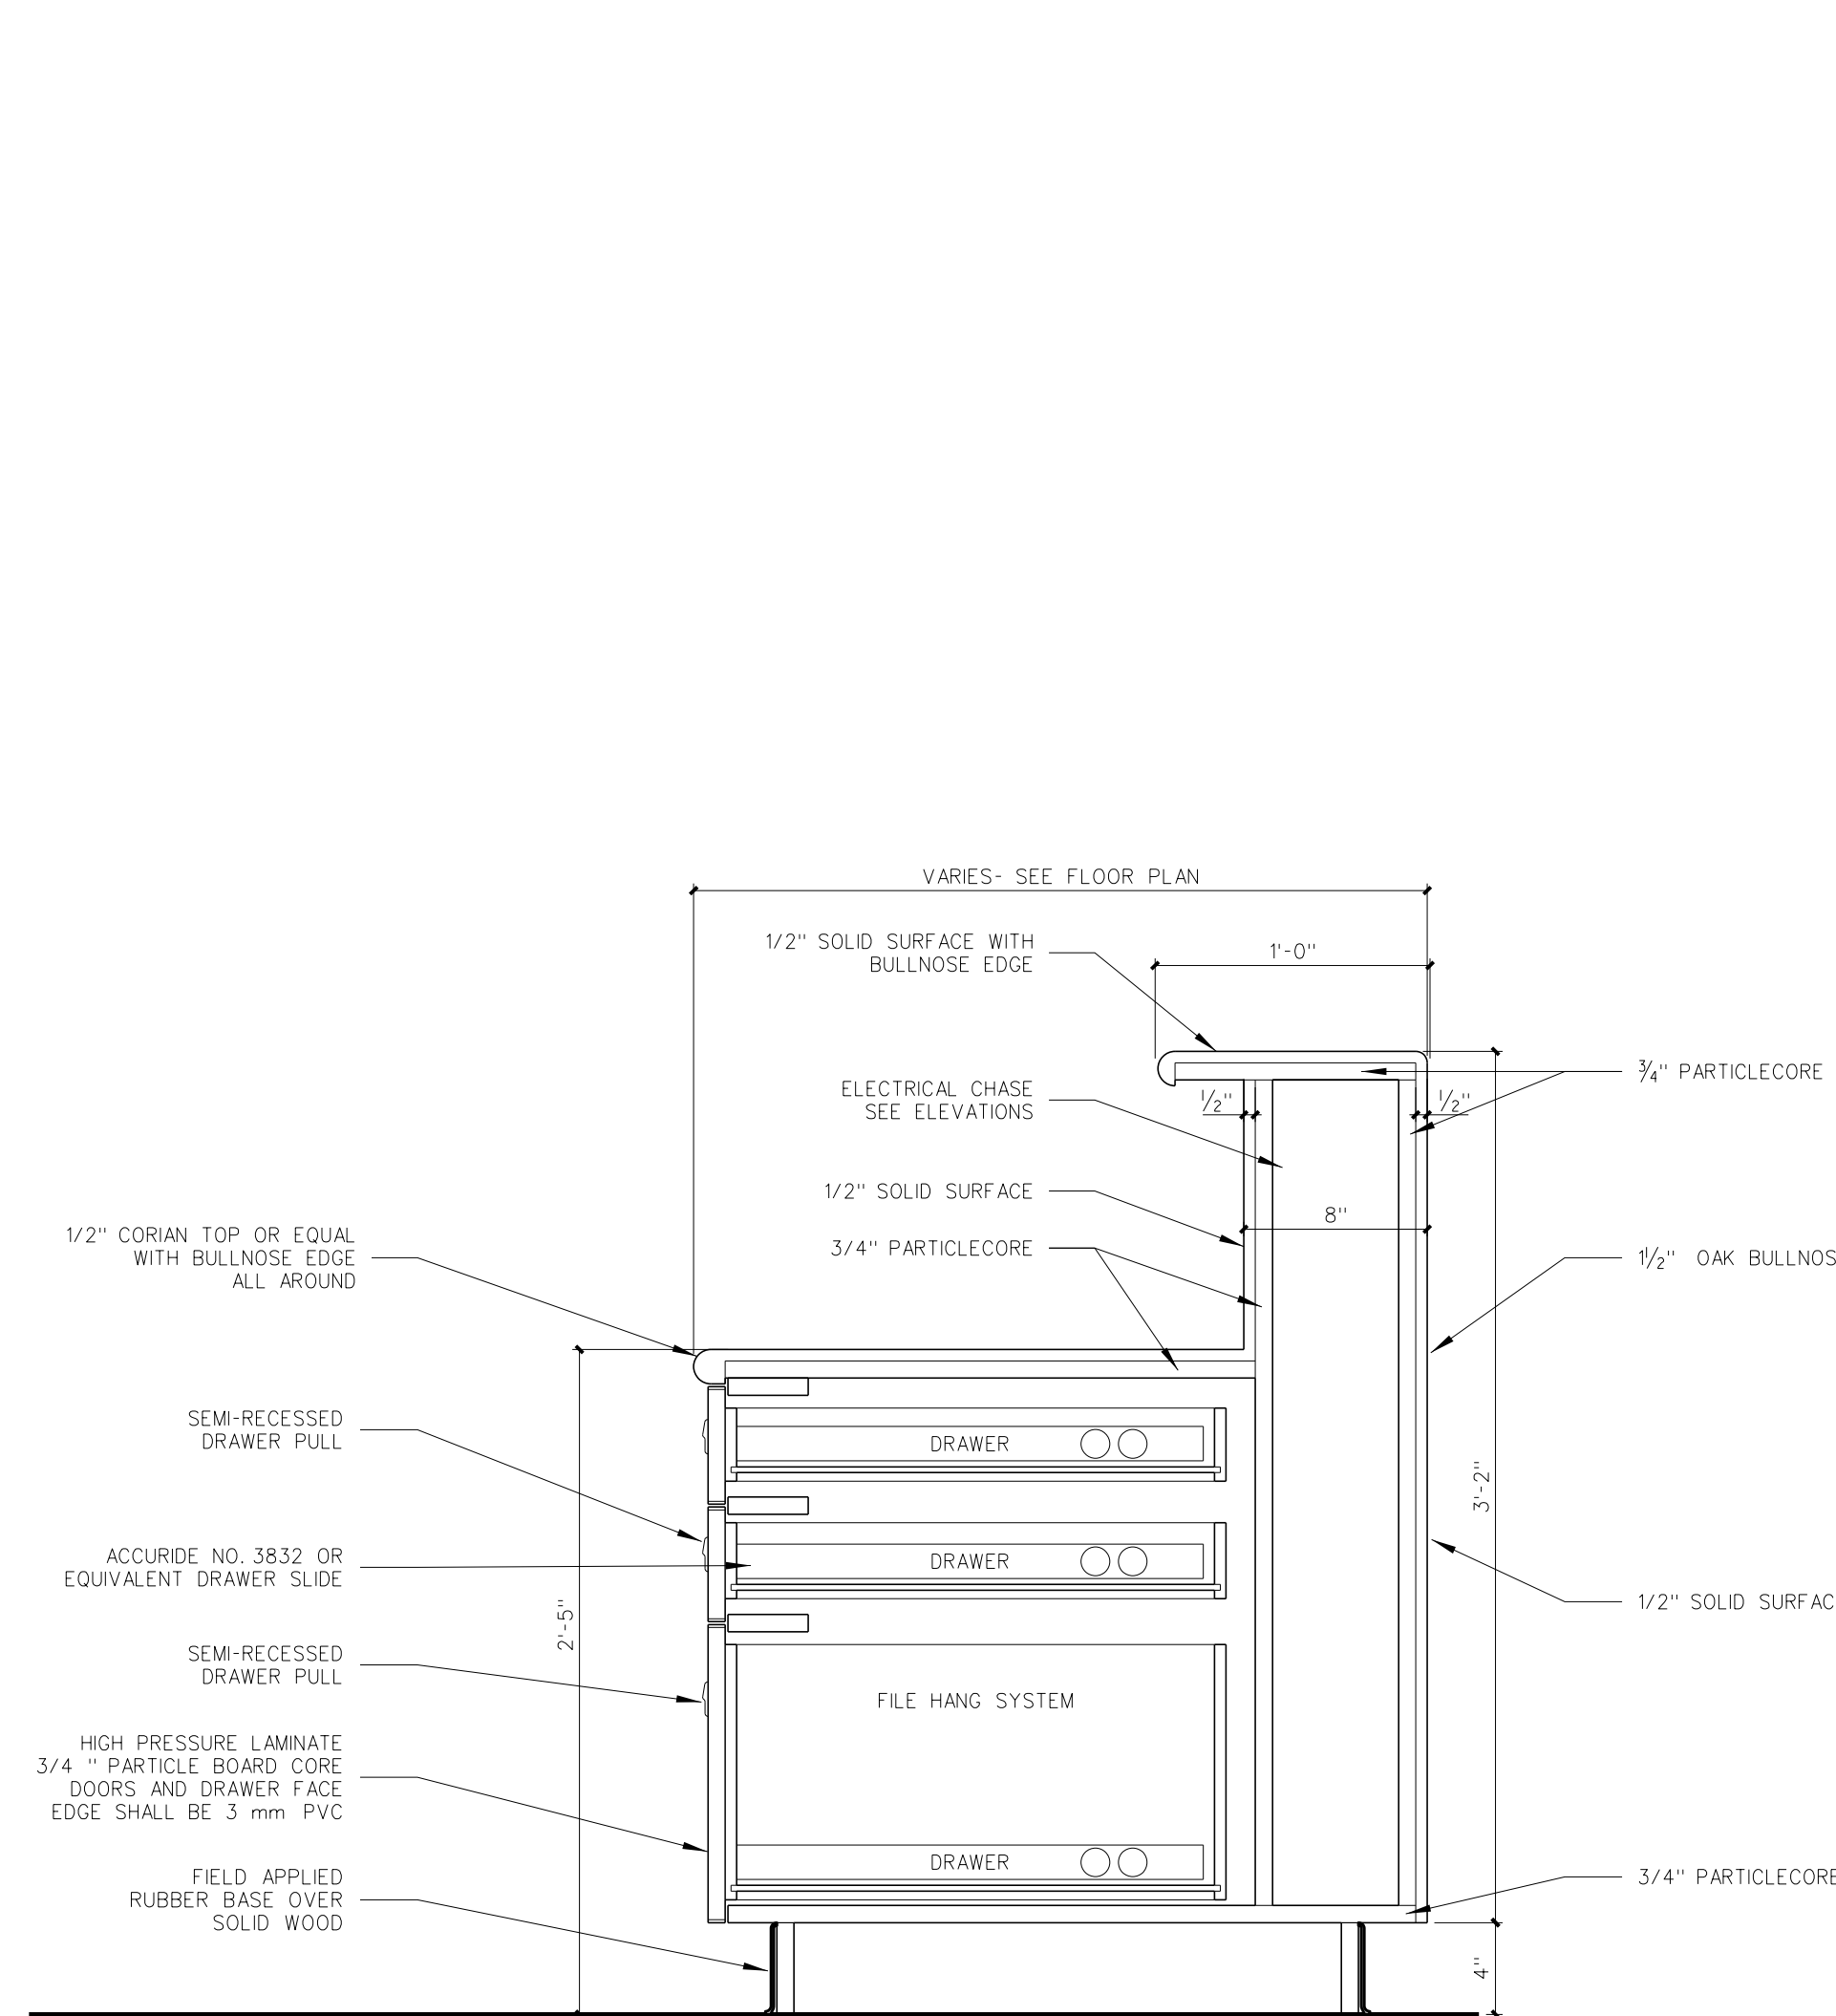

902.2 29" BASE CABINET
SCALE: 1 1/2" = 1'-0"

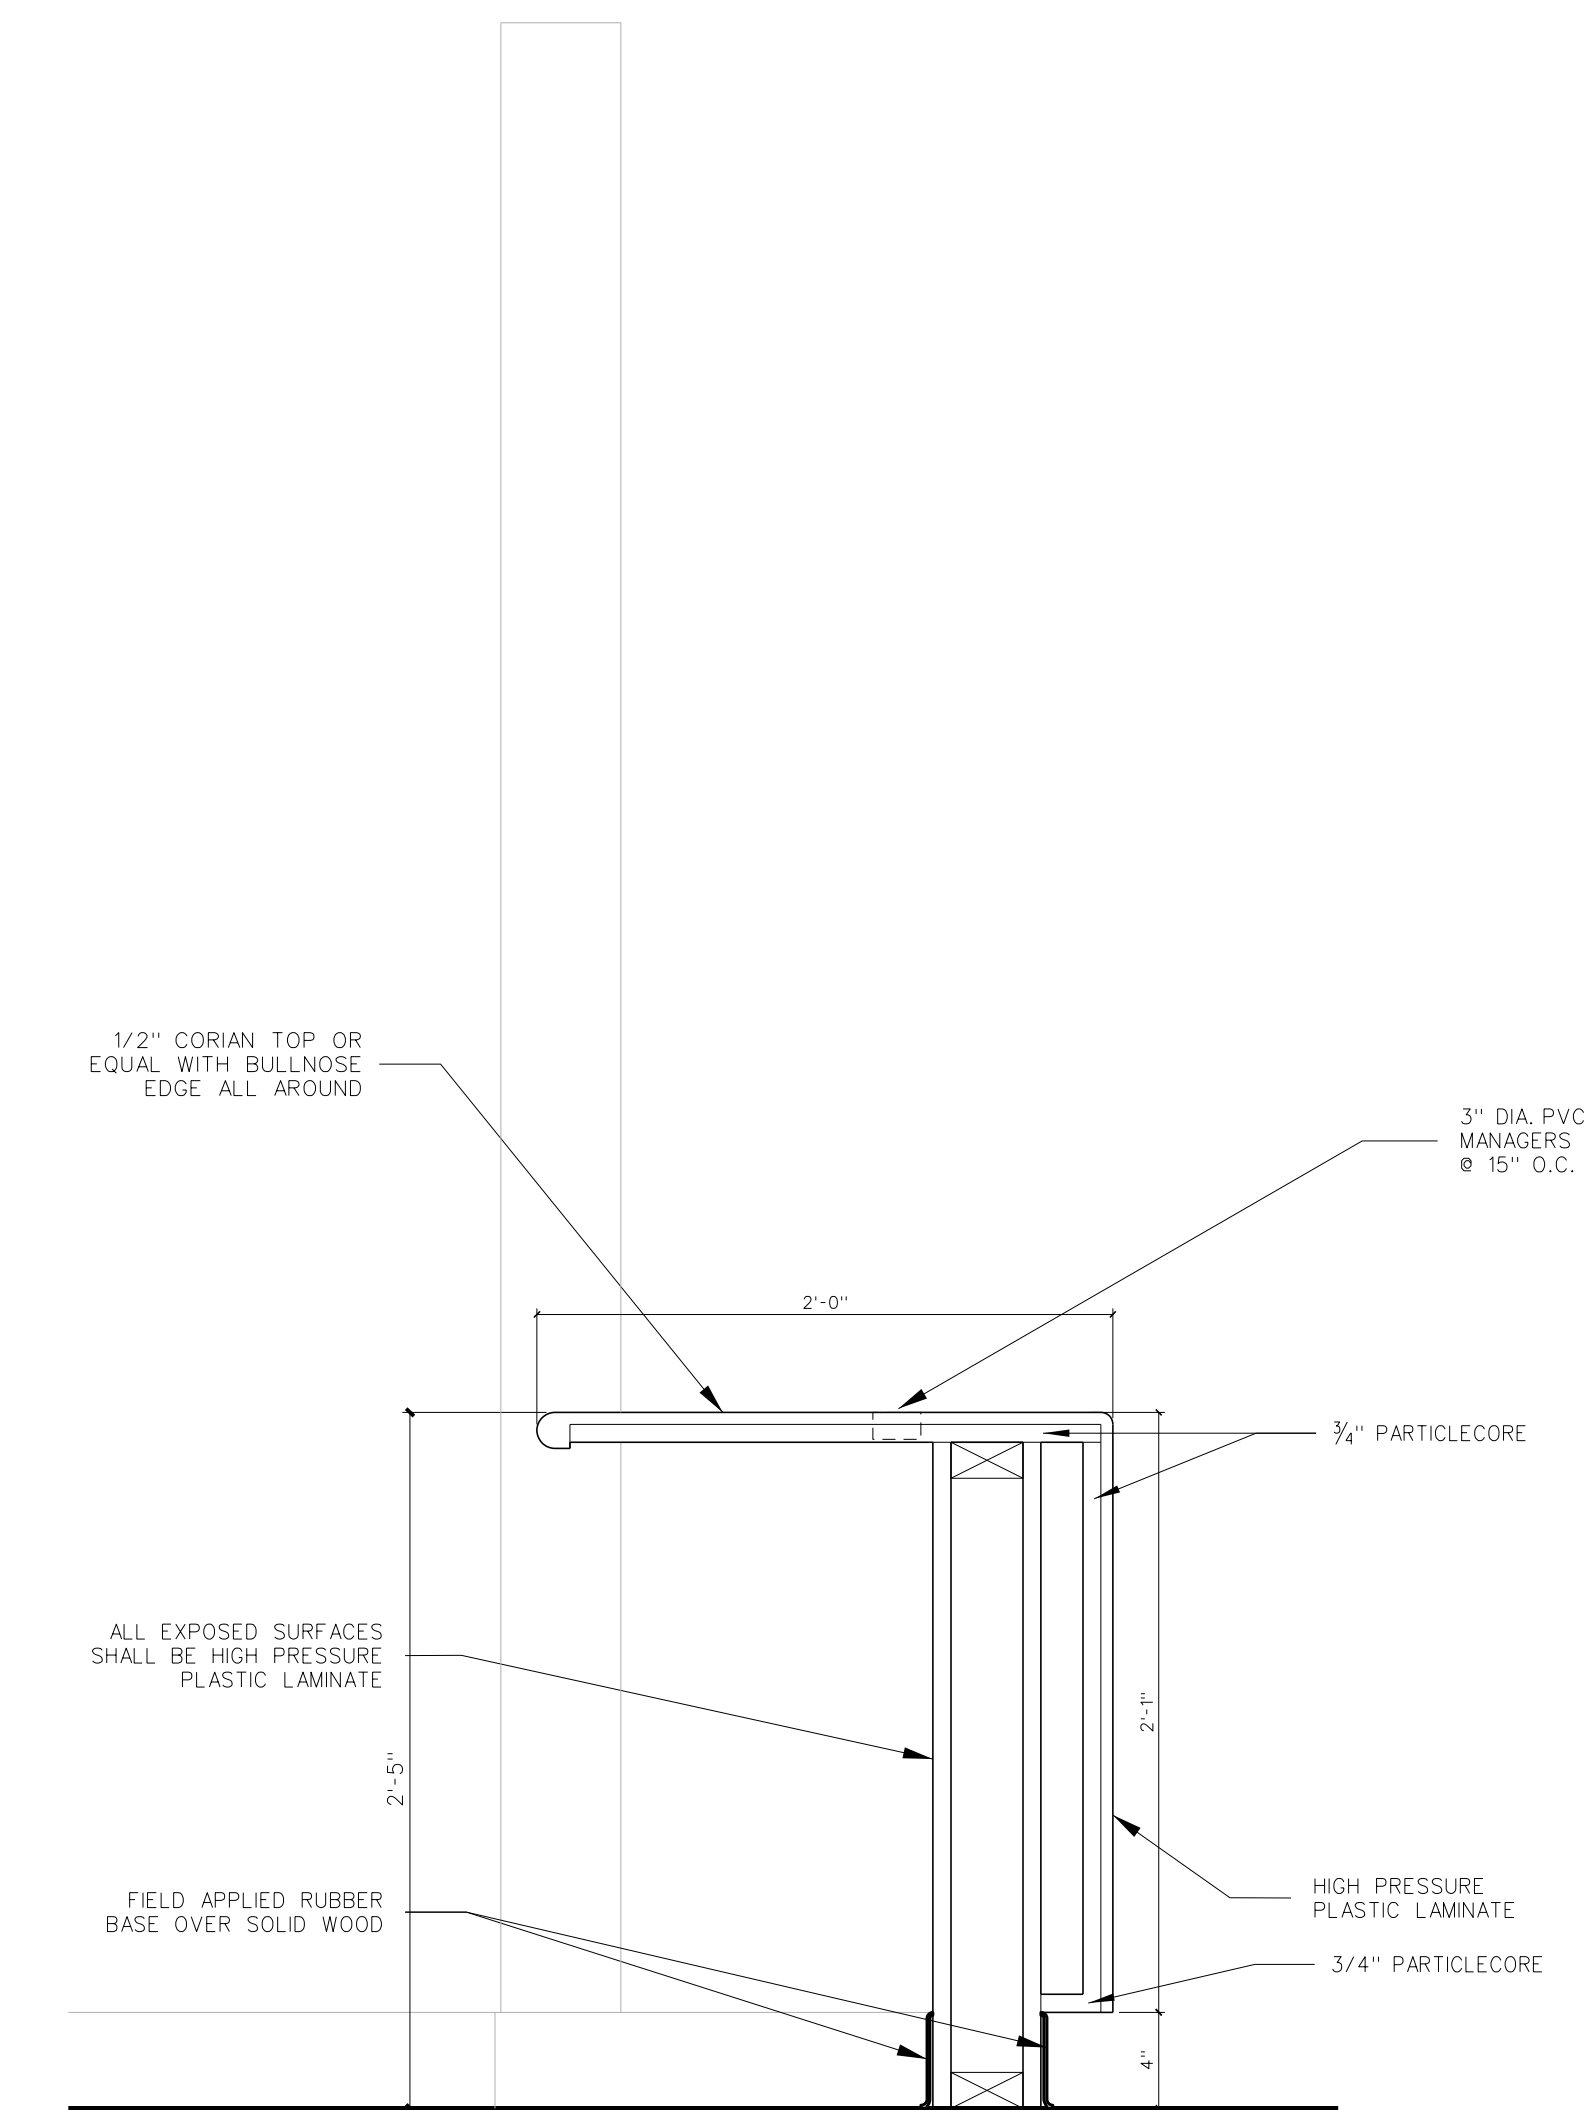

902.1 29" BASE CABINET
SCALE: 1 1/2" = 1'-0"


No.	Date	Revision

Hite associates
ARCHITECTURE / PLANNING / TECHNOLOGY
2600 Meridian Drive / Greenville, NC 27834 / tel (252) 757-0333




Beaufort PK-3 School
BEAUFORT COUNTY SCHOOLS
Washington / North Carolina / 727889


Project No. 22344
Date: 1 July 2024
Drawing no. **A 902**

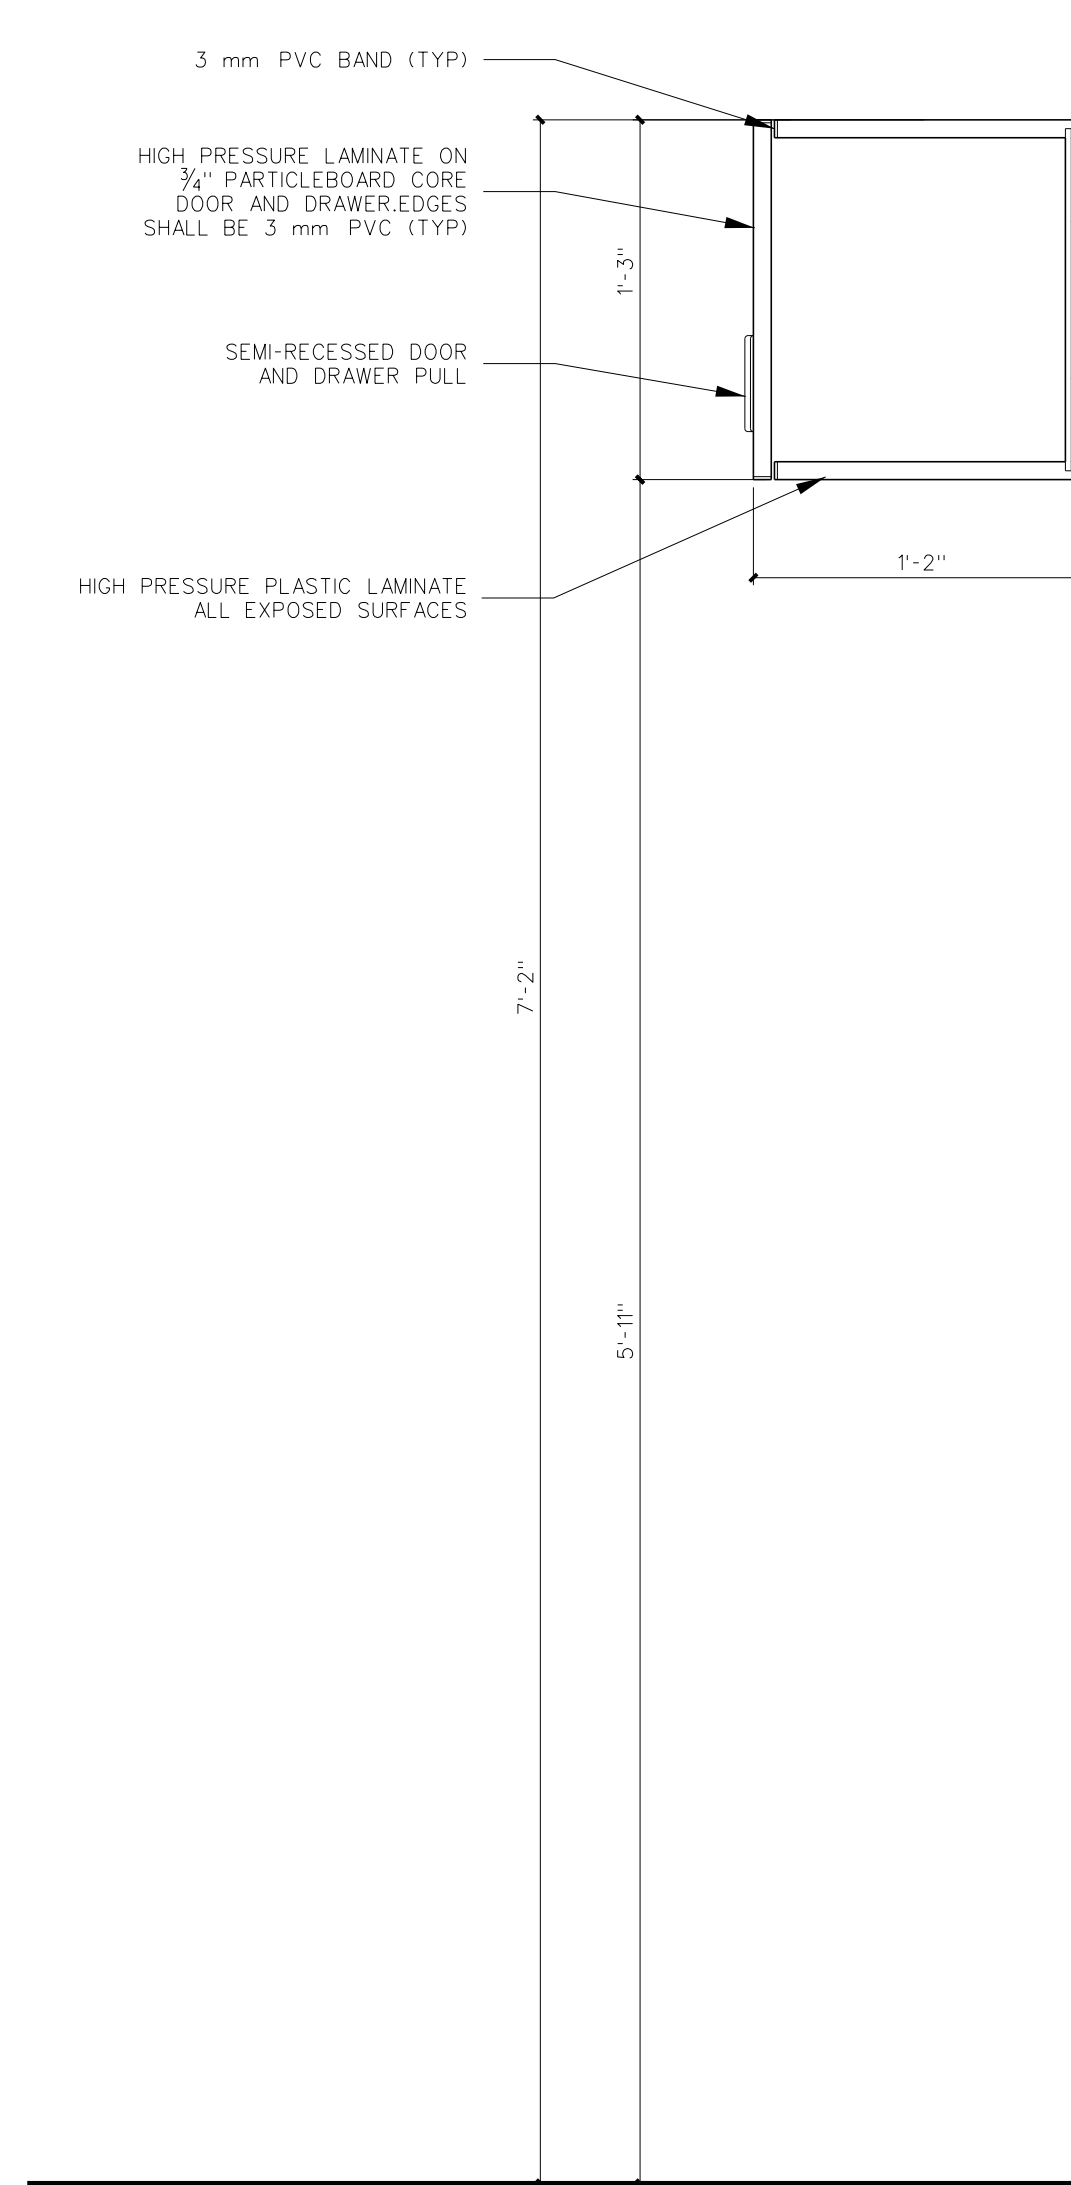


903.8 CABINET OVER REFRIGERATOR
SCALE: 1 1/2" = 1'-0"

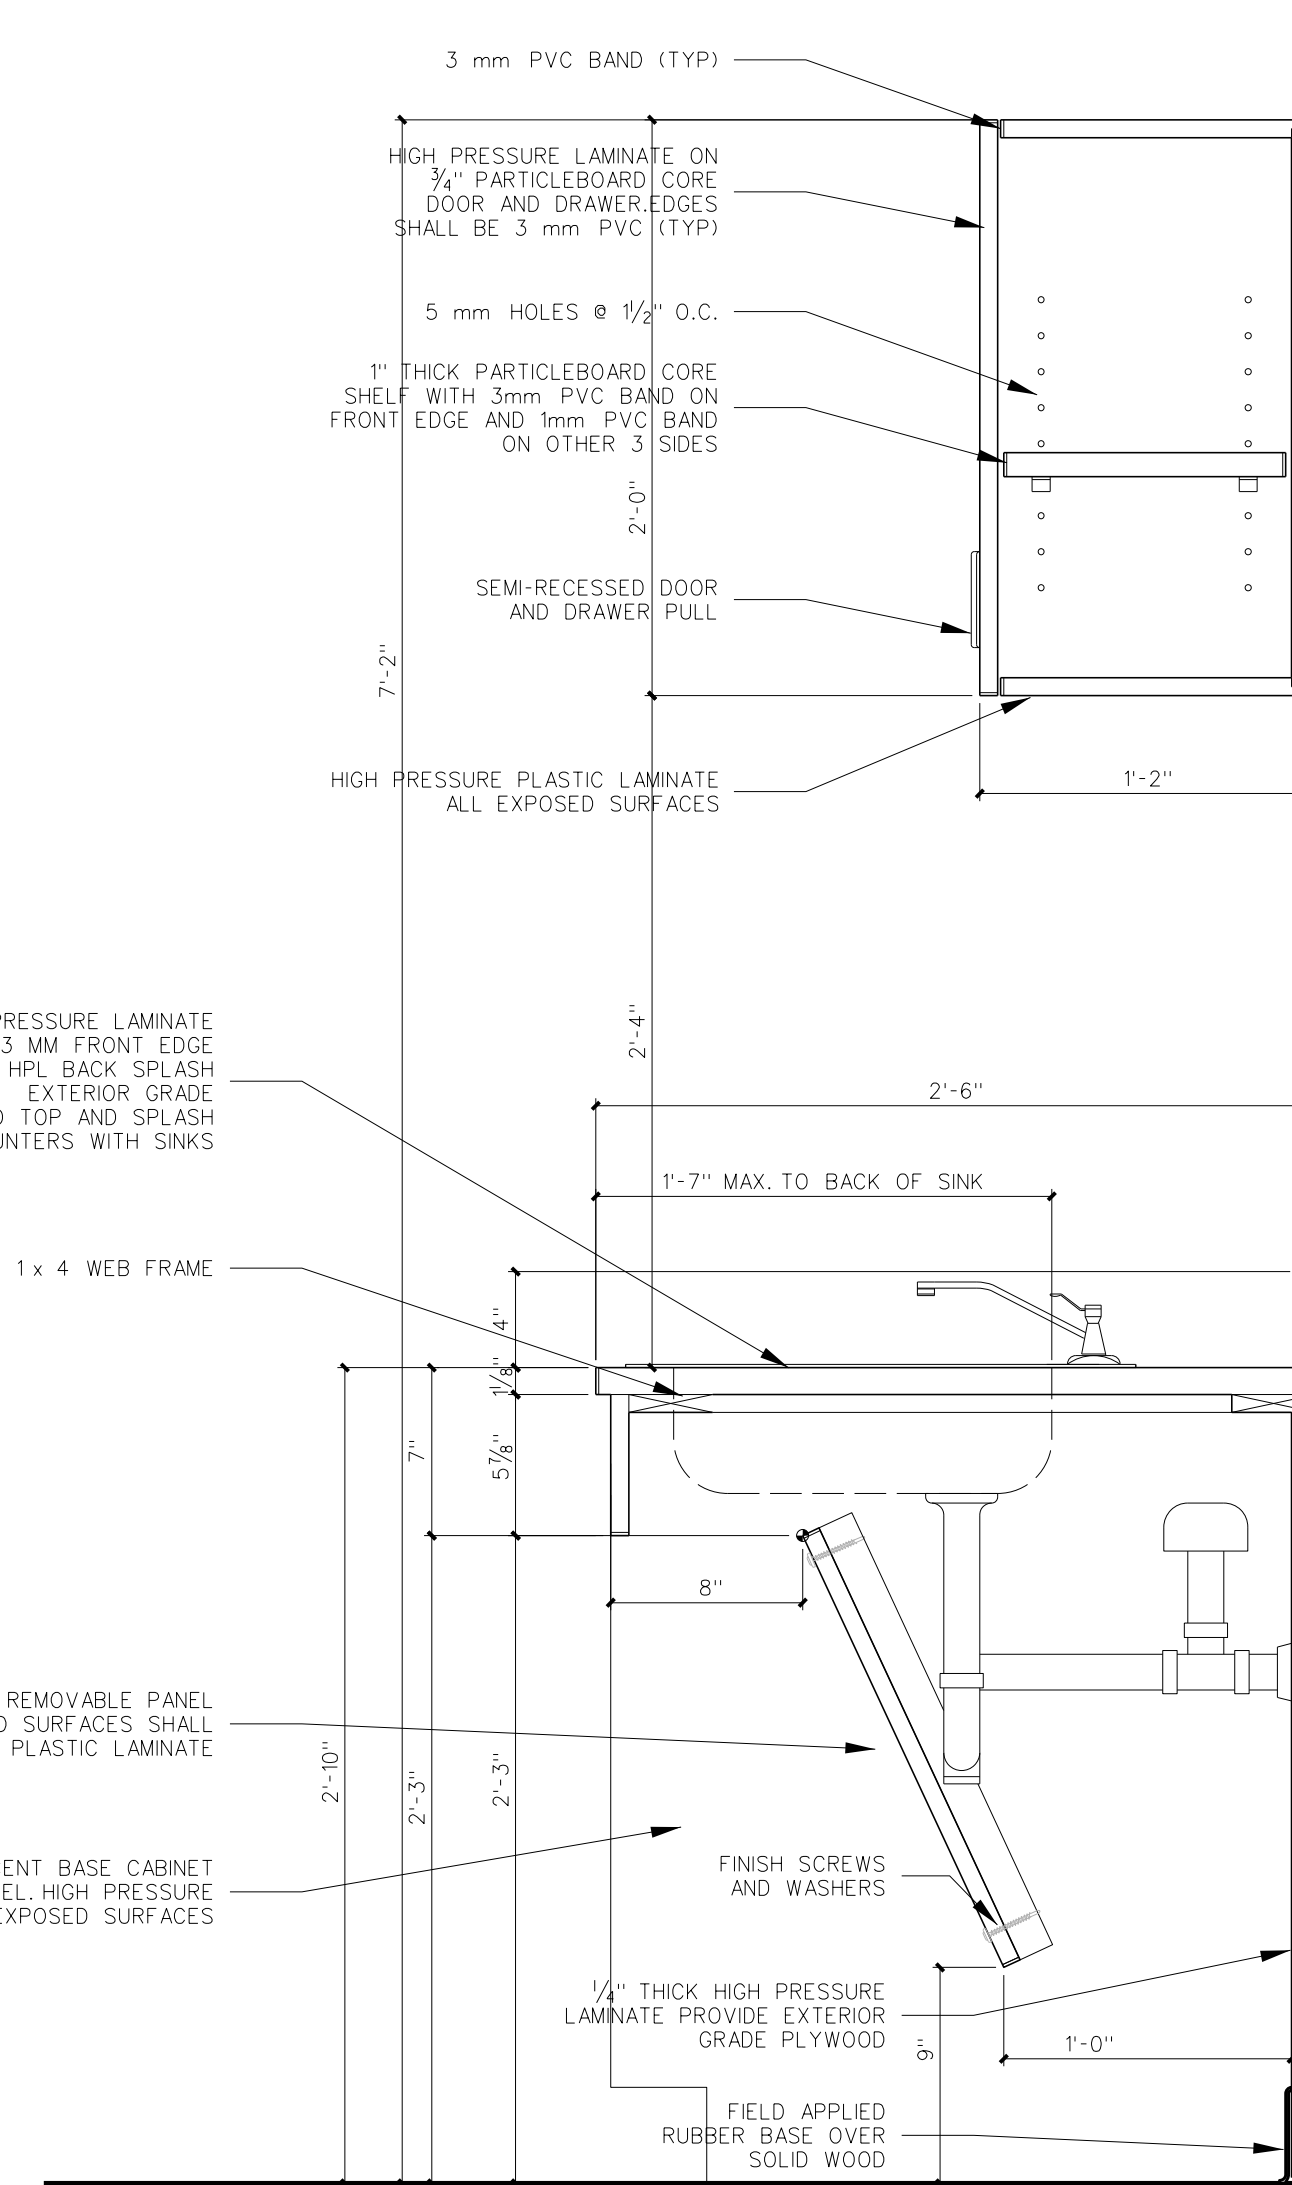


903.7 34" H/C BASE CABINET
30" DEEP
SCALE: 1 1/2" = 1'-0"

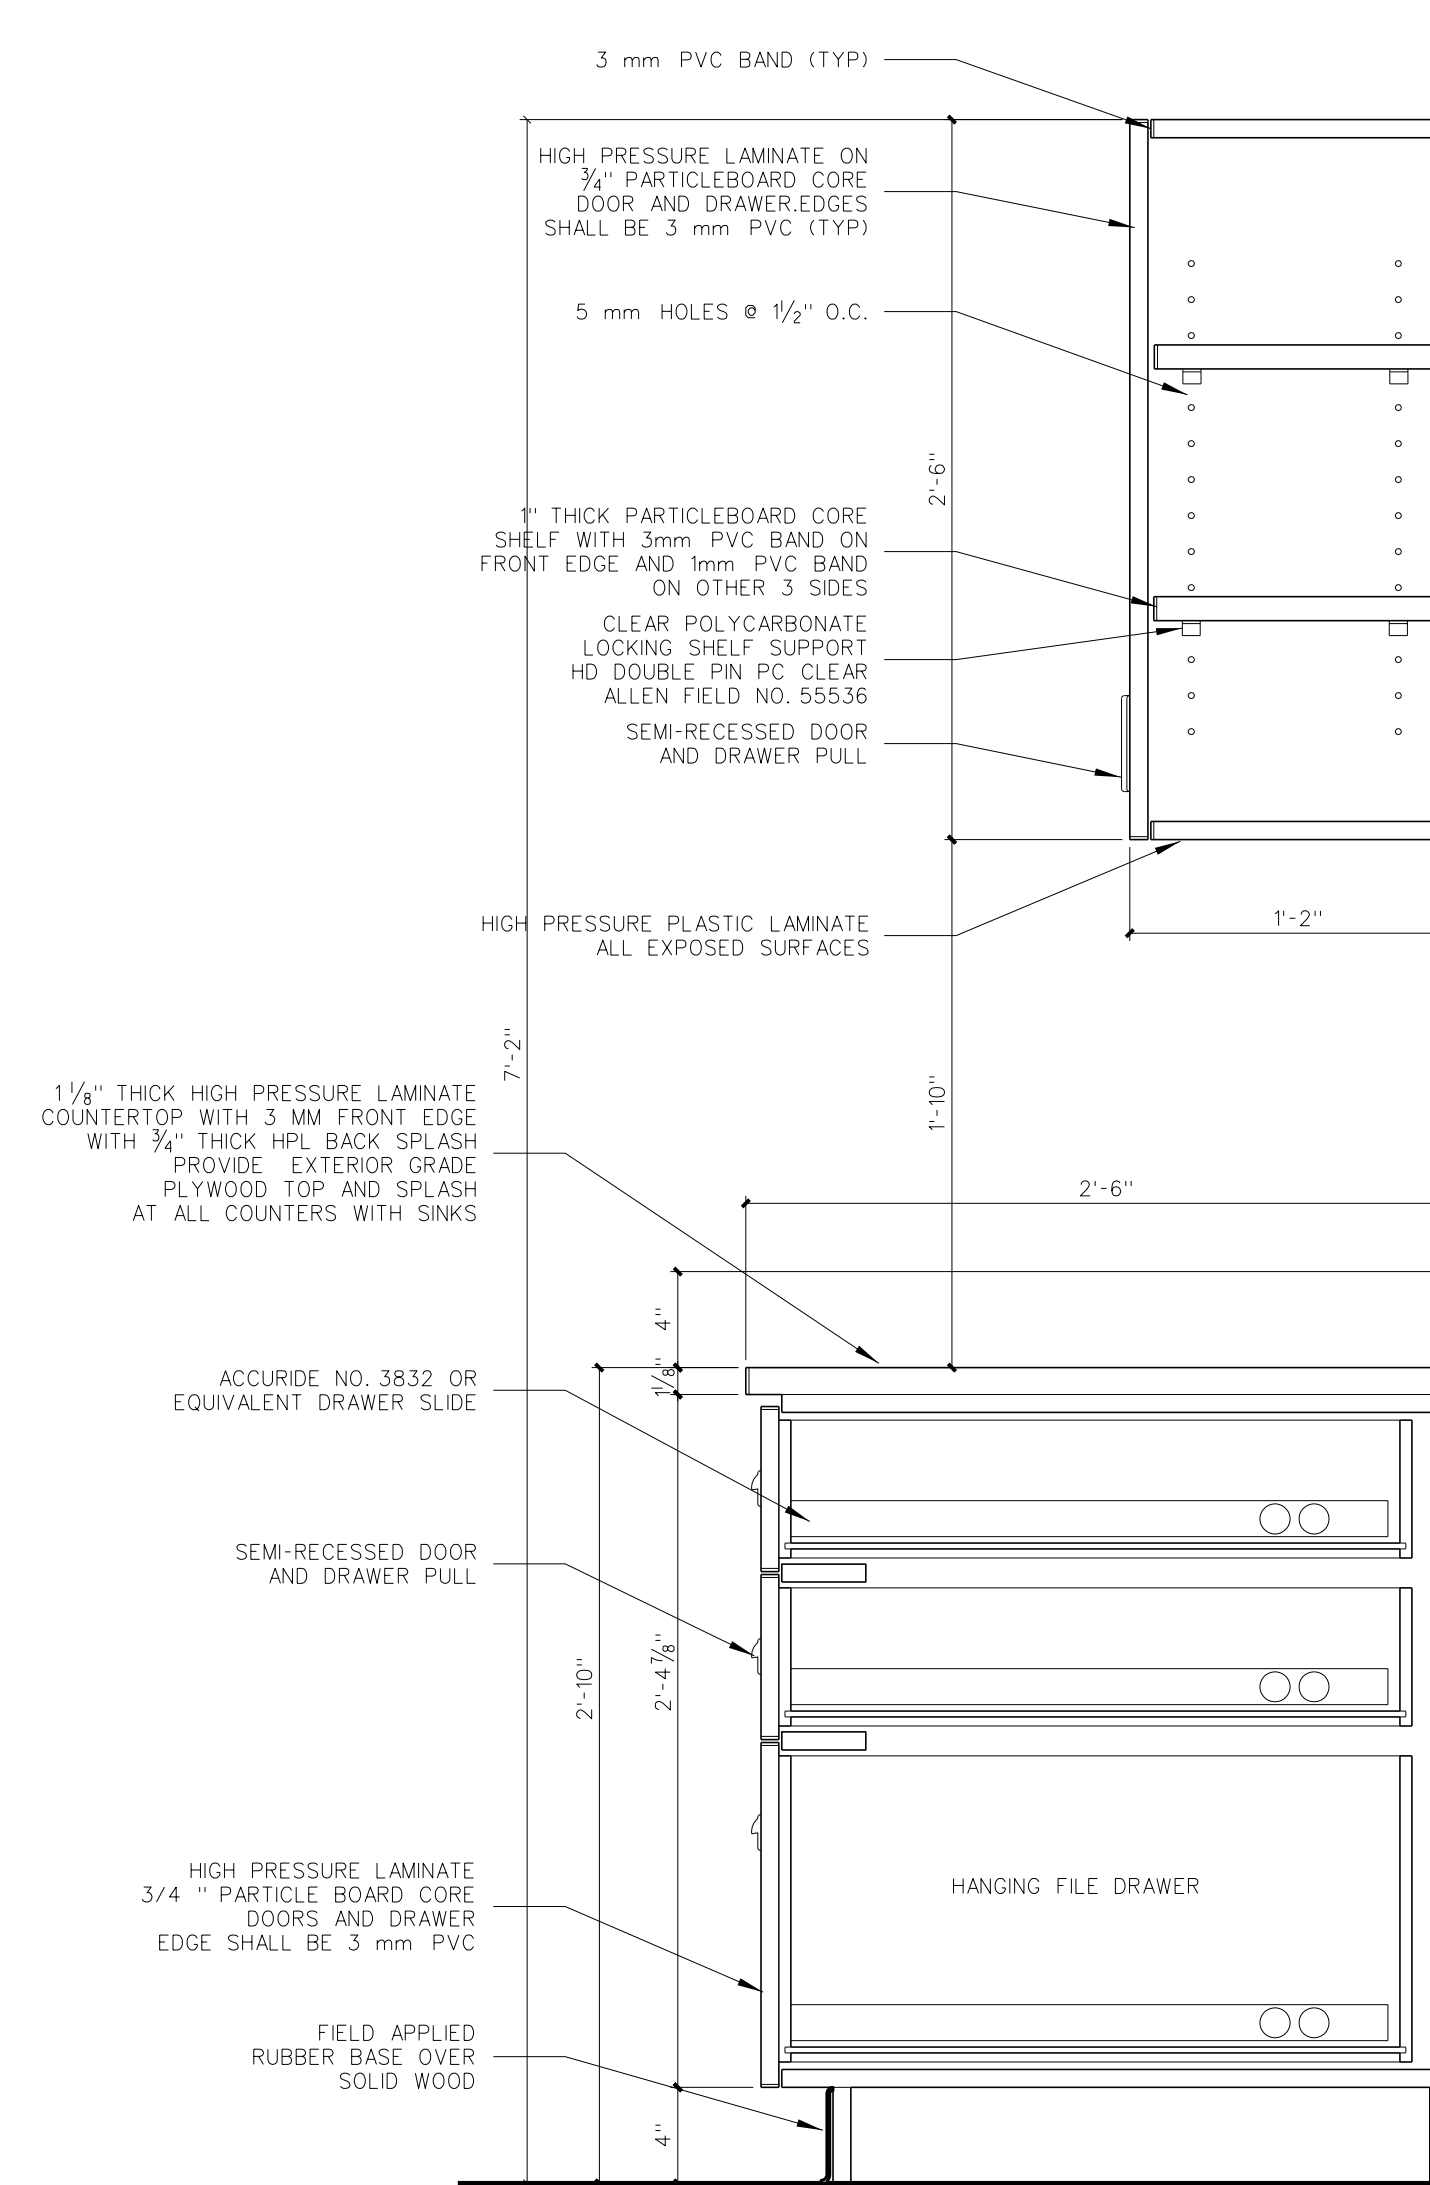


903.6 34" BASE CABINET
30" DEEP
SCALE: 1 1/2" = 1'-0"

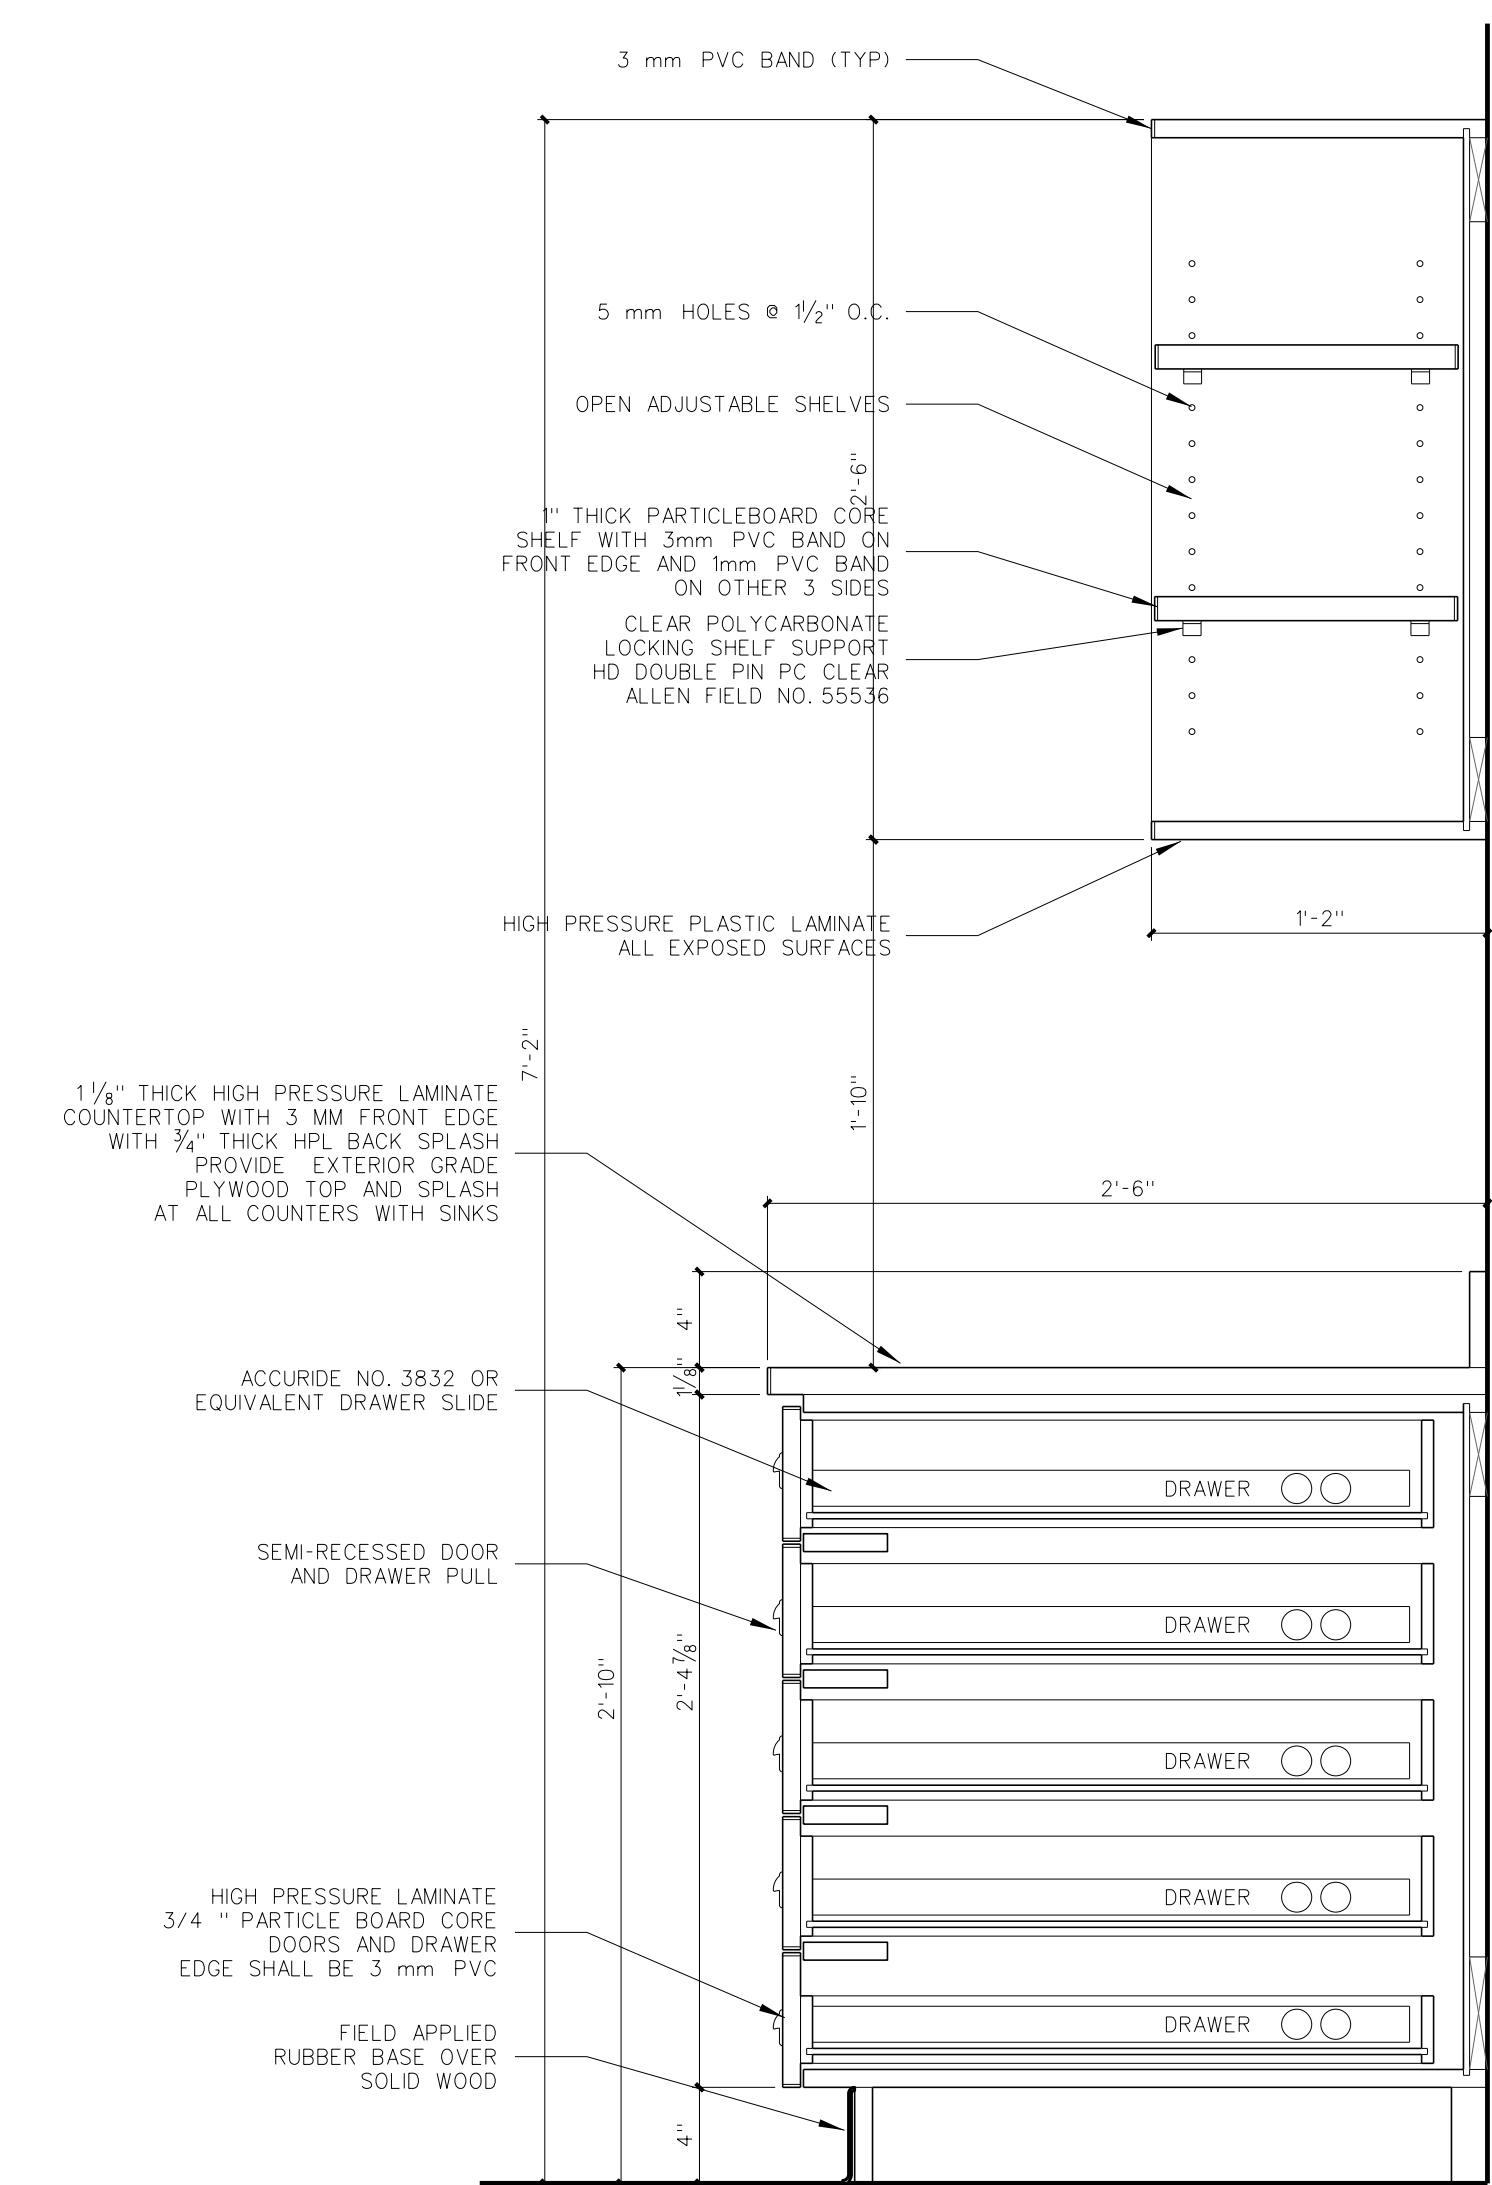


903.5 34" BASE CABINET
NOTE: 30" DEEP
SCALE: 1 1/2" = 1'-0"

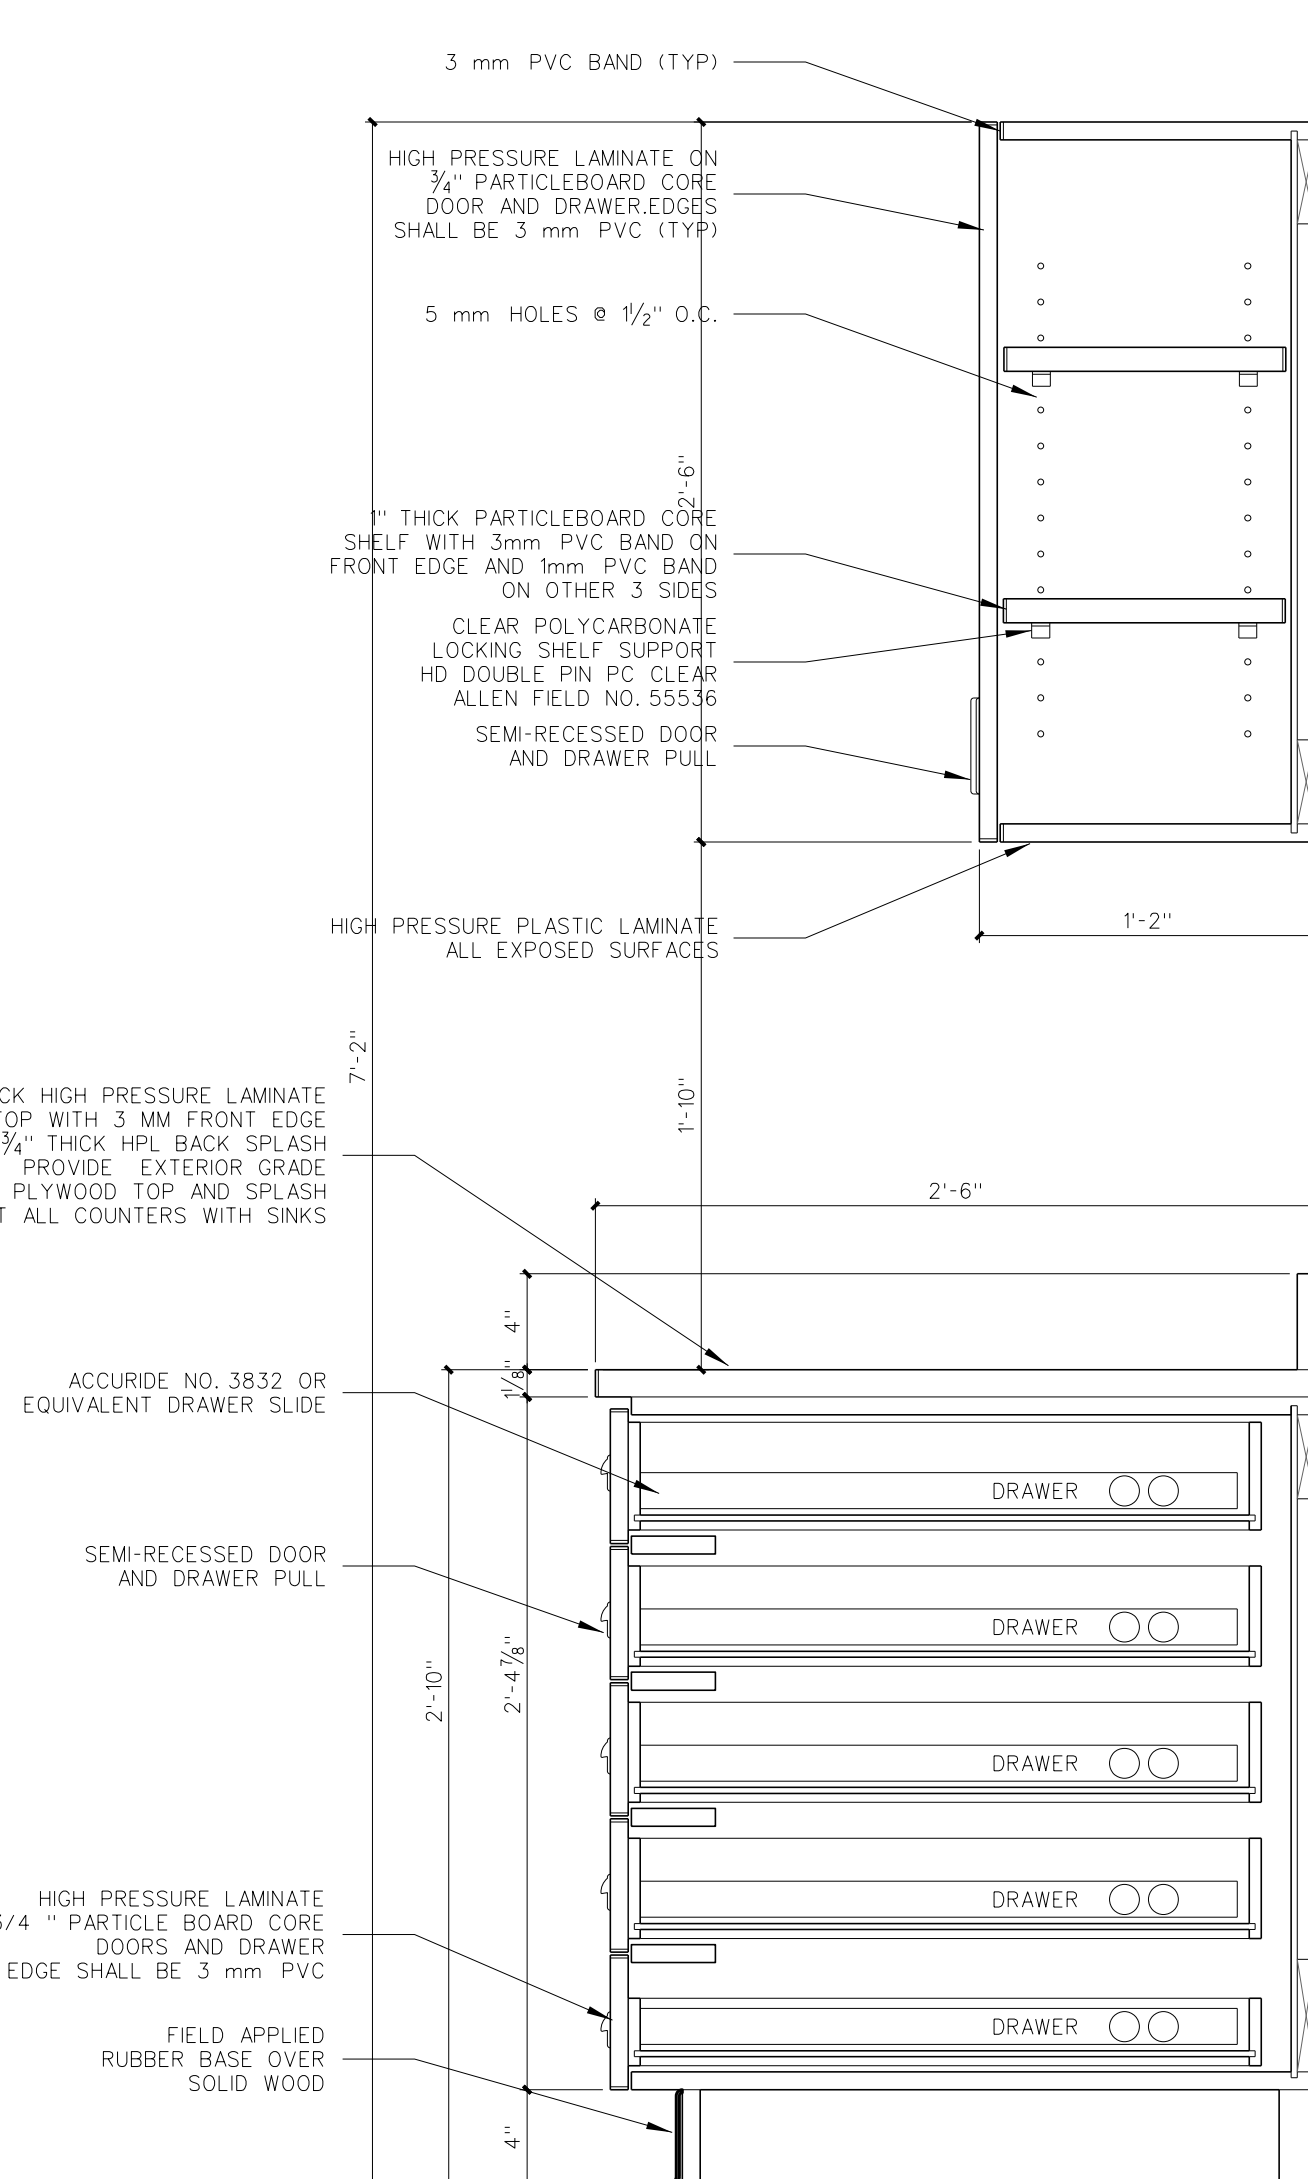


903.4 34" BASE CABINET
NOTE: 30" DEEP
SCALE: 1 1/2" = 1'-0"

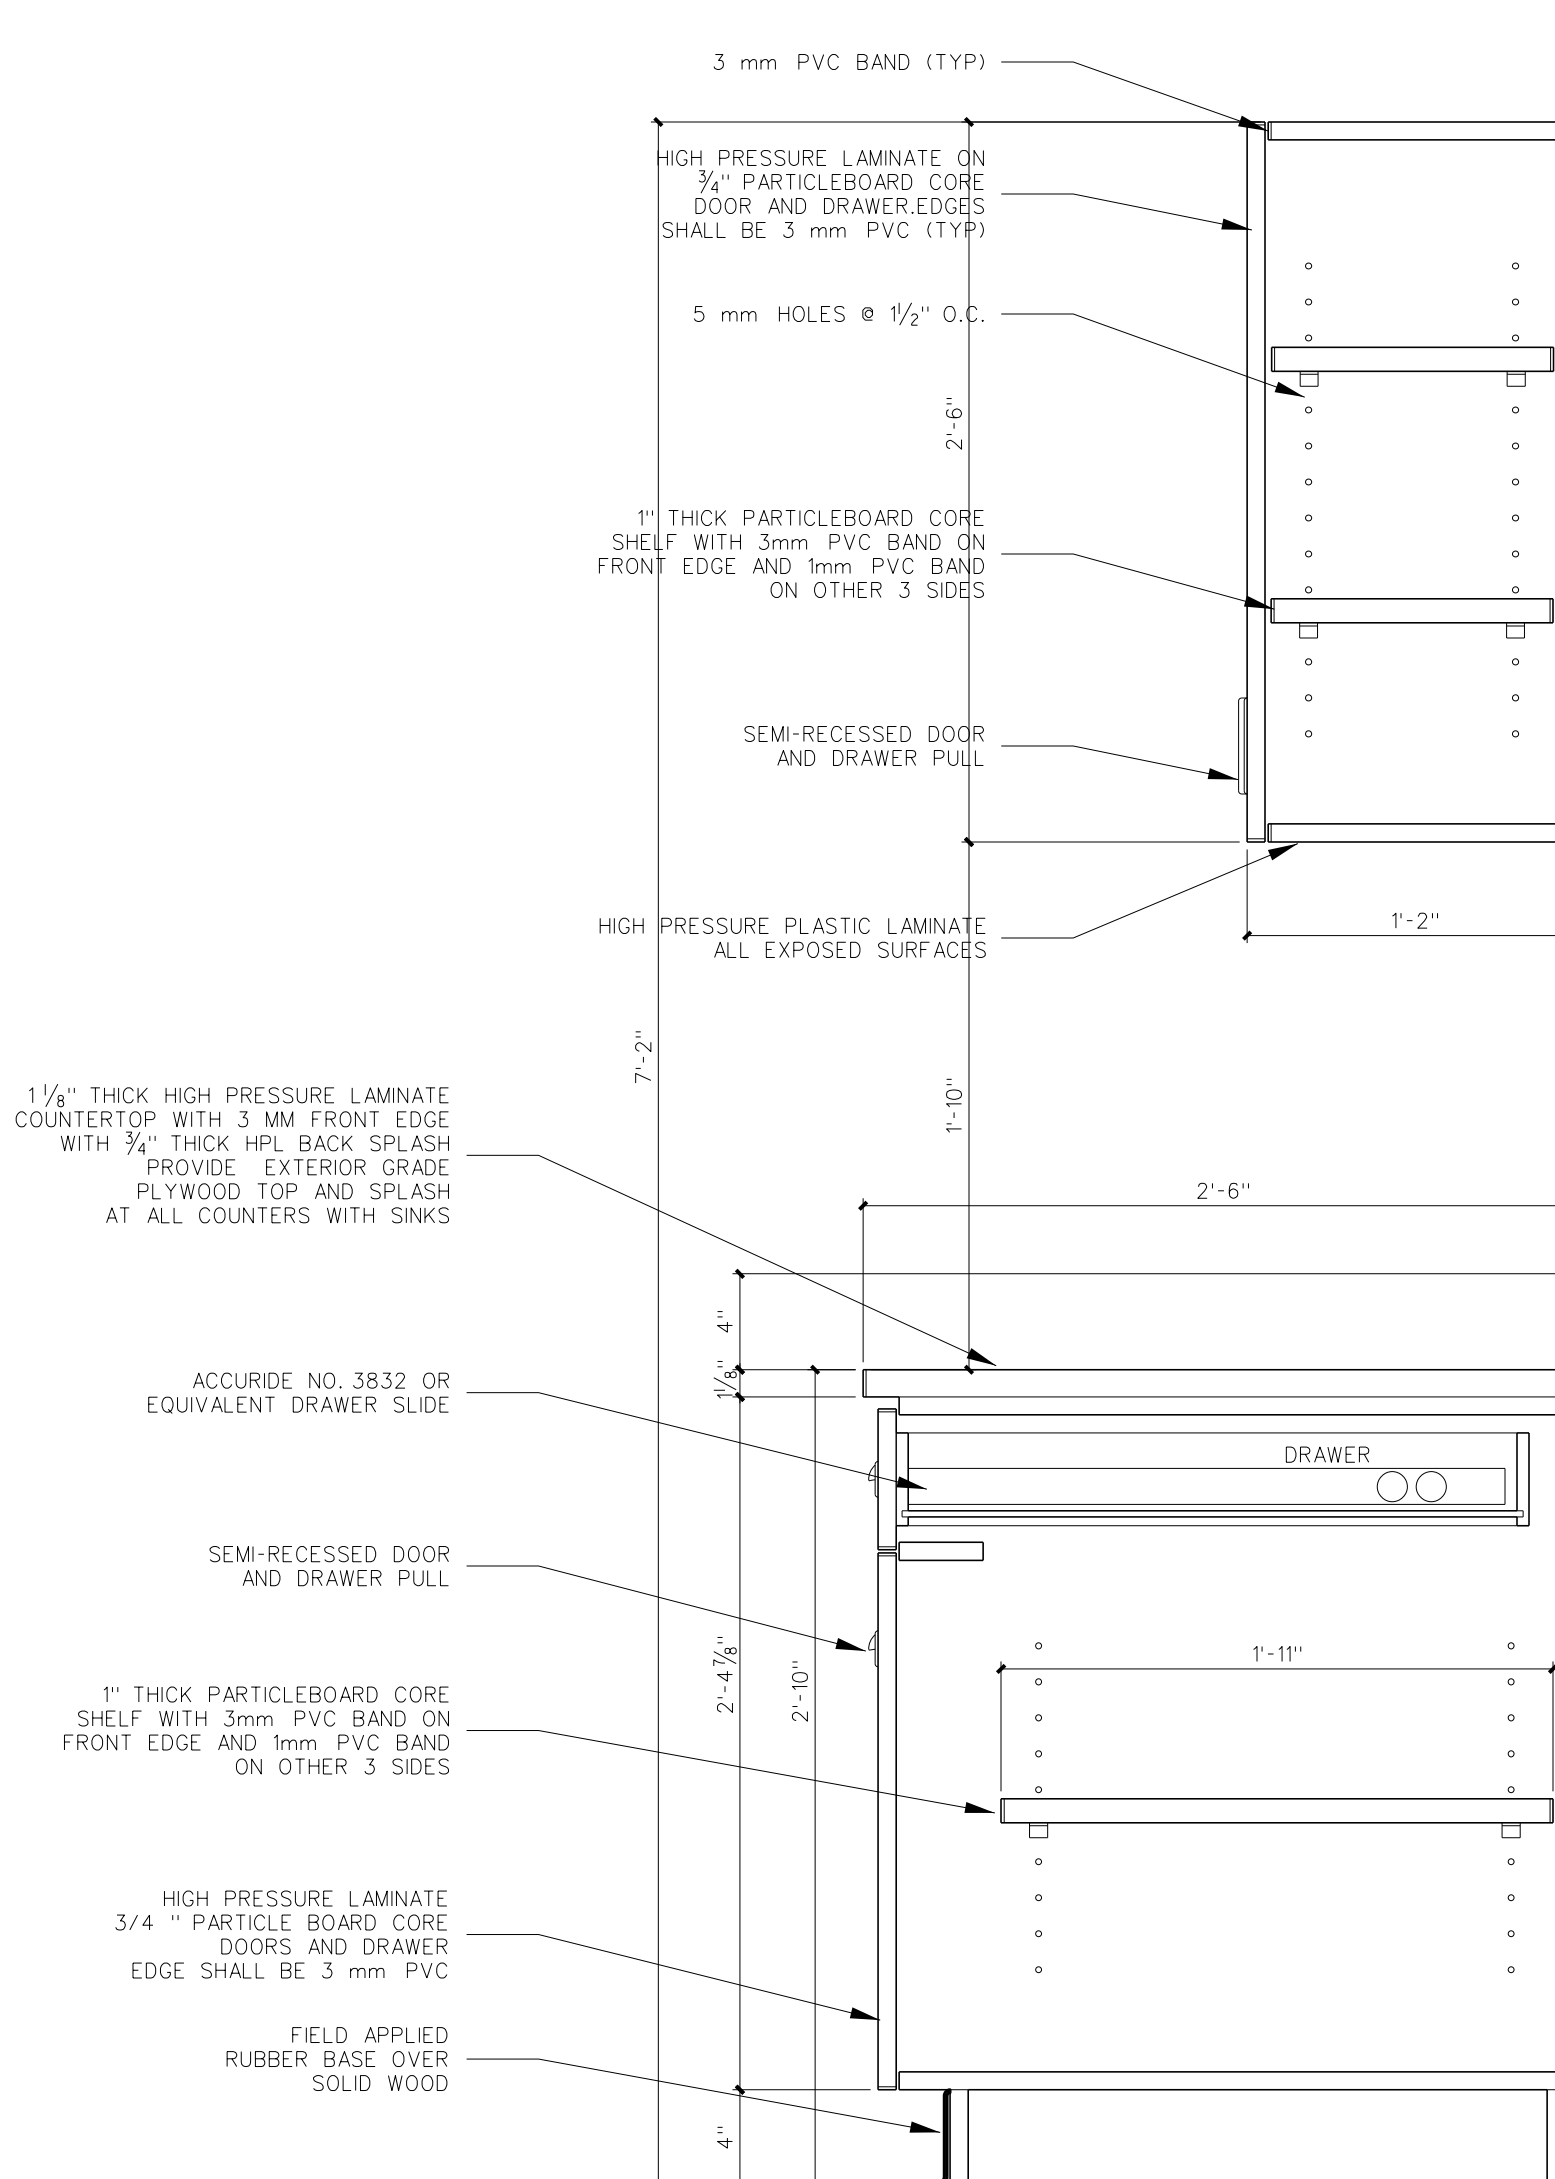

903.3 34" BASE CABINET
30" DEEP
SCALE: 1 1/2" = 1'-0"

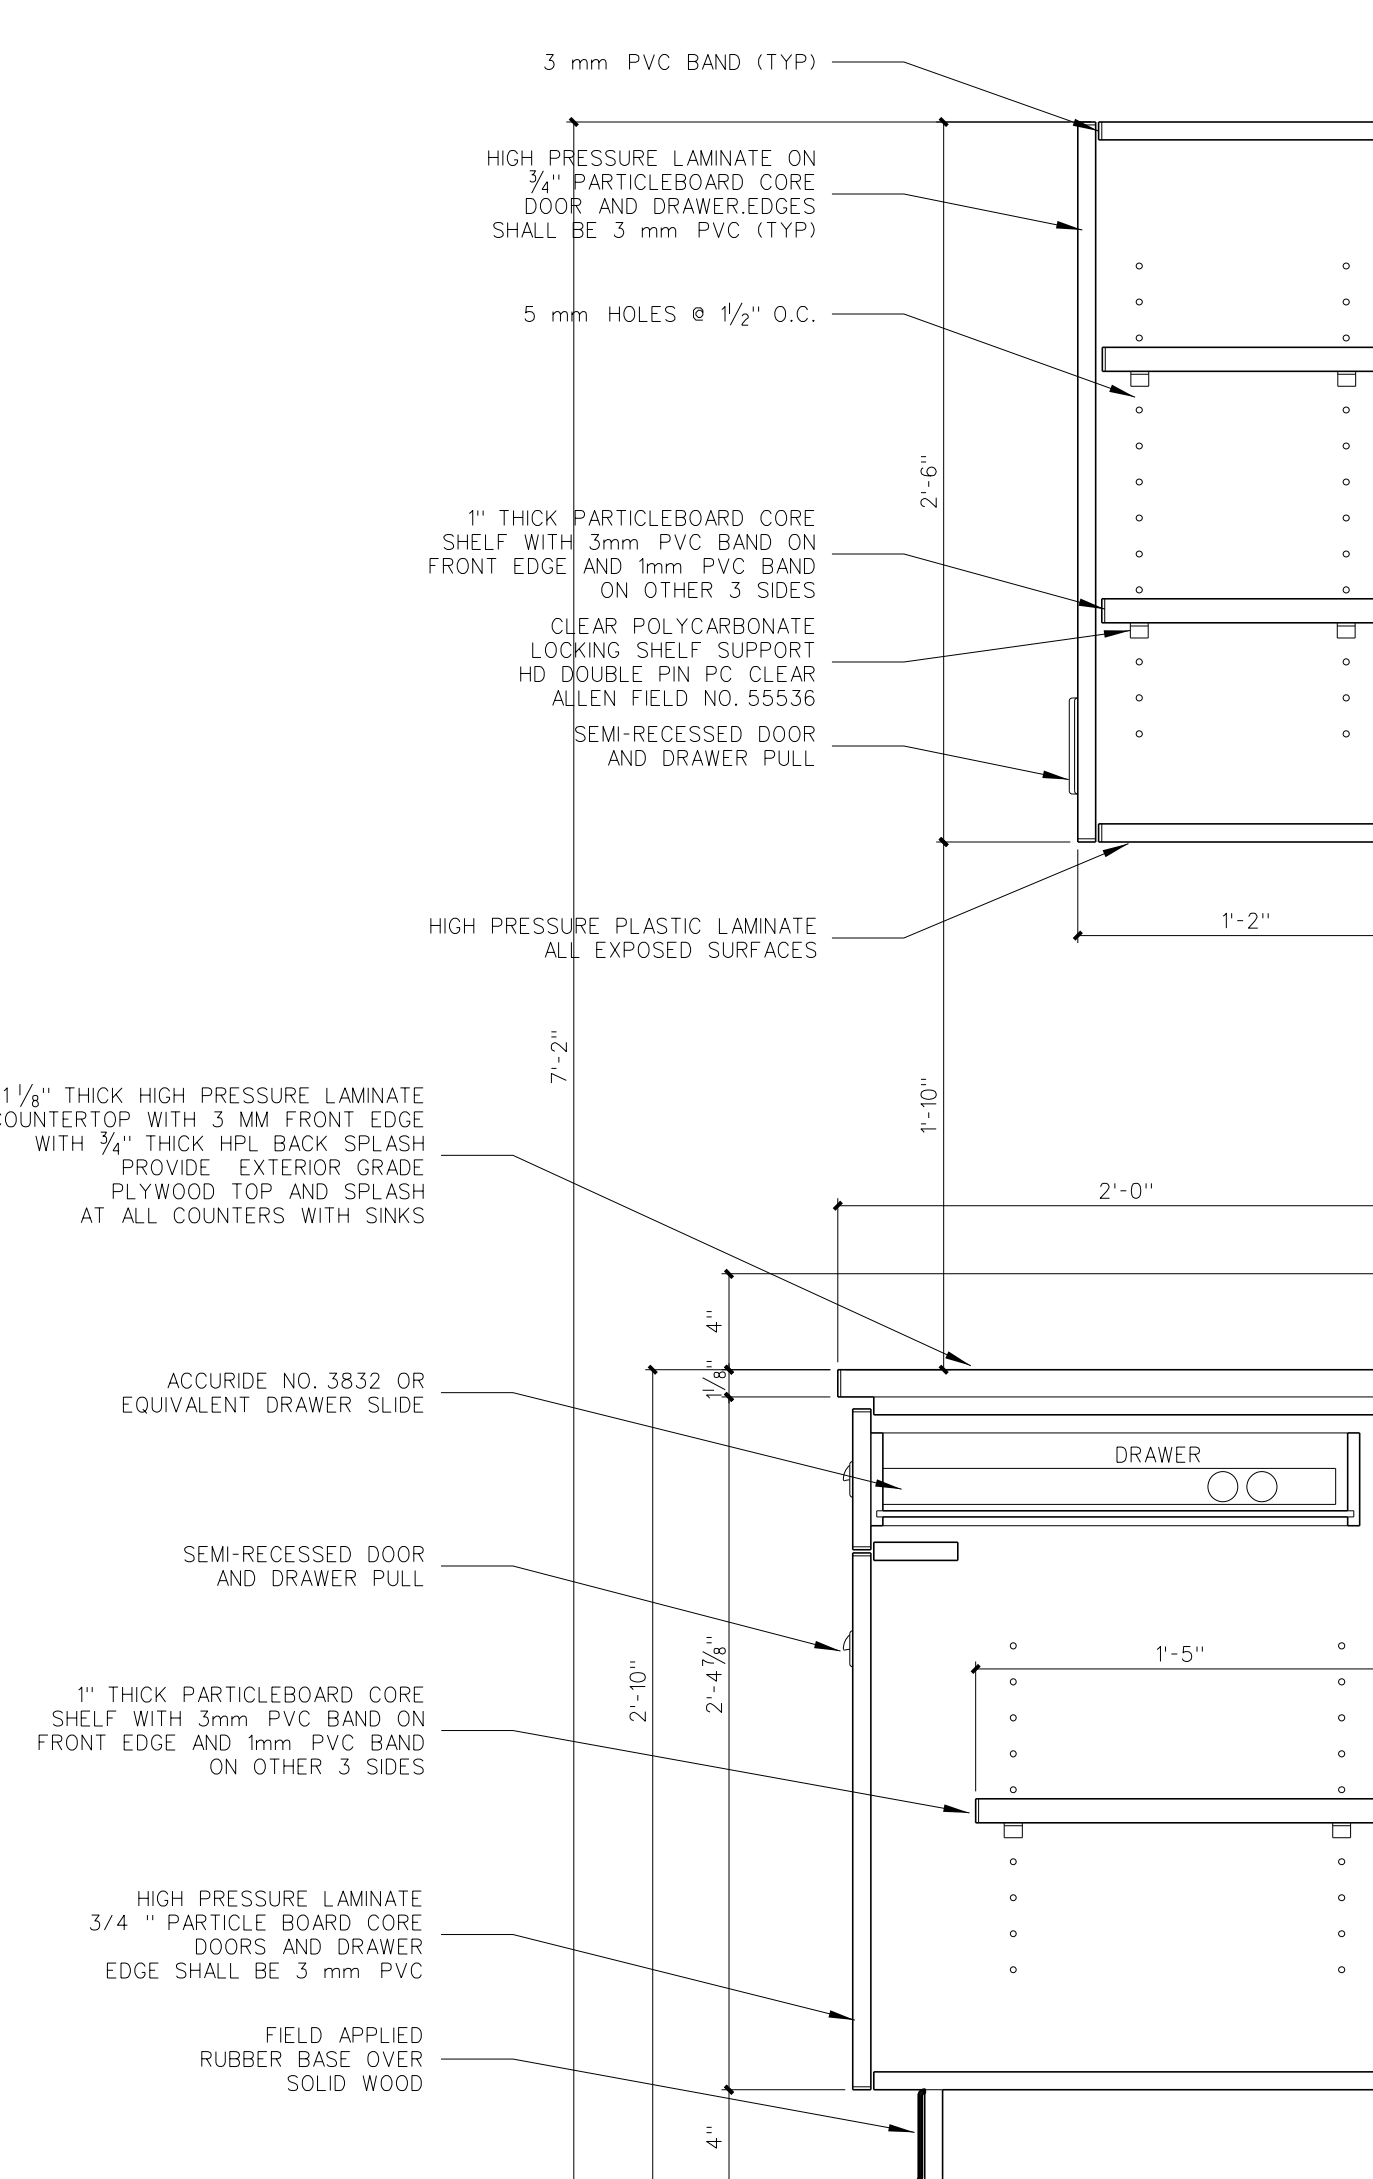


903.2 34" BASE CABINET
24" DEEP
SCALE: 1 1/2" = 1'-0"

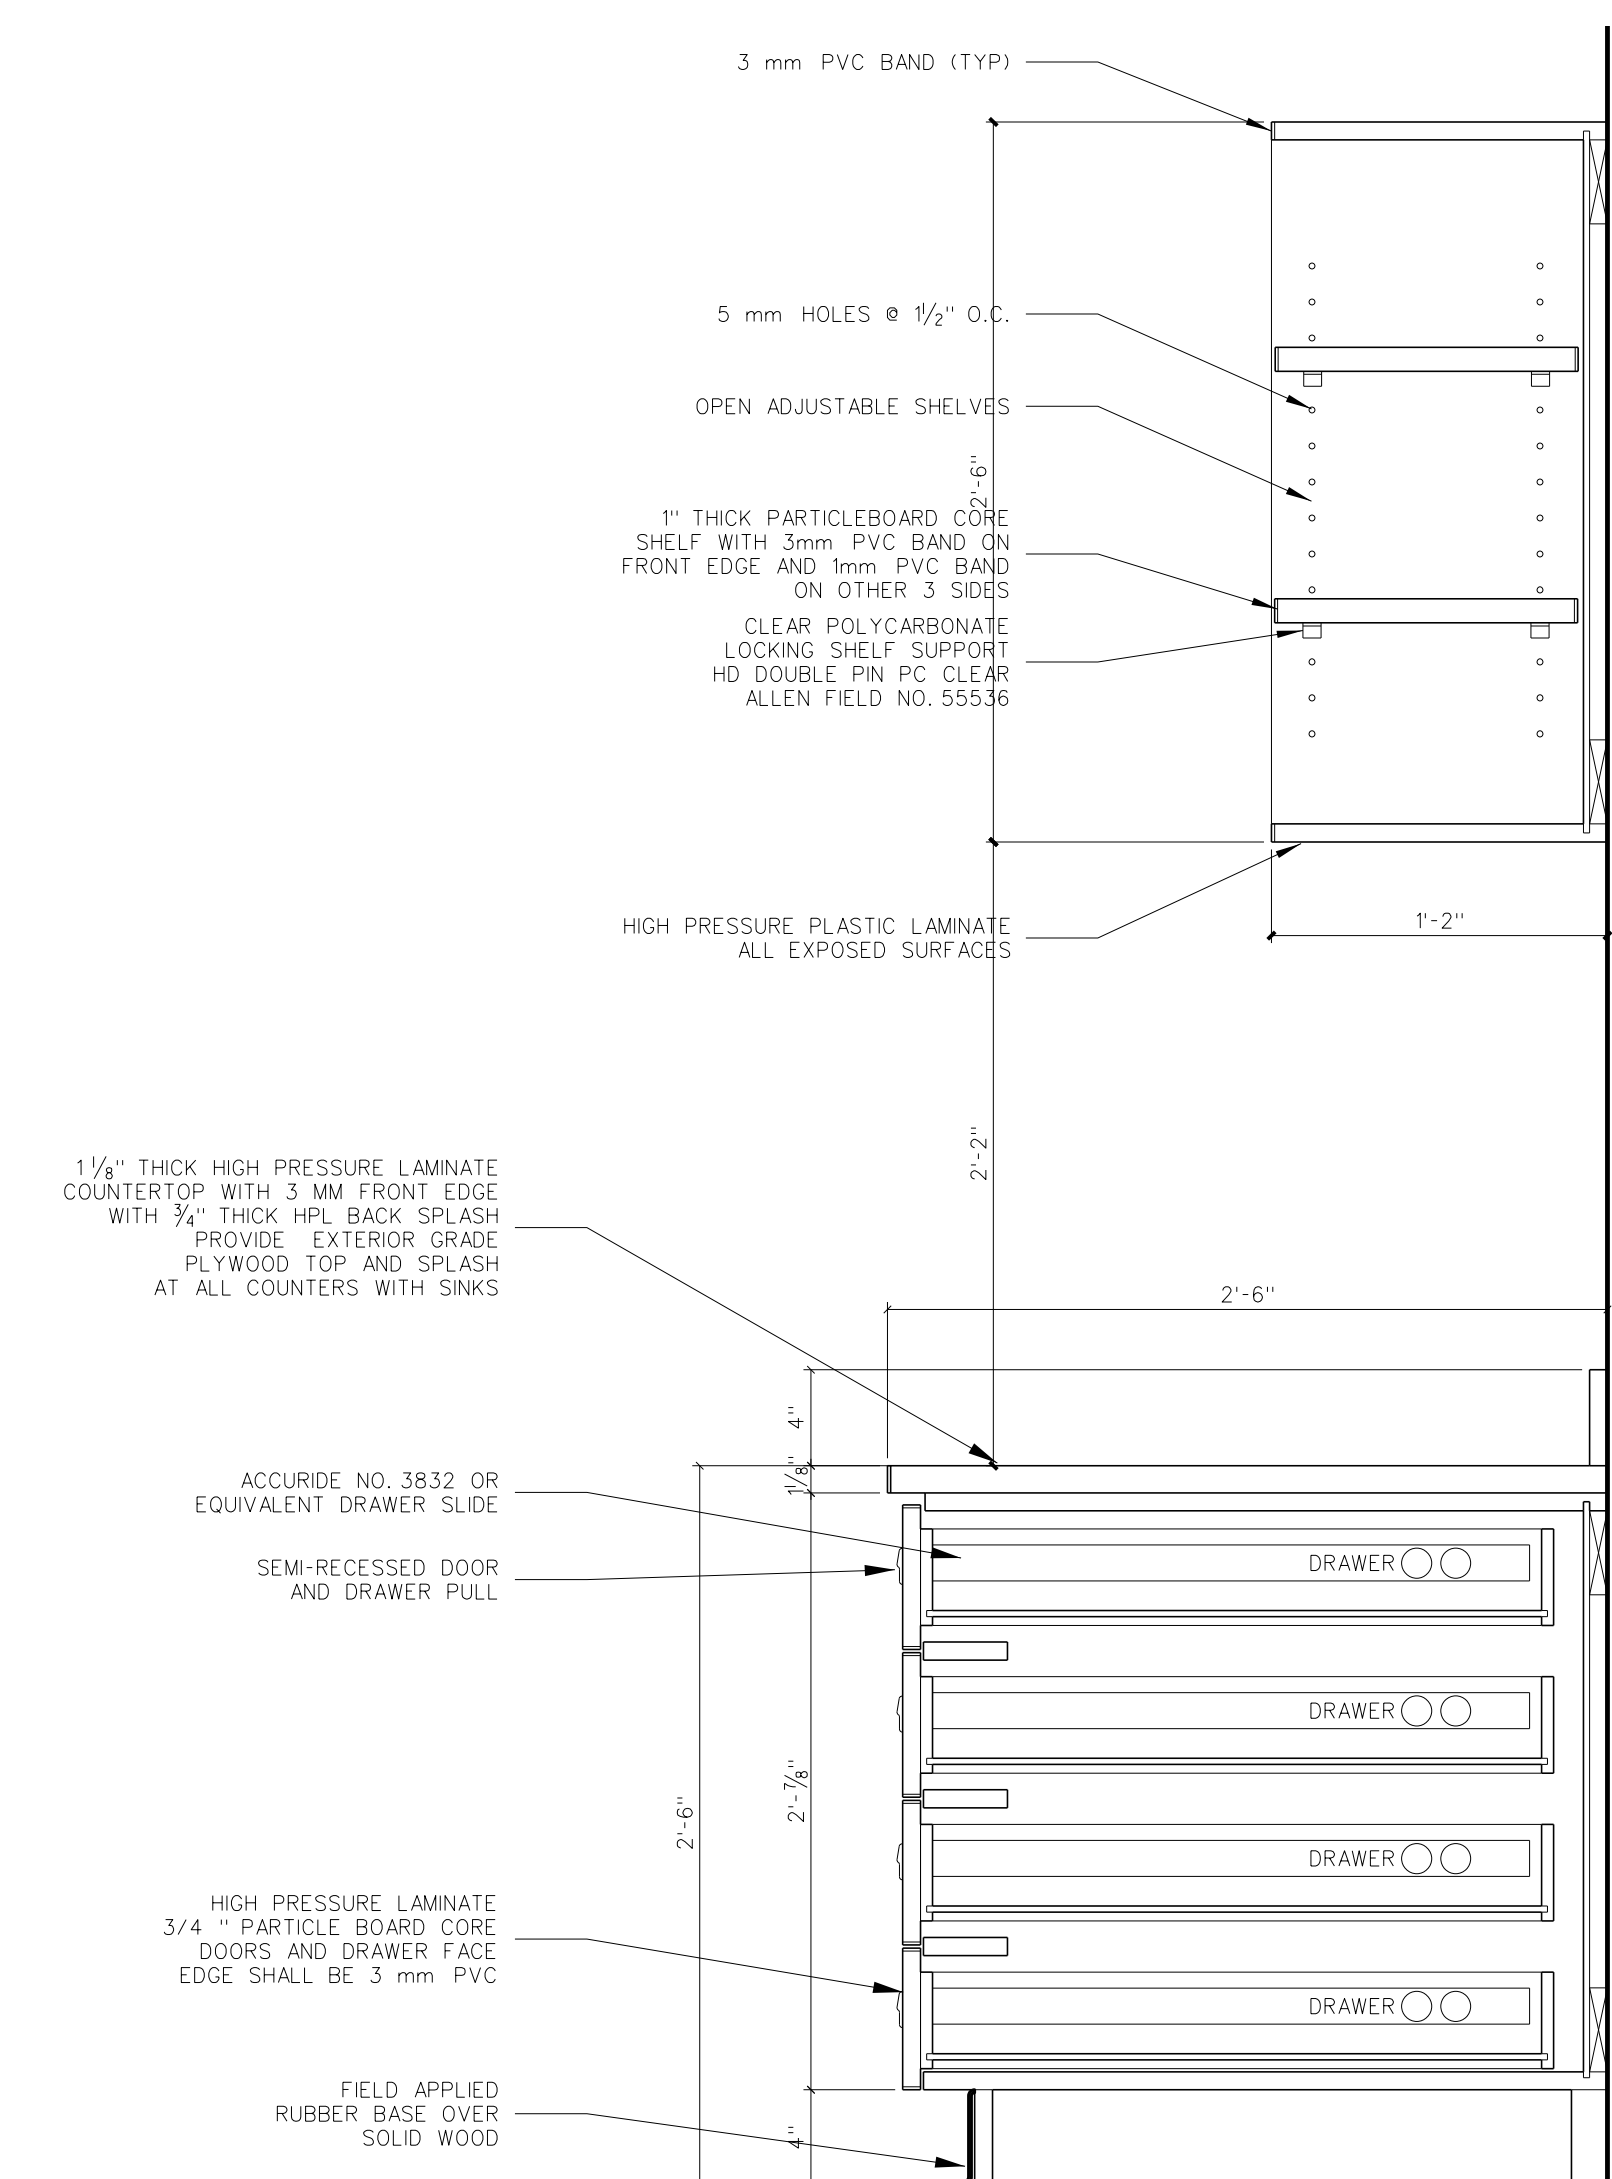

903.1 30" BASE CABINET
NOTE: 30" DEEP
SCALE: 1 1/2" = 1'-0"


No.	Date	Revision

Hite associates
ARCHITECTURE / PLANNING / TECHNOLOGY
2600 Meridian Drive / Greenville, NC 27834 / tel (252) 757-0333

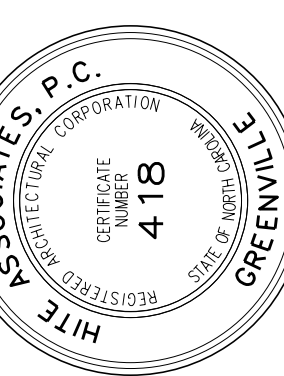


Beaufort PK-3 School
BEAUFORT COUNTY SCHOOLS
Washington / North Carolina / 27889

Project No: 22344
Date: 1 July 2024
Drawing No: **A 903**

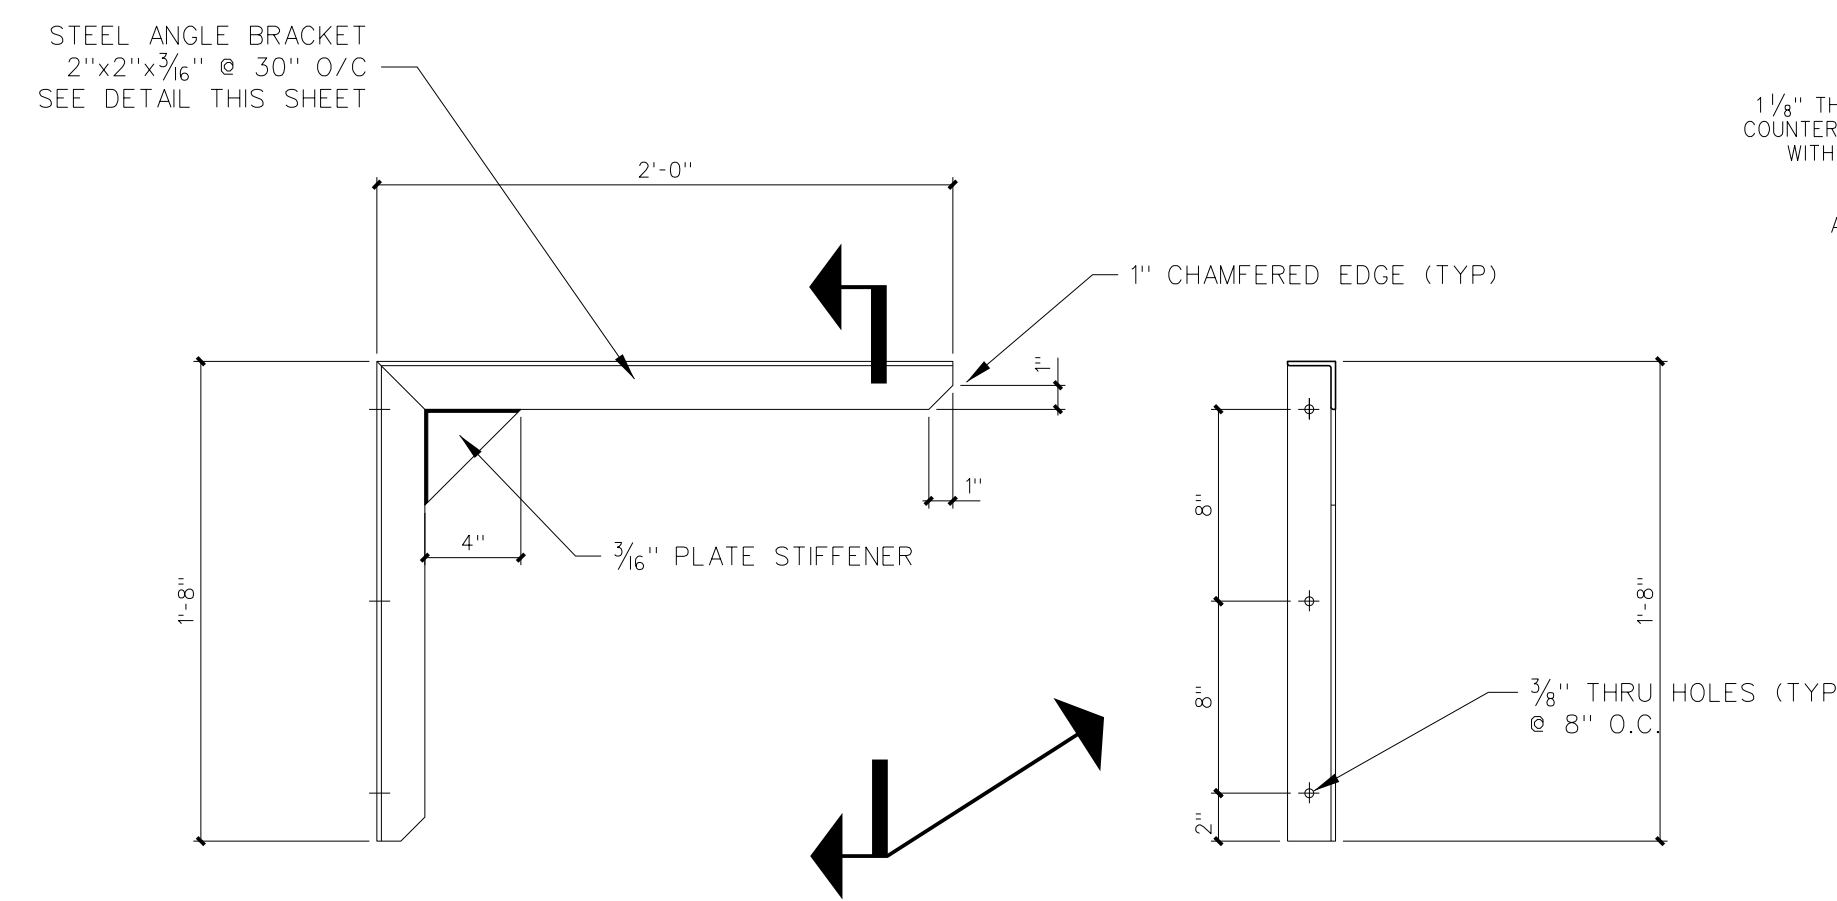


24"x20" STEEL ANGLE SHELF BRACKET

SCALE: 1 1/2" = 1'-0"

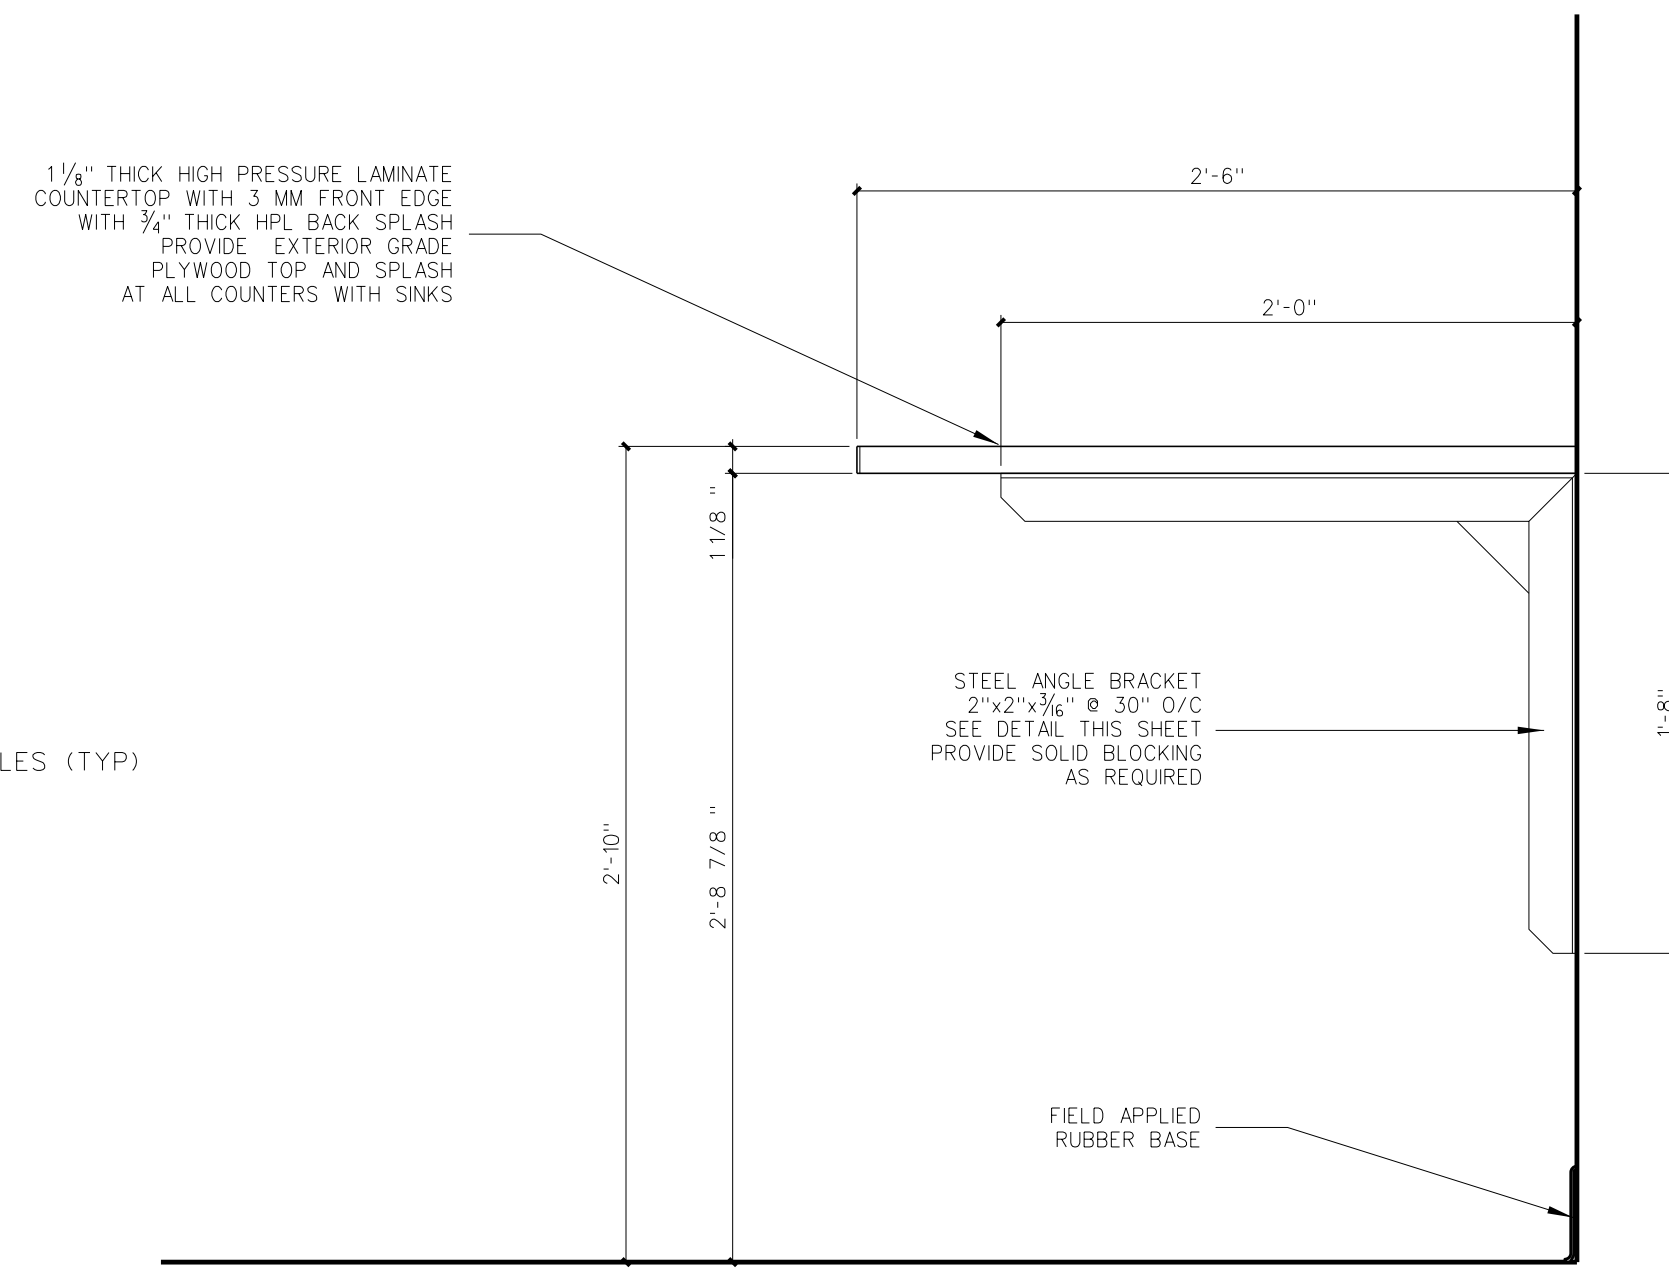


904.7 SECTION @ WORKROOM 123

30" DEEP
SCALE: 1 1/2" = 1'-0"

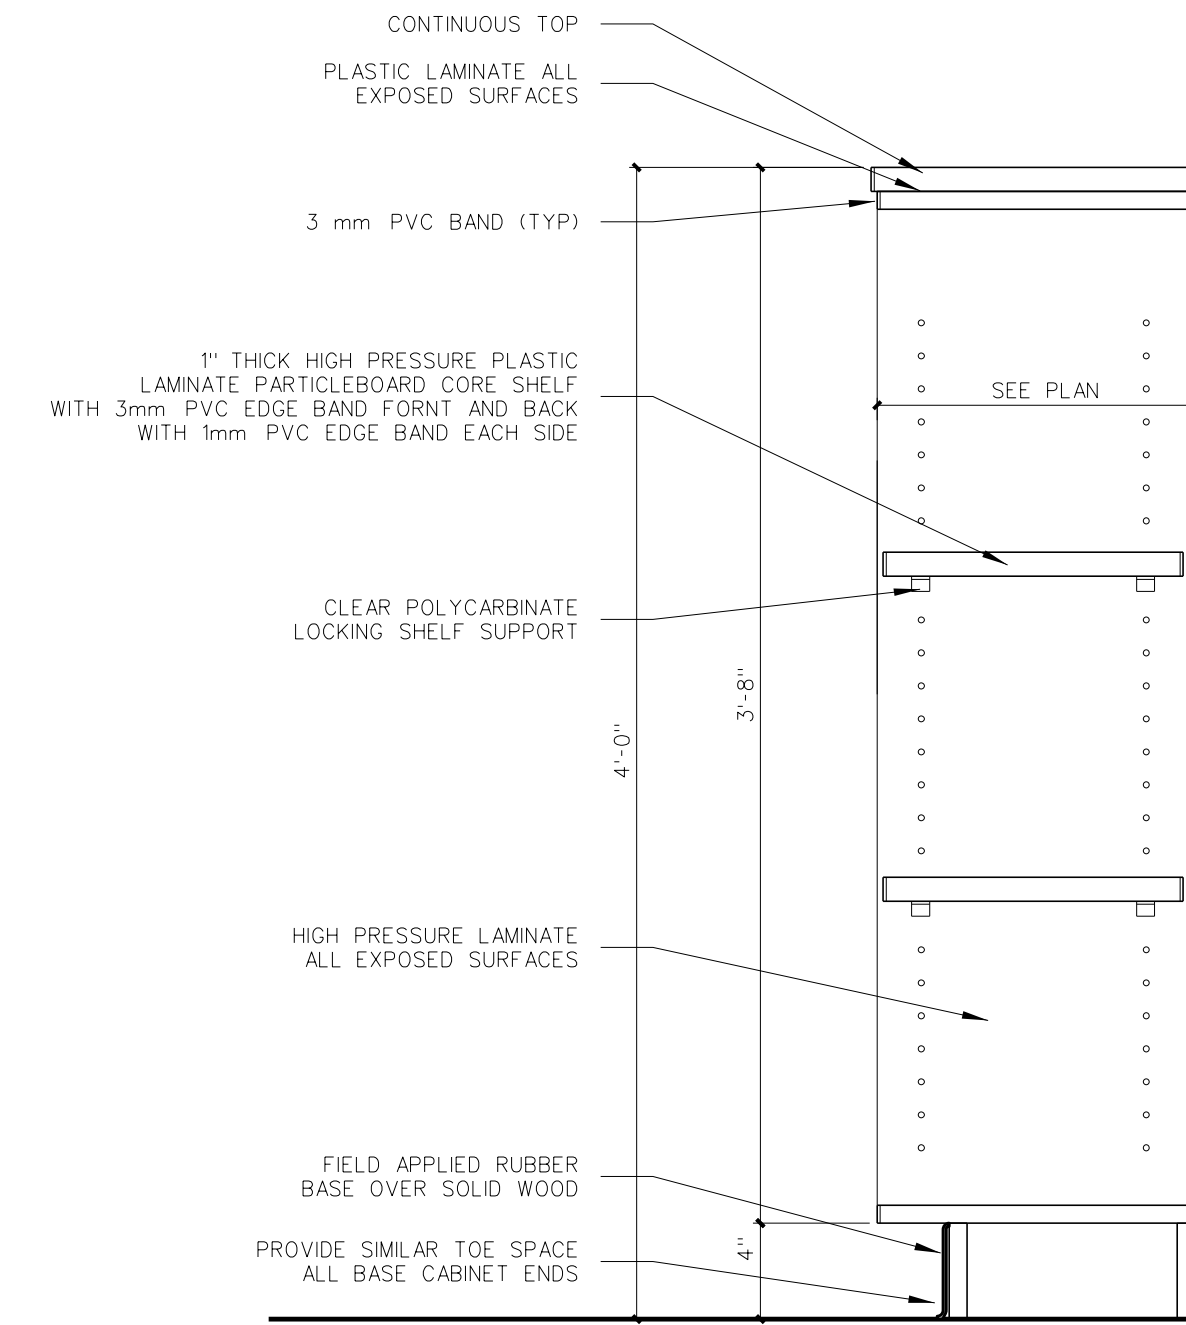


904.6 SECTION @ BOOKCASE

SCALE: 1 1/2" = 1'-0"

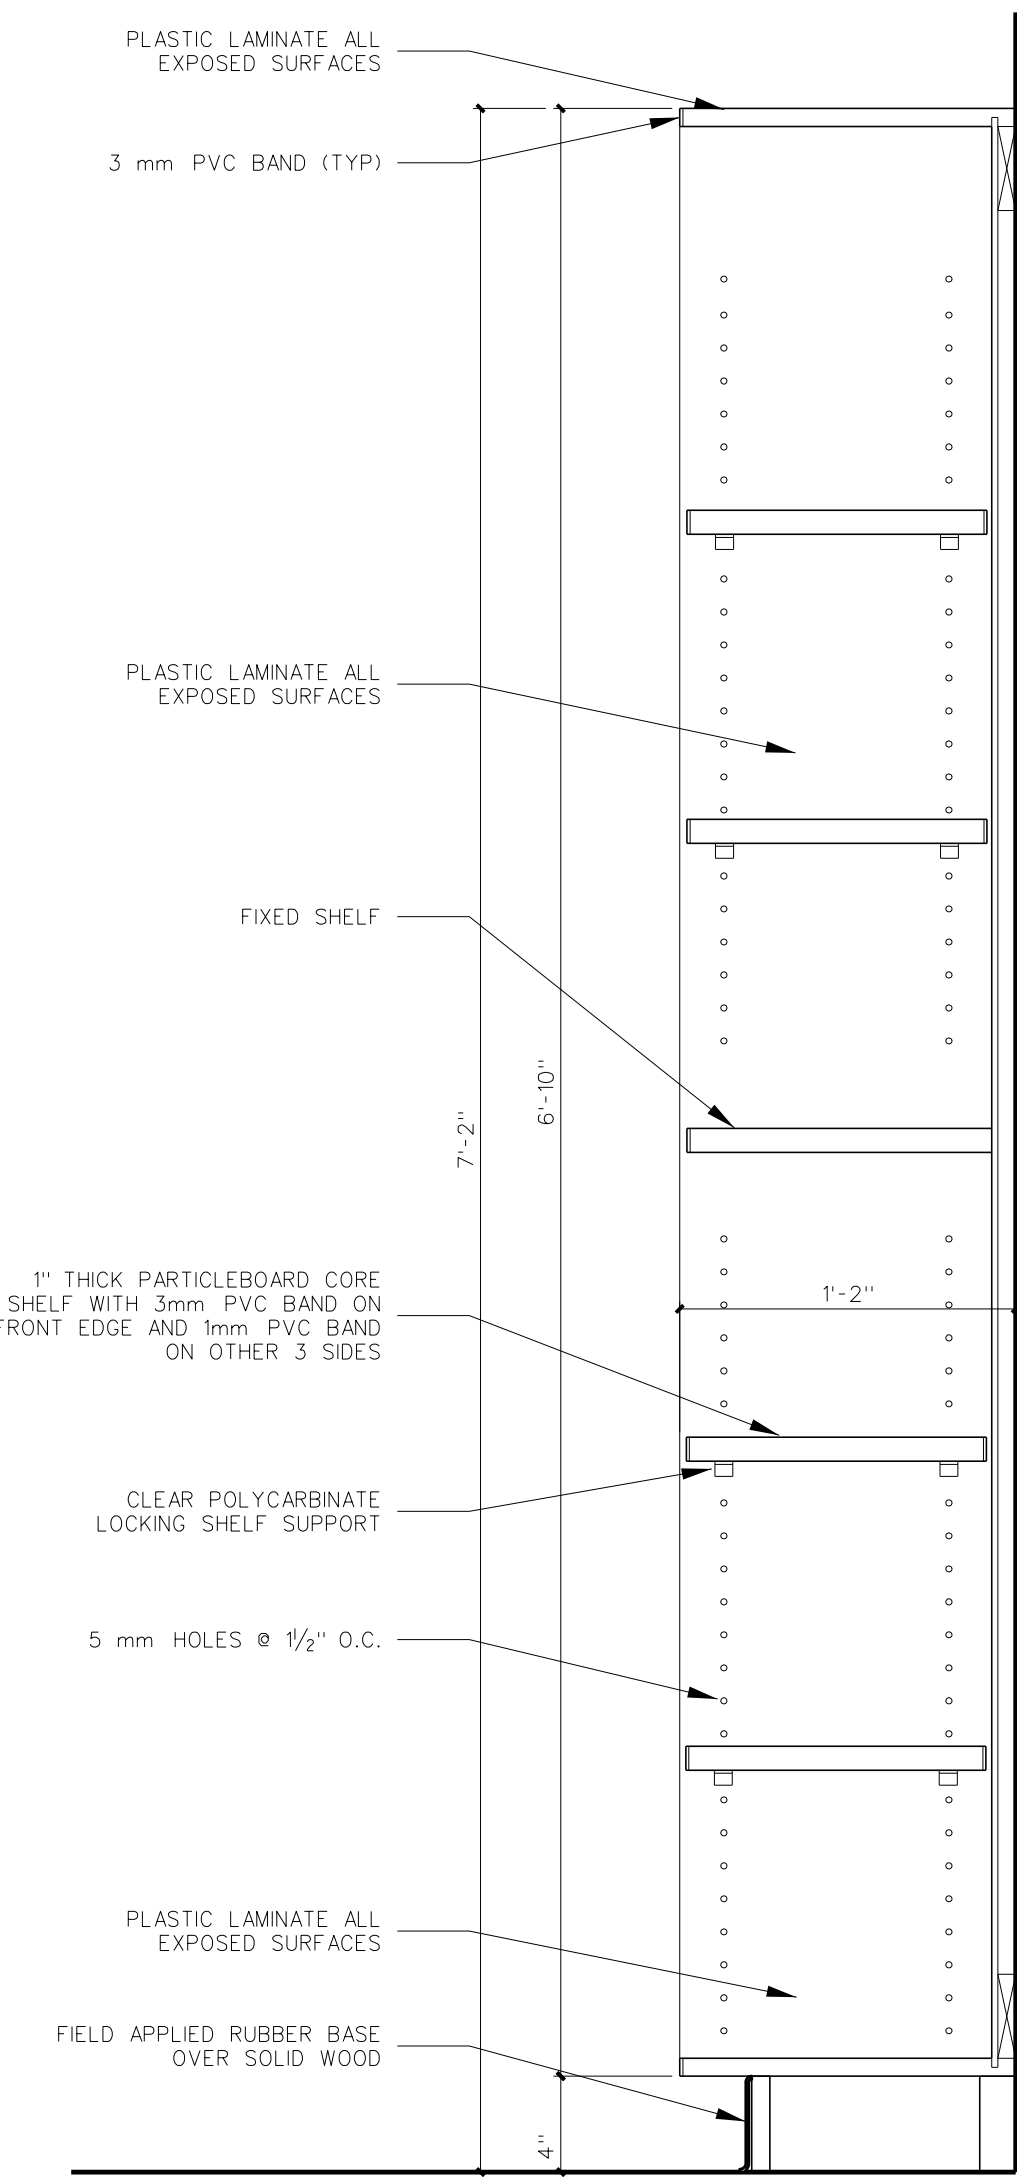


904.5 SECTION @ BOOKCASE

SCALE: 1 1/2" = 1'-0"

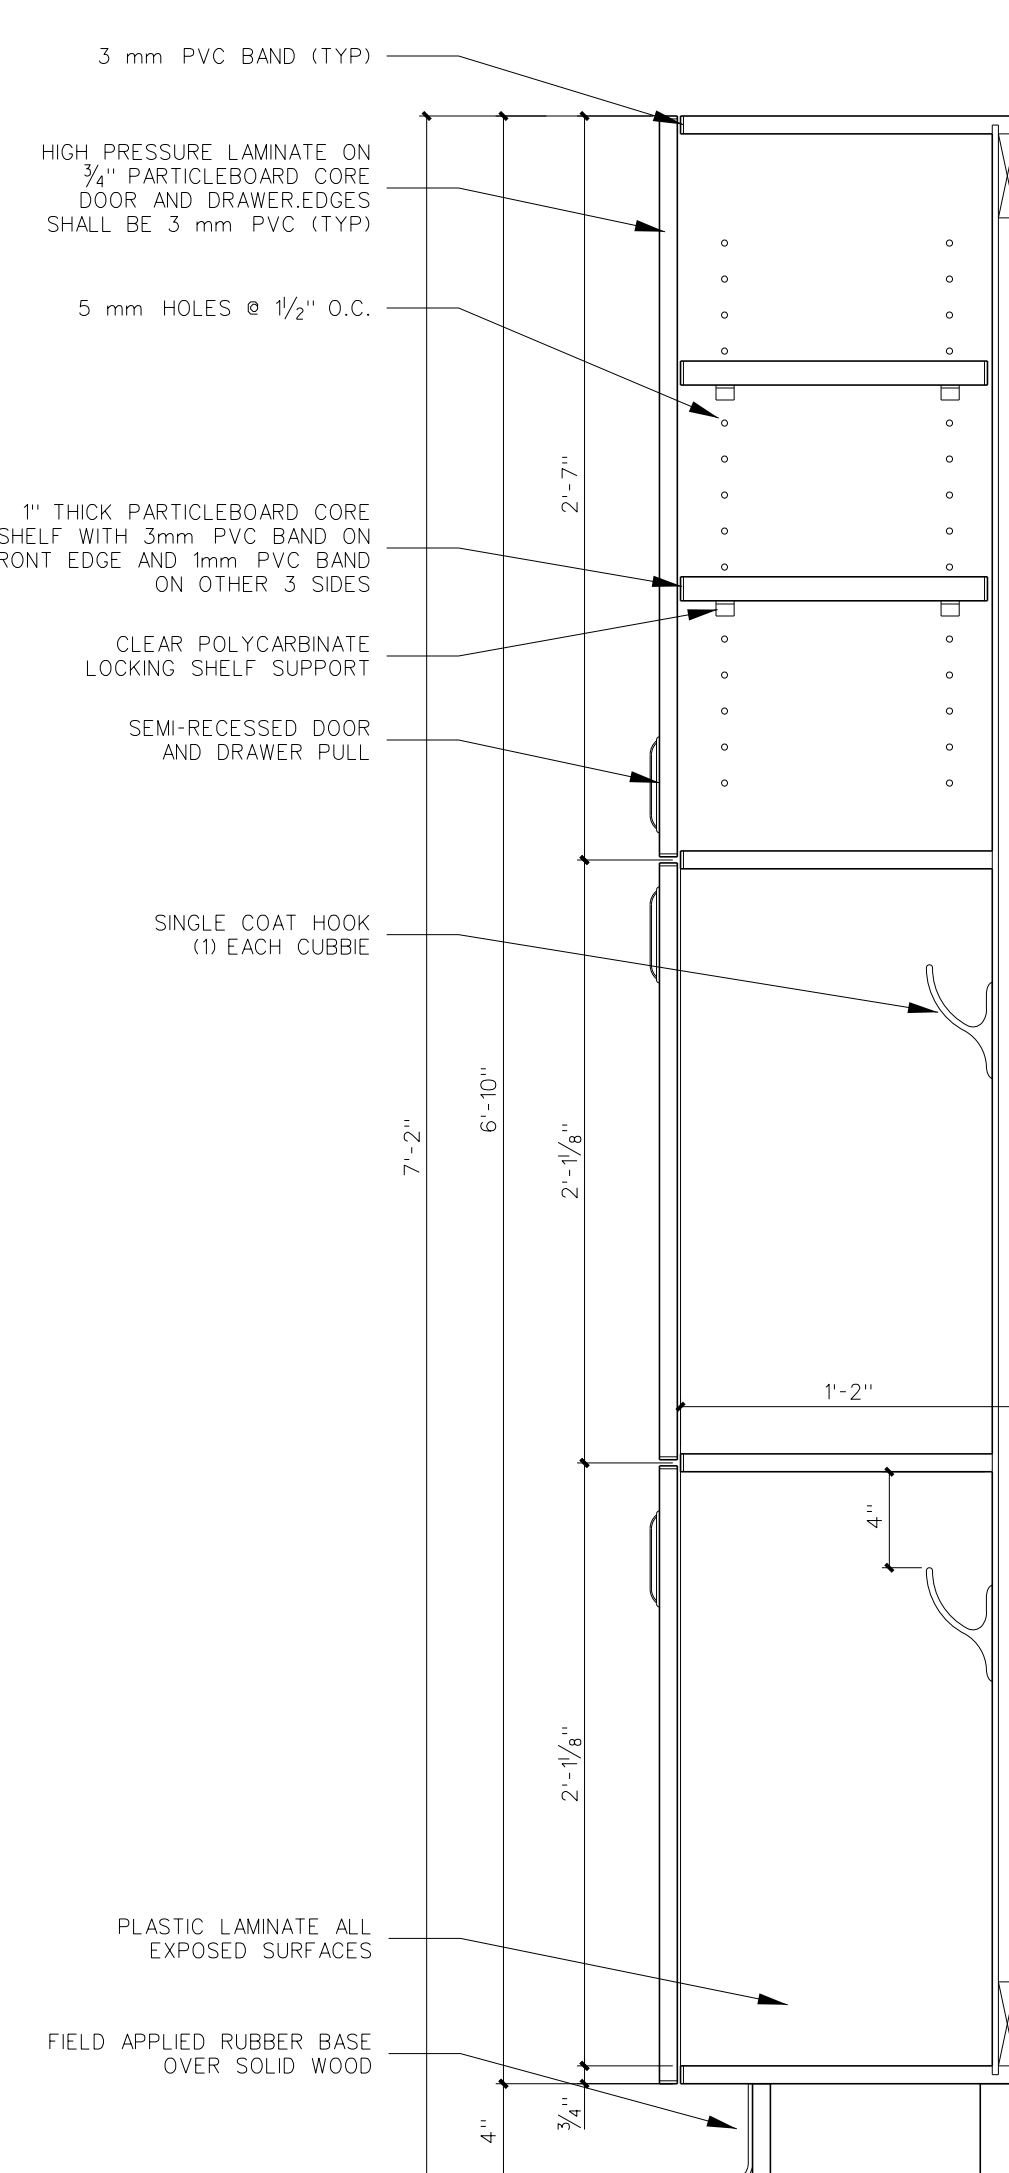


904.4 SECTION @ CUBBIES

SCALE: 1 1/2" = 1'-0"

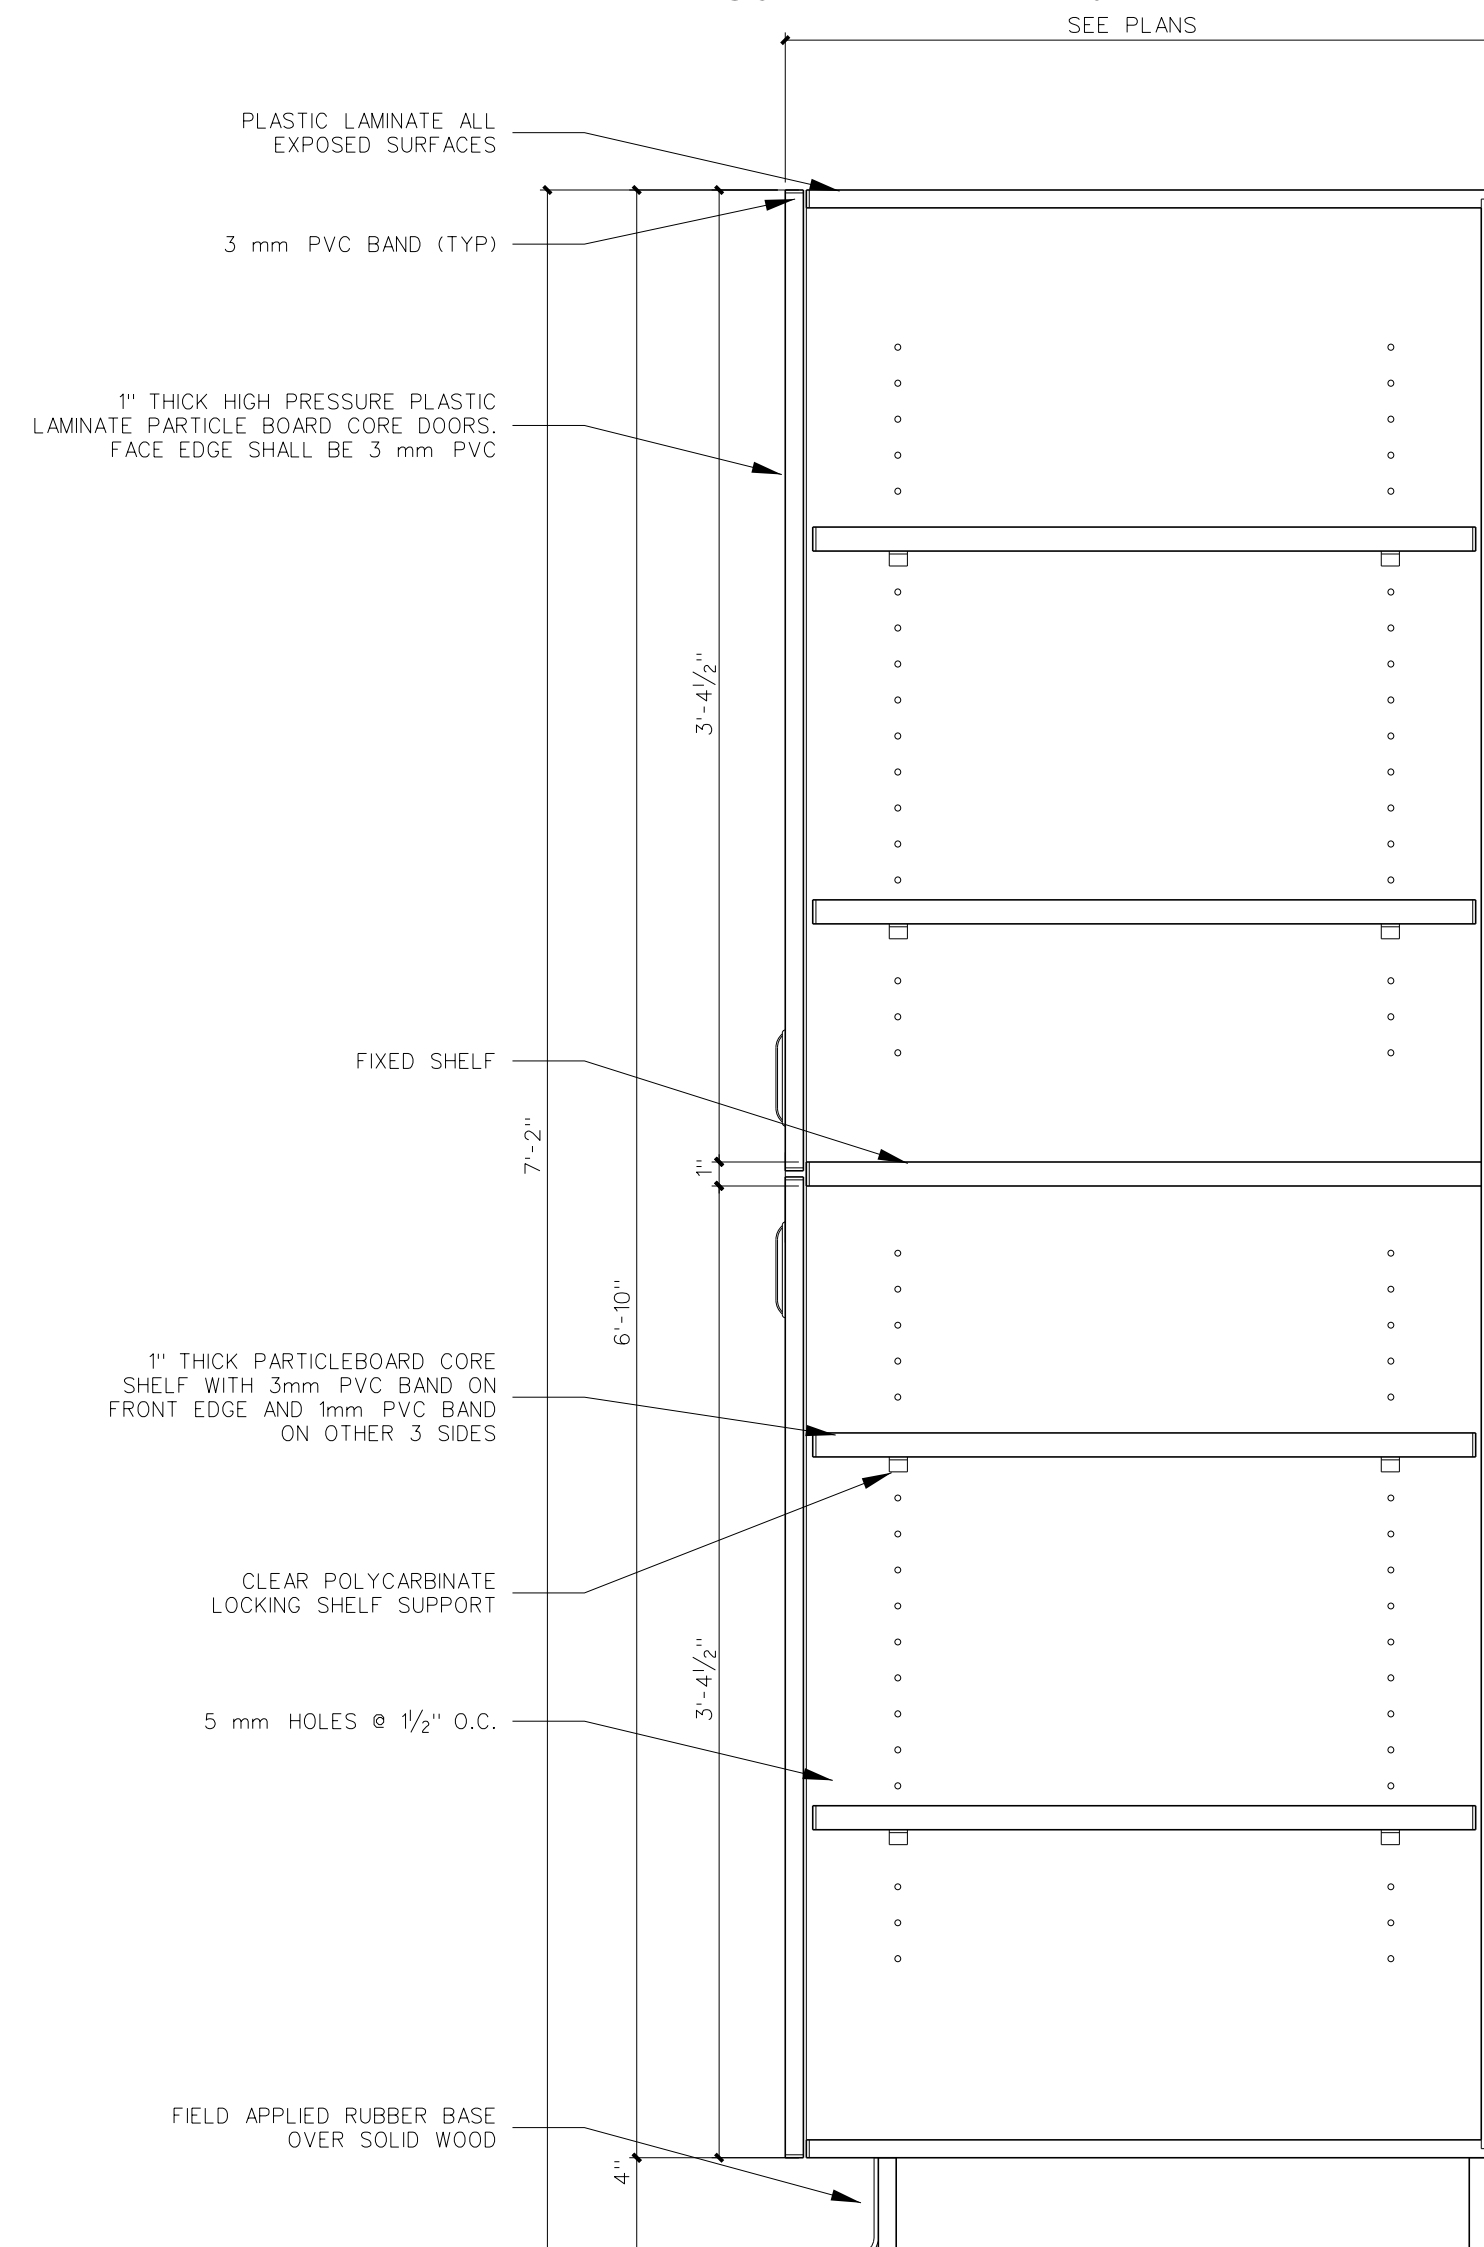


904.3 FULL HEIGHT WALL CABINET

SCALE: 1 1/2" = 1'-0"

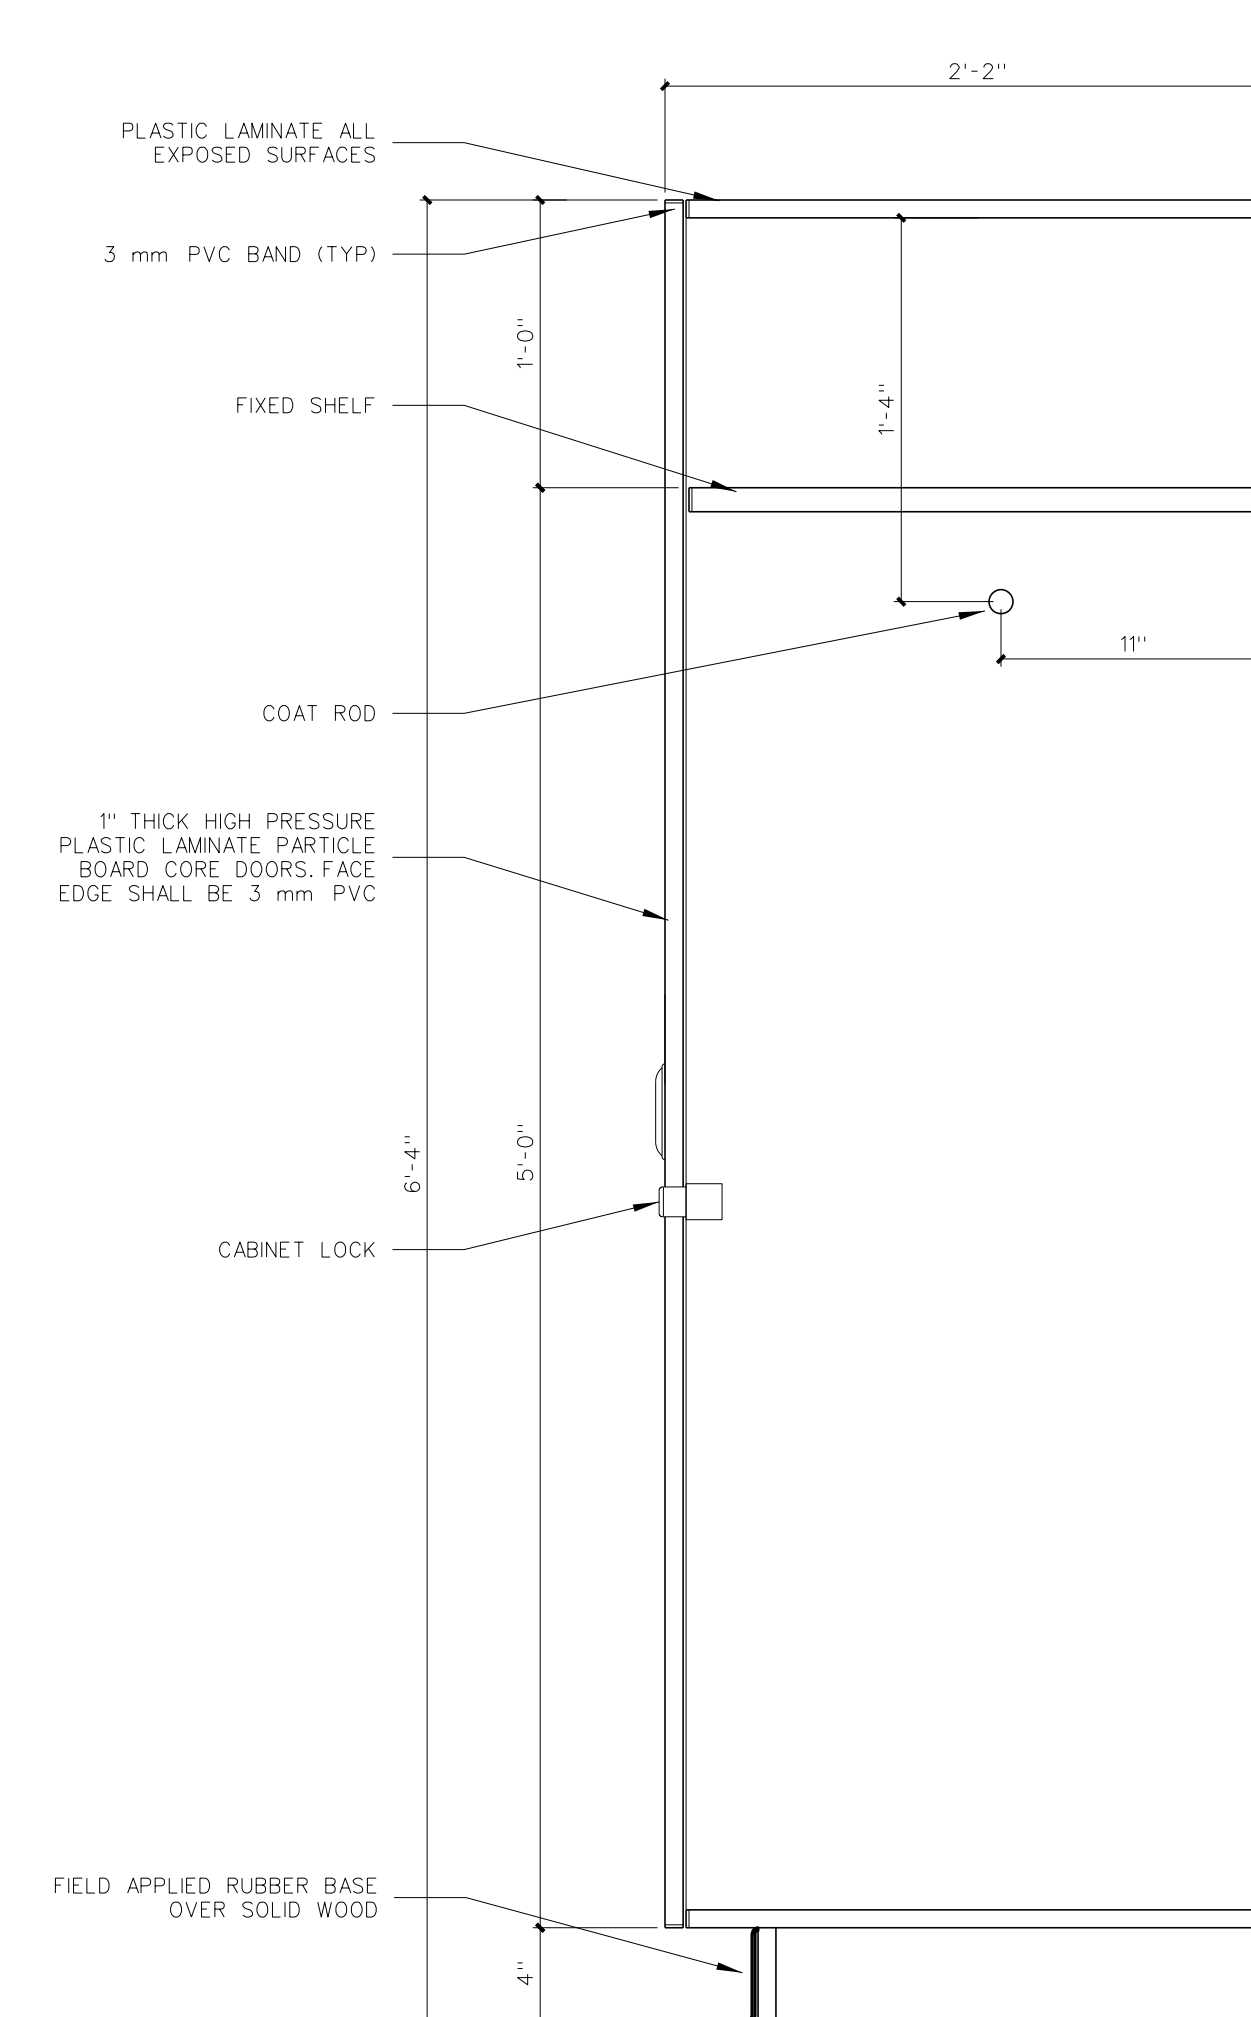

904.2 SECTION @ TEACHERS CABINET

SCALE: 1 1/2" = 1'-0"

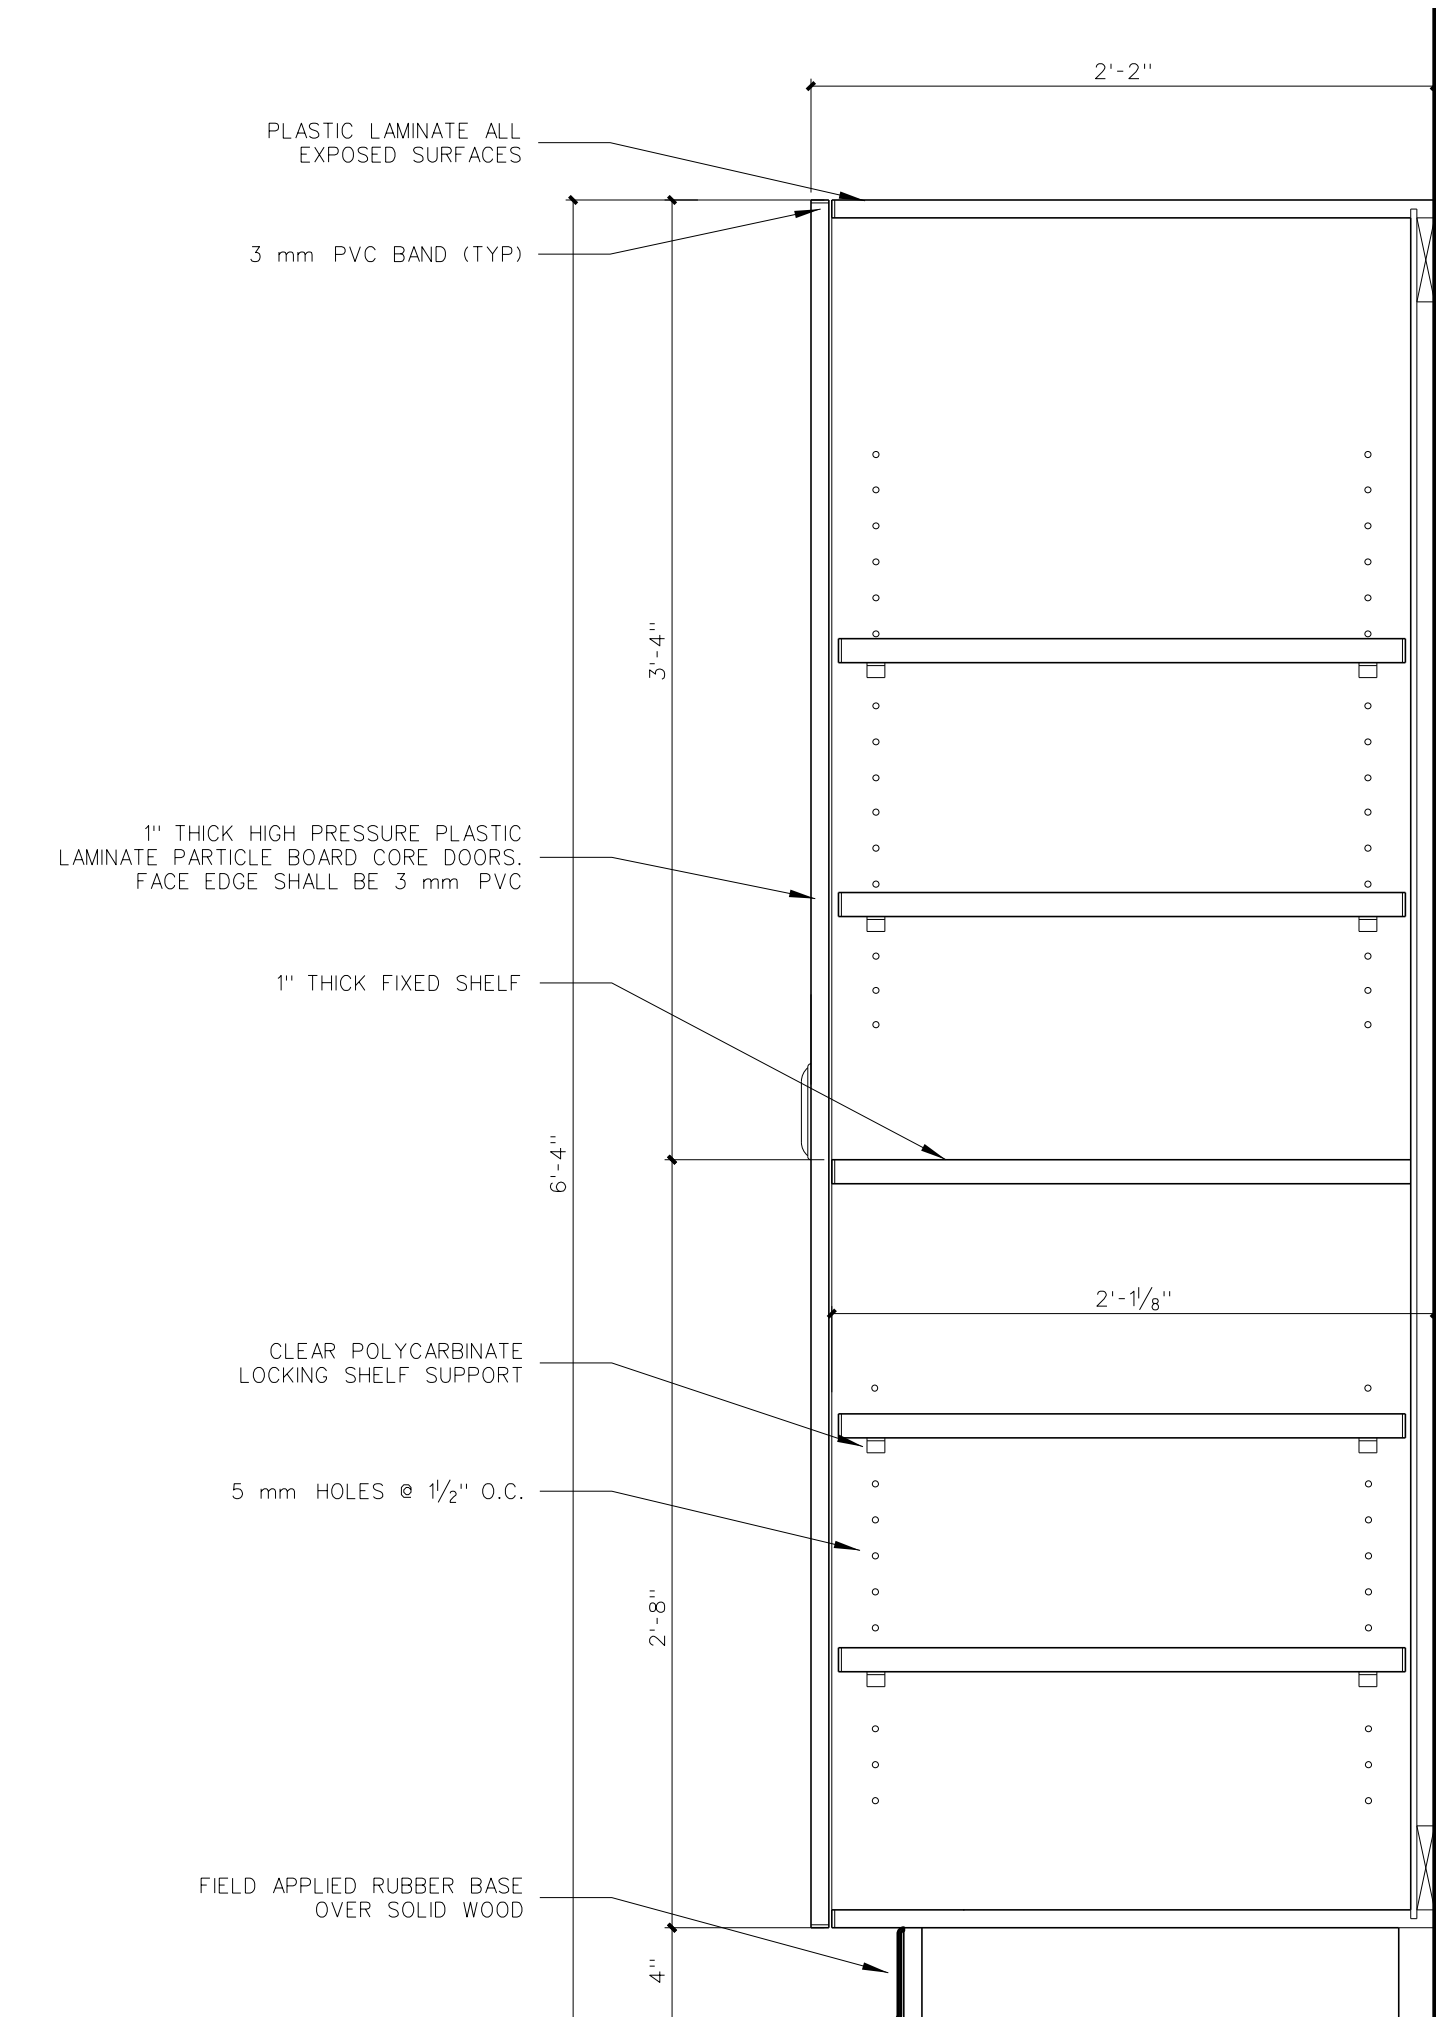


904.1 SECTION @ TEACHERS CABINET

SCALE: 1 1/2" = 1'-0"

No.	Date	Revision

Hite associates
ARCHITECTURE / PLANNING / TECHNOLOGY
2600 Meridian Drive / Greenville, NC 27834 / tel (252) 757-0333

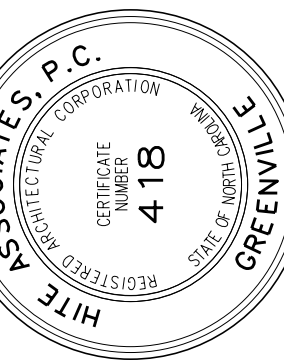


Beaufort PK-3 School
BEAUFORT COUNTY SCHOOLS
Washington / North Carolina / 27889

Project No. 22344

Date: 1 July 2024

Drawing no.

A
904

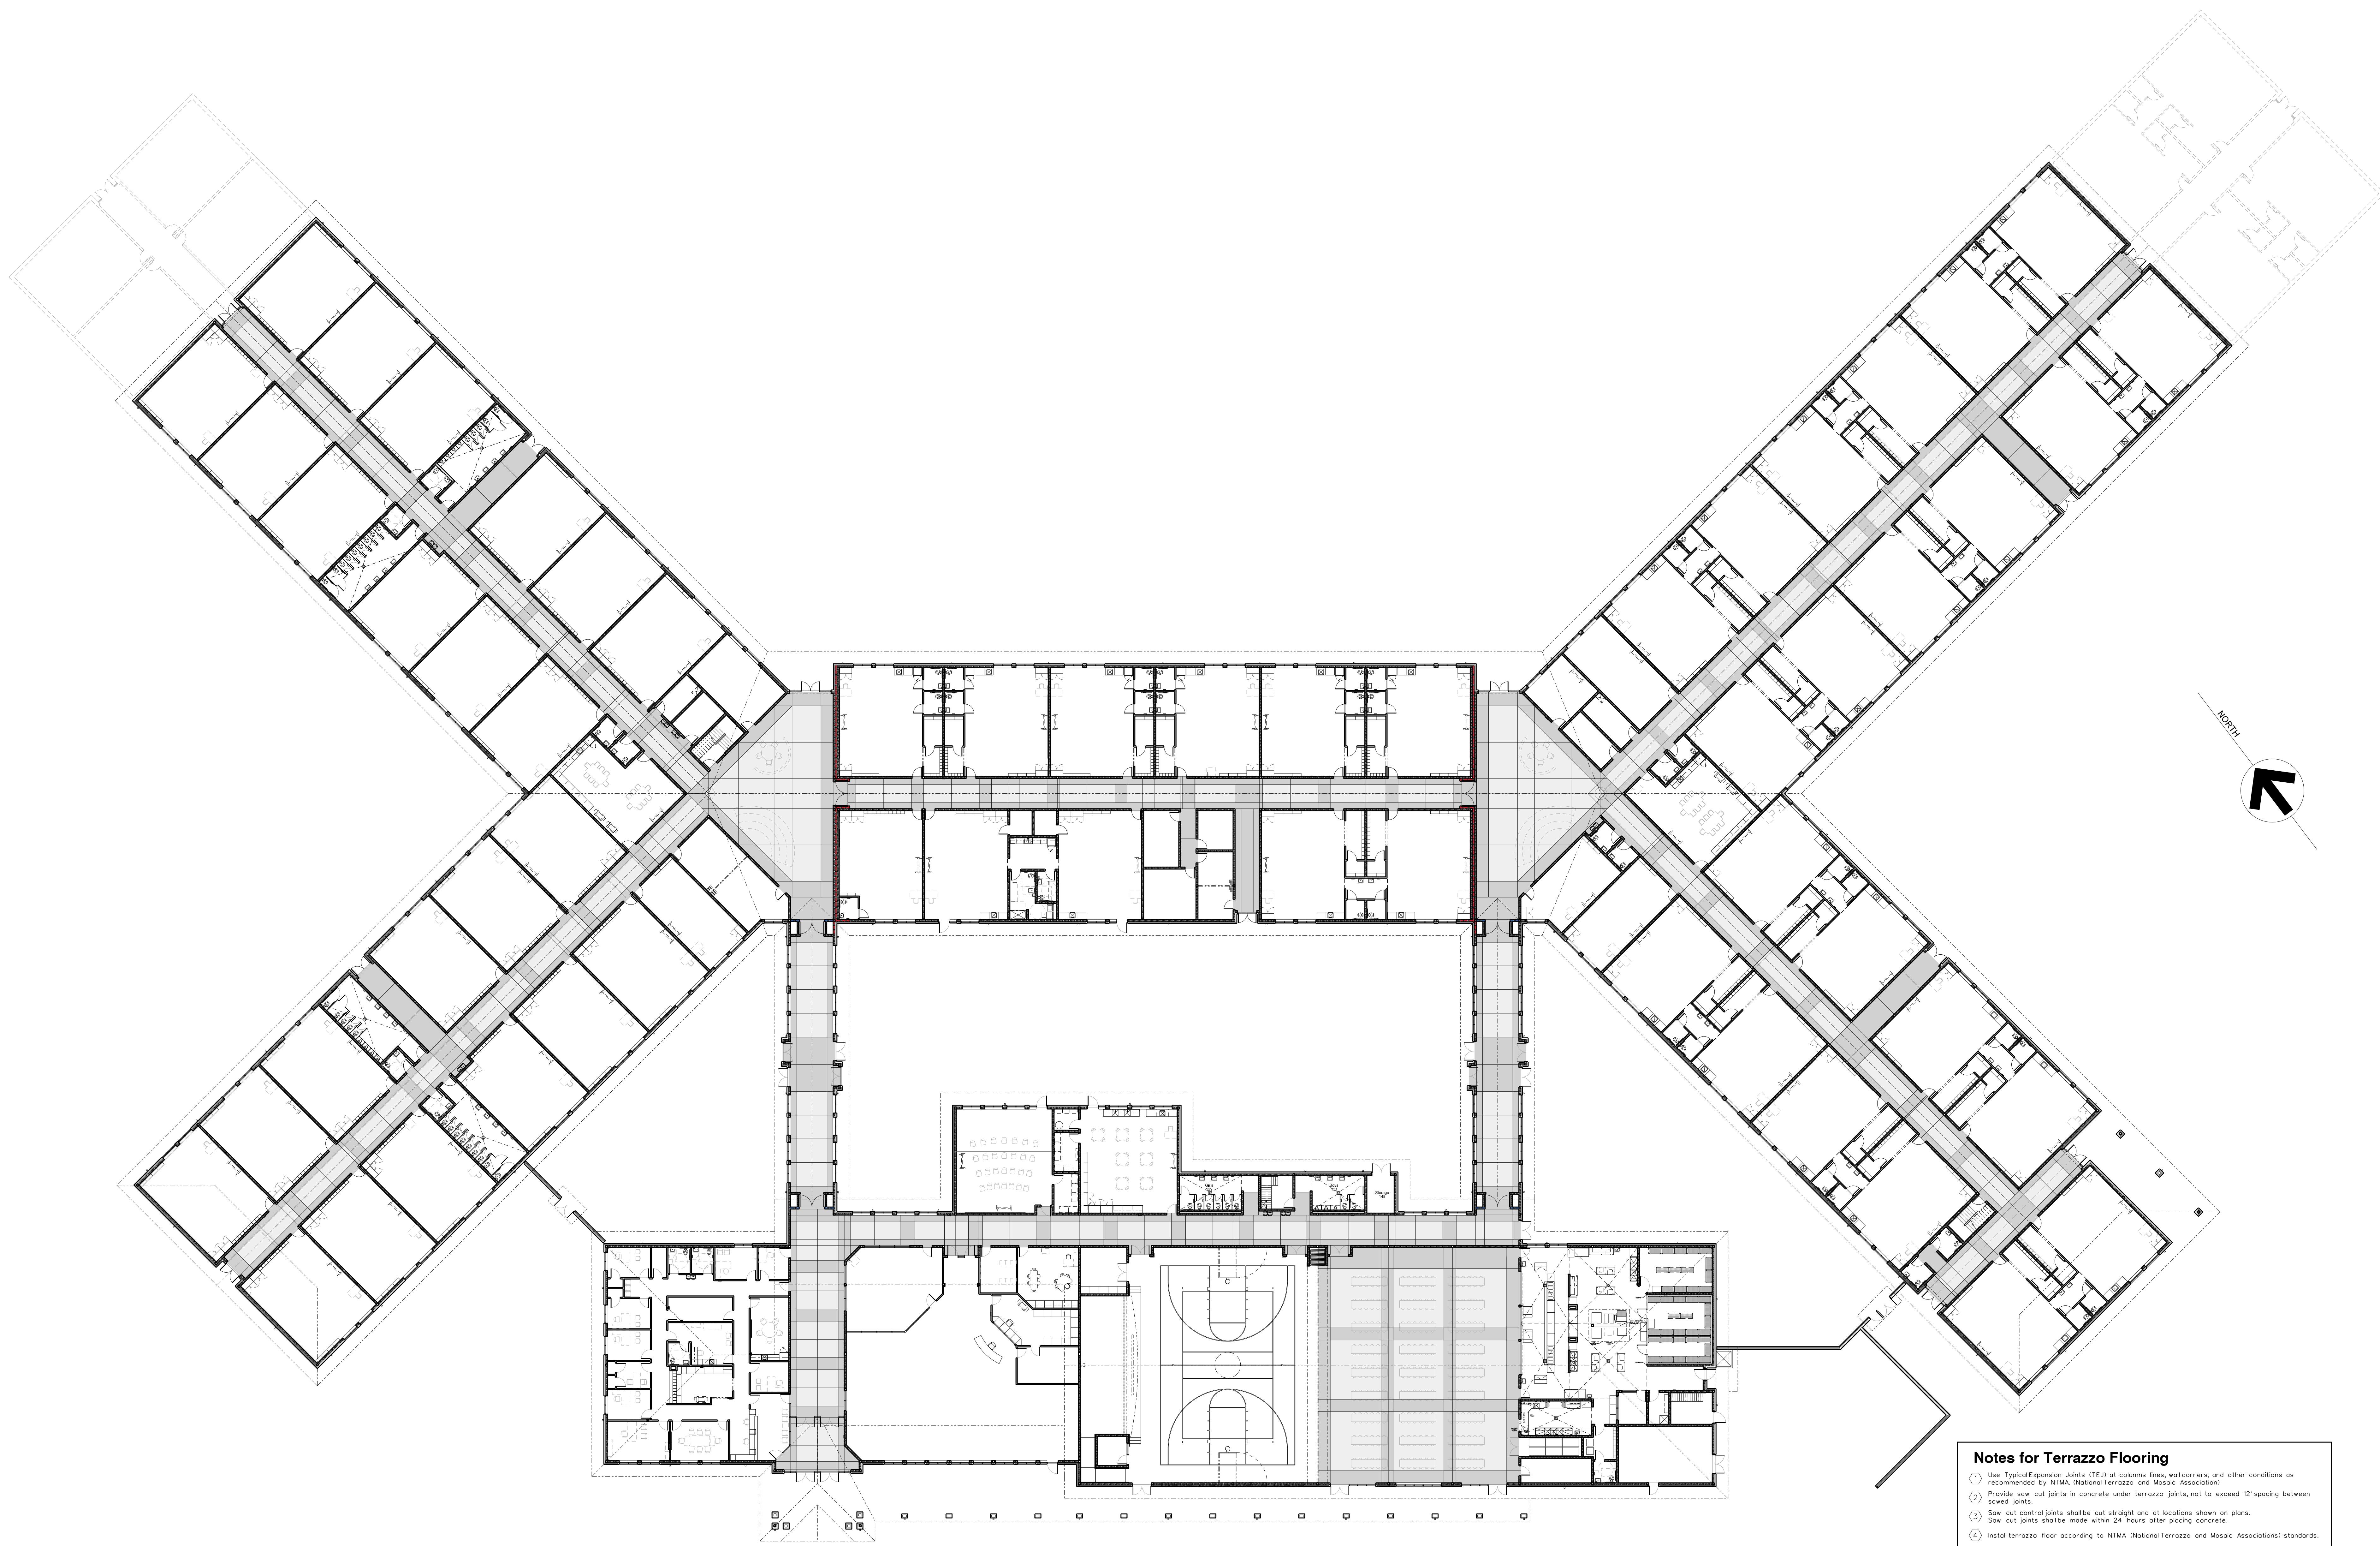

Notes for Terrazzo Flooring


- ① Use Typical Expansion Joints (TEJ) at column lines, wall corners, and other conditions as recommended by NTMA (National Terrazzo and Mosaic Association)
- ② Provide saw cut joints in concrete under terrazzo joints, not to exceed 12' spacing between sawed joints.
- ③ Saw cut control joints shall be cut straight and at locations shown on plans. Saw cut joints shall be made within 24 hours after placing concrete.
- ④ Install terrazzo floor according to NTMA (National Terrazzo and Mosaic Association) standards.

Note: Terrazzo Flooring for this project is under Alternate Bid.

1001.1 OVERALL TERRAZZO PLAN (BID ALTERNATE)
SCALE: 1" = 20'-0"

No.	Date	Revision

Hite associates
ARCHITECTURE / PLANNING / TECHNOLOGY
2600 Meridian Drive / Greenville, NC 27834 / tel (252) 757-0333

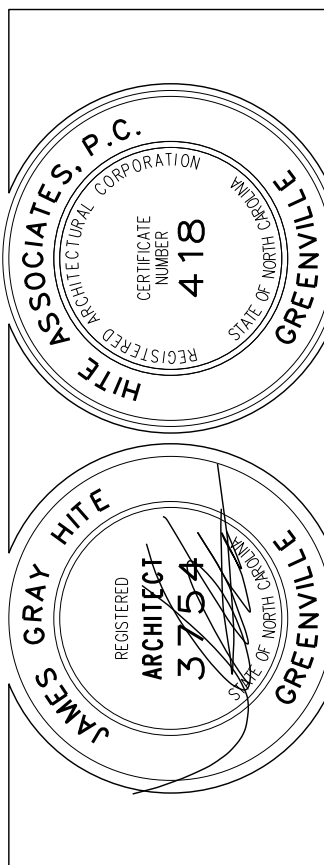


Beaufort PK-3 School
BEAUFORT COUNTY SCHOOLS
Washington / North Carolina / 27889

Project No. 22344
Date: 1 July 2024
Drawing no. **A 1001**

No.	Date	Revision

Hite associates
 ARCHITECTURE / PLANNING / TECHNOLOGY
 2600 Meridian Drive / Greenville, NC 27834 / tel (252) 757-0333

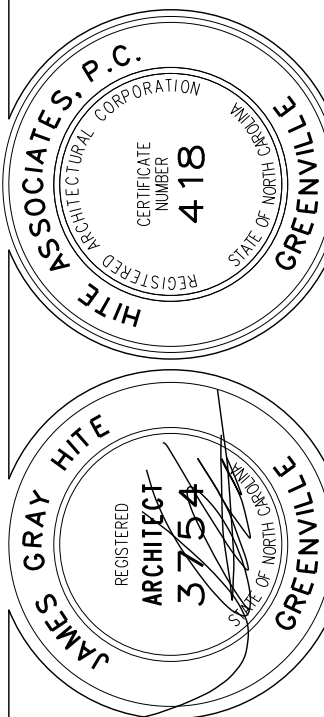

Beaufort PK-3 School
 BEAUFORT COUNTY SCHOOLS
 Washington / North Carolina / 27889

Project No. 22344


Date: 1 July 2024

Drawing No.


**K
101**

KITCHEN EQUIPMENT SCHEDULE


MARK	DESCRIPTION	MFR / MODEL	SIZE			ELECTRICAL			PLUMBING			GAS		REMARKS			
			L	X	D	H	VOLTS	KW/HP	AMPS	HW	CW	WASTE	INDIRECT		SIZE	BTU/HR	
K 1	TRAY STAND	LTI SPECLINE 28-RTS-F	28	30	X	36											
K 2	MILK COOLER / DISPENSER	AVANTCO MC49-HC	49	31	X	42	115										
K 3	5 PAN HOT UNIT WITH COUNTER PROTECTOR	LTI SPECLINE SPC-TW-D/DW-MF-20-05-74	74	30	X	28	208										
K 4	COLD SERVING COUNTER WITH 2 TIER DISPLAY DBL SERVICE	LTI SPECLINE SPC-FT-MF-25-82-84	84	30	X	36	120	1/3	7							TRAY SLIDE AT 28" (TYP ALL SLIDES)	
K 5	WORK TABLE WITH BACKSPLASH	ADVANCE TABCO KSS-308	96	30	X	36										TRAY SLIDE AT 28" (TYP ALL SLIDES)	
K 6	SOLID TOP SERVING COUNTER WITH 2 TIER DISPLAY DBL SERVICE	LTI SPECLINE 90-ST-F	50	30	X	36										PROVIDE 20 X 20 X 5 S.S. DRAWER UNIT	
K 7	CASHER STATION	LTI SPECLINE 36-CSE-F	36	30	X	36										PROVIDE 10" BEADED SLIDE AT 28"	
K 8	WORK TABLE WITH SPLASH AND UNDERSHELF	ADVANCE TABCO KSS-307	84	30	X	36										PROVIDE S.S. SLIDE EACH SIDE AT 28"	
K 9	REFRIGERATED CABINET PASS THROUGH	TRUE STR2RPT-2G-25-HC	53	36	X	84	115	1/2	5.9								
K 10	HEATED CABINET PASS THROUGH	WINSTON HDV5-14UV	28	34	X	76	120		19.1								
K 11	ICE MACHINE	HOSHIZAKI KM-860MAJ/B-250SF	30	28	X	52	208		9.9		1/4	3/4					
K 12	2 COMPARTMENT PREP SINK	ADVANCE TABCO REGALINE 93-42-48-24RL	30	30	X	36											
K 13	PRE RINSE FAUCET WALL MOUNT	T & S B-0133-A12B-TEE														6.5" SINK MOUNT	
K 14	DISPOSAL	SALVAJOR 200-SA-ARSS					208	2	6.6								
K 15	WIRE SHELF STAINLESS WALL MOUNT	METRO 1872 STAINLESS STEEL	72	X	18												
K 16	2 COMPARTMENT PREP SINK	ADVANCE TABCO REGALINE 93-2-36-24RL	85	X	28	X	36										
K 17	HOSE REEL	T & S B-7132-01															
K 18	WORK TABLE	ADVANCE TABCO US-30-72	72	X	30	X	36									PROVIDE (2) 20x20x5 S.S. DRAWERS	
K 19	NOT USED																
K 20	ELECTRIC REELS	BY ELECTRICAL CONTRACTOR															VERIFY EXACT MOUNTING LOCATION
K 21	TRENCH DRAIN	FABRICATED PER DETAILS															
K 22	GAS BRAISING PAN	GROEN BPM-40G / A / C2T	48	X	40	X	44	115						3/4	144,000	NATURAL GAS 7" WC	
K 23	6 BURNER GAS RANGE	SOUTHBEND 4361D	36	X	36	X	37	115						3/4	243,000	NATURAL GAS 7" WC	
K 24	EQUIPMENT TABLE WITH PLATE SHELF	ADVANCE TABCO ES-303	36	X	30	X	24									PROVIDE TA-963 PLATE SHELF	
K 25	DOUBLE GAS COMBI STEAMER	BLODGETT BCX-14G	41	X	38	X	70	115	12 X 2		3/4	2	3/4	115,000	NATURAL GAS 7" WC		
K 26	EXHAUST HOOD	BY MECHANICAL CONTRACTOR															
K 27	AUTO FIRE SUPPRESSION SYSTEM	BY MECHANICAL CONTRACTOR															
K 28	WALK IN COOLER	KOLPAK															SEE SPECIFICATIONS
K 29	WALK IN FREEZER	KOLPAK															SEE SPECIFICATIONS
K 30	EPOXY WIRE SHELVING	METRO, SUPER ERCTA E22448NK3-4	48	X	24	X	74										EPOXY COATED
K 31	DUNNAGE FLATS	METRO BOWTIE POLYMER				22	X	48									
K 32	NO. 10 CAN RACKS / ALUM / STATIONARY	STEELTON CNK162KD	25	X	35	X	72										
K 33	RESIDENTIAL WASHER	PROVIDE UNDER RES KIT ALLOW															NOT IN KIT EQUIPMENT SUBCONTRACT
K 34	RESIDENTIAL DRYER	PROVIDE UNDER RES KIT ALLOW															NOT IN KIT EQUIPMENT SUBCONTRACT
K 35	REFRIGERATOR	TRUE T-49-HC	54	X	30	X	78	115	1/2	5.4							
K 36	UTILITY CART	CAMBRO BC235	37	X	22	X	35										
K 37	3 COMPARTMENT SINK / DISH TABLE	ADVANCE TABCO REGALINE 93-43-72-36RL	151	X	32	X	36										
K 38	SOUP KETTLE WARMER	AVANTCO 5600 14 QT.						120	3/5	5.5							
K 39	SWING SPOUT WALL MOUNT	T & S B-0231															
K 40	CASTER CART 4 SHELF WITH COVER	METRO 4 TIER ADJ CHROME FINISH	36	X	24	X	69										PROVIDE METRO ESD CART COVER EACH
K 41	DISHWASHER WITH EXTENDED SS VENTS TO CEILING	HOBART CL66-ADV	85	X	31	X	69	208	2	115.7	1/2	1/2	2				HOT WATER PROVIDED AT 170 DEGREES
K 42	DISH RETURN TABLE WITH PREWASH	FABRICATED PER DETAILS / DIMS															
K 43	TRAY RETURN WINDOW	COOKSON CD-10 PUSH UP															
K 44	ONE COMPARTMENT SINK	ADVANCE TABCO REGALINE 93-41-24-36L	66	X	32	X	36										ONE FOR MAKERSPACE
K 45	TWO COMPARTMENT SINK	ADVANCE TABCO REGALINE 93-42-48-24RL	101	X	30	X	36										ONE FOR ART ROOM
K 46	DISHWASHER CLEAN TABLE	FABRICATED PER DETAILS / DIMS															

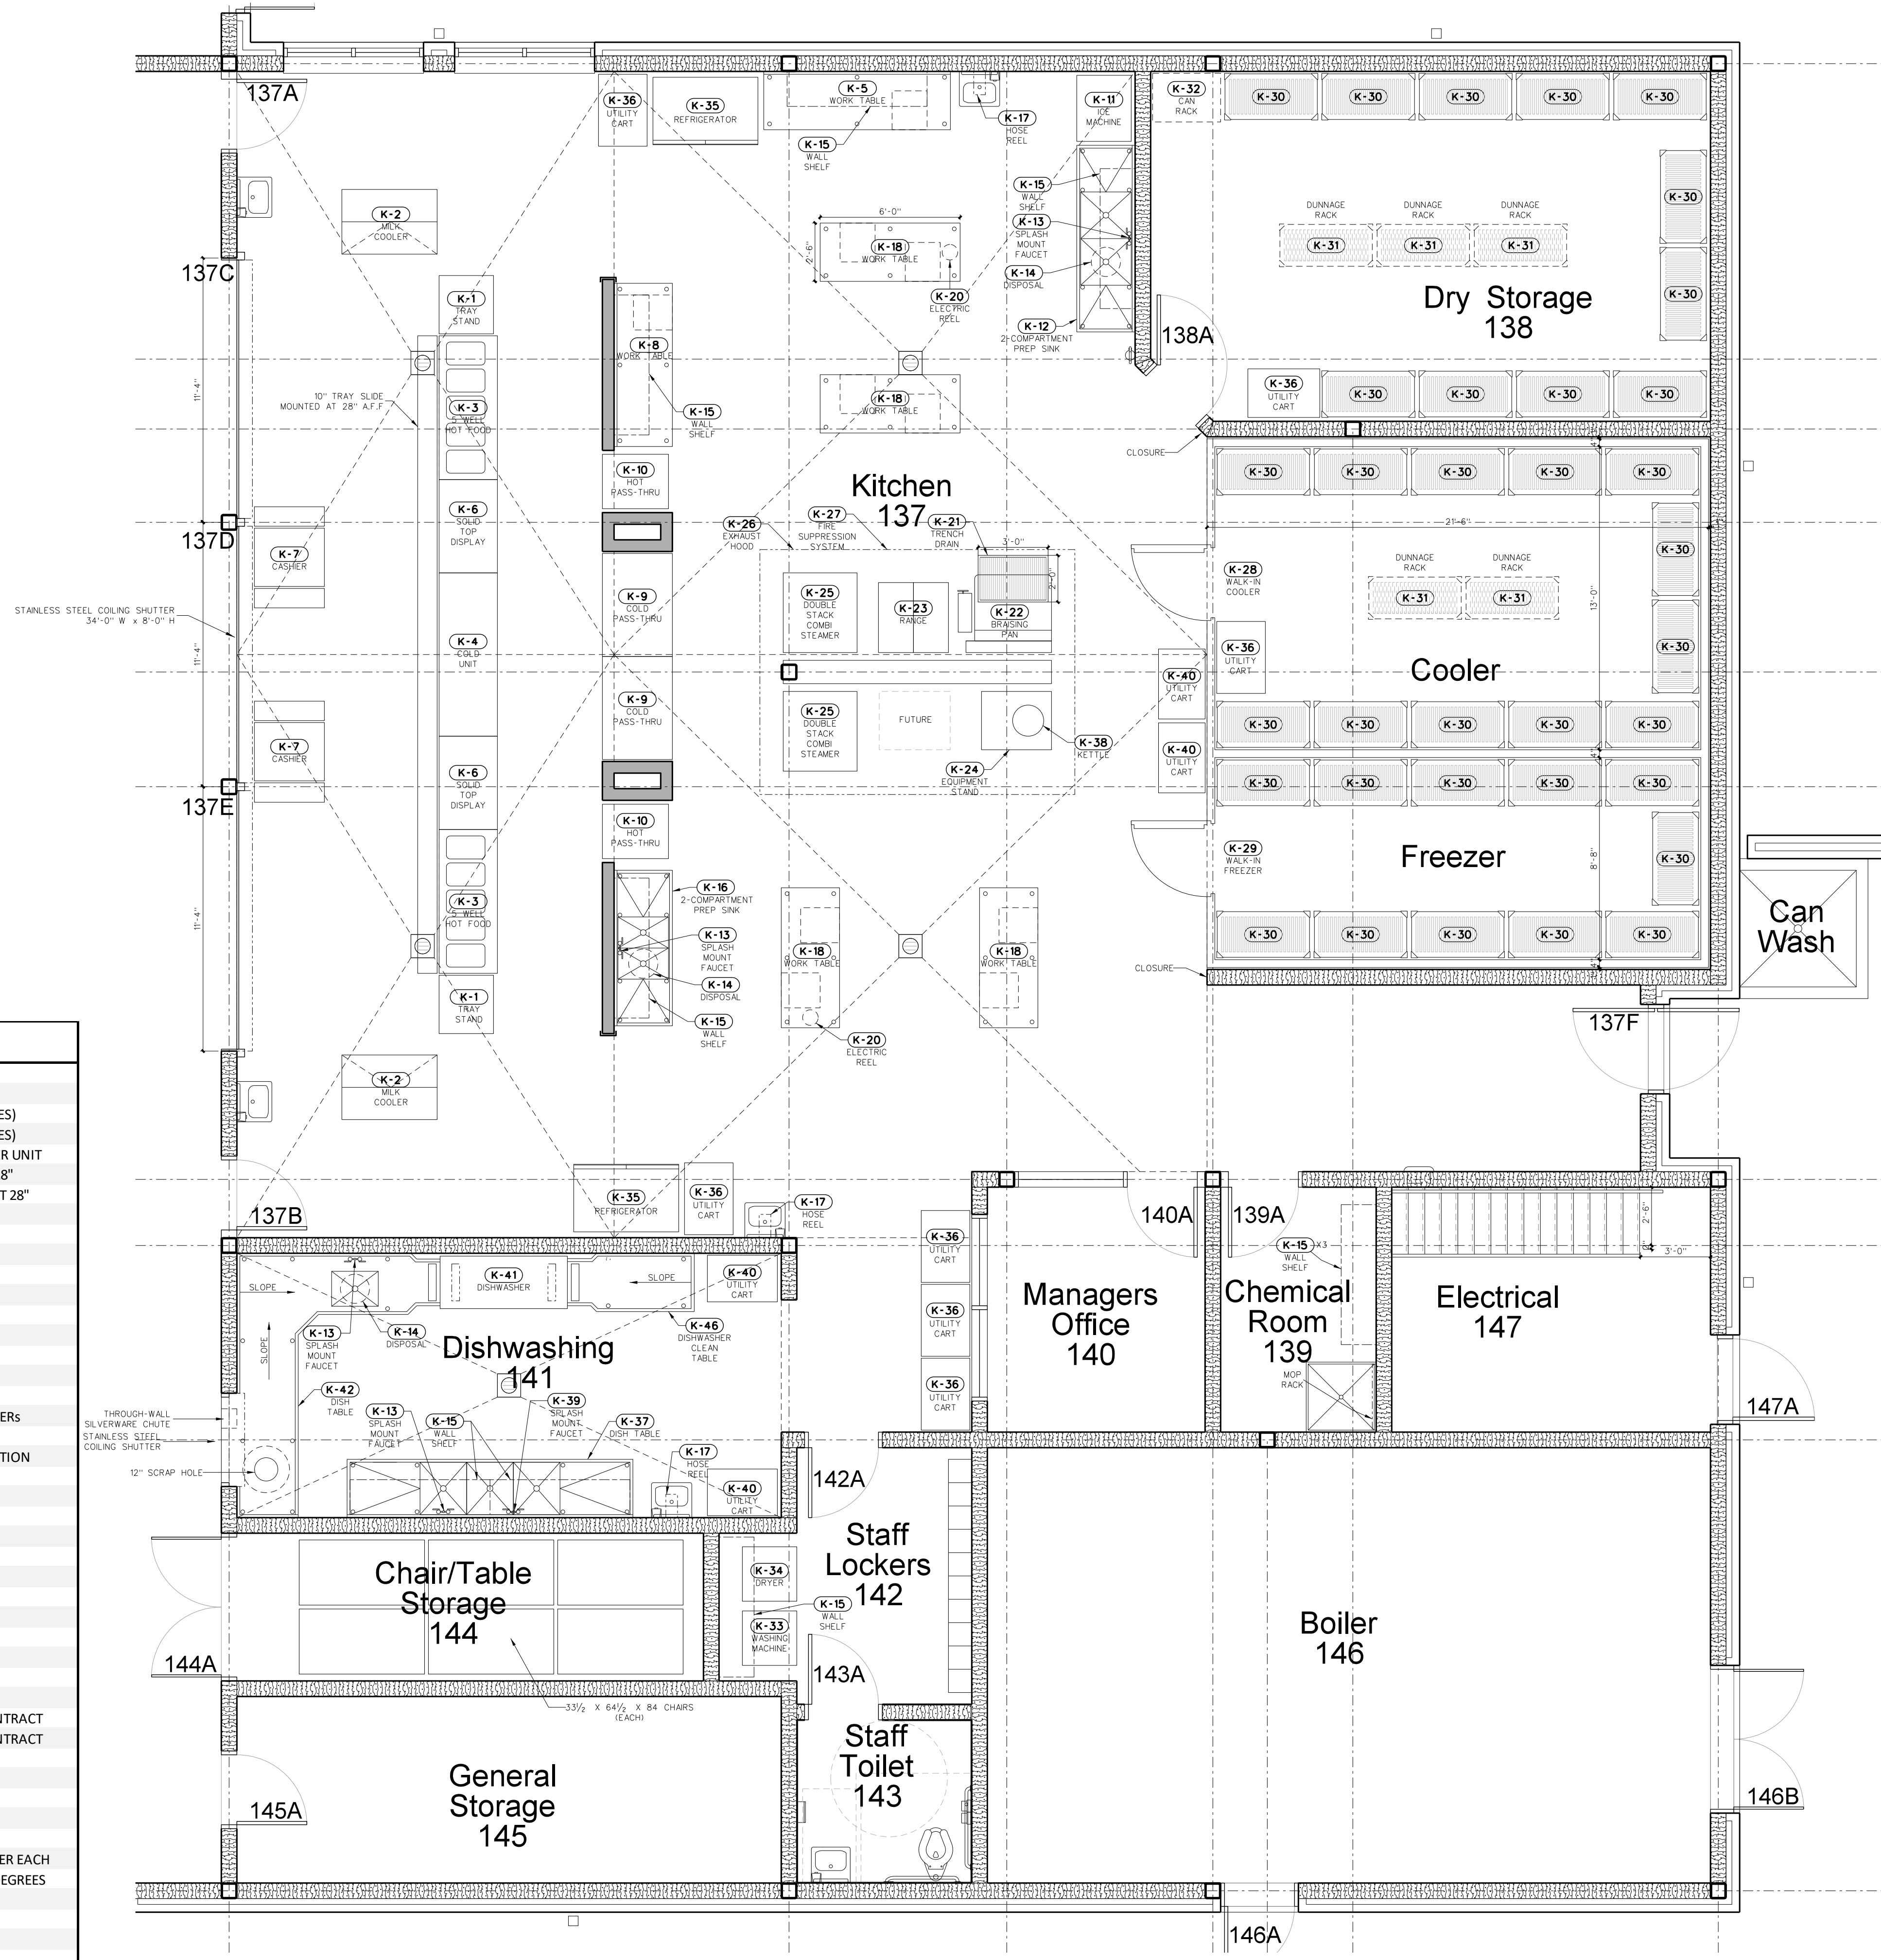


101.1 ENLARGED KITCHEN PLAN
 SCALE: 1/4" = 1'-0"

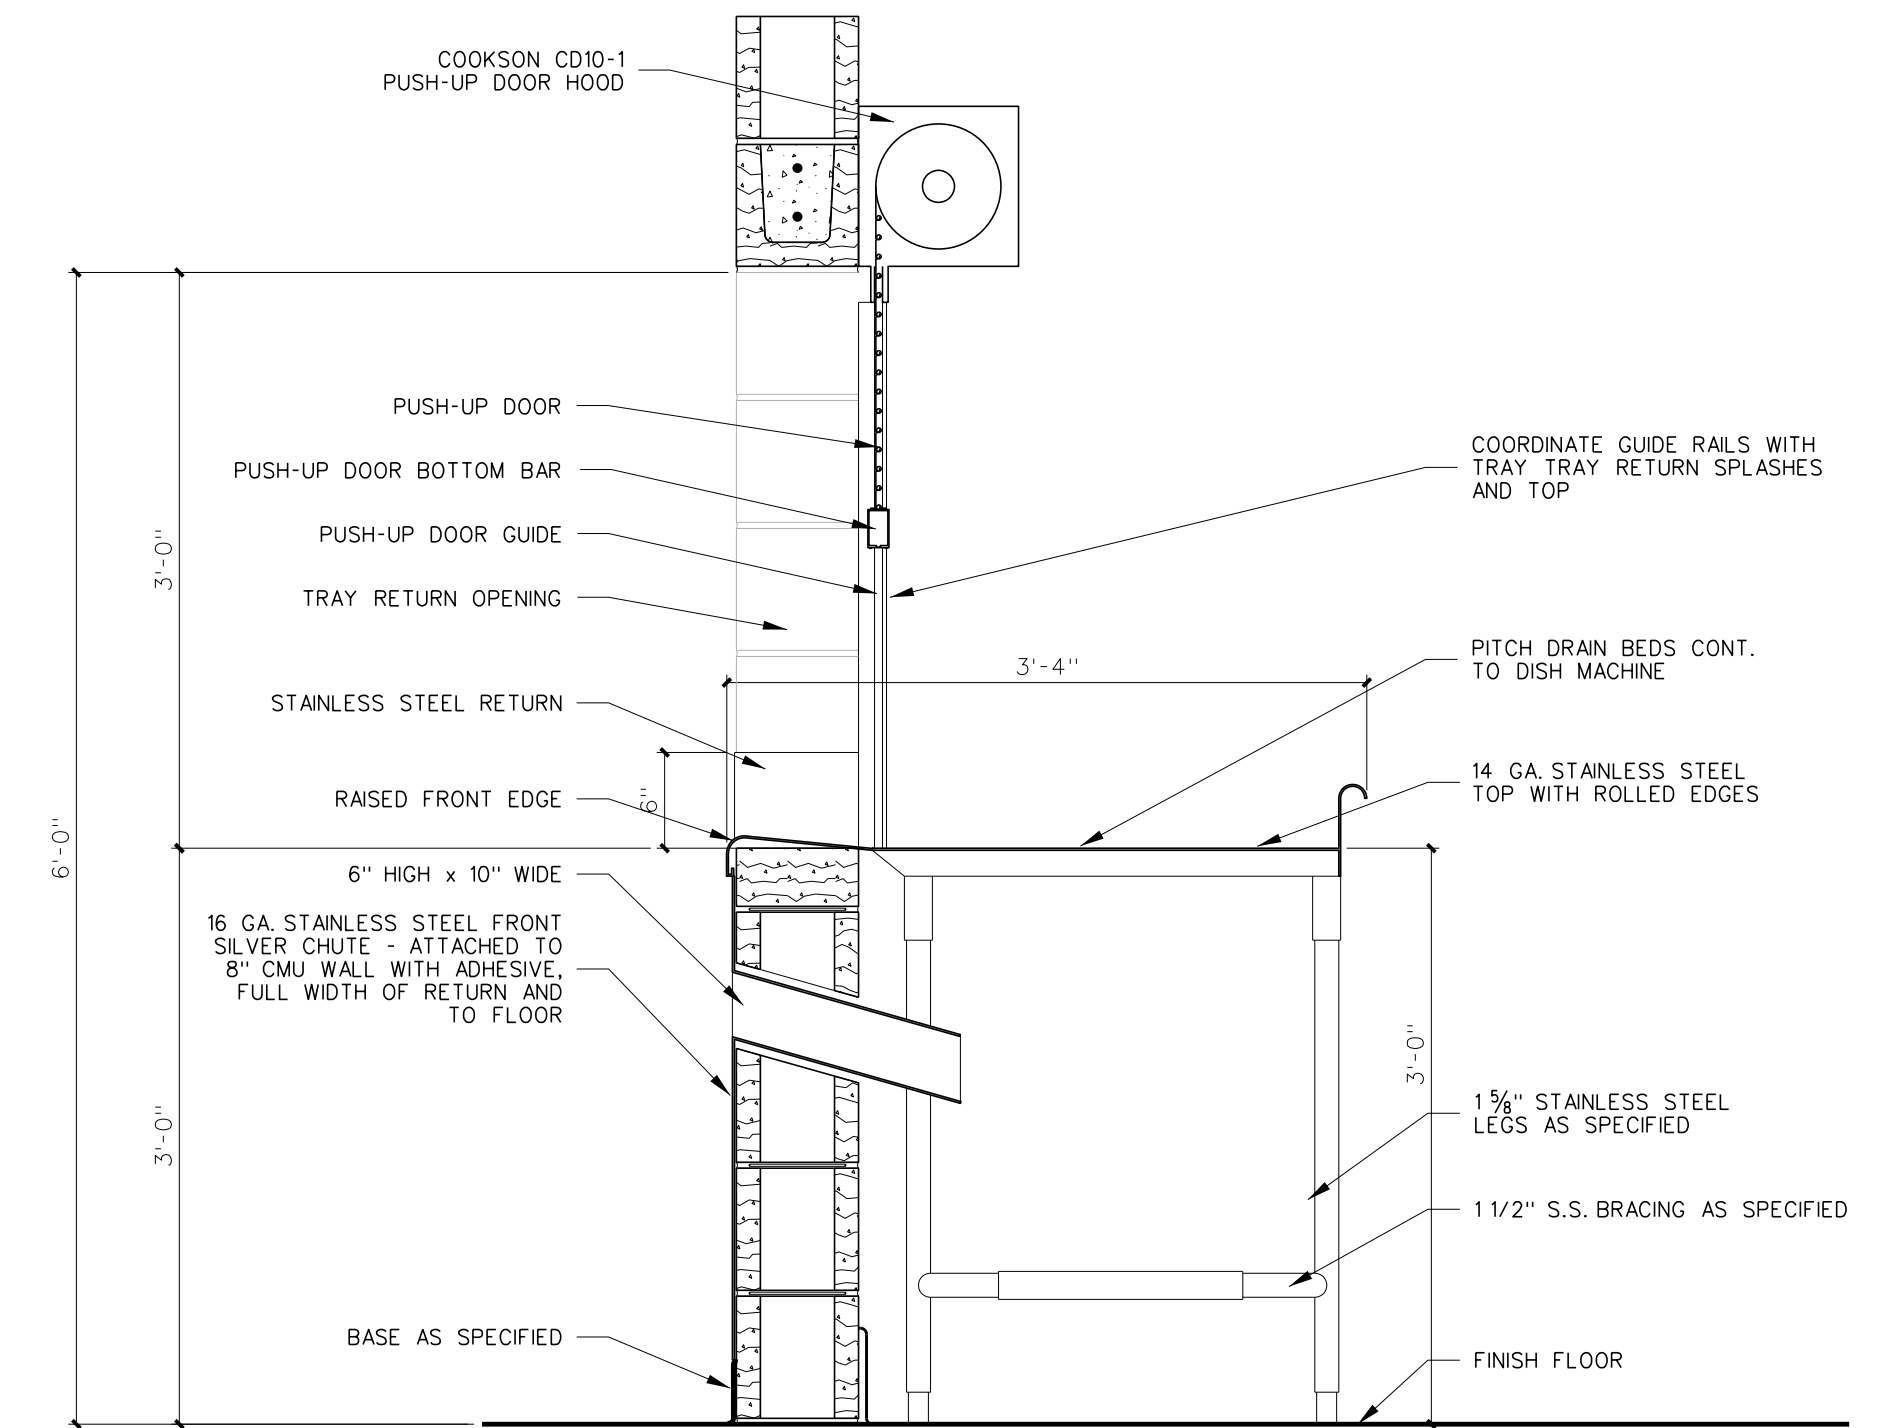


102.4 DIRTY DISH RETURN
SCALE: 1" = 1'-0"

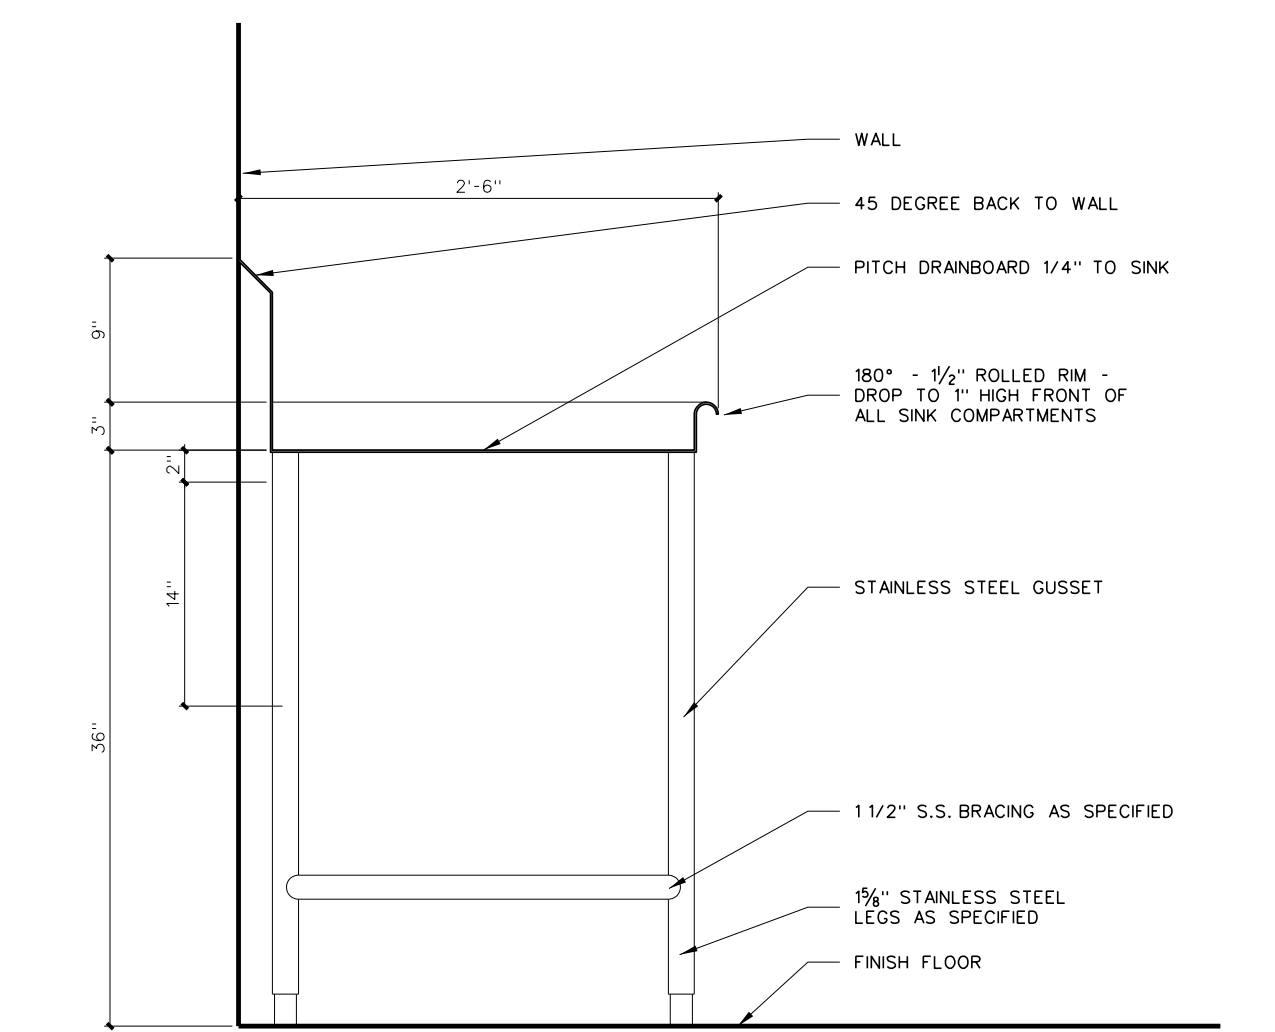


102.3 TYPICAL DRAINBOARD SECTION
SCALE: 1" = 1'-0"

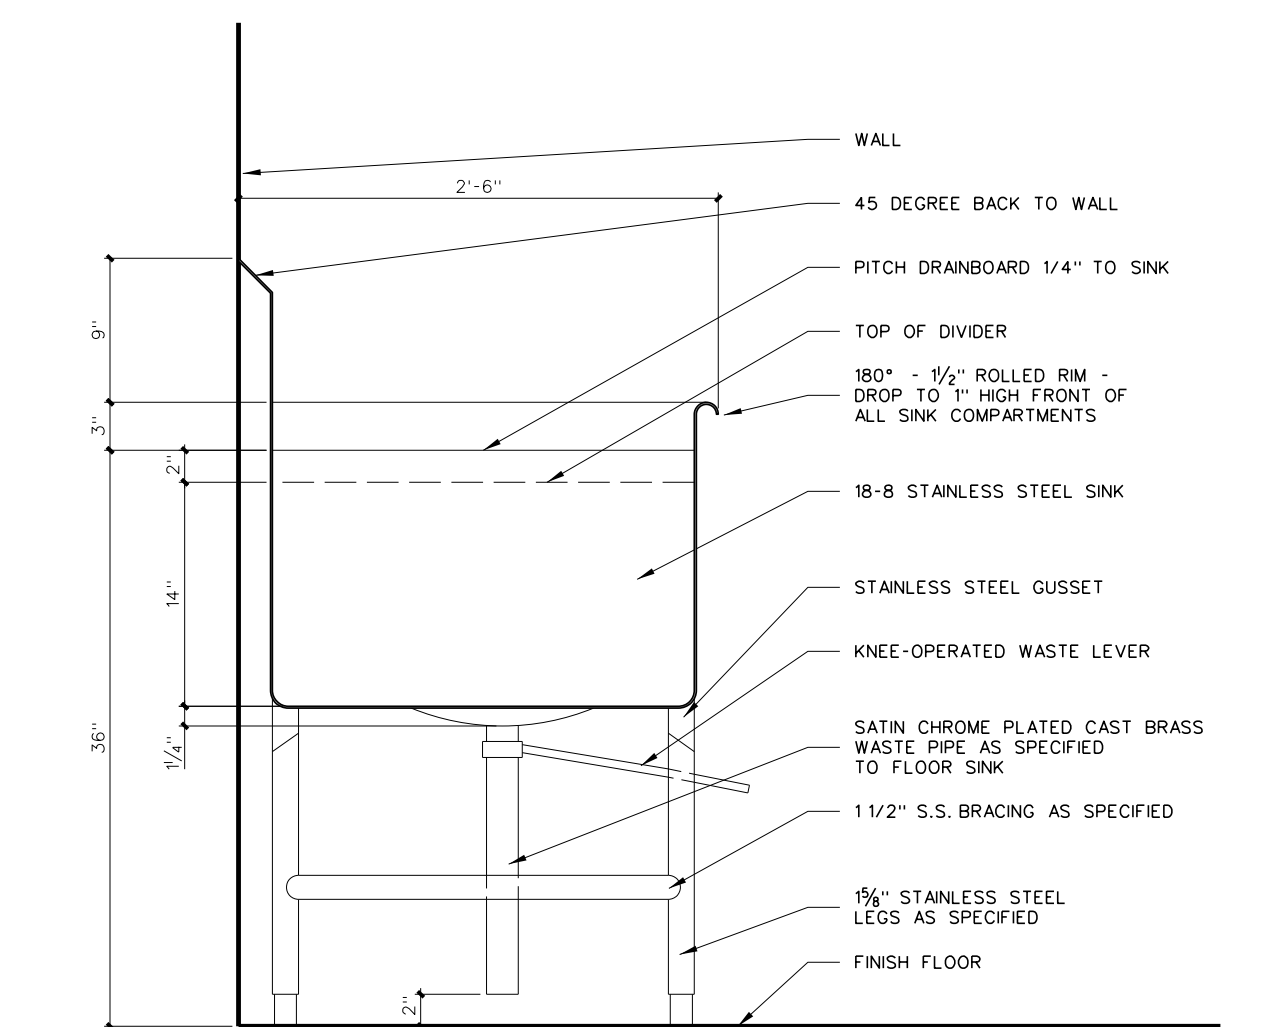

102.2 TYPICAL SINK SECTION
SCALE: 1" = 1'-0"

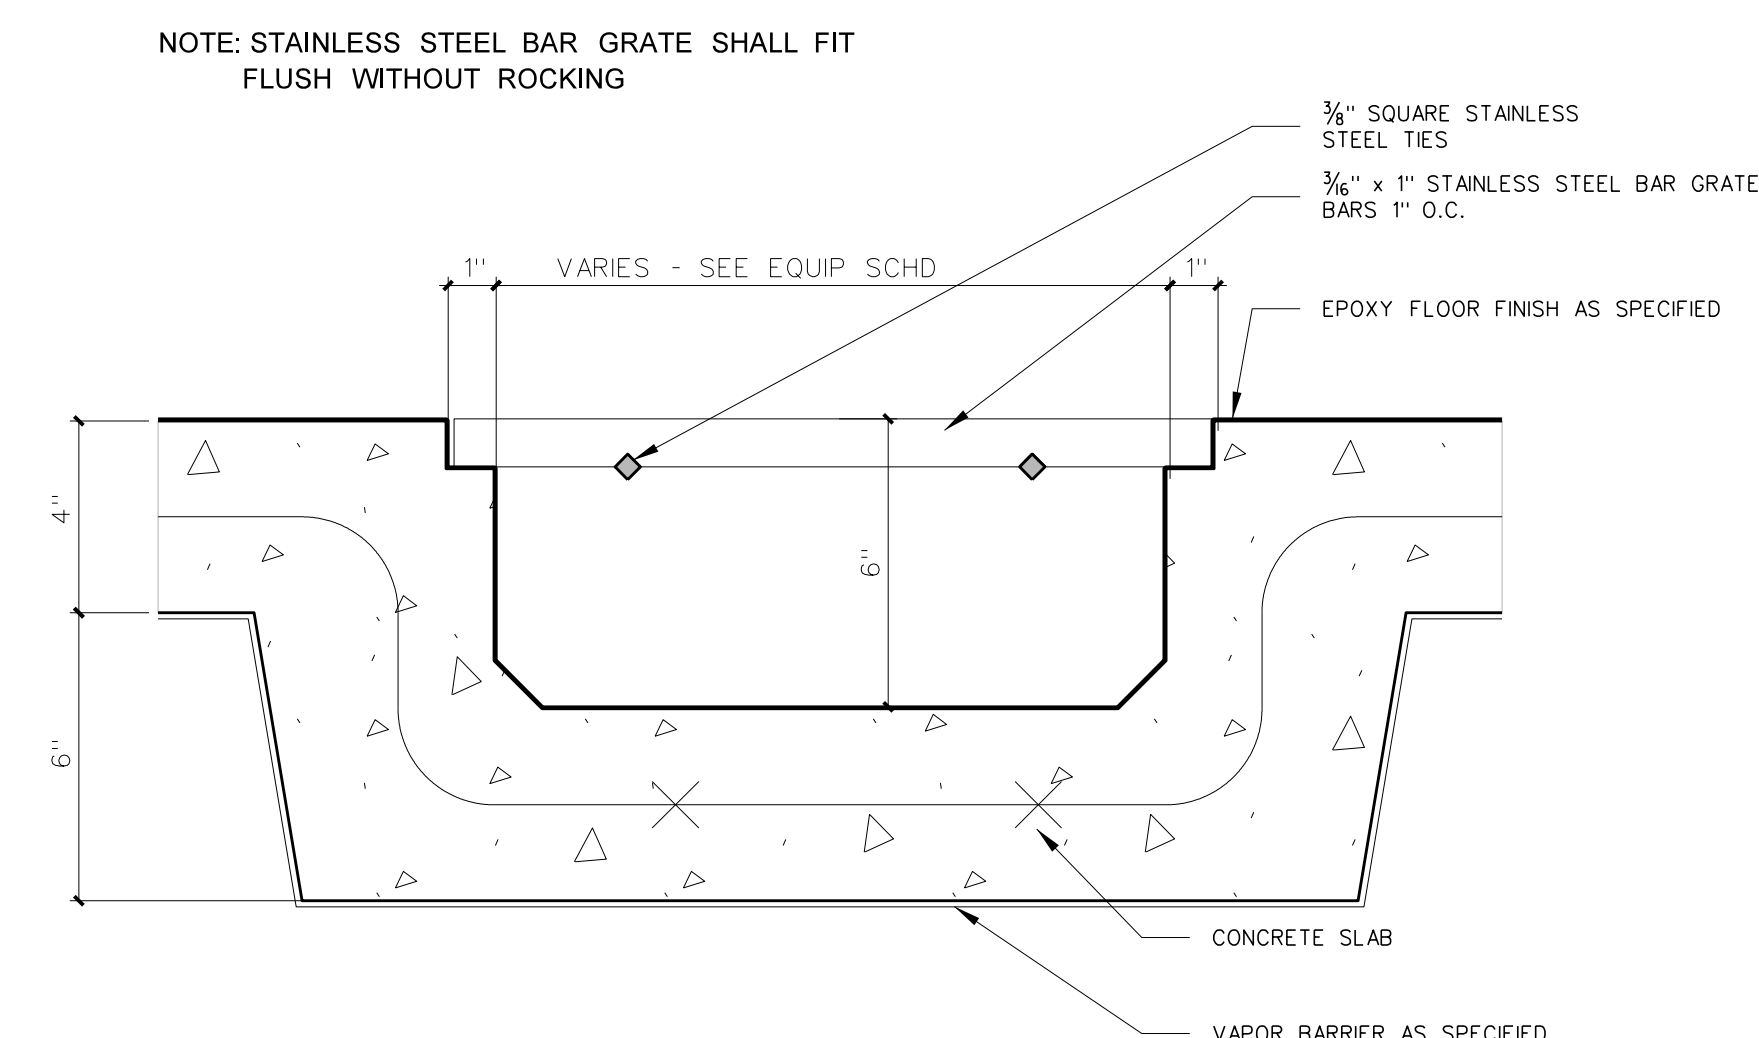


102.5 TRENCH GRATE DETAIL
SCALE: NONE

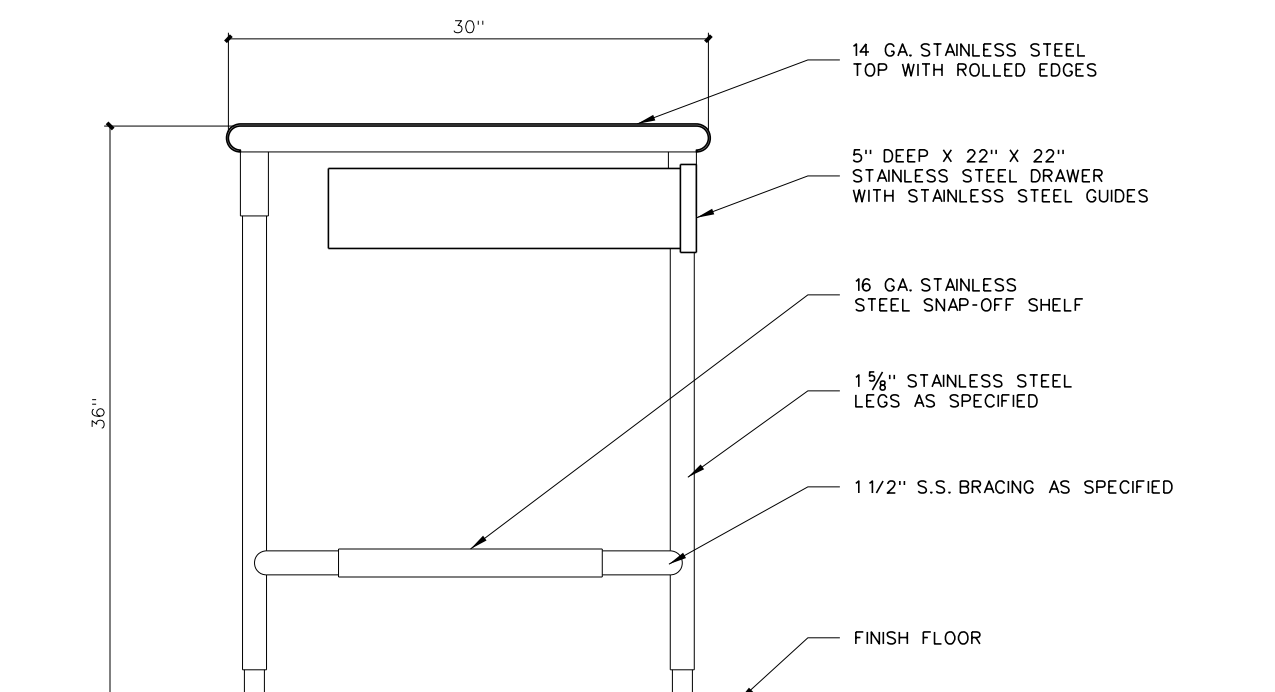

102.1 S.S. WORK TABLE
SCALE: 1" = 1'-0"


No.	Date	Revision

Hite associates
ARCHITECTURE / PLANNING / TECHNOLOGY
2600 Meridian Drive / Greenville, NC 27834 / tel (252) 757-0333

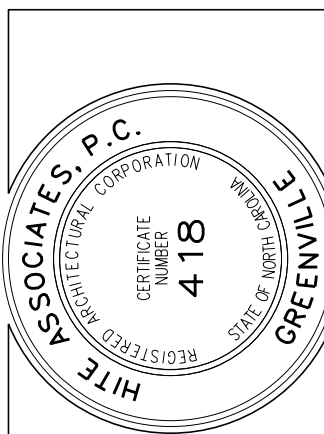

Beaufort PK-3 School
BEAUFORT COUNTY SCHOOLS
Washington / North Carolina / 27889


Project No.	22344
Date:	1 July 2024
Drawing no.	K 102

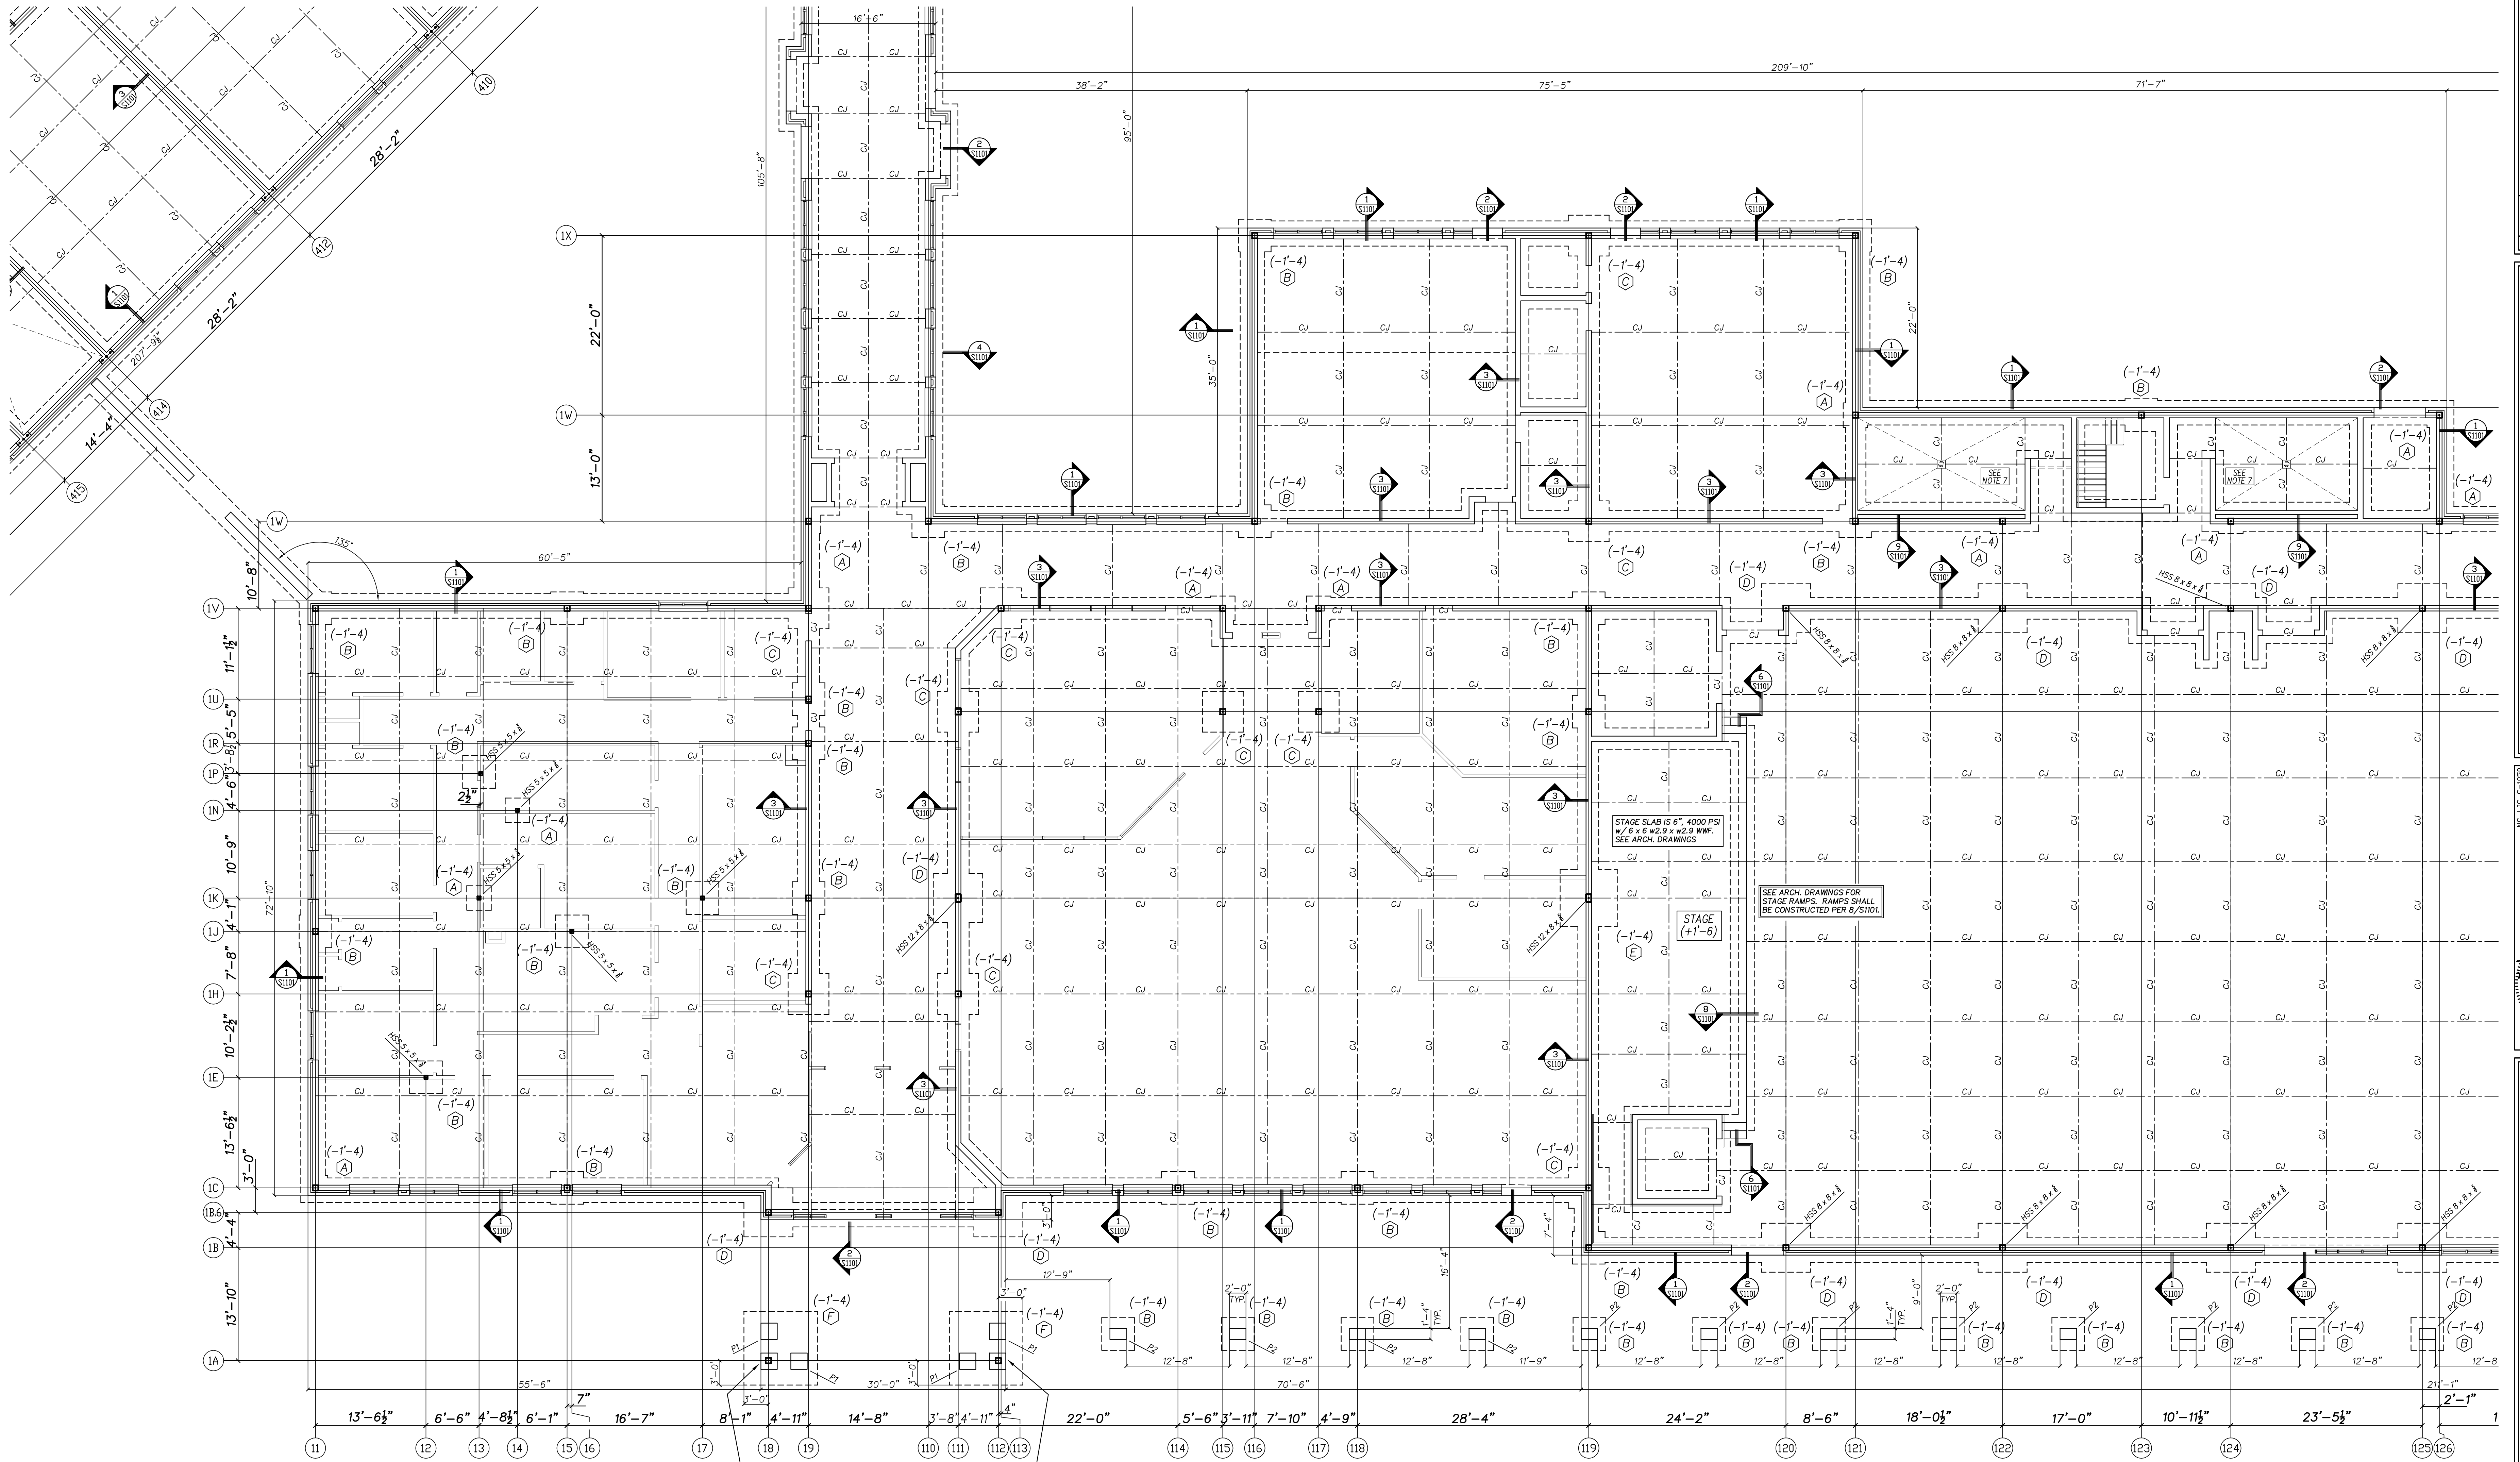


TYPICAL MASONRY SURROUND NOTE:
 CIRCULAR MASONRY PIERS AROUND COLUMNS 100K SOLID w/ 3000 PSI CONCRETE. PROVIDE ONE #6 VERTICAL IN EACH CELL OF 8" BLOCK UNIT BACKING UP BRICK VENEER. PROVIDE ONE #3 COLUMN HOOP TIE AT EVERY OTHER 8" BLOCK COURSE. #7 AROUND VERTICAL BARS. DOWEL ALL REINFORCED CELLS TO FOOTING BELOW w/ MATCHING BARS.

**AREA 100
 FOUNDATION PART PLAN**

- FOOTING DESIGN BASED ON AN SOIL BRG. CAPACITY OF 1500 PSF. (GEOTECHNICAL REPORT BY TERRACON (PROJECT NO. 72235092, DATED 17 NOV 2023) IT IS THE RESPONSIBILITY OF THE CONTRACTOR TO NOTIFY THE ENGINEER OF RECORD IF UNSTABLE, ORGANIC, WEAK OR OTHERWISE UNACCEPTABLE SOIL CONDITIONS ARE ENCOUNTERED DURING EXCAVATIONS OR SUBSEQUENT GEOTECHNICAL INVESTIGATIONS.
- ELEV. NOTED (-) ARE BELOW REFERENCE FINISHED FLOOR TO TOP/FOOTING. (+15.00')
- SLAB ON GRADE IS NORMAL WEIGHT CONCRETE WITH REINFORCED WITH #6x6 W1.4 x W1.4 WMM ON A 4" NO. 57/87 WASHED STONE AND 15 MIL POLY VAPOR BARRIER, TYP. U.O.N.
- ALL CONCRETE SHALL BE A MINIMUM STRENGTH OF 3000 PSI MEETING ACI 301 AND ACI 318. ALL CONCRETE SHALL BE MIXED, HANDLED, SAMPLED, TESTED AND PLACED IN ACCORDANCE WITH ACI STANDARDS. ALL SAMPLES SUBJECT TO PUMPING SHALL BE TAKEN AT THE EXIT END OF THE PUMP AT THE ELEVATION OF PLACEMENT. (REFERENCE ACI MANUAL OF CONCRETE PRACTICE).
- ALL REINFORCING BARS SHALL BE GRADE 60 CONFORMING TO ASTM 615. LAP BARS WHERE REQUIRED USING CLASS B TENSION LAP SPLICES, OR 40 BAR DIAMETERS. DEVELOPMENT LENGTHS SHALL BE CRSI MINIMUM UON.
- SEE S101 FOR COLUMN FOOTING SCHEDULE AND ADDITIONAL NOTES THAT APPLY.
- REFERENCE ARCHITECTURAL AND PLUMBING DRAWINGS FOR COORDINATION OF SLOPED FLOORS AT FLOOR DRAINS, AND DEPRESSED FLOOR SLAB LOCATIONS.
- LOCATE ALL WALLS AND MASONRY OPENINGS PER ARCHITECTURAL DRAWINGS.
- ARCHITECTURAL BACKGROUND IS SHOWN FOR REFERENCE ONLY. REFER TO ARCHITECTURAL DRAWINGS FOR EXACT LOCATIONS OF WALLS.
- THE CONTRACTOR SHALL COORDINATE AND VERIFY ALL DIMENSIONS & ELEVATIONS PRIOR TO STARTING CONSTRUCTION AND ANY DISCREPANCY SHALL BE BROUGHT TO THE ATTENTION OF THE ENGINEER OF RECORD.
- FLOOR SLAB IN GYM AREA SHALL BE DEPRESSED 2 17/32" TO RECEIVE THE CUSHIONED PLAY FINISH FLOOR. VERIFY WITH ARCHITECTURAL DRAWINGS ALL DETAILS OF DEPRESSION AT DOORWAY THRESHOLDS. CONTRACTOR SHALL VERIFY/COORDINATE REQUIRED SLAB DEPRESSION FOR PLAY FLOOR WITH ARCH. ROOM FINISH SCHEDULE.
- SEE ARCHITECTURAL DRAWINGS FOR ALL POURED RAMP LOCATIONS AND DIMENSIONS, TYPICAL. SEE ARCHITECTURAL DRAWINGS FOR ALL POURED STAIR LOCATIONS AND DIMENSIONS, TYPICAL. CONSTRUCT ALL POURED RAMPS AND STAIRS IN ACCORDANCE WITH STRUCTURAL SECTIONS 6 & 8/S101 AND ARCHITECTURAL DRAWINGS. SEE 13/S101 FOR BOLLARD DETAIL. LOCATE ALL BOLLARDS PER ARCHITECTURAL DRAWINGS.
- ALL COLUMNS = HSS 8 x 8 x 4, TYP. U.O.N.

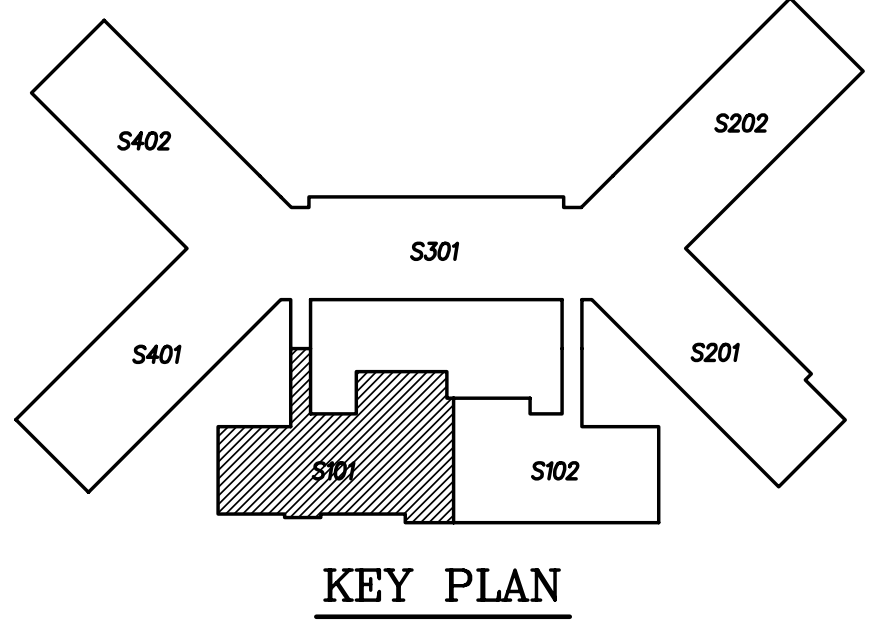


<p>Hite associates ARCHITECTURE/ENGINEERING/TECHNOLOGY 2600 Meridian Drive / Greenville, NC 27838 / tel (252) 757-0333</p>		No. Date _____ _____	
		Project No. 22344 Date: 09 OCT 2024 Drawing no. S 101	
<p>NE, L.L.C. C-1020 QED QUEEN ENGINEERING & DESIGN 2600 MERIDIAN DRIVE, SUITE 400 GREENVILLE, NC 27838 TEL: 252-757-0333 WWW.QED-NC.COM</p>		<p>North Carolina Princess Owen 18991 ENGINEER BRUCE OWEN 09 OCT 2024</p>	
<p>Beaufort PK-3 School BEAUFORT COUNTY SCHOOLS Washington / North Carolina / 27889</p>			

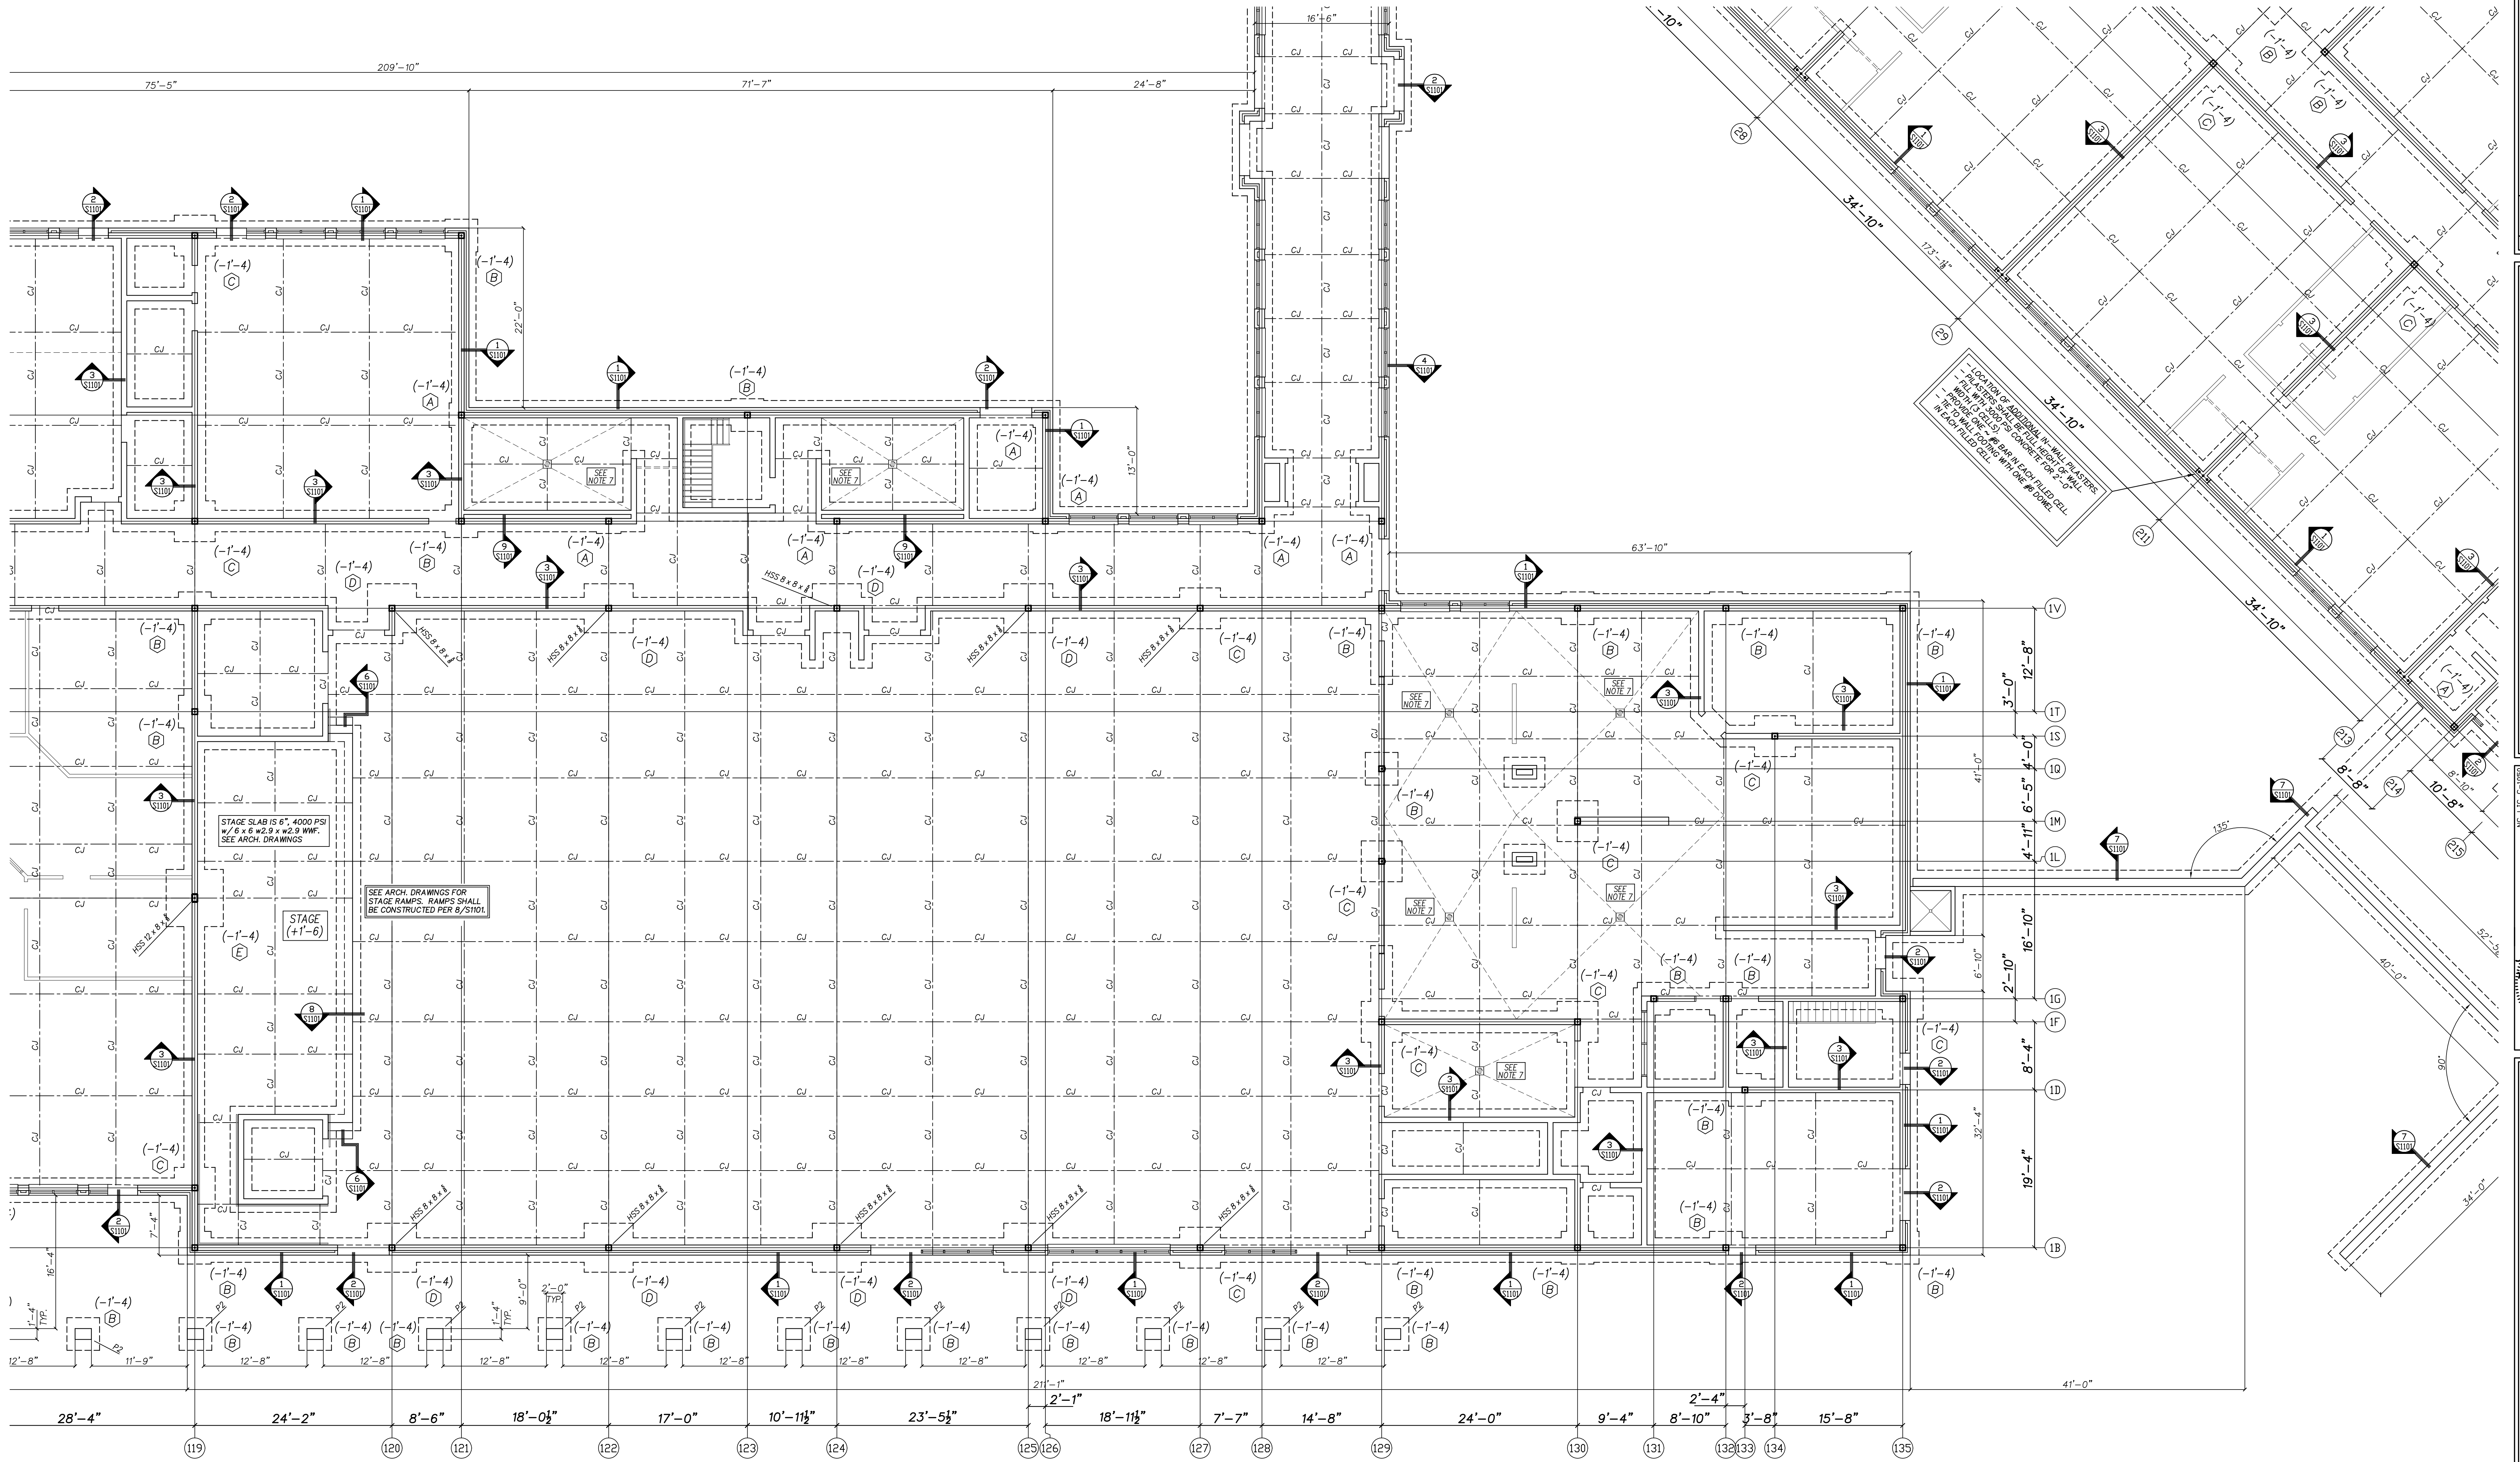

**AREA 100
FOUNDATION PART PLAN**

1" = 1'-0"

- FOOTING DESIGN BASED ON A SOIL BRG. CAPACITY OF 1500 PSF. (GEOLOGICAL REPORT BY TERRACON (PROJECT NO. 72235092, DATED 17 NOV 2023) IT IS THE RESPONSIBILITY OF THE CONTRACTOR TO NOTIFY THE ENGINEER OF RECORD IF UNSTABLE, ORGANIC, WEAK OR OTHERWISE UNACCEPTABLE SOIL CONDITIONS ARE ENCOUNTERED DURING EXCAVATIONS OR SUBSEQUENT GEOLOGICAL INVESTIGATIONS.
- ELEV. NOTED (-) ARE BELOW REFERENCE FINISHED FLOOR TO TOP/FOOTING. (+15.00')
- SLAB ON GRADE IS NORMAL WEIGHT CONCRETE WITH REINFORCED WITH 6x6 W1.4 x W1.4 W/M ON A 4" NO. 57/67 WASHED STONE AND 15 MIL POLY VAPOR BARRIER, TYP. U.O.N.
- ALL CONCRETE SHALL BE A MINIMUM STRENGTH OF 3000 PSI MEETING ACI 301 AND ACI 318. ALL CONCRETE SHALL BE MIXED, HANDLED, SAMPLED, TESTED, AND PLACED IN ACCORDANCE WITH ACI STANDARDS. ALL SAMPLES SUBJECT TO PUMPING SHALL BE TAKEN AT THE EXIT END OF THE PUMP AT THE ELEVATION OF PLACEMENT. (REFERENCE ACI MANUAL OF CONCRETE PRACTICE).
- ALL REINFORCING BARS SHALL BE GRADE 60 CONFORMING TO ASTM 615. LAP BARS WHERE REQUIRED USING CLASS B TENSION LAP SPLICES, OR 40 BAR DIAMETERS. DEVELOPMENT LENGTHS SHALL BE CRSI MINIMUM U.O.N.
- SEE S101 FOR COLUMN FOOTING SCHEDULE AND ADDITIONAL NOTES THAT APPLY.
- REFERENCE ARCHITECTURAL AND PLUMBING DRAWINGS FOR COORDINATION OF SLOPED FLOORS AT FLOOR DRAINS, AND DEPRESSED FLOOR SLAB LOCATIONS.
- LOCATE ALL WALLS AND MASONRY OPENINGS PER ARCHITECTURAL DRAWINGS.
- ARCHITECTURAL BACKGROUND IS SHOWN FOR REFERENCE ONLY. REFER TO ARCHITECTURAL DRAWINGS FOR EXACT LOCATIONS OF WALLS.
- THE CONTRACTOR SHALL COORDINATE AND VERIFY ALL DIMENSIONS & ELEVATIONS PRIOR TO STARTING CONSTRUCTION AND ANY DISCREPANCY SHALL BE BROUGHT TO THE ATTENTION OF THE ENGINEER OF RECORD.
- FLOOR SLAB IN GYM AREA SHALL BE DEPRESSED 2 17/32" TO RECEIVE THE CUSHIONED PLAY FINISH FLOOR. VERIFY WITH ARCHITECTURAL DRAWINGS ALL DETAILS OF DEPRESSION AT DOORWAY THRESHOLDS. CONTRACTOR SHALL VERIFY/COORDINATE REQUIRED SLAB DEPRESSION FOR PLAY FLOOR WITH ARCH. FLOOR FINISH SCHEDULE.
- SEE ARCHITECTURAL DRAWINGS FOR ALL POURED RAMP LOCATIONS AND DIMENSIONS, TYPICAL. SEE ARCHITECTURAL DRAWINGS FOR ALL POURED STAIR LOCATIONS AND DIMENSIONS, TYPICAL. CONSTRUCT ALL POURED RAMPS AND STAIRS IN ACCORDANCE WITH STRUCTURAL SECTIONS 6 & 8/S101 AND ARCHITECTURAL DRAWINGS. SEE 13/S101 FOR BOLLARD DETAIL. LOCATE ALL BOLLARDS PER ARCHITECTURAL DRAWINGS.
- ALL COLUMNS = HSS 8 x 8 x 1, TYP. U.O.N.

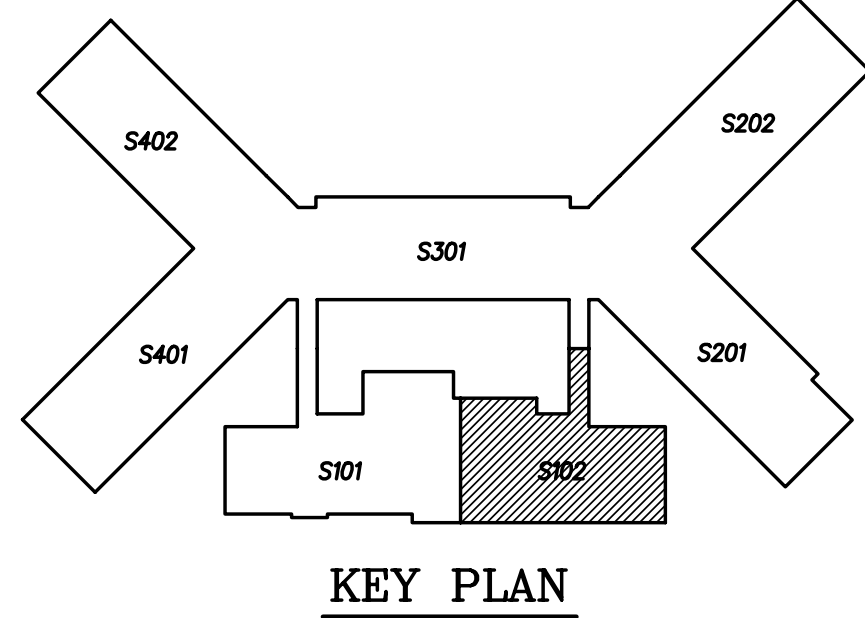

KEY PLAN


No.	Date	Revision

Hite associates
ARCHITECTURE / ENGINEERING / TECHNOLOGY
2600 Meridian Drive / Greenville, NC 27838 / tel (252) 757-0333

NE L.L.C. C-1024
QED
QUEEN ENGINEERING & DESIGN
REGISTERED PROFESSIONAL ENGINEER
STATE OF NORTH CAROLINA
18991
09 OCT 2024

Beaufort PK-3 School
BEAUFORT COUNTY SCHOOLS
Washington / North Carolina / 27889


Project No. 22344
Date: 09 OCT 2024
Drawing No. **S 102**

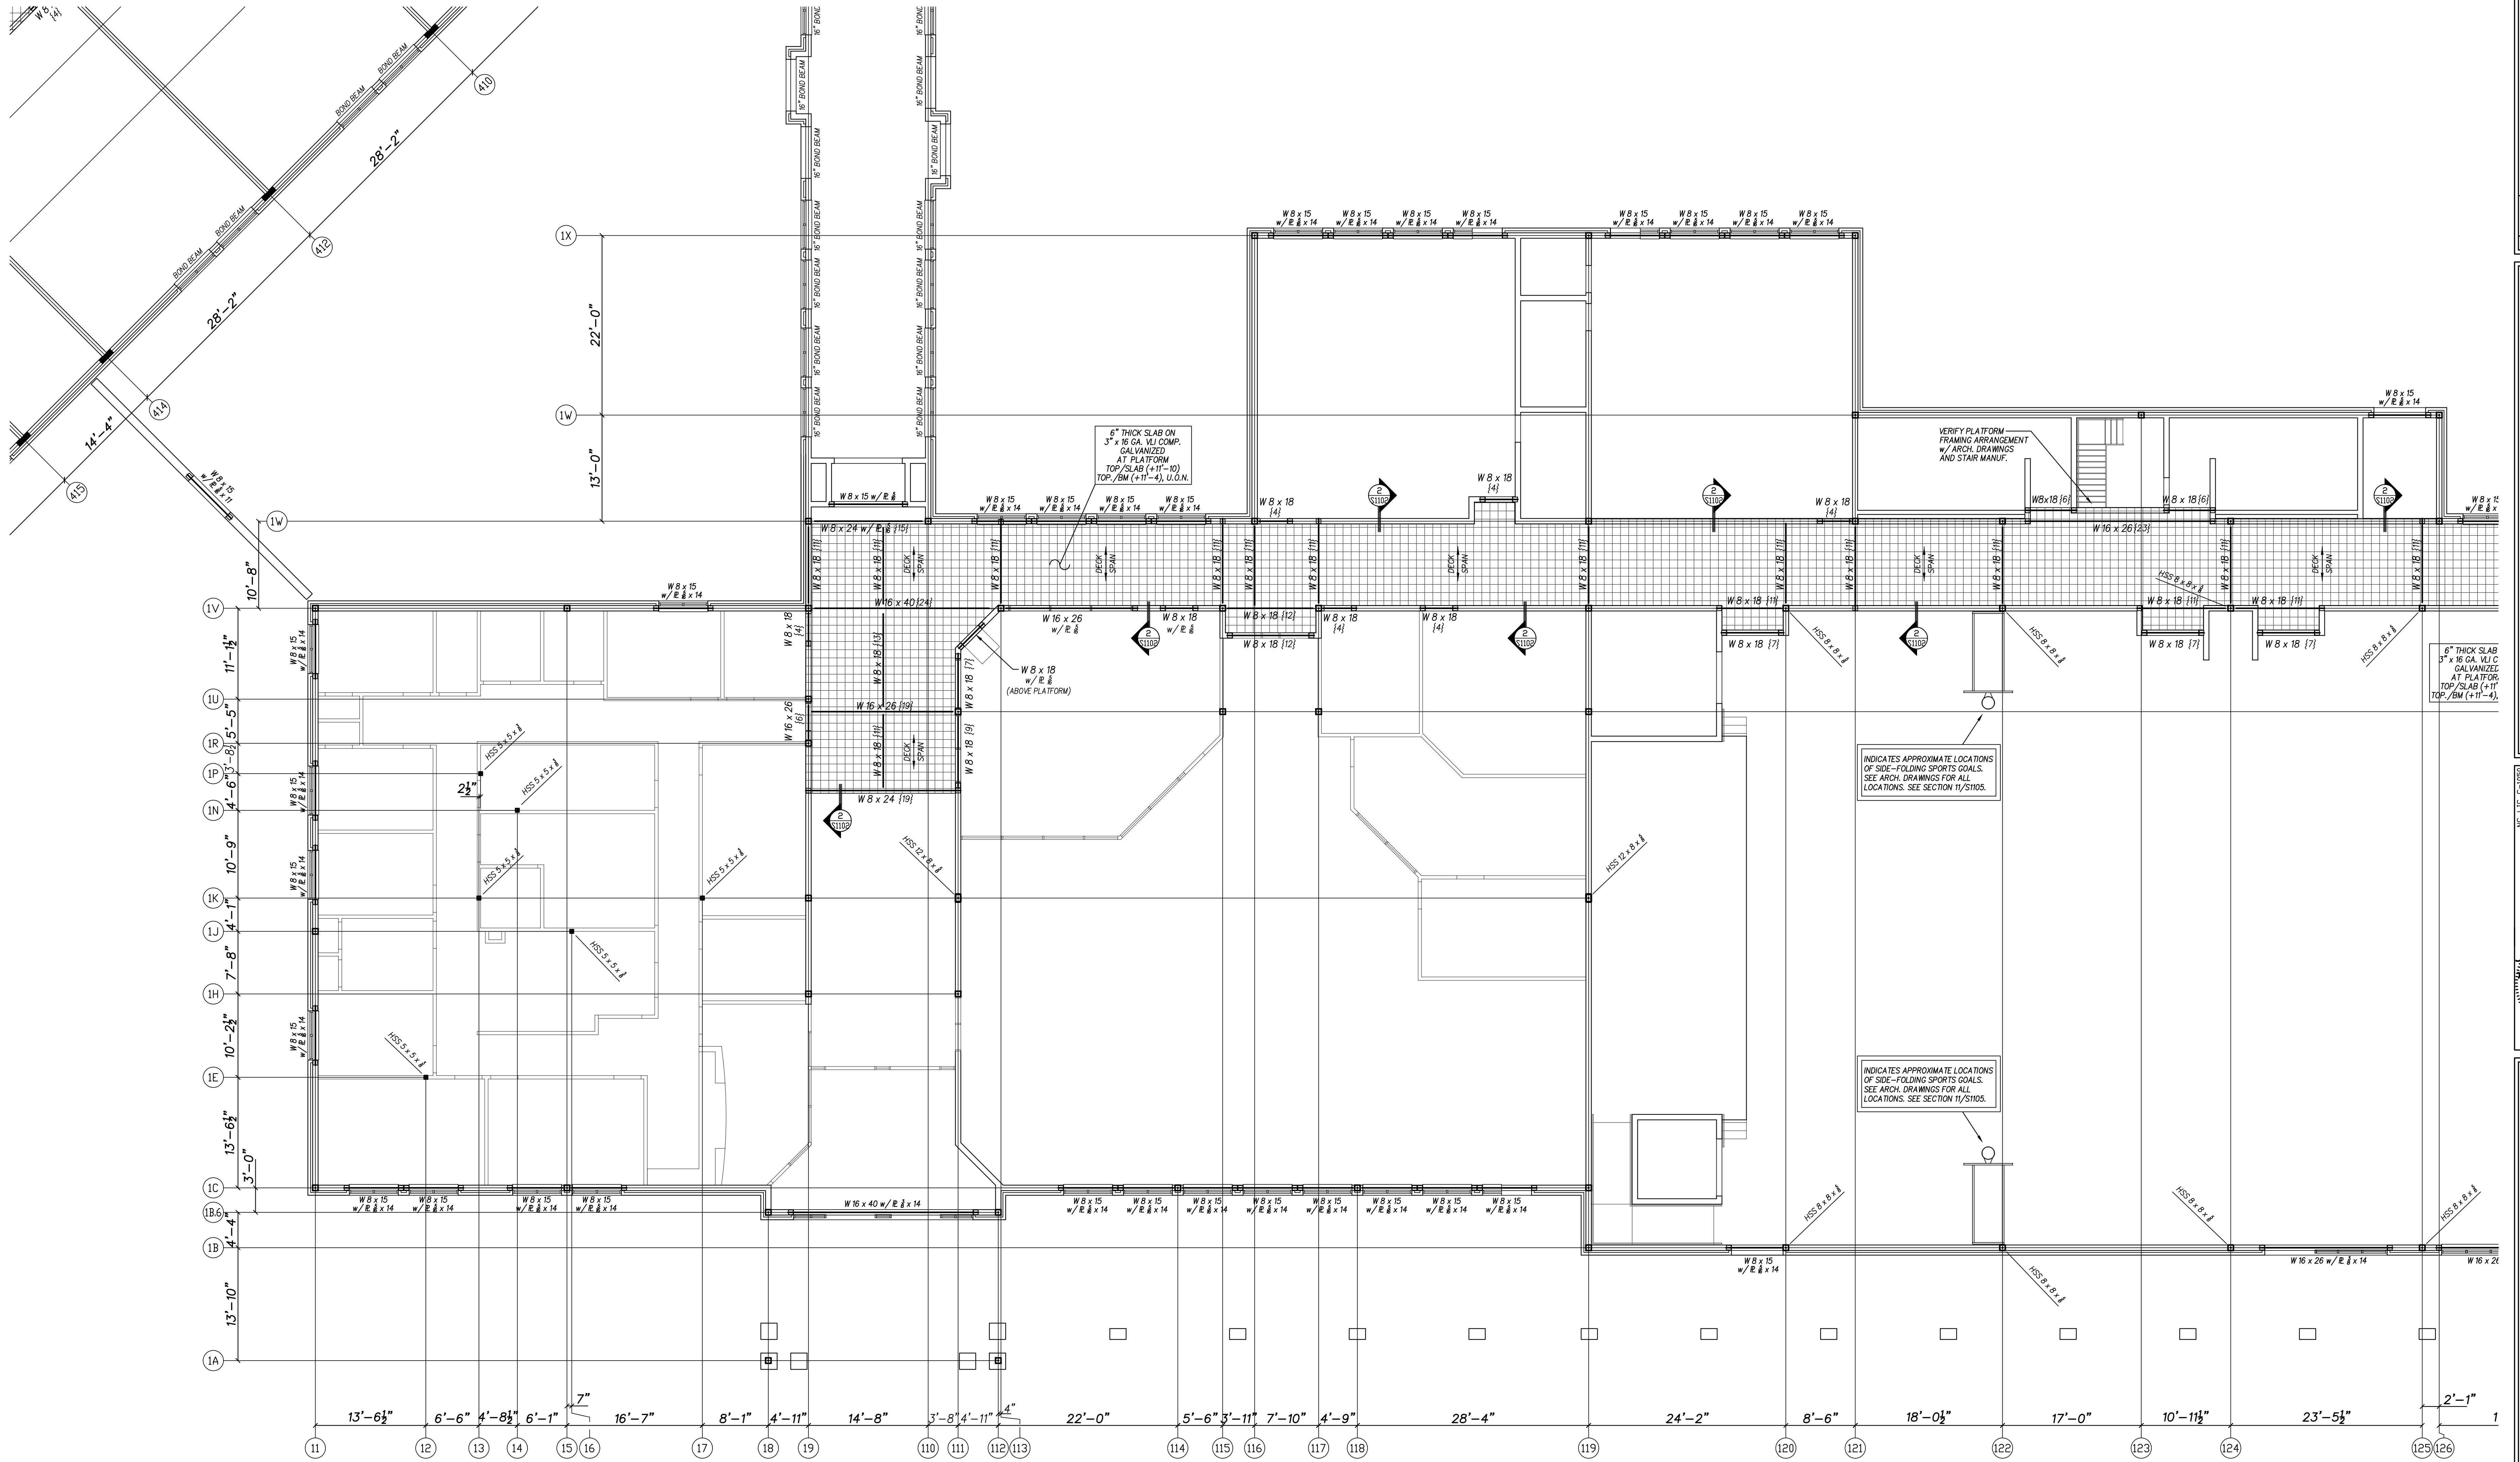


**AREA 100
INTERMEDIATE PART PLAN**

1" = 1'-0"

- 1.) SEE PLAN FOR TOP/UTILITY PLATFORM SLAB ELEVATION
- 2.) SEE S1102 FOR METAL FLOOR DECK FASTENING PATTERN, WHERE REQUIRED.
- 3.) SEE PLAN FOR SLAB THICKNESS AND FLOOR DECK SIZE. REINFORCE ALL NEW PLATFORM SLABS WITH 6x6 w2.9 x w2.9 WWM.
- 4.) ARCHITECTURAL BACKGROUND IS SHOWN FOR REFERENCE ONLY. REFER TO ARCHITECTURAL DRAWINGS FOR EXACT LOCATIONS OF WALLS.
- 5.) REFER TO ARCHITECTURAL DRAWINGS FOR ELEVATION OF ALL LINTELS.
- 6.) CONTRACTOR SHALL PROVIDE TEMPORARY SHORING AS REQUIRED FOR NEW COMPOSITE DECK SPANS GREATER THAN 10'-0".
- 7.) LOCATE ALL WALLS AND MASONRY OPENINGS PER ARCHITECTURAL DRAWINGS. WHERE REQUIRED, SEE S1102 FOR ALL NEW CMU LINTELS.
- 8.) NO FABRICATION OR ERECTION SHALL COMMENCE PRIOR TO THE APPROVAL OF ALL STRUCTURAL STEEL SHOP DRAWINGS BY THE ENGINEER OF RECORD.
- 9.) COORDINATE AND VERIFY ALL DECK EDGE LOCATIONS AND DIMENSIONS WITH ARCHITECTURAL DRAWINGS.
- 10.) REFERENCE ARCHITECTURAL AND PLUMBING DRAWINGS FOR COORDINATION OF SLOPED FLOORS AT FLOOR DRAINS, AND DEPRESSED FLOOR SLAB LOCATIONS.

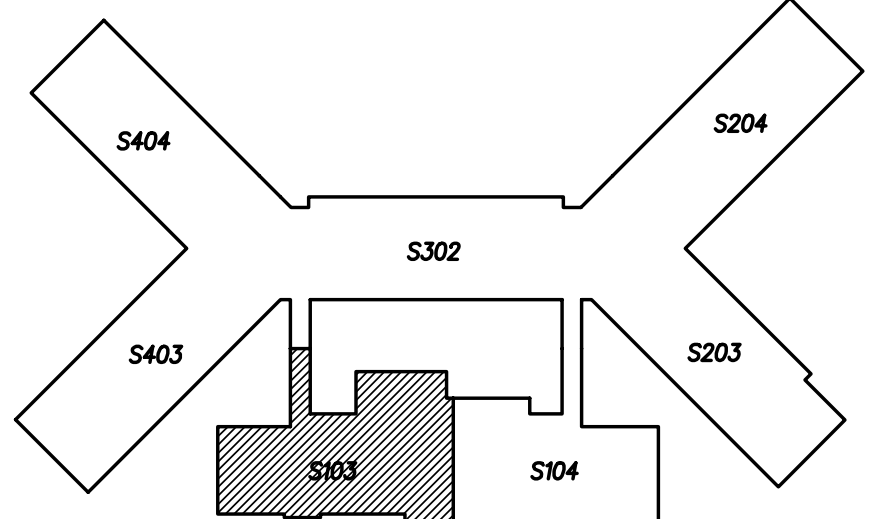

KEY PLAN

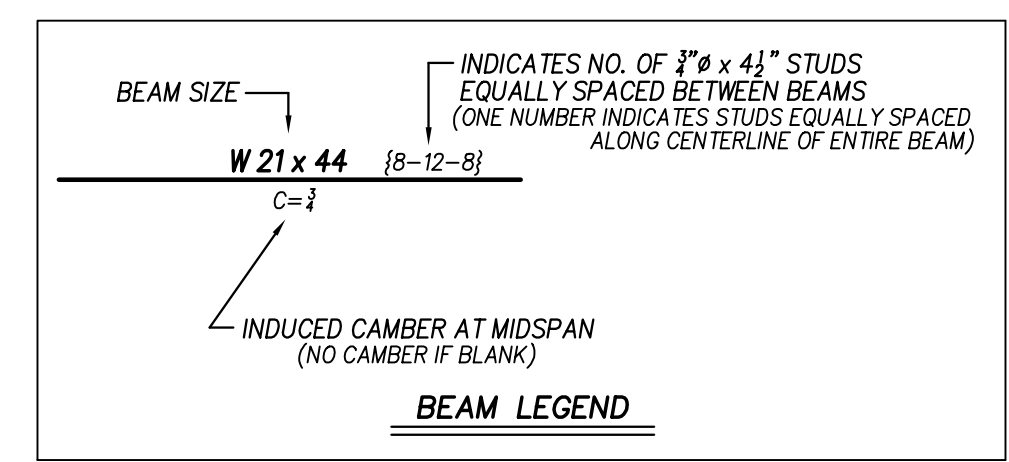


No.	Date	Revision

Hite associates
 ARCHITECTURE / ENGINEERING / TECHNOLOGY
 2600 Meridian Drive / Greenville, NC 27838 / tel (252) 757-0333

NE LIC C-1020
QED
 QUINN ENGINEERING & DESIGN
 1000 W. WILSON DRIVE, SUITE 200
 WASHINGTON, NC 27883
 ENGINEER
 BRUCE QUINN
 09 OCT 2024

Beaufort PK-3 School
 BEAUFORT COUNTY SCHOOLS
 Washington / North Carolina / 27889



Project No. 22344
 Date: 09 OCT 2024
 Drawing No. S 103

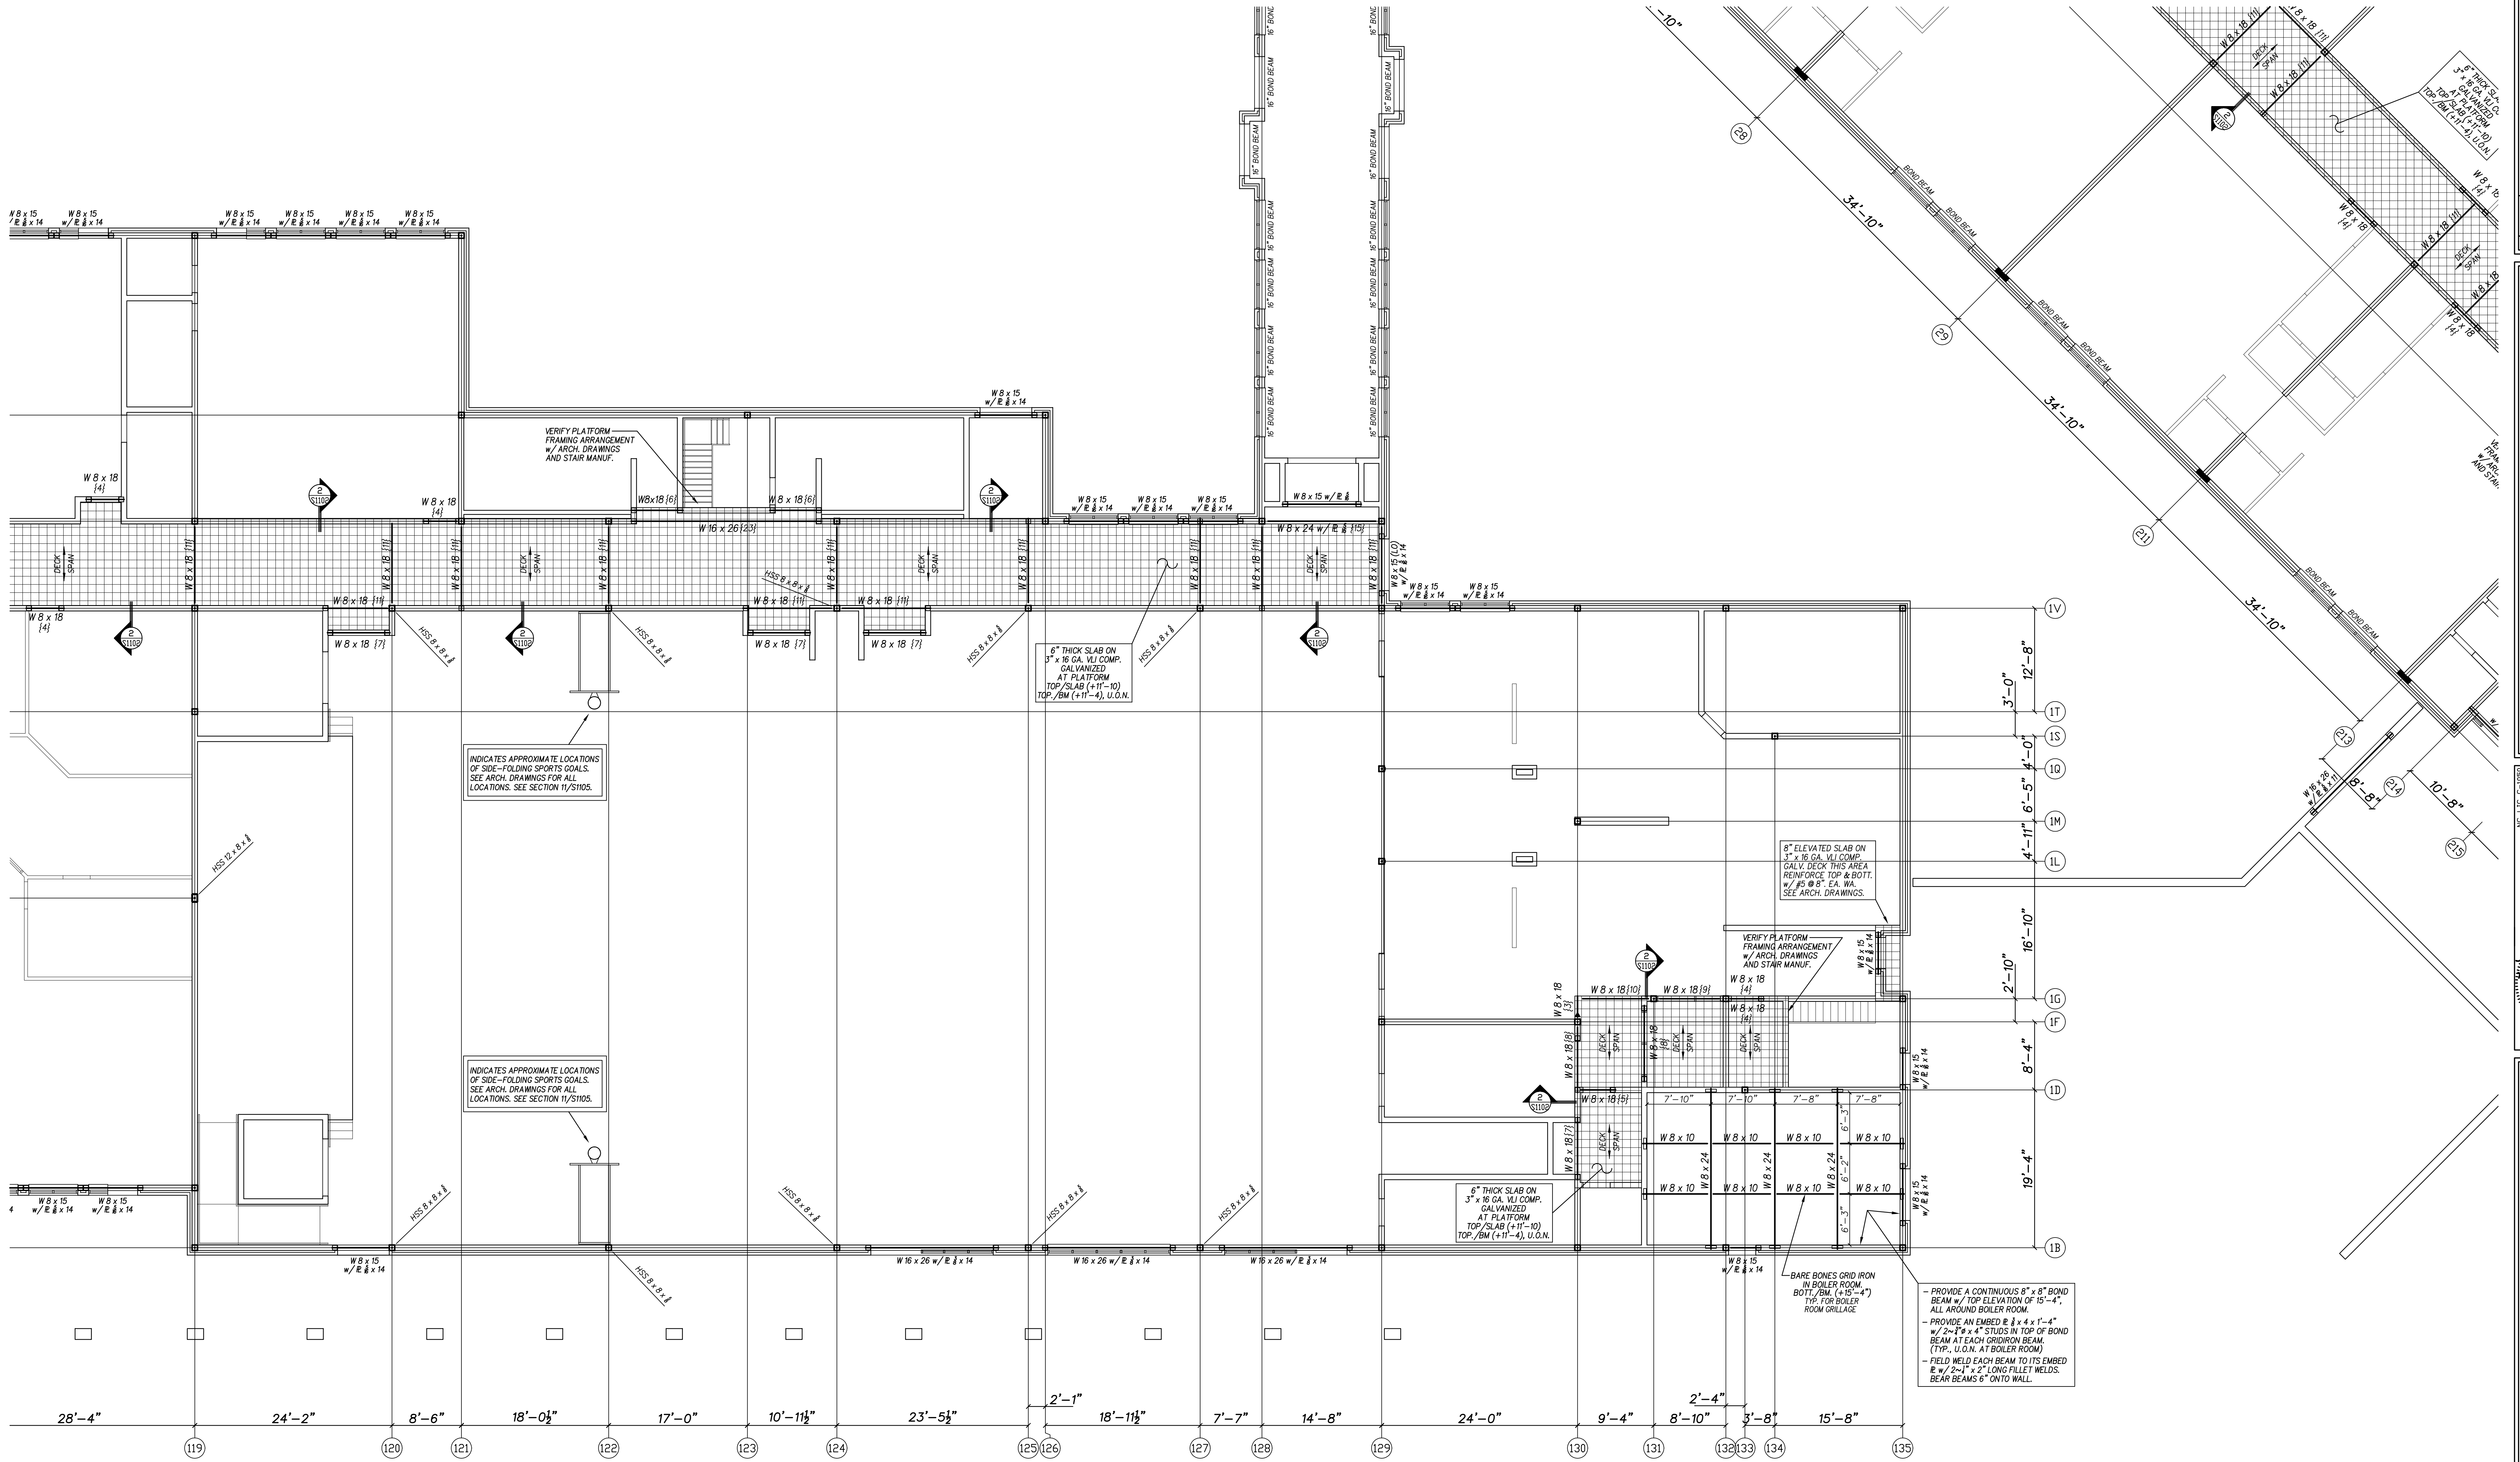

**AREA 100
INTERMEDIATE PART PLAN**

1" = 1'-0"

- 1.) SEE PLAN FOR TOP/UTILITY PLATFORM SLAB ELEVATION
- 2.) SEE S102 FOR METAL FLOOR DECK FASTENING PATTERN, WHERE REQUIRED.
- 3.) SEE PLAN FOR SLAB THICKNESS AND FLOOR DECK SIZE. REINFORCE ALL NEW PLATFORM SLABS WITH 6x6 w/2.9 x w/2.9 WWM.
- 4.) ARCHITECTURAL BACKGROUND IS SHOWN FOR REFERENCE ONLY. REFER TO ARCHITECTURAL DRAWINGS FOR EXACT LOCATIONS OF WALLS.
- 5.) REFER TO ARCHITECTURAL DRAWINGS FOR ELEVATION OF ALL LINTELS.
- 6.) CONTRACTOR SHALL PROVIDE TEMPORARY SHORING AS REQUIRED FOR NEW COMPOSITE DECK SPANS GREATER THAN 10'-0".
- 7.) LOCATE ALL WALLS AND MASONRY OPENINGS PER ARCHITECTURAL DRAWINGS, WHERE REQUIRED, SEE S102 FOR ALL NEW CMU LINTELS.
- 8.) NO FABRICATION OR ERECTION SHALL COMMENCE PRIOR TO THE APPROVAL OF ALL STRUCTURAL STEEL SHOP DRAWINGS BY THE ENGINEER OF RECORD.
- 9.) COORDINATE AND VERIFY ALL DECK EDGE LOCATIONS AND DIMENSIONS WITH ARCHITECTURAL DRAWINGS.
- 10.) REFERENCE ARCHITECTURAL AND PLUMBING DRAWINGS FOR COORDINATION OF SLOPED FLOORS AT FLOOR DRAINS, AND DEPRESSED FLOOR SLAB LOCATIONS.

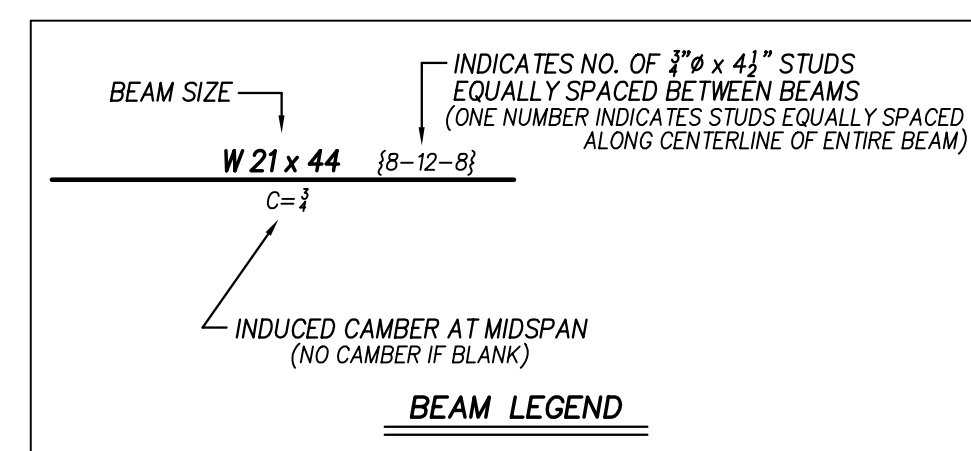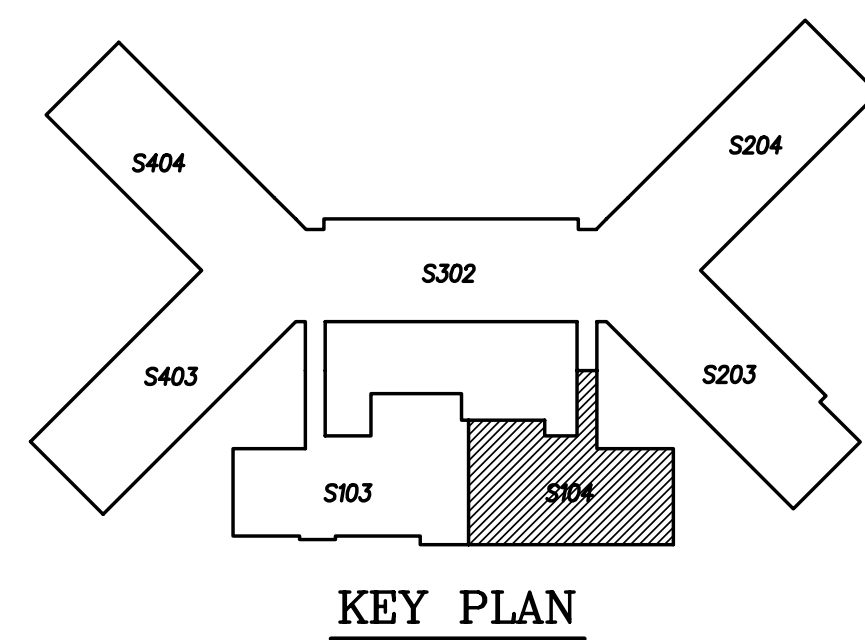



No.	Date	Revision

Hite associates
ARCHITECTURE / ENGINEERING / TECHNOLOGY
2600 Meridian Drive / Greenville, NC 27838 / tel (252) 757-0333

NE LIC. C-1020
QED
QUINN ENGINEERING & DESIGN
REGISTERED PROFESSIONAL ENGINEER
STATE OF NORTH CAROLINA
1989
ENGINEER
BRUCE QUINN
09 OCT 2024


Beaufort PK-3 School
BEAUFORT COUNTY SCHOOLS
Washington / North Carolina / 27869

Project No. 22344
Date: 09 OCT 2024
Drawing No. S 104

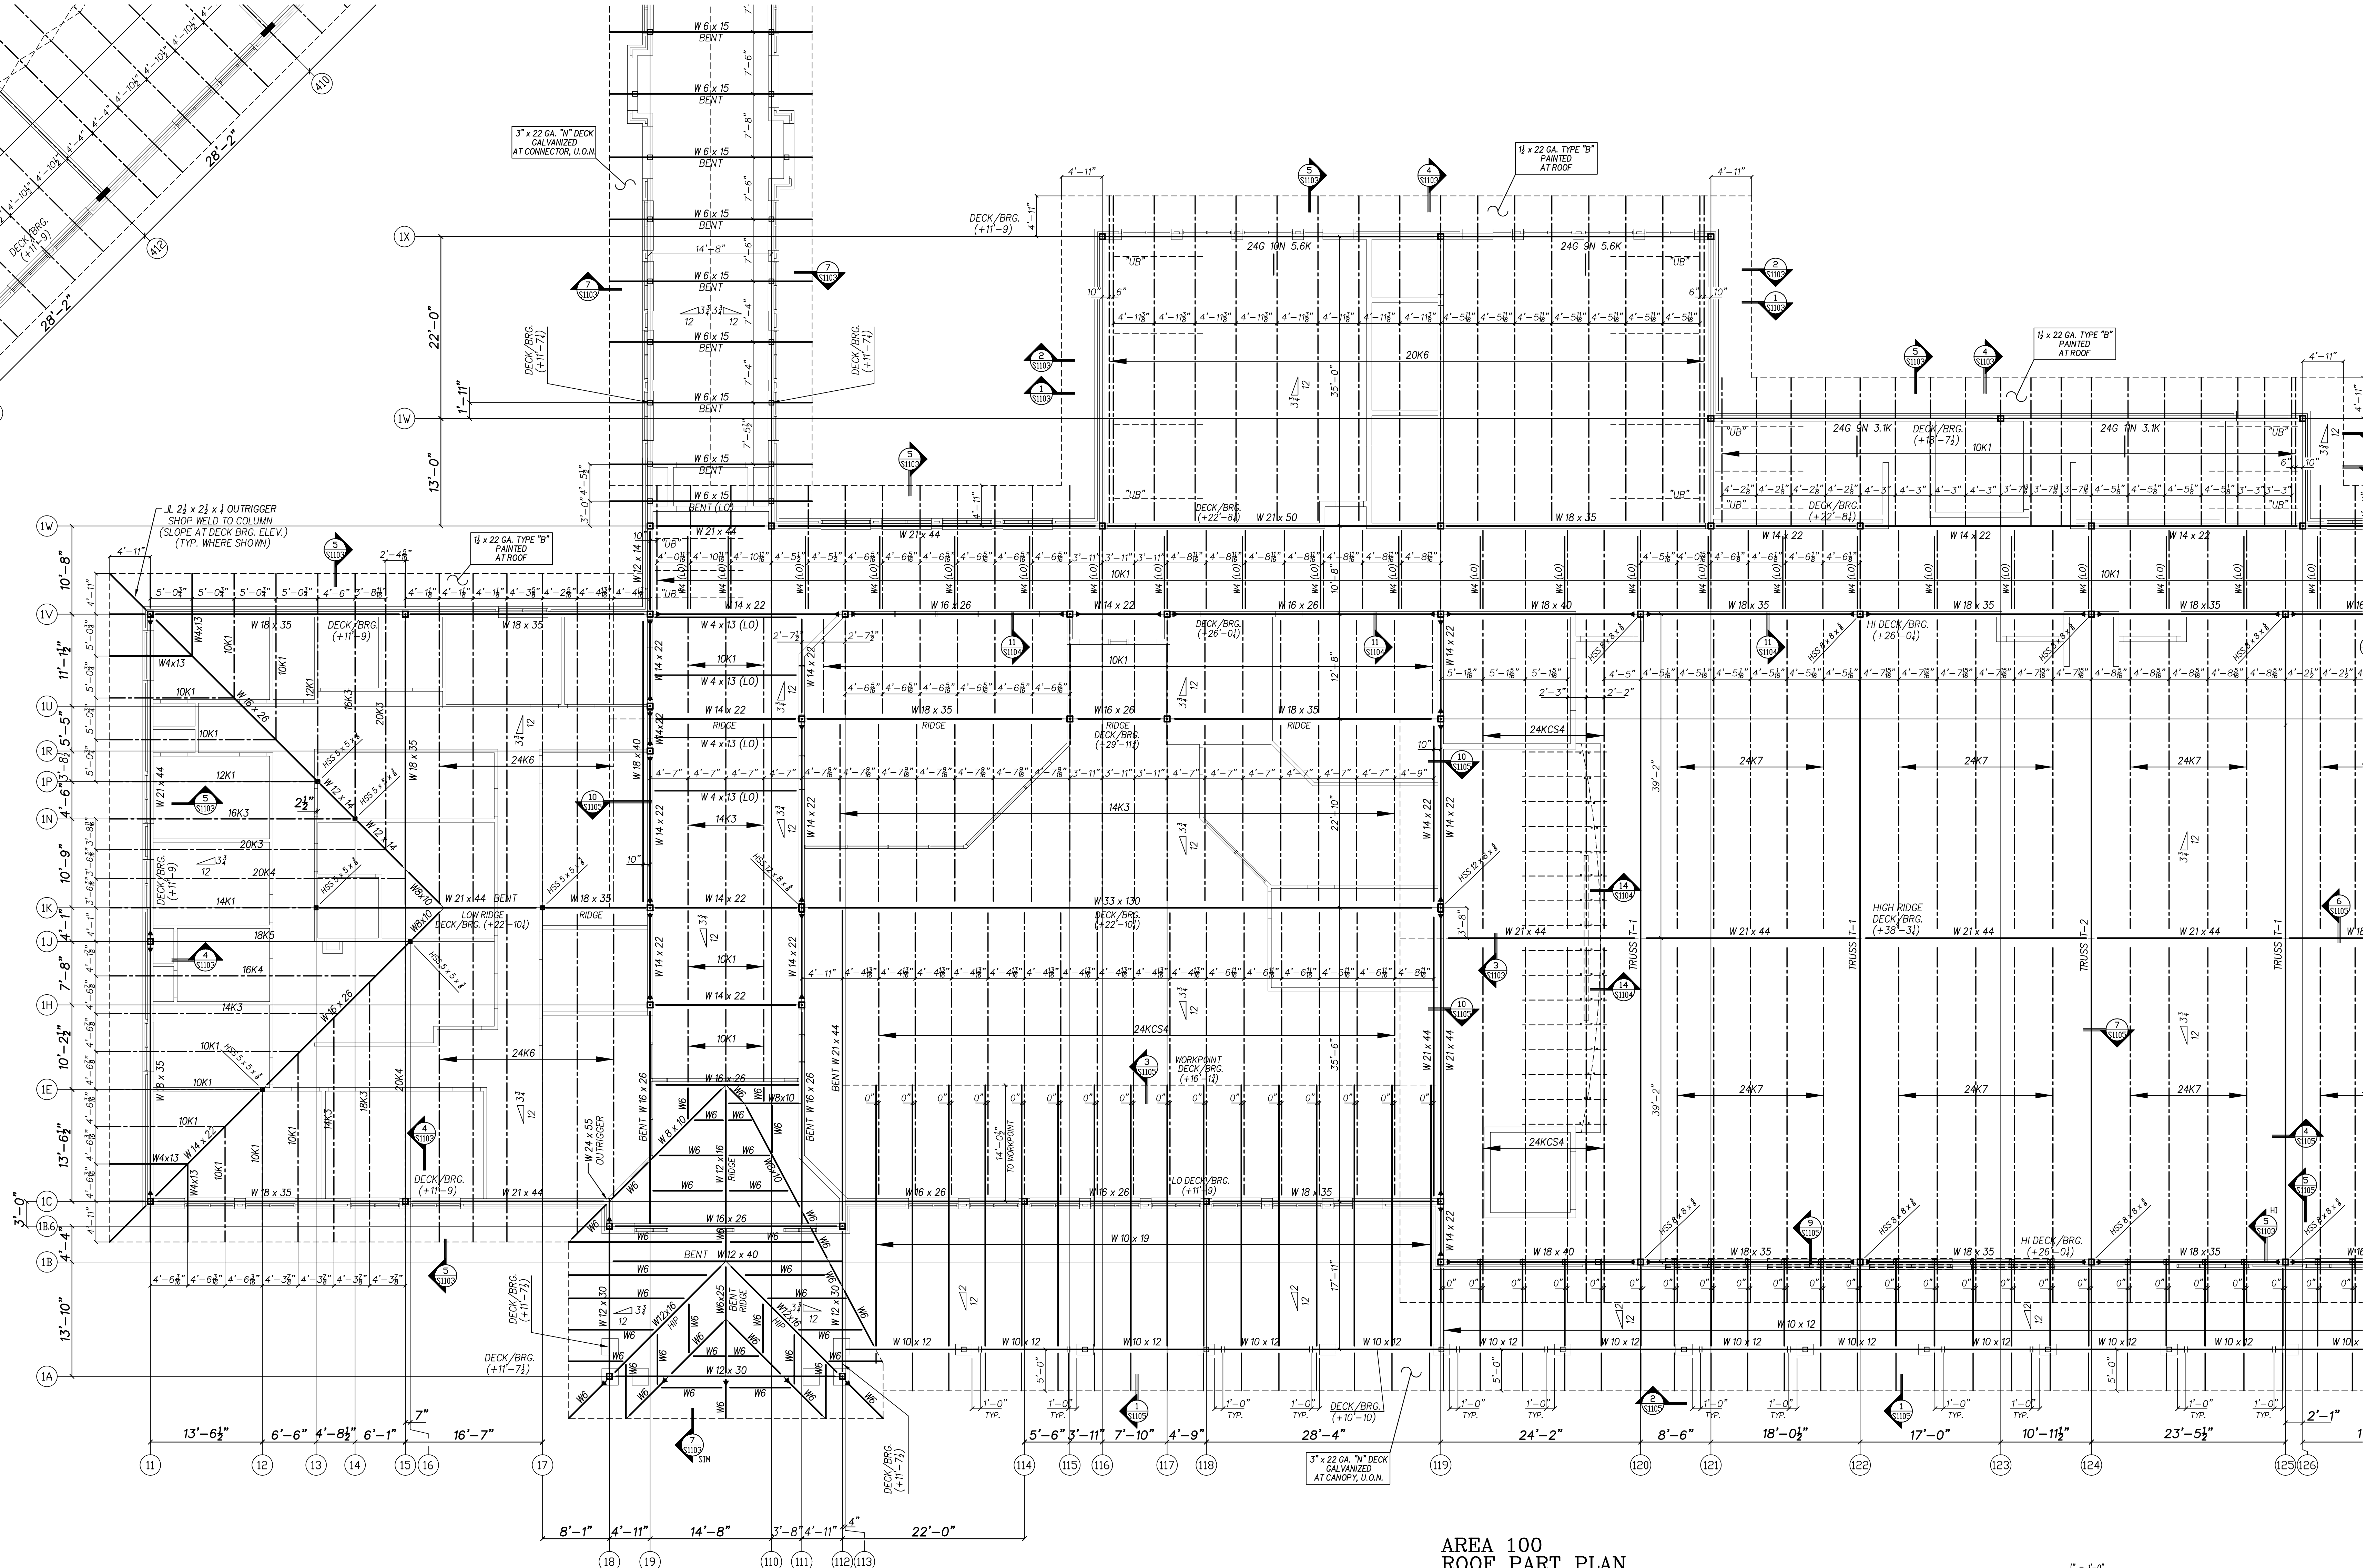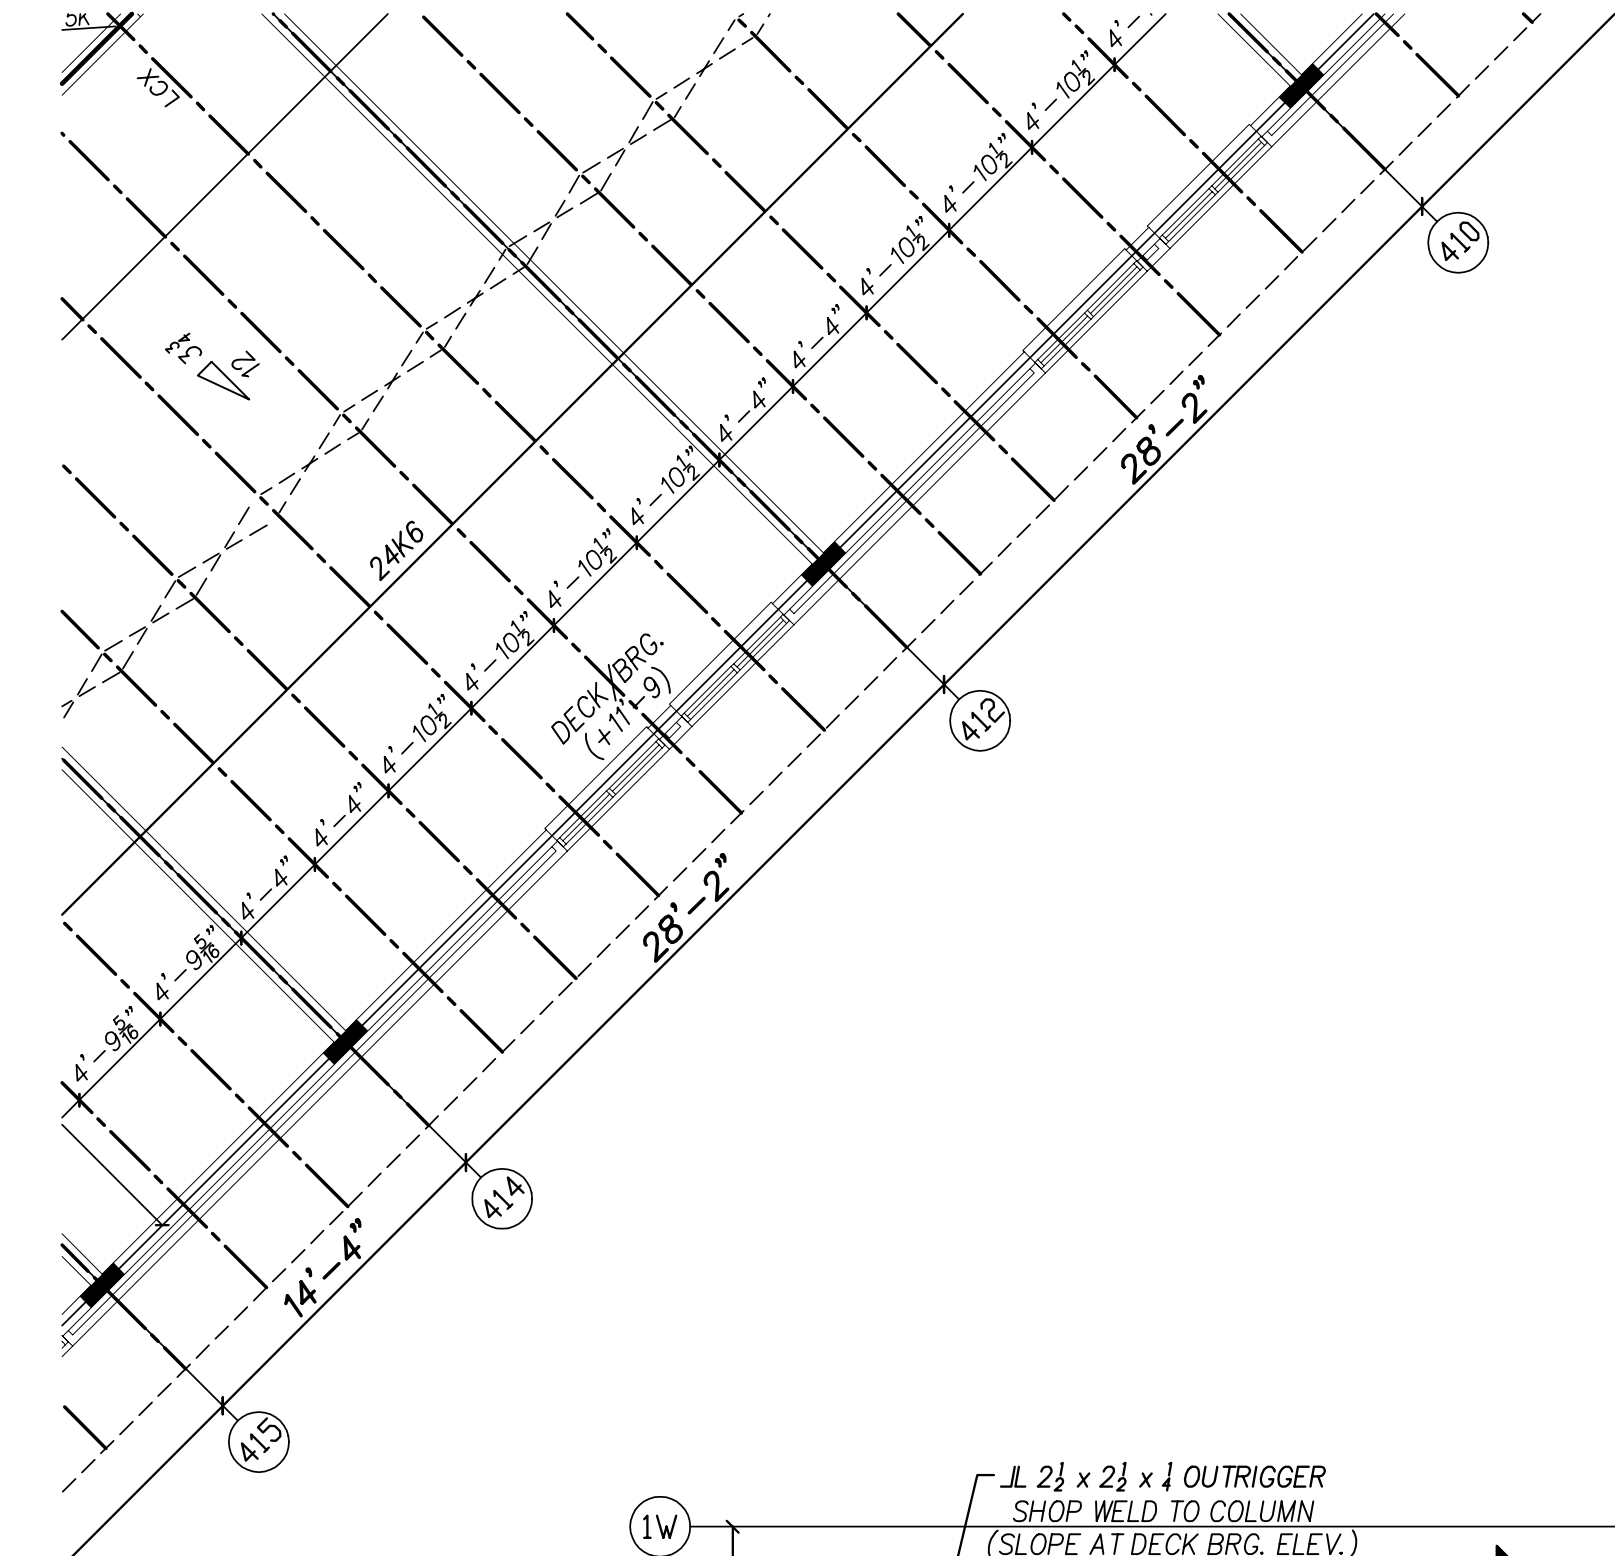

**AREA 100
ROOF PART PLAN**

- 1.) METAL ROOF DECK IS 1/2" x 22 GA TYPE "B" PAINTED M.R.D., TYP. U.O.N. FOR ATTACHMENT, SEE TYPICAL M.R.D. FASTENING DETAIL ON S102.
- 2.) ELEV. NOTED () ARE ABOVE REFERENCED FINISHED FLOOR.
- 3.) METAL ROOF DECK IS TO BE USED TO TRANSMIT LATERAL LOADS TO WALLS. SEE TYP. DECK FASTENING PATTERN ON S102.
- 4.) JOIST SUPPLIER SHALL DESIGN JOISTS FOR ADDITIONAL POINT LOADS FROM ROOF TOP MECHANICAL UNITS (IF REQUIRED). CONTRACTOR SHALL VERIFY SIZE AND WEIGHT OF UNITS AND REPORT THIS INFORMATION TO THE STRUCTURAL ENGINEER OF RECORD, IF REQUIRED.
- 5.) ALL WIDE FLANGE BEAMS TO BE "A50" STEEL.
- 6.) SEE S1021 FOR NET UPLIFT DESIGN LOADING FOR ALL JOISTS AND GIRDERS.
- 7.) "UB" INDICATES UPLIFT BRIDGING TO BE LOCATED AT THE FIRST BOTTOM CHORD PANEL POINT OF JOIST.
- 8.) NO FABRICATION OR ERECTION SHALL COMMENCE PRIOR TO THE APPROVAL OF ALL STRUCTURAL STEEL SHOP DRAWINGS BY THE ENGINEER OF RECORD.
- 9.) JOIST MANUFACTURER SHALL ADJUST JOIST SEATS AS REQUIRED TO MAINTAIN DECK BEARING ELEVATIONS SHOWN ON THE CONTRACT DRAWINGS.
- 10.) COORDINATE AND VERIFY ALL DECK ELEV. LOCATIONS AND DIMENSIONS WITH ARCHITECTURAL DRAWINGS.
- 11.) SEE S1013 AND S1013 FOR LCK CONFIGURATION.
- 12.) SEE S1013 FOR BCK CONFIGURATION.
- 13.) PROVIDE CONTINUOUS HORIZONTAL AND/OR DIAGONAL CROSS BRIDGING AT LOCATIONS SHOWN ON THE DRAWINGS. WHERE S4 STANDARDS REQUIRE ADDITIONAL LINES OF BRIDGING IN ADDITION TO THOSE SHOWN ON THE DRAWINGS THE ADDITIONAL LINES SHALL BE PROVIDED.
- 14.) () INDICATES THAT JOIST AND GIRDER SUPPLIER SHALL DESIGN JOIST WITH DESIGN END MOMENT OF 500 IN-K AT END OF JOIST. SEE SECTION S1014 FOR ADDITIONAL NOTES THAT APPLY. TYPICAL AT "SM" JOIST DESIGNATION.
- 15.) UNLESS OTHERWISE NOTED, ALL JOIST ORDERS SUPPORTING W4 PIPING SUPPORT BEAMS SHALL BE DESIGNED BY THEIR SUPPLIER TO SUPPORT AN ADDITIONAL 1.5 KIPS UNFACTORED SERVICE LOAD AT EACH W4 SUPPORT POINT.
- 16.) LOCATE ALL WALLS AND MASONRY OPENINGS PER ARCHITECTURAL DRAWINGS.
- 17.) L6 = L6 x 6 x 8 TYP. U.O.N.
- 18.) W4 = W4 x 13 TYP. U.O.N.
- 19.) () INDICATES MOMENT CONNECTION. SEE S1014.
- 20.) SEE S1013 FOR BENT BEAM WELDMENTS.
- 21.) W6 = W6 x 9 TYP. U.O.N.
- 22.) HSS3 = HSS 3 x 3 x 4 TYP. U.O.N.

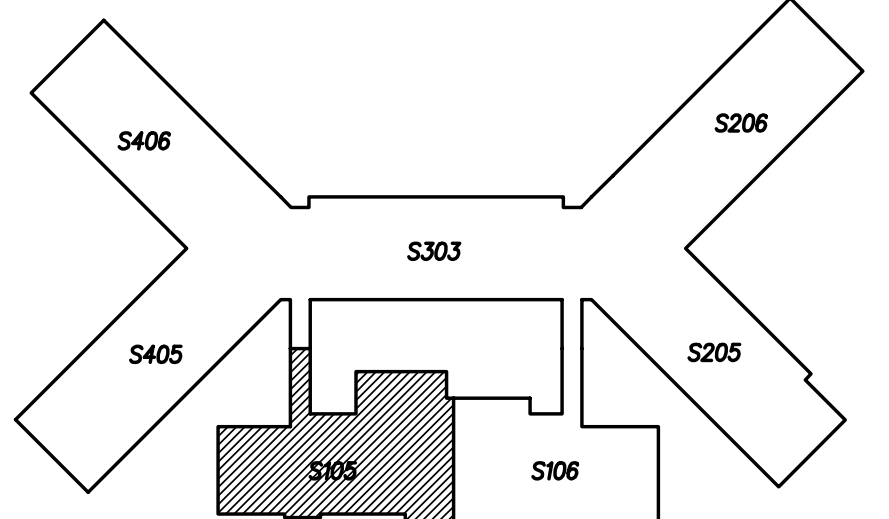

KEY PLAN



No.	Date	Revision

Hite associates
ARCHITECTURE / ENGINEERING / TECHNOLOGY
2600 Meridian Drive / Greenville, NC 27838 / tel (252) 757-0333

QED
QUEEN ENGINEERING & DESIGN
REGISTERED PROFESSIONAL ENGINEER
STATE OF NORTH CAROLINA
18891
09 OCT 2024

Beaufort PK-3 School
BEAUFORT COUNTY SCHOOLS
Washington / North Carolina / 27889

Project No. 22344
Date: 09 OCT 2024
Drawing No. S 105

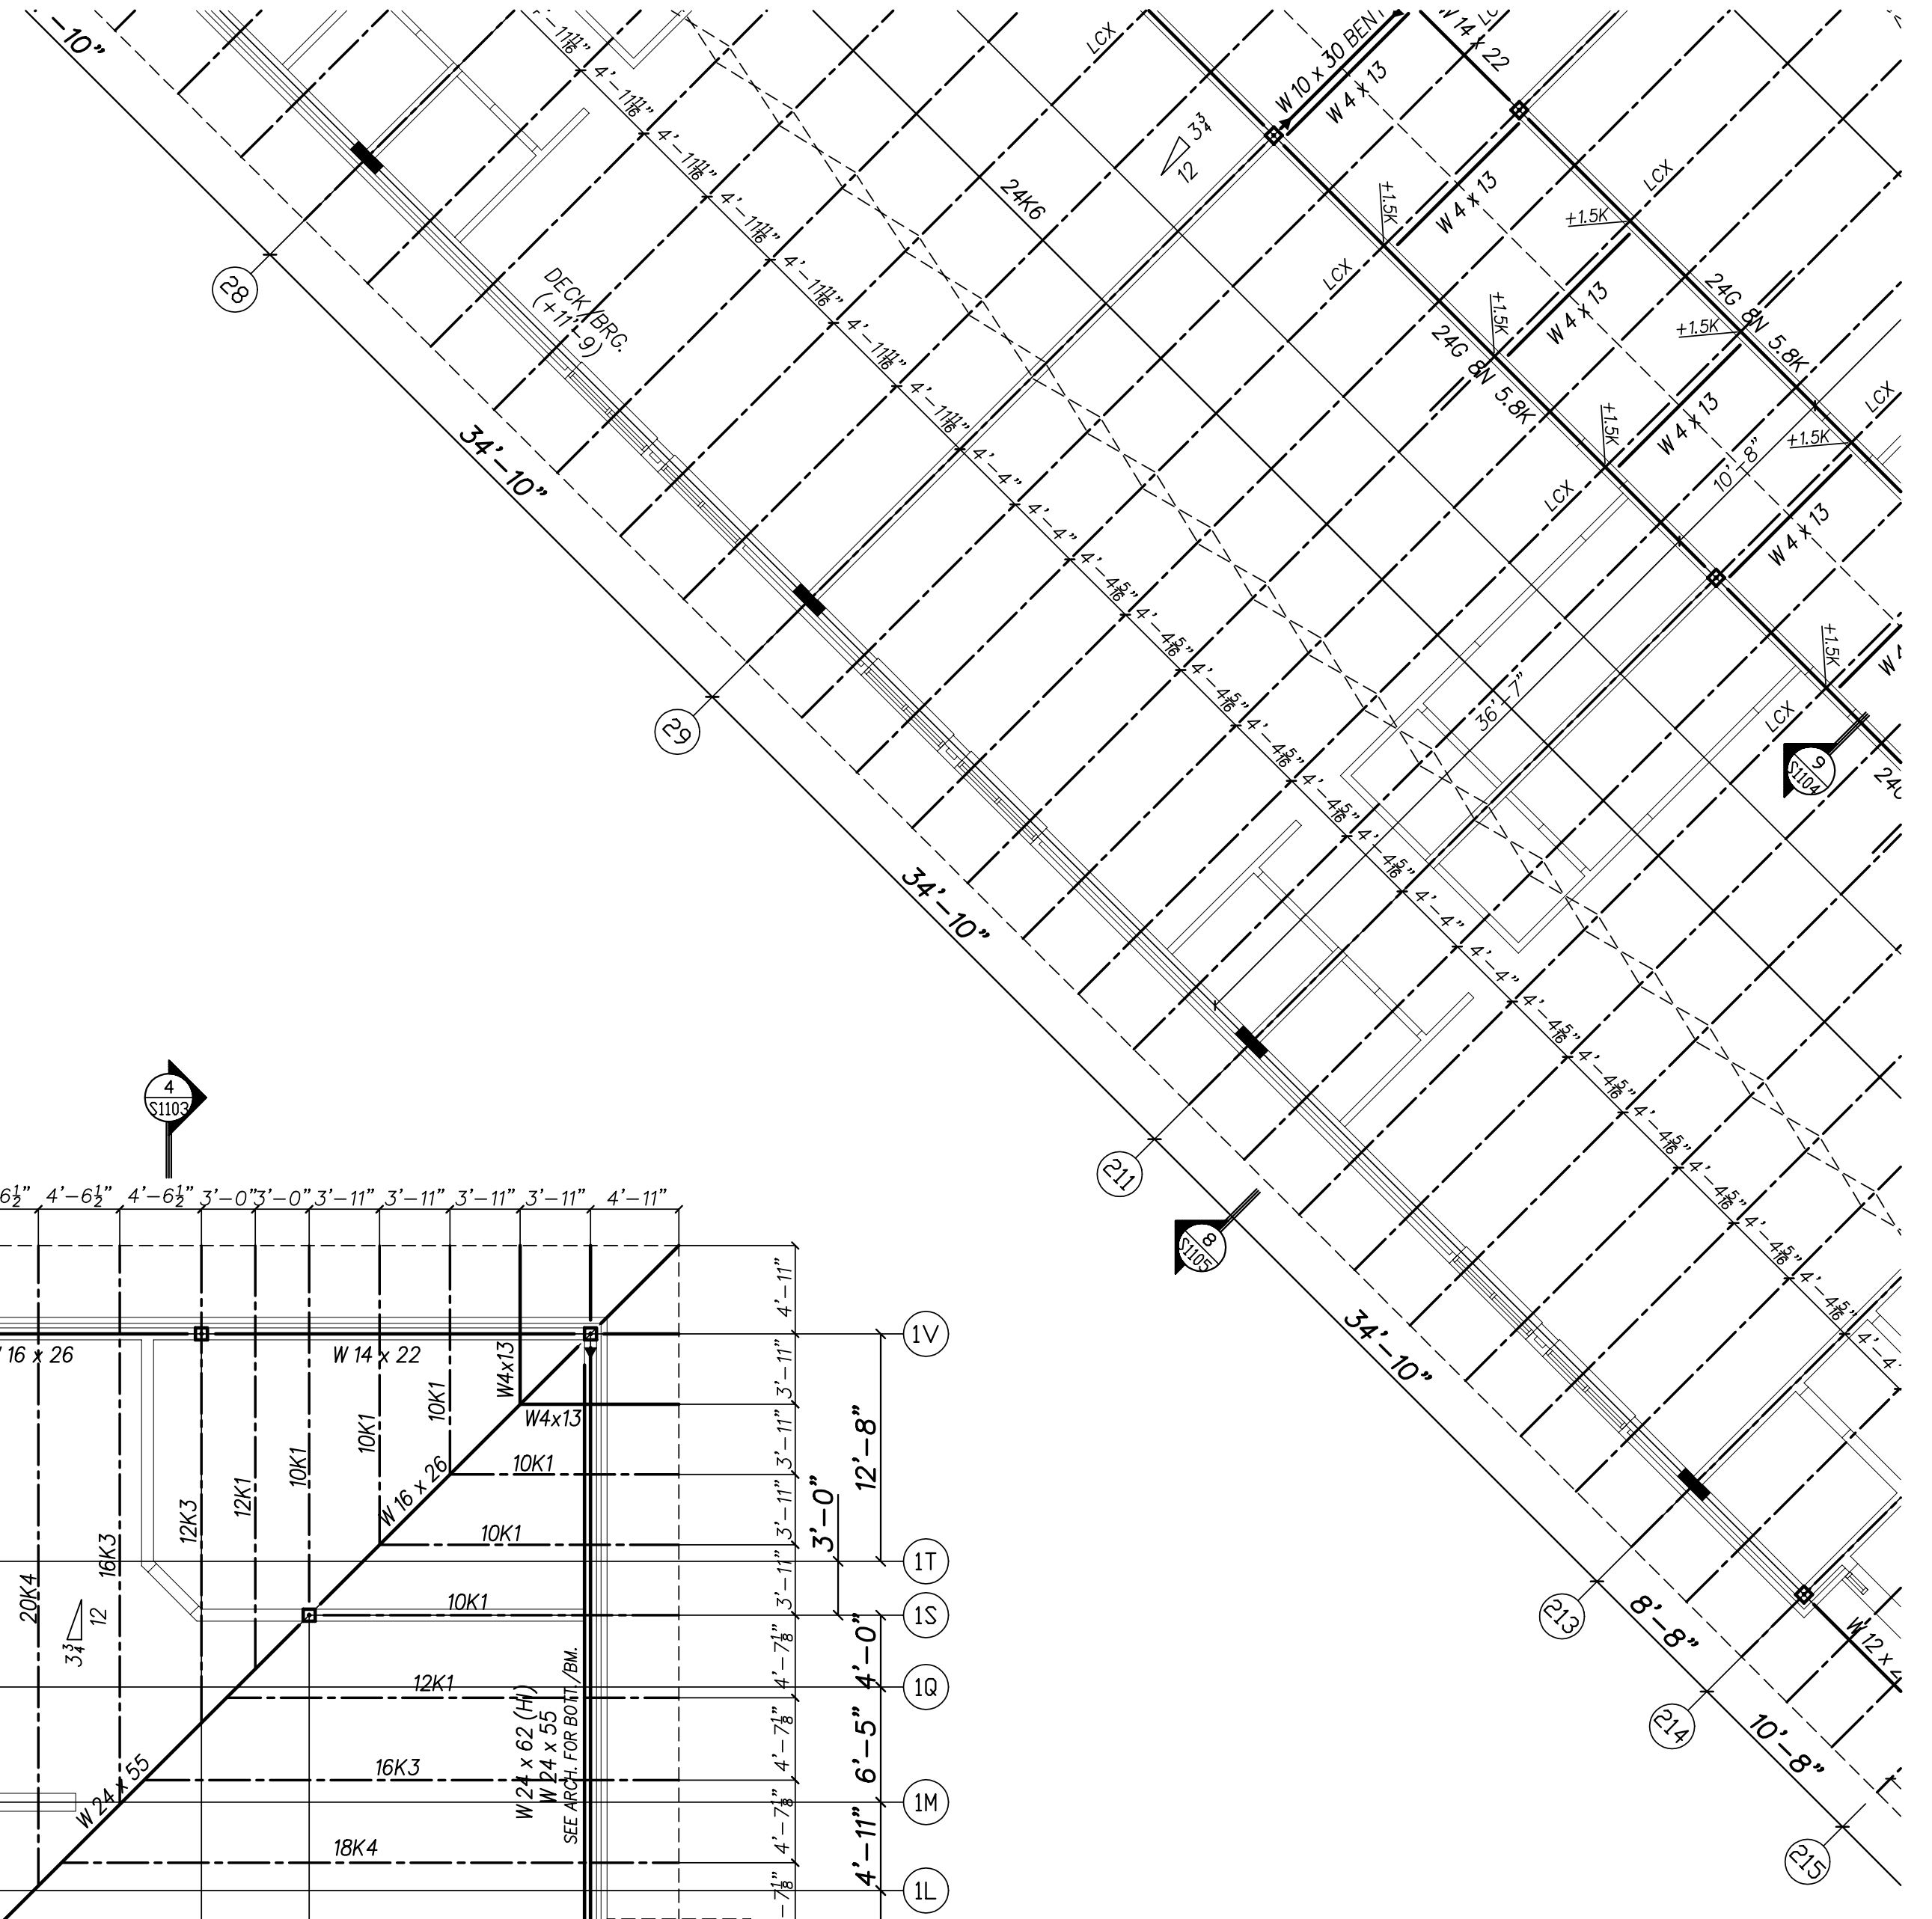
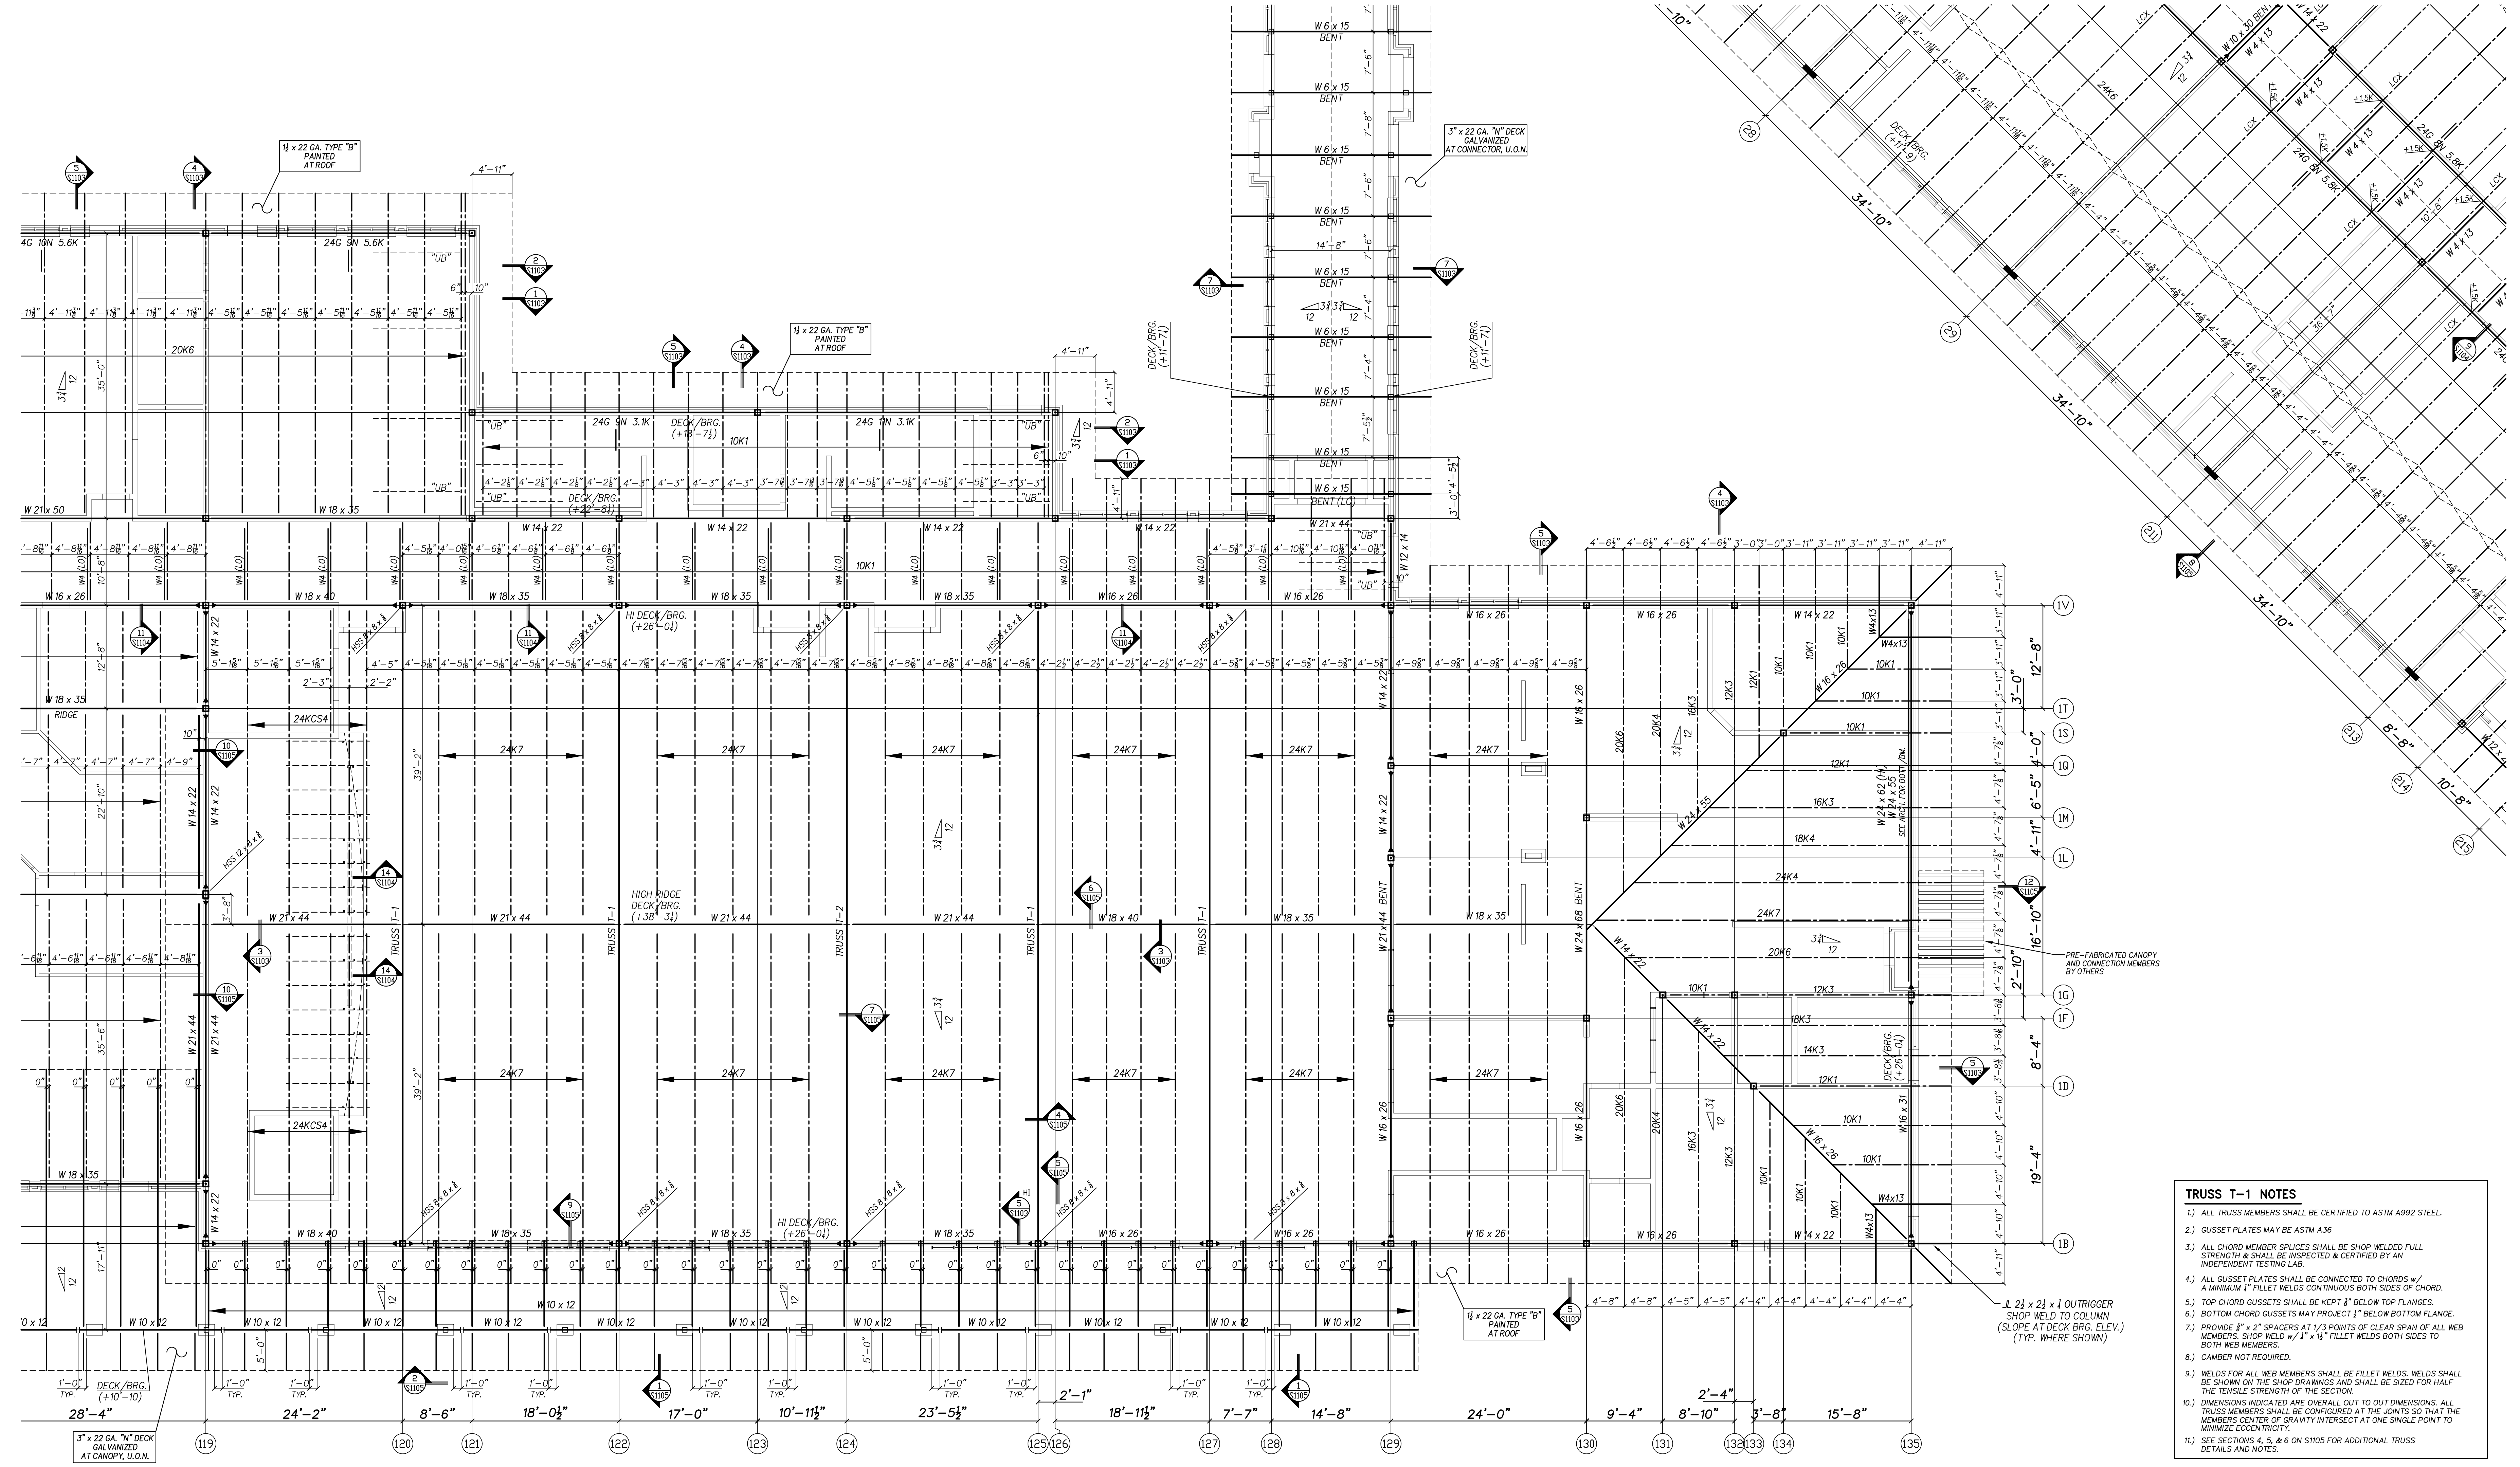


TRUSS T-1 NOTES

- 1) ALL TRUSS MEMBERS SHALL BE CERTIFIED TO ASTM A992 STEEL.
- 2) GUSSET PLATES MAY BE ASTM A36
- 3) ALL CHORD MEMBER SPICES SHALL BE SHOP WELDED FULL STRENGTH & SHALL BE INSPECTED & CERTIFIED BY AN INDEPENDENT TESTING LAB.
- 4) ALL GUSSET PLATES SHALL BE CONNECTED TO CHORDS w/ A MINIMUM 1" FILLET WELDS CONTINUOUS BOTH SIDES OF CHORD.
- 5) TOP CHORD GUSSETS SHALL BE KEPT 1" BELOW TOP FLANGES.
- 6) BOTTOM CHORD GUSSETS MAY PROJECT 1" BELOW BOTTOM FLANGE.
- 7) PROVIDE 1" x 2" SPACERS AT 1/3 POINTS OF CLEAR SPAN OF ALL WEB MEMBERS. SHOP WELD w/ 1" x 1/2" FILLET WELDS BOTH SIDES TO BOTH WEB MEMBERS.
- 8) CAMBER NOT REQUIRED.
- 9) WELDS FOR ALL WEB MEMBERS SHALL BE FILLET WELDS. WELDS SHALL BE SHOWN ON THE SHOP DRAWINGS AND SHALL BE SIZED FOR HALF THE TENSILE STRENGTH OF THE SECTION.
- 10) DIMENSIONS INDICATED ARE OVERALL OUT TO OUT DIMENSIONS. ALL TRUSS MEMBERS SHALL BE CONFIGURED AT THE JOINTS SO THAT THE MEMBER'S CENTER OF GRAVITY INTERSECT AT ONE SINGLE POINT TO MINIMIZE ECCENTRICITY.
- 11) SEE SECTIONS 4, 5, & 6 ON S105 FOR ADDITIONAL TRUSS DETAILS AND NOTES.

AREA 100 ROOF PART PLAN

- 1) METAL ROOF DECK IS 1/2" x 22 GA TYPE 'B' PAINTED M.R.D., TYP. U.O.N. FOR ATTACHMENT, SEE TYPICAL M.R.D. FASTENING DETAIL ON S102.
- 2) ELEV. NOTED -) ARE ABOVE REFERENCED FINISHED FLOOR.
- 3) METAL ROOF DECK IS TO BE USED TO TRANSMIT LATERAL LOADS TO WALLS. SEE TYP. DECK FASTENING PATTERN ON S102.
- 4) JOIST SUPPLIER SHALL DESIGN JOISTS FOR ADDITIONAL POINT LOADS FROM ROOF TOP MECHANICAL UNITS (IF REQUIRED). CONTRACTOR SHALL VERIFY SIZE AND WEIGHT OF UNITS AND REPORT THIS INFORMATION TO THE STRUCTURAL ENGINEER OF RECORD, IF REQUIRED.
- 5) ALL WIDE FLANGE BEAMS TO BE 'A50' STEEL.
- 6) SEE S1021 FOR NET UPLIFT DESIGN LOADING FOR ALL JOISTS AND GIRDERS.
- 7) 'UB' INDICATES UPLIFT BRIDGING TO BE LOCATED AT THE FIRST BOTTOM CHORD PANEL POINT OF JOIST.
- 8) NO FABRICATION OR ERECTION SHALL COMMENCE PRIOR TO THE APPROVAL OF ALL STRUCTURAL STEEL SHOP DRAWINGS BY THE ENGINEER OF RECORD.
- 9) JOIST MANUFACTURER SHALL ADJUST JOIST SEATS AS REQUIRED TO MAINTAIN DECK BEARING ELEVATIONS SHOWN ON THE CONTRACT DRAWINGS.
- 10) COORDINATE AND VERIFY ALL DECK EDGE LOCATIONS AND DIMENSIONS WITH ARCHITECTURAL DRAWINGS.
- 11) SEE S1013 AND S1013 FOR LCX CONFIGURATION.
- 12) SEE 4/S103 FOR BOX CONFIGURATION.
- 13) PROVIDE CONTINUOUS HORIZONTAL AND/OR DIAGONAL CROSS BRIDGING AT LOCATIONS SHOWN ON THE DRAWINGS. WHERE SA STANDARDS REQUIRE ADDITIONAL LINES OF BRIDGING IN ADDITION TO THOSE SHOWN ON THE DRAWINGS THE ADDITIONAL LINES SHALL BE PROVIDED.
- 14) ⊗ INDICATES THAT JOIST AND GIRDER SUPPLIER SHALL DESIGN JOIST WITH DESIGN END MOMENT OF 500 IN-K AT END OF JOIST. SEE SECTION 8/S104 FOR ADDITIONAL NOTES THAT APPLY. TYPICAL AT 'SP' JOIST DESIGNATION.
- 15) UNLESS OTHERWISE NOTED, ALL JOIST GIRDERS SUPPORTING W4 PIPING SUPPORT BEAMS SHALL BE DESIGNED BY THEIR SUPPLIER TO SUPPORT AN ADDITIONAL 1.5 KIPS UNFACTORED SERVICE LOAD AT EACH W4 SUPPORT POINT.
- 16) LOCATE ALL WALLS AND MASONRY OPENINGS PER ARCHITECTURAL DRAWINGS.
- 17) L6 = L6 x 6 x 8, TYP. U.O.N.
- 18) W4 = W4 x 13, TYP. U.O.N.
- 19) ◀ ▶ INDICATES MOMENT CONNECTION. SEE 1/S104.
- 20) SEE 15/S103 FOR BENT BEAM WELDDINGS.
- 21) W8 = W8 x 9, TYP. U.O.N.
- 22) HSS3 = HSS 3 x 3 x 2, TYP. U.O.N.

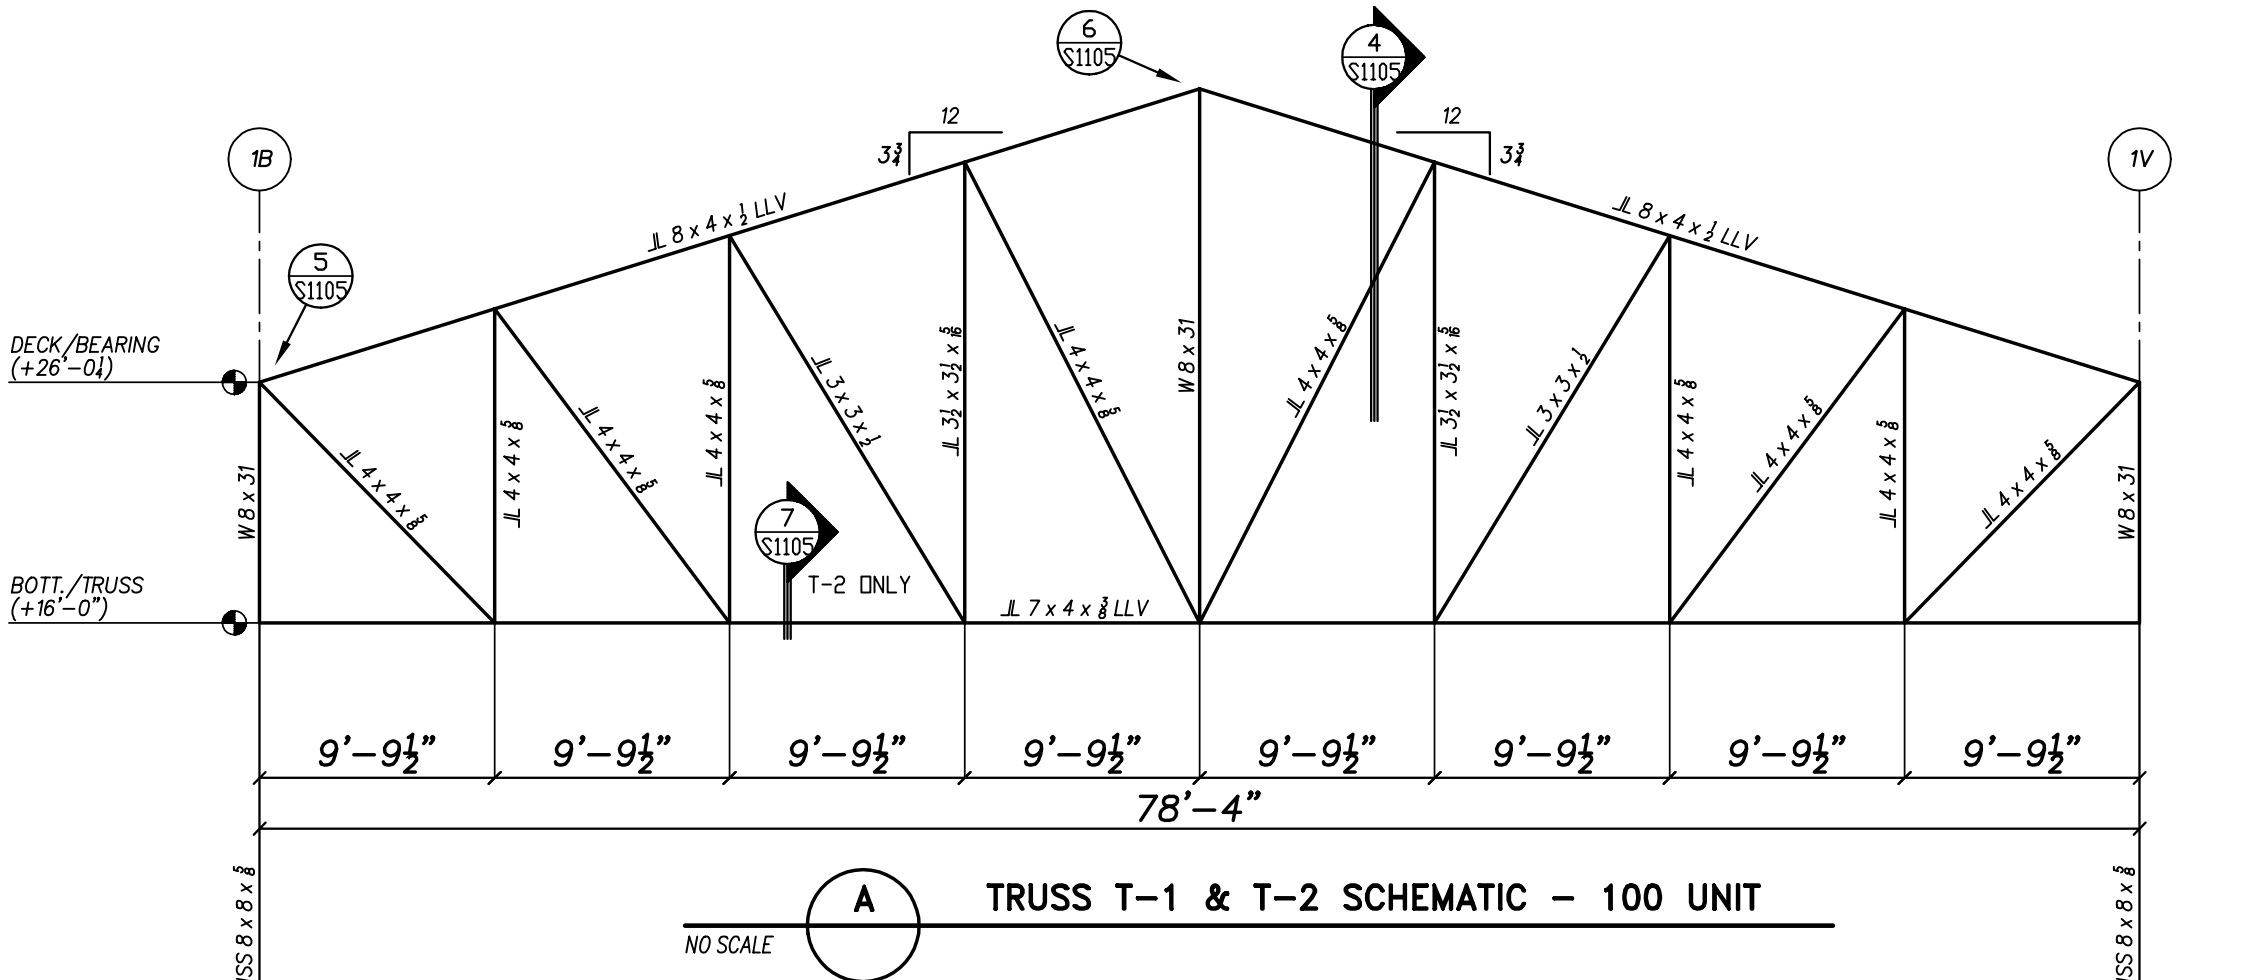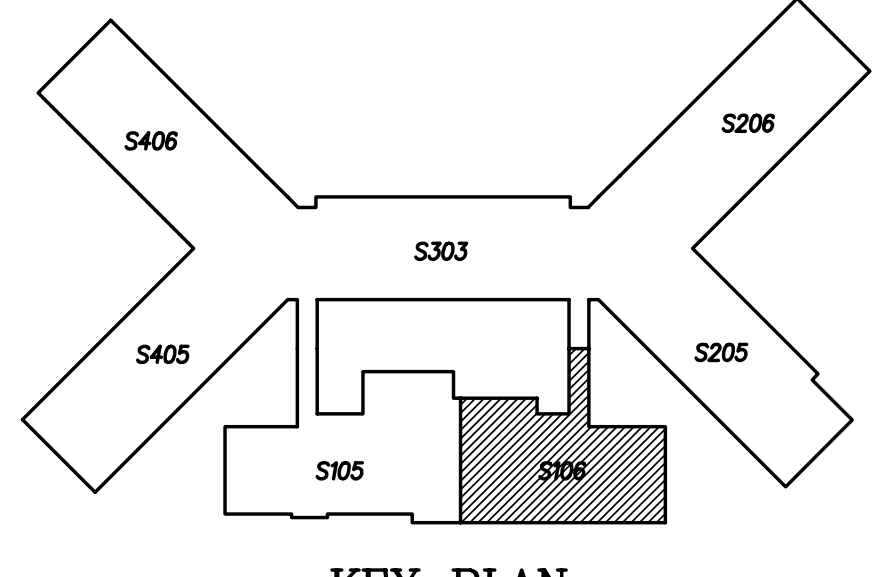

No.	Date	Revision

Hite associates
 ARCHITECTURE / ENGINEERING / TECHNOLOGY
 2600 Meridian Drive / Greenville, NC 27838 / tel (252) 757-0333

QED
 QUINN ENGINEERING & DESIGN
 1000 W. WILSON ST. SUITE 410
 WILSON, NC 27894
 ENGINEER
 BRUCE QUINN
 09 OCT 2024



Beaufort PK-3 School
 BEAUFORT COUNTY SCHOOLS
 Washington / North Carolina / 27889

Project No. 22344
 Date: 09 OCT 2024
 Drawing no. S 106

AREA 200 FOUNDATION PART PLAN

1" = 1'-0"

- 1.) FOOTING DESIGN BASED ON AN SOIL BRG. CAPACITY OF 1500 PSF. (GEOLOGICAL REPORT BY TERRACON (PROJECT NO. 72235092, DATED 17 NOV 2023) IF UNSTABLE, ORGANIC, WEAK OR OTHERWISE UNACCEPTABLE SOIL CONDITIONS ARE ENCOUNTERED DURING EXCAVATIONS OR SUBSEQUENT GEOTECHNICAL INVESTIGATIONS.
- 2.) ELEV. NOTED (-) ARE BELOW REFERENCE FINISHED FLOOR TO TOP/FOOTING. (+15.00')
- 3.) SLAB ON GRADE IS NORMAL WEIGHT CONCRETE WITH REINFORCED WITH 6x6 W1.4 x W1.4 W/M ON A 4" NO. 57/87 WASHED STONE AND 15 MIL POLY VAPOR BARRIER. TYP. U.O.N.
- 4.) ALL CONCRETE SHALL BE A MINIMUM STRENGTH OF 3000 PSI MEETING ACI 301 AND ACI 318. ALL CONCRETE SHALL BE MIXED, HANDLED, SAMPLED, TESTED, AND PLACED IN ACCORDANCE WITH ACI STANDARDS. ALL SAMPLES SUBJECT TO PUMPING SHALL BE TAKEN AT THE EXIT END OF THE PUMP AT THE ELEVATION OF PLACEMENT. (REFERENCE ACI MANUAL OF CONCRETE PRACTICE).
- 5.) ALL REINFORCING BARS SHALL BE GRADE 60 CONFORMING TO ASTM 615. LAP BARS WHERE REQUIRED USING CLASS B TENSION LAP SPICES, OR 40 BAR DIAMETERS. DEVELOPMENT LENGTHS SHALL BE CRSI MINIMUM UOM.
- 6.) SEE S101 FOR COLUMN FOOTING SCHEDULE AND ADDITIONAL NOTES THAT APPLY.
- 7.) REFERENCE ARCHITECTURAL AND PLUMBING DRAWINGS FOR COORDINATION OF SLOPED FLOORS AT FLOOR DRAINS, AND DEPRESSED FLOOR SLAB LOCATIONS.
- 8.) LOCATE ALL WALLS AND MASONRY OPENINGS PER ARCHITECTURAL DRAWINGS.
- 9.) ARCHITECTURAL BACKGROUND IS SHOWN FOR REFERENCE ONLY. REFER TO ARCHITECTURAL DRAWINGS FOR EXACT LOCATIONS OF WALLS.
- 10.) THE CONTRACTOR SHALL COORDINATE AND VERIFY ALL DIMENSIONS & ELEVATIONS PRIOR TO STARTING CONSTRUCTION AND ANY DISCREPANCY SHALL BE BROUGHT TO THE ATTENTION OF THE ENGINEER OF RECORD.
- 11.) FLOOR SLAB IN GYM AREA SHALL BE DEPRESSED 2 17/32" TO RECEIVE THE CUSHIONED PLAY FINISH FLOOR. VERIFY WITH ARCHITECTURAL DRAWINGS ALL DETAILS OF DEPRESSION AT DOORWAY THRESHOLDS. CONTRACTOR SHALL VERIFY/COORDINATE REQUIRED SLAB DEPRESSION FOR PLAY FLOOR WITH ARCH. ROOM FINISH SCHEDULE.
- 12.) SEE ARCHITECTURAL DRAWINGS FOR ALL POURED RAMP LOCATIONS AND DIMENSIONS. TYPICAL DRAWINGS ALL DETAILS OF DEPRESSION AT DOORWAY THRESHOLDS. CONTRACTOR SHALL VERIFY/COORDINATE REQUIRED SLAB DEPRESSION FOR PLAY FLOOR WITH ARCH. ROOM FINISH SCHEDULE.
- 13.) ALL COLUMNS = HSS 8 x 8 x 1, TYP. U.O.N.

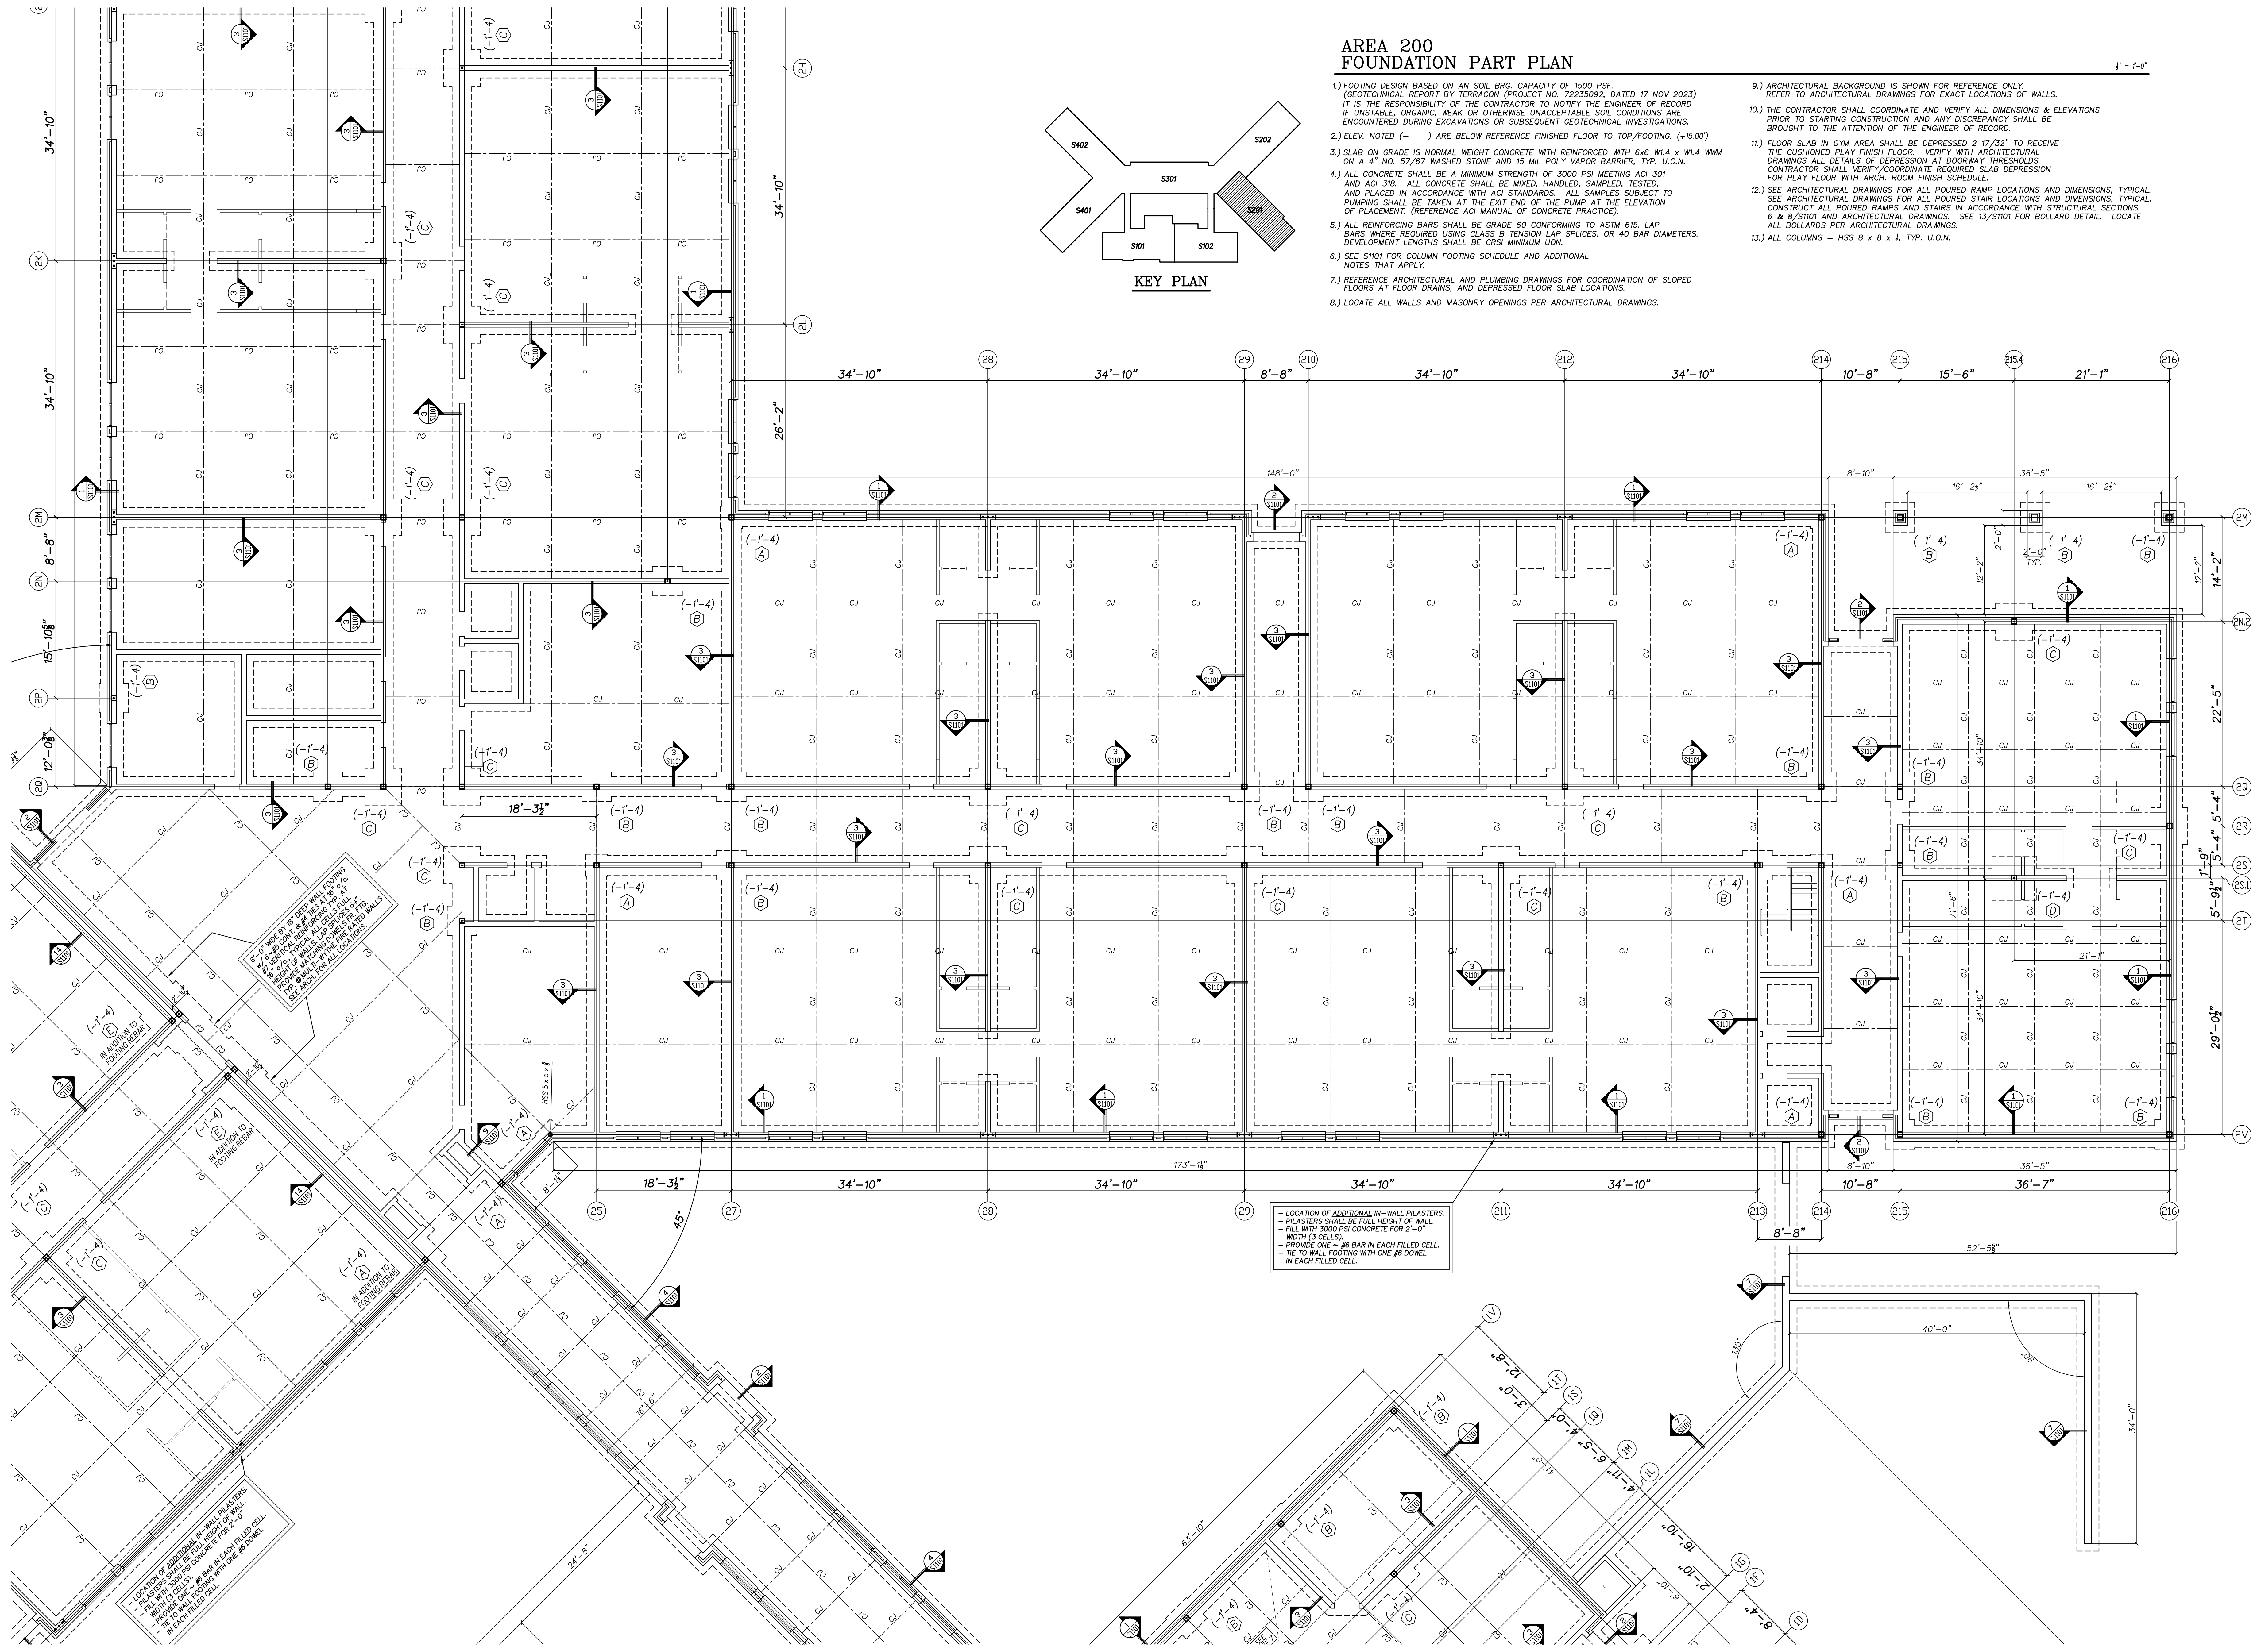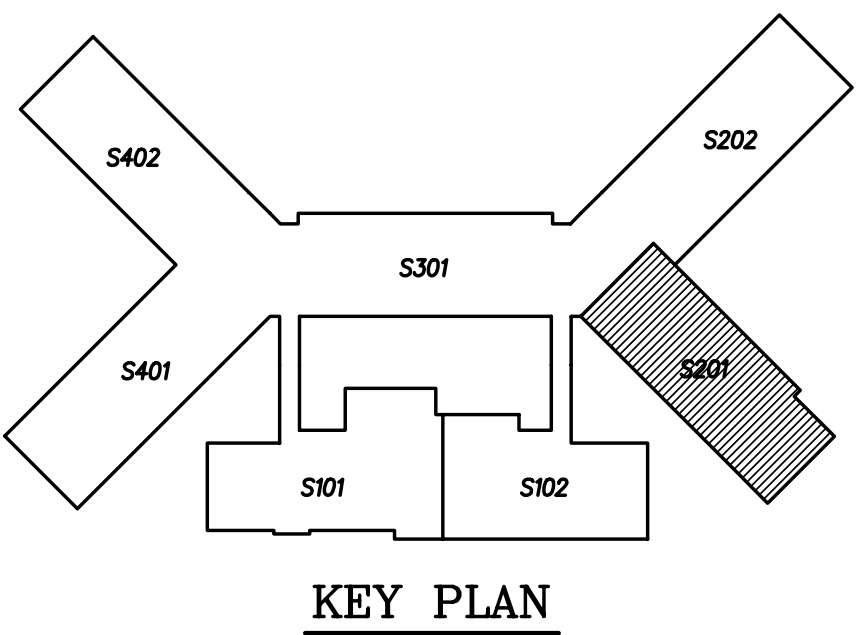

6" MIN. WIDE DEEP WALL FOOTING WITH REINFORCING BARS AT 18" O.C. FOR ALL WALLS. PROVIDE 2" MIN. WIDE DEEP WALL FOOTING WITH REINFORCING BARS AT 18" O.C. FOR ALL WALLS. PROVIDE 2" MIN. WIDE DEEP WALL FOOTING WITH REINFORCING BARS AT 18" O.C. FOR ALL WALLS. PROVIDE 2" MIN. WIDE DEEP WALL FOOTING WITH REINFORCING BARS AT 18" O.C. FOR ALL WALLS.

- LOCATION OF ADDITIONAL IN-WALL PILASTERS.
- PILASTERS SHALL BE FULL HEIGHT OF WALL.
- FILL WITH 3000 PSI CONCRETE FOR 2'-0" WIDTH (3 CELLS).
- PROVIDE ONE #6 BAR IN EACH FILLED CELL.
- TIE TO WALL FOOTING WITH ONE #6 DOWEL IN EACH FILLED CELL.

LOCATION OF ADDITIONAL IN-WALL PILASTERS SHALL BE FULL HEIGHT OF WALL. FILL WITH 3000 PSI CONCRETE FOR 2'-0" WIDTH (3 CELLS). PROVIDE ONE #6 BAR IN EACH FILLED CELL. TIE TO WALL FOOTING WITH ONE #6 DOWEL IN EACH FILLED CELL.

NO.	DATE	REVISION


Hite associates
ARCHITECTURE / ENGINEERING / TECHNOLOGY
2600 Meridian Drive / Greenville, NC 27838 / tel (252) 757-0333

QED
QUEEN ENGINEERING & DESIGN
REGISTERED PROFESSIONAL ENGINEER
STATE OF NORTH CAROLINA, LICENSE # 14516
10/19/2022

Princess Queen
REGISTERED PROFESSIONAL ENGINEER
STATE OF NORTH CAROLINA, LICENSE # 18991
09 OCT 2024

Beaufort PK-3 School
BEAUFORT COUNTY SCHOOLS
Washington / North Carolina / 27889

Project No. 22344
Date: 09 OCT 2024
Drawing No. **S**
201

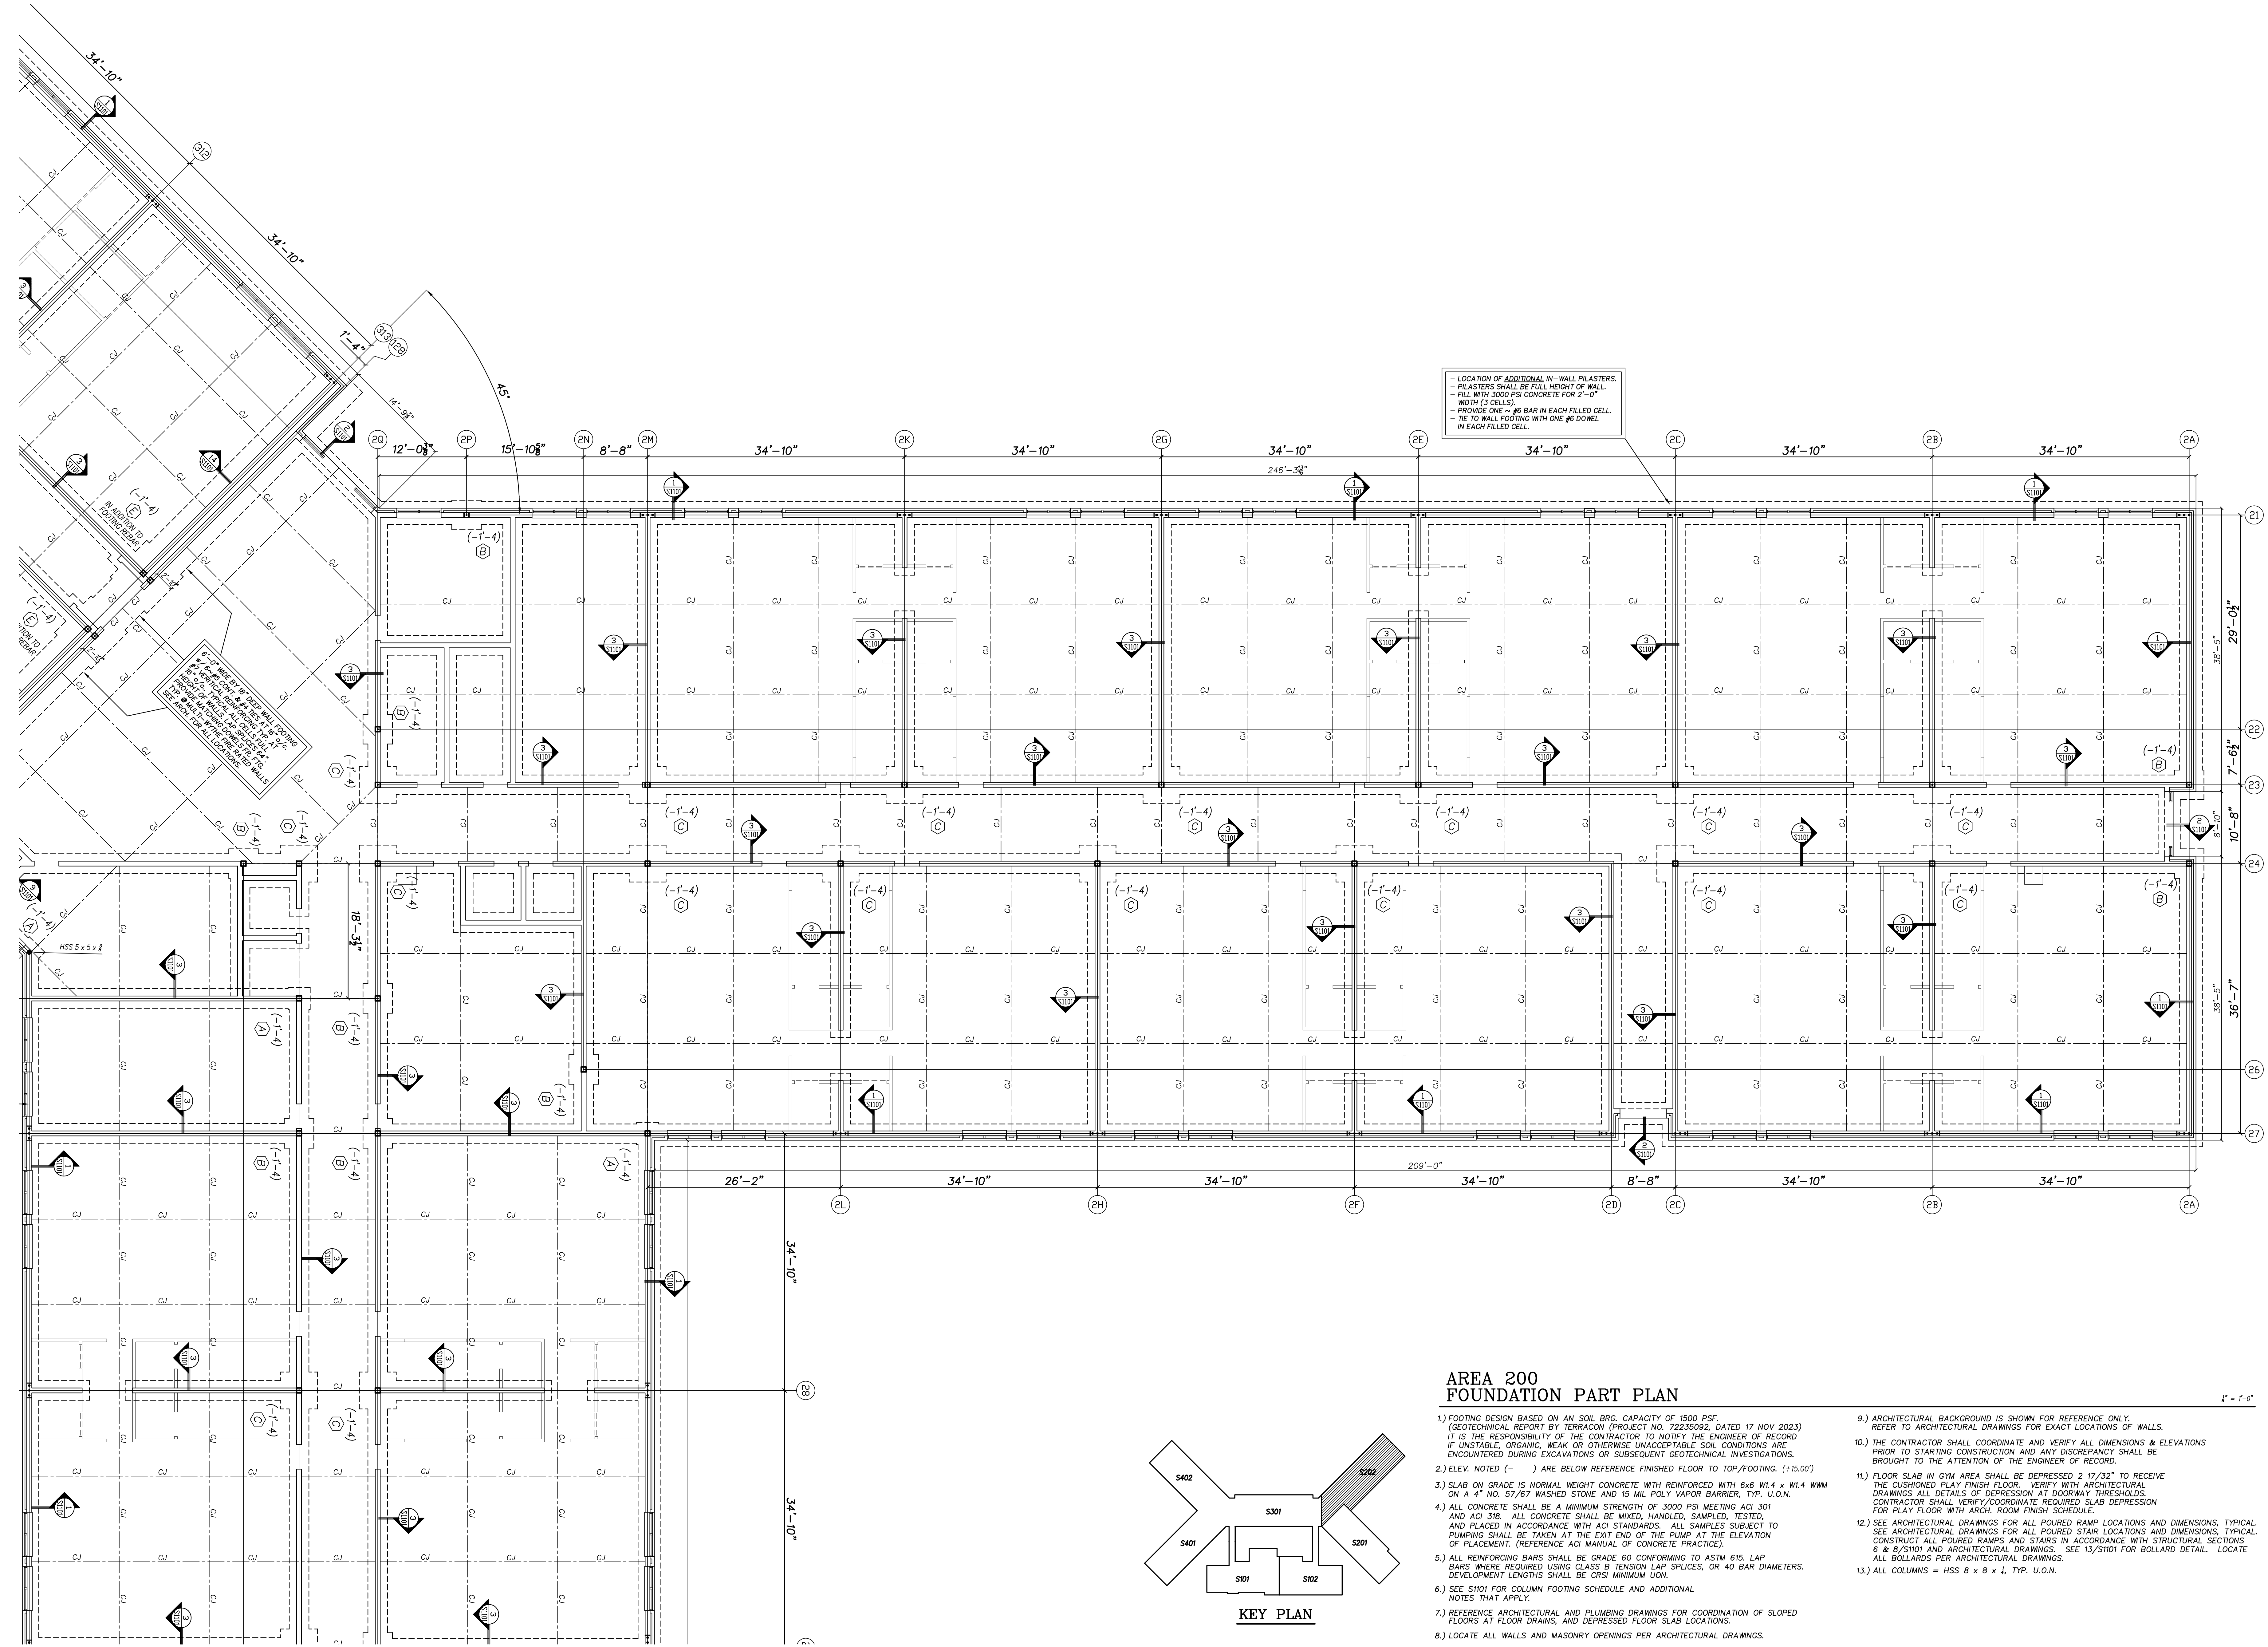

**AREA 200
FOUNDATION PART PLAN**

- 1.) FOOTING DESIGN BASED ON AN SOIL BRG. CAPACITY OF 1500 PSF. (GEOTECHNICAL REPORT BY TERRACON (PROJECT NO. 72235092, DATED 17 NOV 2023) IT IS THE RESPONSIBILITY OF THE CONTRACTOR TO NOTIFY THE ENGINEER OF RECORD IF UNSTABLE, ORGANIC, WEAK OR OTHERWISE UNACCEPTABLE SOIL CONDITIONS ARE ENCOUNTERED DURING EXCAVATIONS OR SUBSEQUENT GEOTECHNICAL INVESTIGATIONS.
- 2.) ELEV. NOTED (-) ARE BELOW REFERENCE FINISHED FLOOR TO TOP/FOOTING. (+15.00')
- 3.) SLAB ON GRADE IS NORMAL WEIGHT CONCRETE WITH REINFORCED WITH 6x6 W1.4 x W1.4 W/M ON A 4" NO. 57/87 WASHED STONE AND 15 MIL POLY VAPOR BARRIER, TYP. U.O.N.
- 4.) ALL CONCRETE SHALL BE A MINIMUM STRENGTH OF 3000 PSI MEETING ACI 301 AND ACI 318. ALL CONCRETE SHALL BE MIXED, HANDLED, SAMPLED, TESTED AND PLACED IN ACCORDANCE WITH ACI STANDARDS. ALL SAMPLES SUBJECT TO PUMPING SHALL BE TAKEN AT THE EXIT END OF THE PUMP AT THE ELEVATION OF PLACEMENT. (REFERENCE ACI MANUAL OF CONCRETE PRACTICE).
- 5.) ALL REINFORCING BARS SHALL BE GRADE 60 CONFORMING TO ASTM 615. LAP BARS WHERE REQUIRED USING CLASS B TENSION LAP SPLICES, OR 40 BAR DIAMETERS. DEVELOPMENT LENGTHS SHALL BE CRSI MINIMUM UON.
- 6.) SEE S101 FOR COLUMN FOOTING SCHEDULE AND ADDITIONAL NOTES THAT APPLY.
- 7.) REFERENCE ARCHITECTURAL AND PLUMBING DRAWINGS FOR COORDINATION OF SLOPED FLOORS AT FLOOR DRAINS, AND DEPRESSED FLOOR SLAB LOCATIONS.
- 8.) LOCATE ALL WALLS AND MASONRY OPENINGS PER ARCHITECTURAL DRAWINGS.
- 9.) ARCHITECTURAL BACKGROUND IS SHOWN FOR REFERENCE ONLY. REFER TO ARCHITECTURAL DRAWINGS FOR EXACT LOCATIONS OF WALLS.
- 10.) THE CONTRACTOR SHALL COORDINATE AND VERIFY ALL DIMENSIONS & ELEVATIONS PRIOR TO STARTING CONSTRUCTION AND ANY DISCREPANCY SHALL BE BROUGHT TO THE ATTENTION OF THE ENGINEER OF RECORD.
- 11.) FLOOR SLAB IN GYM AREA SHALL BE DEPRESSED 2 17/32" TO RECEIVE THE CUSHIONED PLAY FINISH FLOOR. VERIFY WITH ARCHITECTURAL DRAWINGS ALL DETAILS OF DEPRESSION AT DOORWAY THRESHOLDS. CONTRACTOR SHALL VERIFY/COORDINATE REQUIRED SLAB DEPRESSION FOR PLAY FLOOR WITH ARCH. ROOM FINISH SCHEDULE.
- 12.) SEE ARCHITECTURAL DRAWINGS FOR ALL POURED RAMP LOCATIONS AND DIMENSIONS, TYPICAL. SEE ARCHITECTURAL DRAWINGS FOR ALL POURED STAIR LOCATIONS AND DIMENSIONS, TYPICAL. CONSTRUCT ALL POURED RAMPS AND STAIRS IN ACCORDANCE WITH STRUCTURAL SECTIONS 6 & 8/S101 AND ARCHITECTURAL DRAWINGS. SEE 13/S101 FOR BOLLARD DETAIL. LOCATE ALL BOLLARDS PER ARCHITECTURAL DRAWINGS.
- 13.) ALL COLUMNS = HSS 8 x 8 x 4, TYP. U.O.N.

No.	Date

Hite associates
ARCHITECTURE / ENGINEERING / TECHNOLOGY
2600 Meridian Drive / Greenville, NC 27838 / tel (252) 757-0333

QED
QUINN ENGINEERING & DESIGN
REGISTERED PROFESSIONAL ENGINEER
STATE OF NORTH CAROLINA
NO. 10000
09 OCT 2024




Beaufort PK-3 School
BEAUFORT COUNTY SCHOOLS
Washington / North Carolina / 27889

Project No. 22344
Date: 09 OCT 2024
Drawing no. S 202

AREA 200 INTERMEDIATE PART PLAN

1" = 1'-0"

- 1.) SEE PLAN FOR TOP/UTILITY PLATFORM SLAB ELEVATION
- 2.) SEE S102 FOR METAL FLOOR DECK FASTENING PATTERN, WHERE REQUIRED.
- 3.) SEE PLAN FOR SLAB THICKNESS AND FLOOR DECK SIZE.
REINFORCE ALL NEW PLATFORM SLABS WITH 6x6 W2.9 x W2.9 W/M.
- 4.) ARCHITECTURAL BACKGROUND IS SHOWN FOR REFERENCE ONLY.
REFER TO ARCHITECTURAL DRAWINGS FOR EXACT LOCATIONS OF WALLS.
- 5.) REFER TO ARCHITECTURAL DRAWINGS FOR ELEVATION OF ALL LINTELS.
- 6.) CONTRACTOR SHALL PROVIDE TEMPORARY SHORING AS REQUIRED FOR NEW COMPOSITE DECK SPANS GREATER THAN 10'-6"
- 7.) LOCATE ALL WALLS AND MASONRY OPENINGS PER ARCHITECTURAL DRAWINGS.
WHERE REQUIRED, SEE S102 FOR ALL NEW OMI LINTELS.
- 8.) NO FABRICATION OR ERECTION SHALL COMMENCE PRIOR TO THE APPROVAL OF ALL STRUCTURAL STEEL SHOP DRAWINGS BY THE ENGINEER OF RECORD.
- 9.) COORDINATE AND VERIFY ALL DECK EDGE LOCATIONS AND DIMENSIONS WITH ARCHITECTURAL DRAWINGS.
- 10.) REFERENCE ARCHITECTURAL AND PLUMBING DRAWINGS FOR COORDINATION OF SLOPED FLOORS AT FLOOR DRAINS, AND DEPRESSED FLOOR SLAB LOCATIONS.

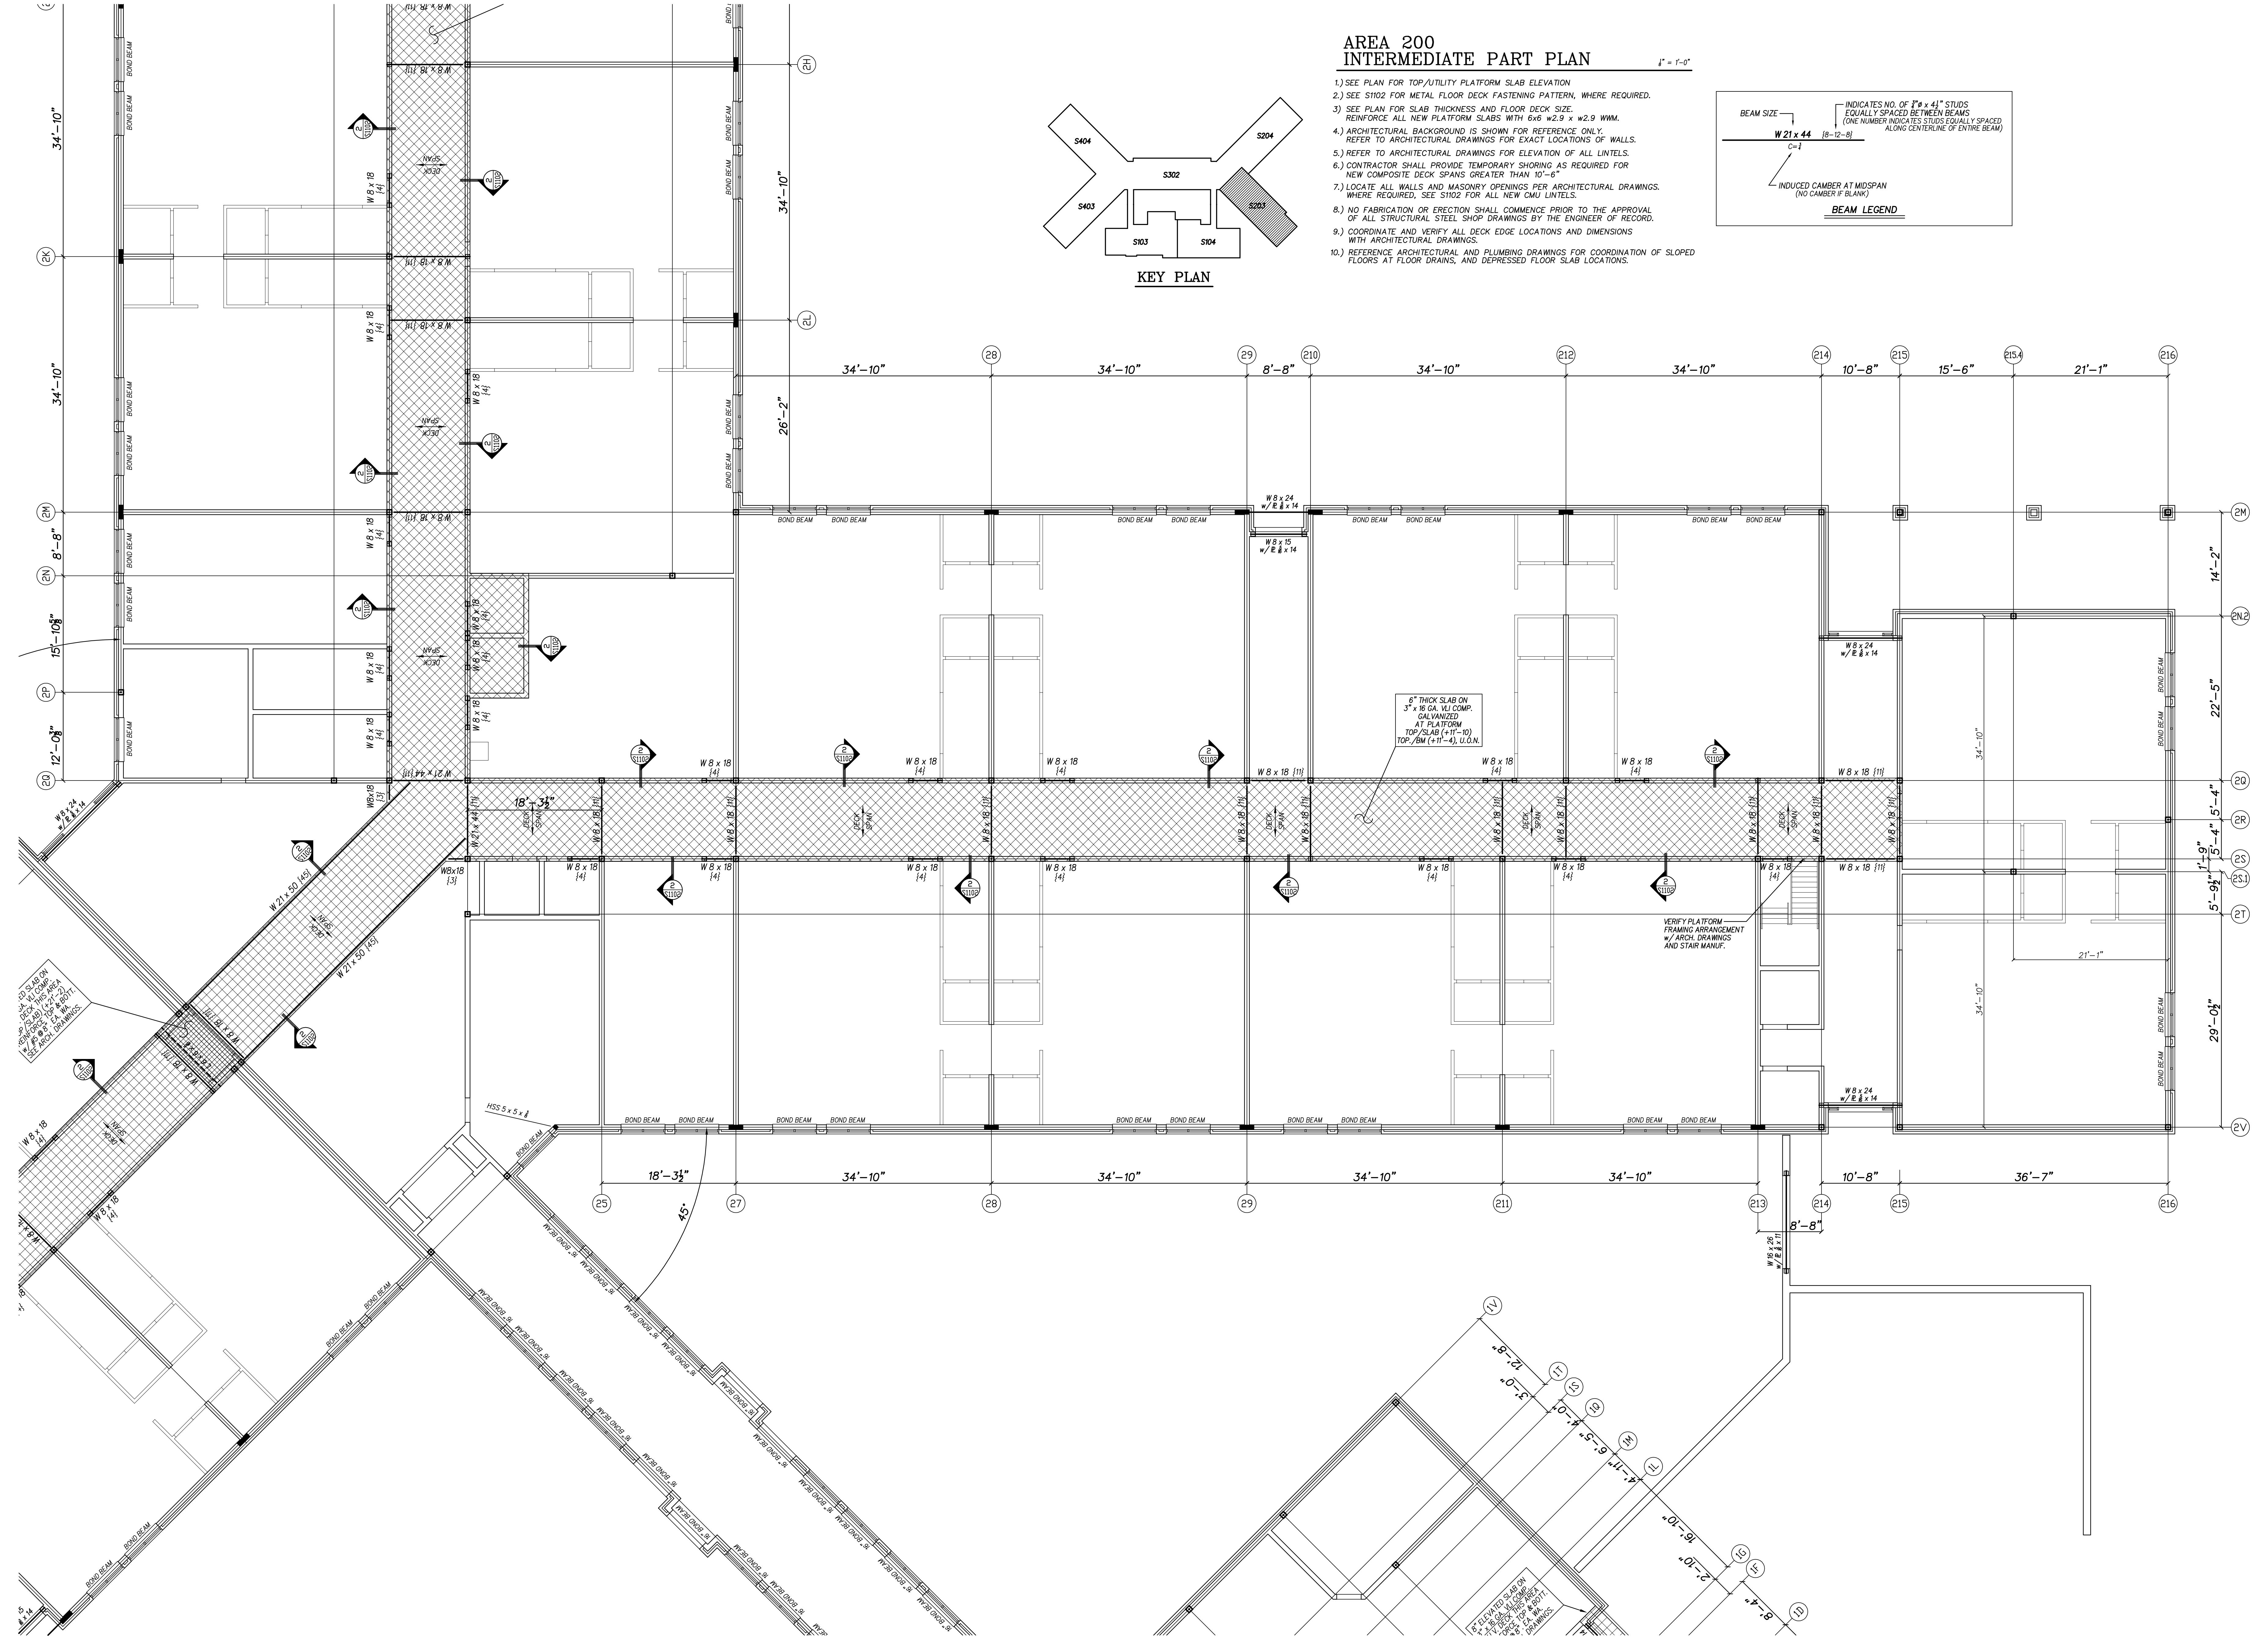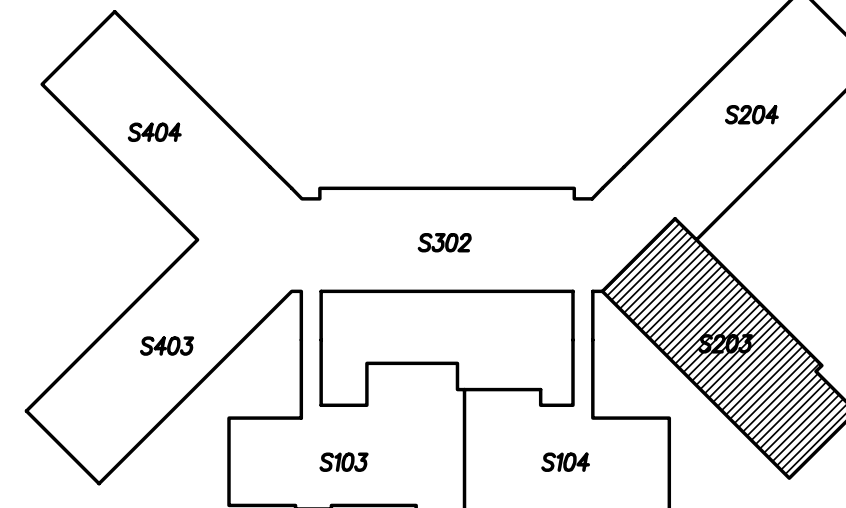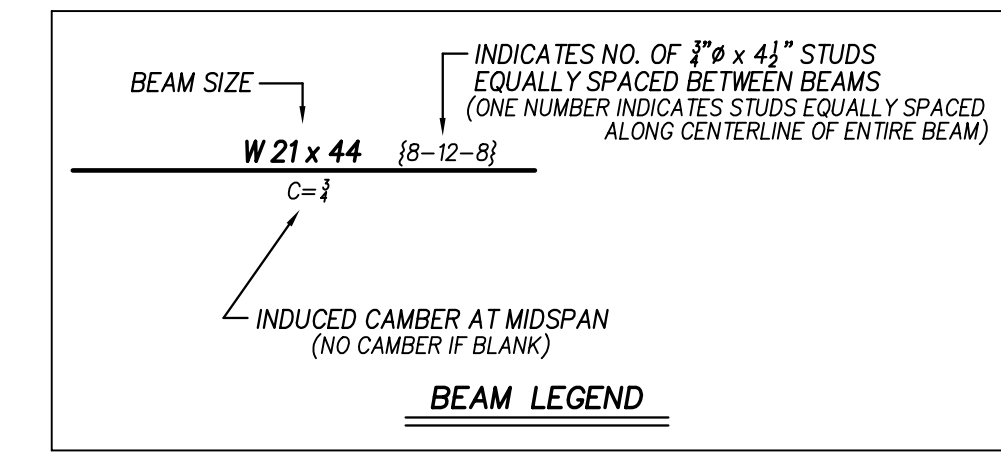


No.	Date	Revision

Hite associates
ARCHITECTURE / ENGINEERING / TECHNOLOGY
2600 Meridian Drive / Greenville, NC 27838 / tel (252) 757-0333

NE L.L.C. C-1000
QED
QUINN ENGINEERING & DESIGN
REGISTERED PROFESSIONAL ENGINEER
STATE OF NORTH CAROLINA, LICENSE NO. 4415
1989
Prince Green
ENGINEER
BRUCE L. QUINN
09 OCT 2024

Beaufort PK-3 School
BEAUFORT COUNTY SCHOOLS
Washington / North Carolina / 27889



Project No. 22344
Date: 09 OCT 2024
Drawing no. S 203

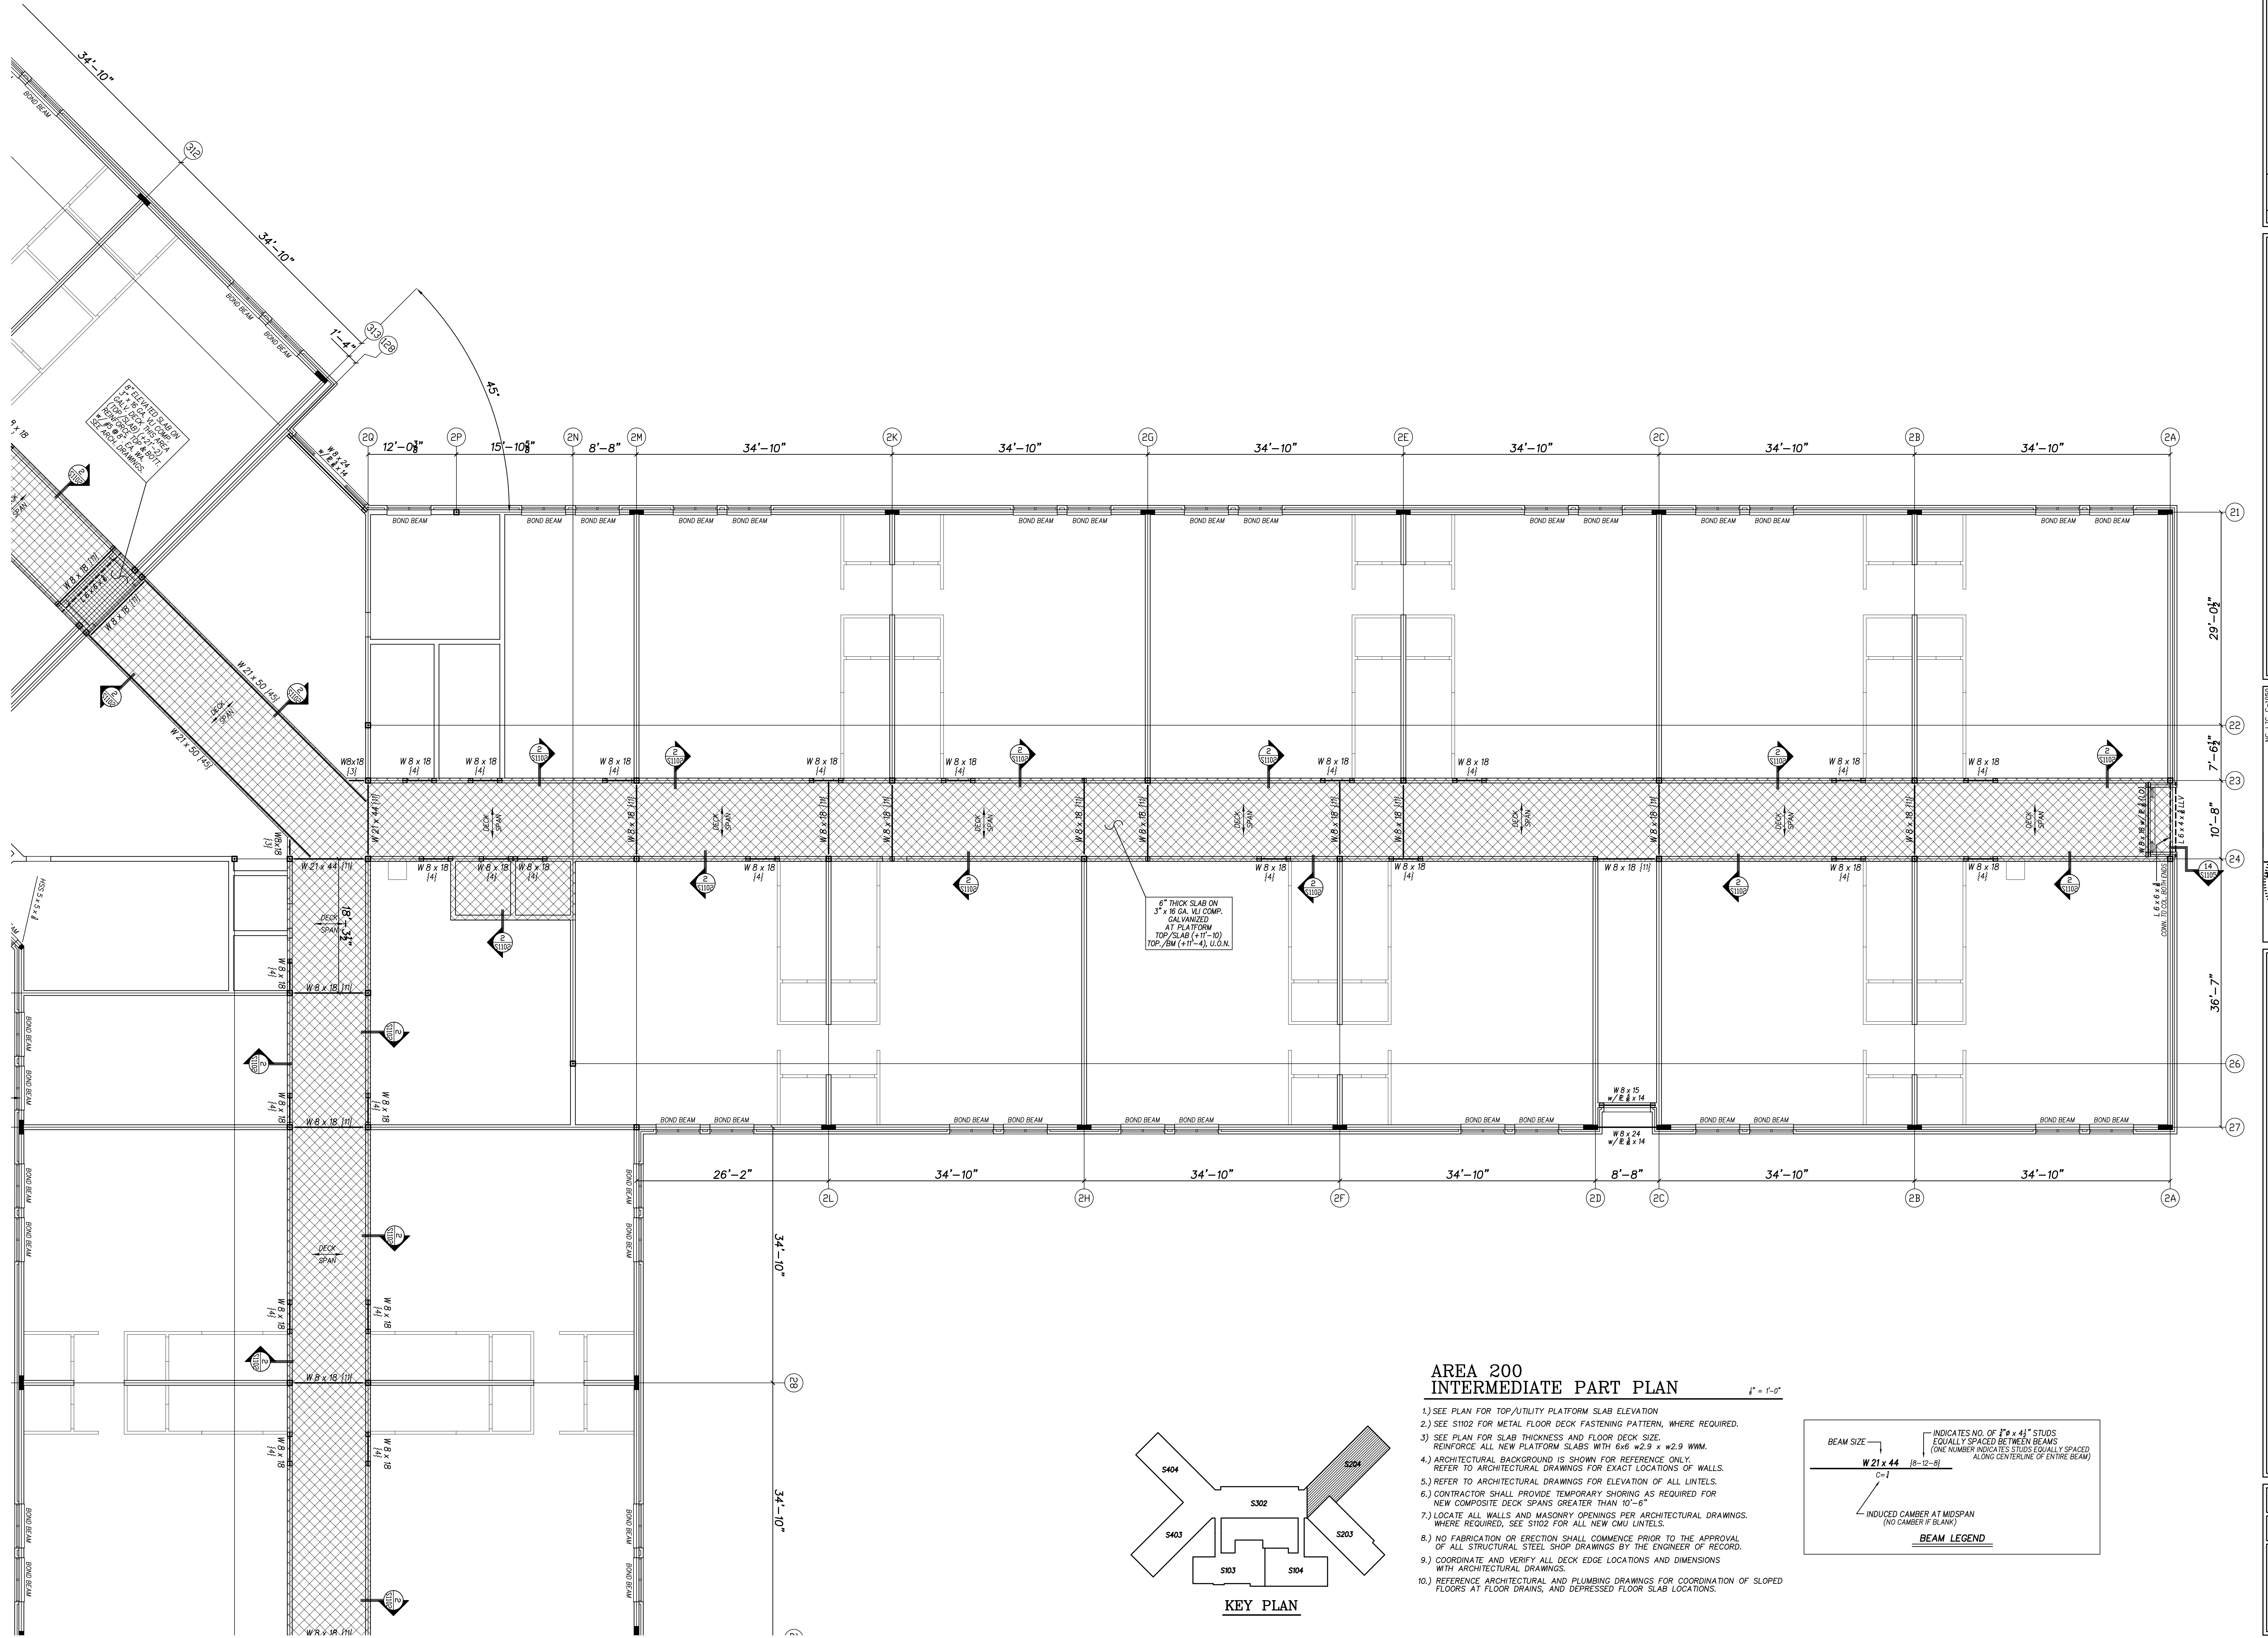

**AREA 200
INTERMEDIATE PART PLAN**

1" = 1'-0"

- 1.) SEE PLAN FOR TOP/UTILITY PLATFORM SLAB ELEVATION
- 2.) SEE S1102 FOR METAL FLOOR DECK FASTENING PATTERN, WHERE REQUIRED.
- 3.) SEE PLAN FOR SLAB THICKNESS AND FLOOR DECK SIZE. REINFORCE ALL NEW PLATFORM SLABS WITH 6x6 w2.9 x w2.9 WWM. REFER TO ARCHITECTURAL DRAWINGS FOR EXACT LOCATIONS OF WALLS.
- 4.) ARCHITECTURAL BACKGROUND IS SHOWN FOR REFERENCE ONLY. REFER TO ARCHITECTURAL DRAWINGS FOR EXACT LOCATIONS OF WALLS.
- 5.) REFER TO ARCHITECTURAL DRAWINGS FOR ELEVATION OF ALL LINTELS.
- 6.) CONTRACTOR SHALL PROVIDE TEMPORARY SHORING AS REQUIRED FOR NEW COMPOSITE DECK SPANS GREATER THAN 10'-0".
- 7.) LOCATE ALL WALLS AND MASONRY OPENINGS PER ARCHITECTURAL DRAWINGS, WHERE REQUIRED, SEE S1102 FOR ALL NEW CMU LINTELS.
- 8.) NO FABRICATION OR ERECTION SHALL COMMENCE PRIOR TO THE APPROVAL OF ALL STRUCTURAL STEEL SHOP DRAWINGS BY THE ENGINEER OF RECORD.
- 9.) COORDINATE AND VERIFY ALL DECK EDGE LOCATIONS AND DIMENSIONS WITH ARCHITECTURAL DRAWINGS.
- 10.) REFERENCE ARCHITECTURAL AND PLUMBING DRAWINGS FOR COORDINATION OF SLOPED FLOORS AT FLOOR DRAINS, AND DEPRESSED FLOOR SLAB LOCATIONS.

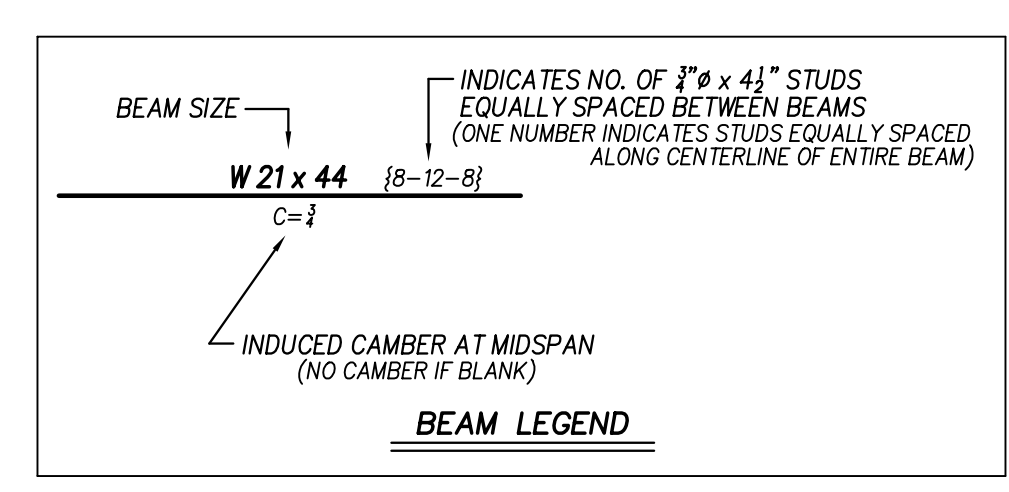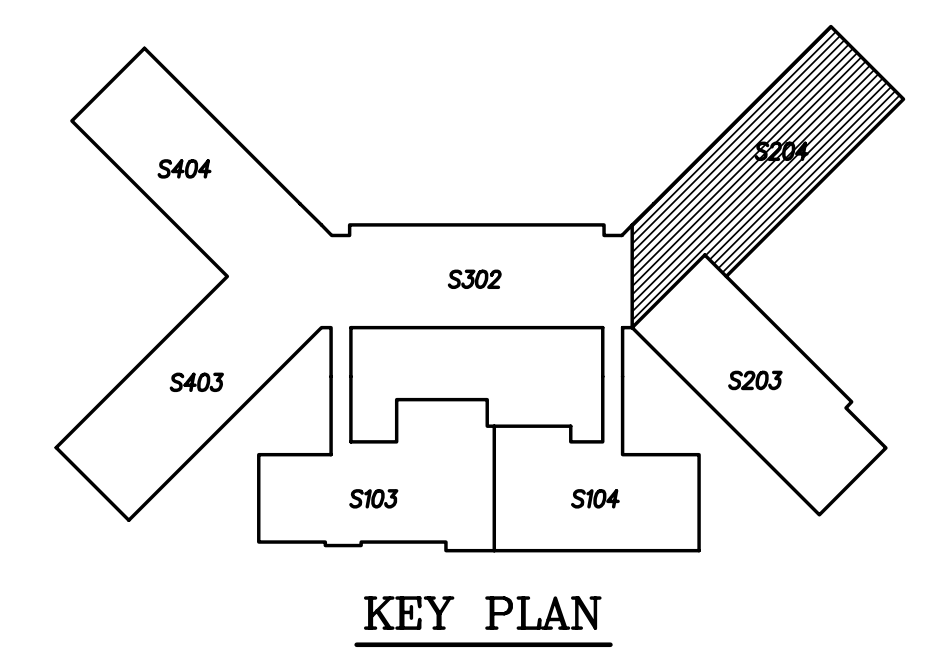

No.	Date	Revision

Hite associates
ARCHITECTURE / ENGINEERING / TECHNOLOGY
2600 Meridian Drive / Greenville, NC 27838 / tel (252) 757-0333

NC LIC C-1020
QED
QUINN ENGINEERING & DESIGN
1000 W. WILSON ST. SUITE 200
GREENVILLE, NC 27604
PH: 252-333-8888
FAX: 252-333-8889
ENGINEER
BRUCE QUINN
18991
09 OCT 2024



Beaufort PK-3 School
BEAUFORT COUNTY SCHOOLS
Washington / North Carolina / 27889

Project No. 22344
Date: 09 OCT 2024
Drawing No. S 204

AREA 200 ROOF PART PLAN

1" = 1'-0"

- METAL ROOF DECK IS 1/2" x 22 GA TYPE "B" PAINTED M.R.D. TYP. U.O.N. FOR ATTACHMENT, SEE TYPICAL M.R.D. FASTENING DETAIL ON S102.
- ELEV NOTED(*) ARE ABOVE REFERENCED FINISHED FLOOR.
- METAL ROOF DECK IS TO BE USED TO TRANSMIT LATERAL LOADS TO WALLS. SEE TYP. DECK FASTENING PATTERN ON S102.
- JOIST SUPPLIER SHALL DESIGN JOISTS FOR ADDITIONAL POINT LOADS FROM ROOF TOP MECHANICAL UNITS (IF REQUIRED). CONTRACTOR SHALL VERIFY SIZE AND WEIGHT OF UNITS AND REPORT THIS INFORMATION TO THE STRUCTURAL ENGINEER OF RECORD, IF REQUIRED.
- ALL WIDE FLANGE BEAMS TO BE "A50" STEEL.
- SEE S301 FOR NET UPLIFT DESIGN LOADING FOR ALL JOISTS AND ORDERS.
- "UB" INDICATES UPLIFT BRIDGING TO BE LOCATED AT THE FIRST BOTTOM CHORD PANEL POINT OF JOIST.
- NO FABRICATION OR ERECTION SHALL COMMENCE PRIOR TO THE APPROVAL OF ALL STRUCTURAL STEEL SHOP DRAWINGS BY THE ENGINEER OF RECORD.
- JOIST MANUFACTURER SHALL ADJUST JOIST SEATS AS REQUIRED TO MAINTAIN DECK BEARING ELEVATIONS SHOWN ON THE CONTRACT DRAWINGS.
- COORDINATE AND VERIFY ALL DECK EDGE LOCATIONS AND DIMENSIONS WITH ARCHITECTURAL DRAWINGS.
- SEE S3103 AND S3103 FOR LCX CONFIGURATION.
- SEE S4103 FOR BCK CONFIGURATION.
- PROVIDE CONTINUOUS HORIZONTAL AND/OR DIAGONAL CROSS BRIDGING AT LOCATIONS SHOWN ON THE DRAWINGS. WHERE S.A. STANDARDS REQUIRE ADDITIONAL LINES OF BRIDGING IN ADDITION TO THOSE SHOWN ON THE DRAWINGS THE ADDITIONAL LINES SHALL BE PROVIDED.
- ⊗ - INDICATES THAT JOIST AND ORDER SUPPLIER SHALL DESIGN JOIST WITH DESIGN END MOMENT OF 500 IN-K AT END OF JOIST. SEE SECTION B/S104 FOR ADDITIONAL NOTES THAT APPLY. TYPICAL AT "SP" JOIST DESIGNATION.
- UNLESS OTHERWISE NOTED, ALL JOIST ORDERS SUPPORTING WM PIPING SUPPORT BEAMS SHALL BE DESIGNED BY THEIR SUPPLIER TO SUPPORT AN ADDITIONAL 1.5 KIPS UNFACTORED SERVICE LOAD AT EACH W4 SUPPORT POINT.
- LOCATE ALL WALLS AND MASONRY OPENINGS PER ARCHITECTURAL DRAWINGS.
- L6 = L 6 x 6 x 8 TYP. U.O.N.
- W4 = W 4 x 13 TYP. U.O.N.
- ▶ = INDICATES MOMENT CONNECTION. SEE 1/S104.
- SEE 15/S103 FOR BENT BEAM WELDMENTS.
- W6 = W 6 x 9 TYP. U.O.N.
- HSS3 = HSS 3 x 3 x 1/4 TYP. U.O.N.

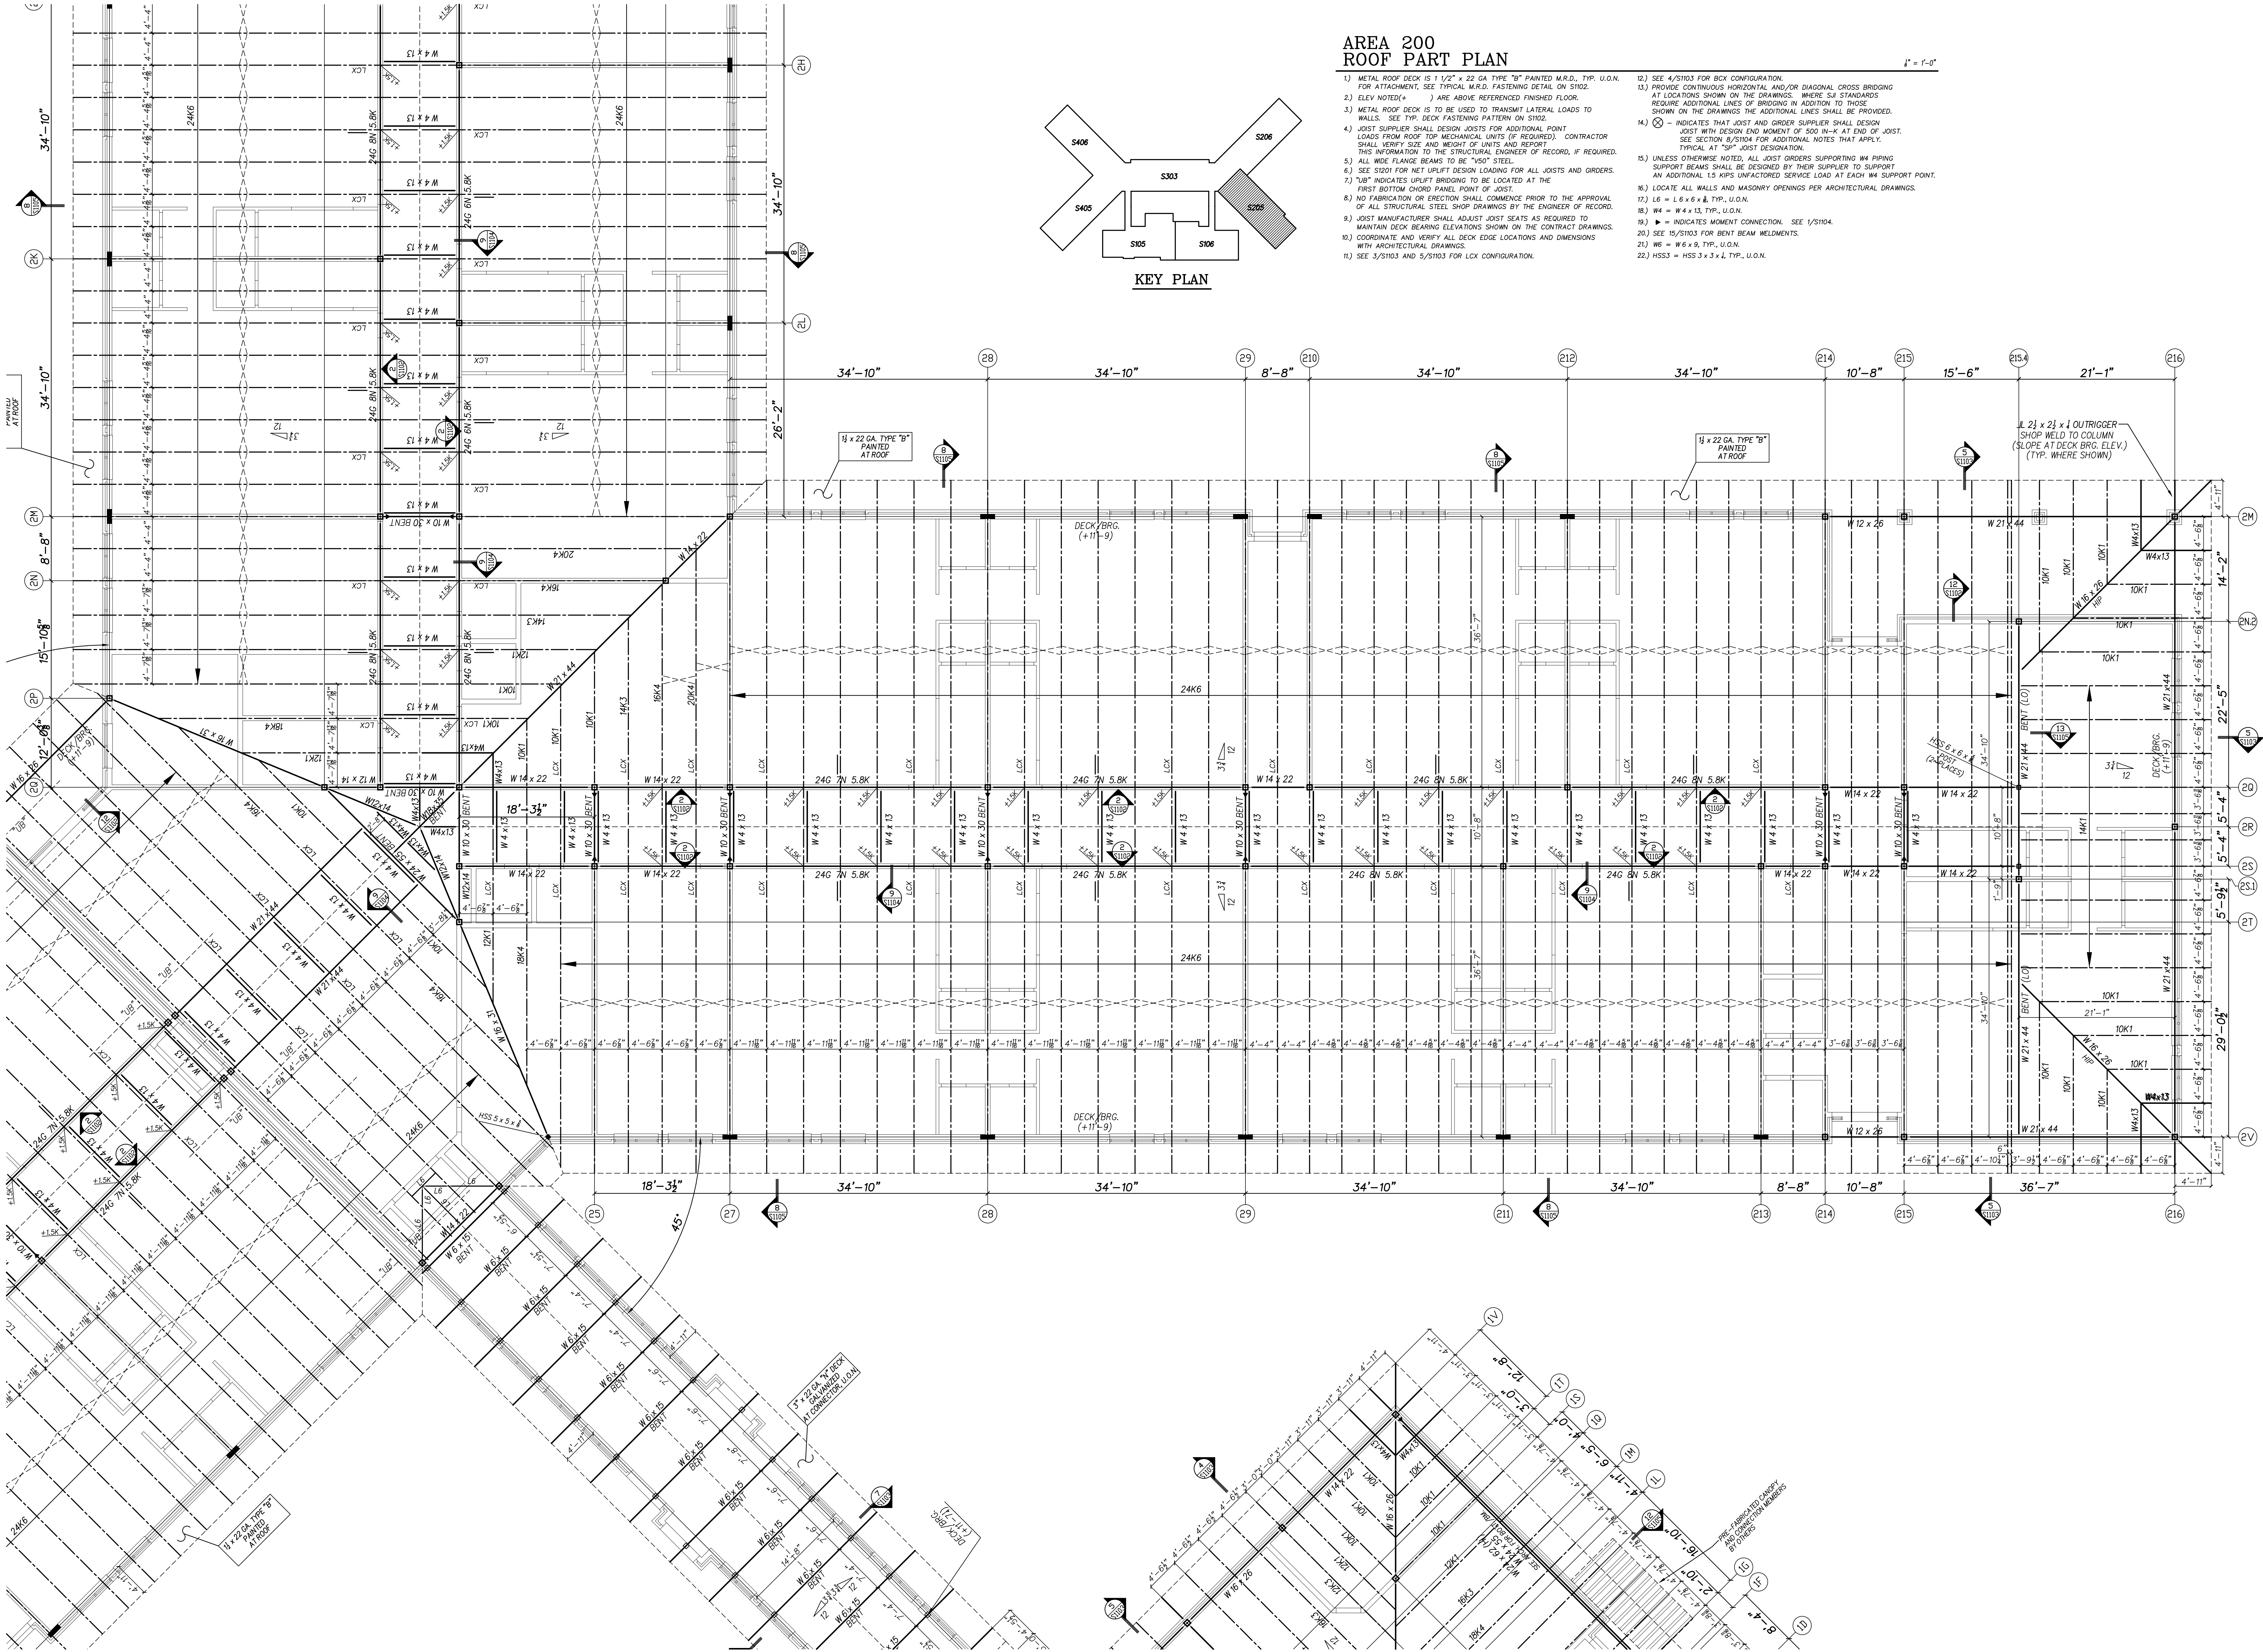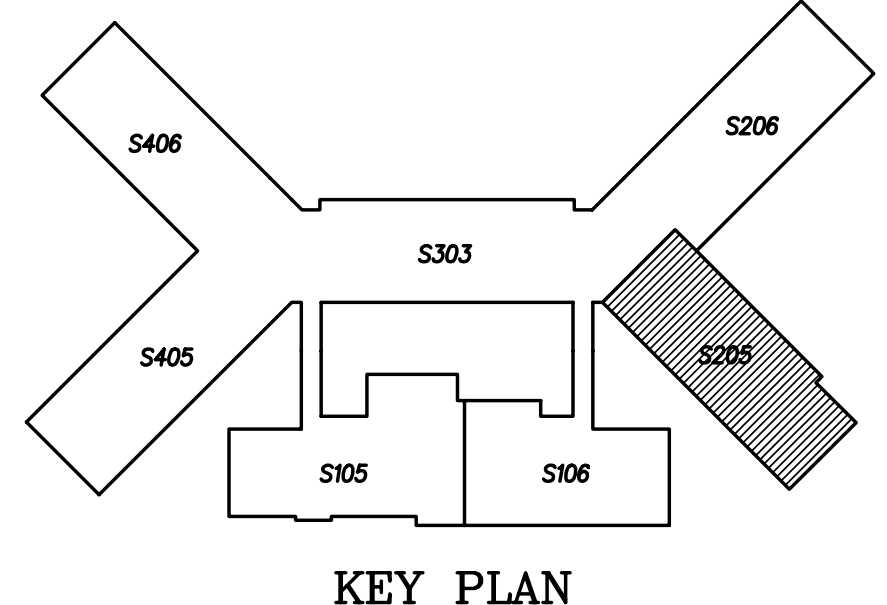


No.	Date	Revision

Hite associates
ARCHITECTURE / ENGINEERING / TECHNOLOGY
2600 Meridian Drive / Greenville, NC 27838 / tel (252) 757-0333

NC LIC C-1030
QED
QUEEN ENGINEERING & DESIGN
ARCHITECTURE / ENGINEERING / TECHNOLOGY
1101 W. HARRIS STREET
GREENVILLE, NC 27834
18991
09 OCT 2024


Beaufort PK-3 School
BEAUFORT COUNTY SCHOOLS
Washington / North Carolina / 27889

Project No. 22344
Date: 09 OCT 2024
Drawing no. S 205

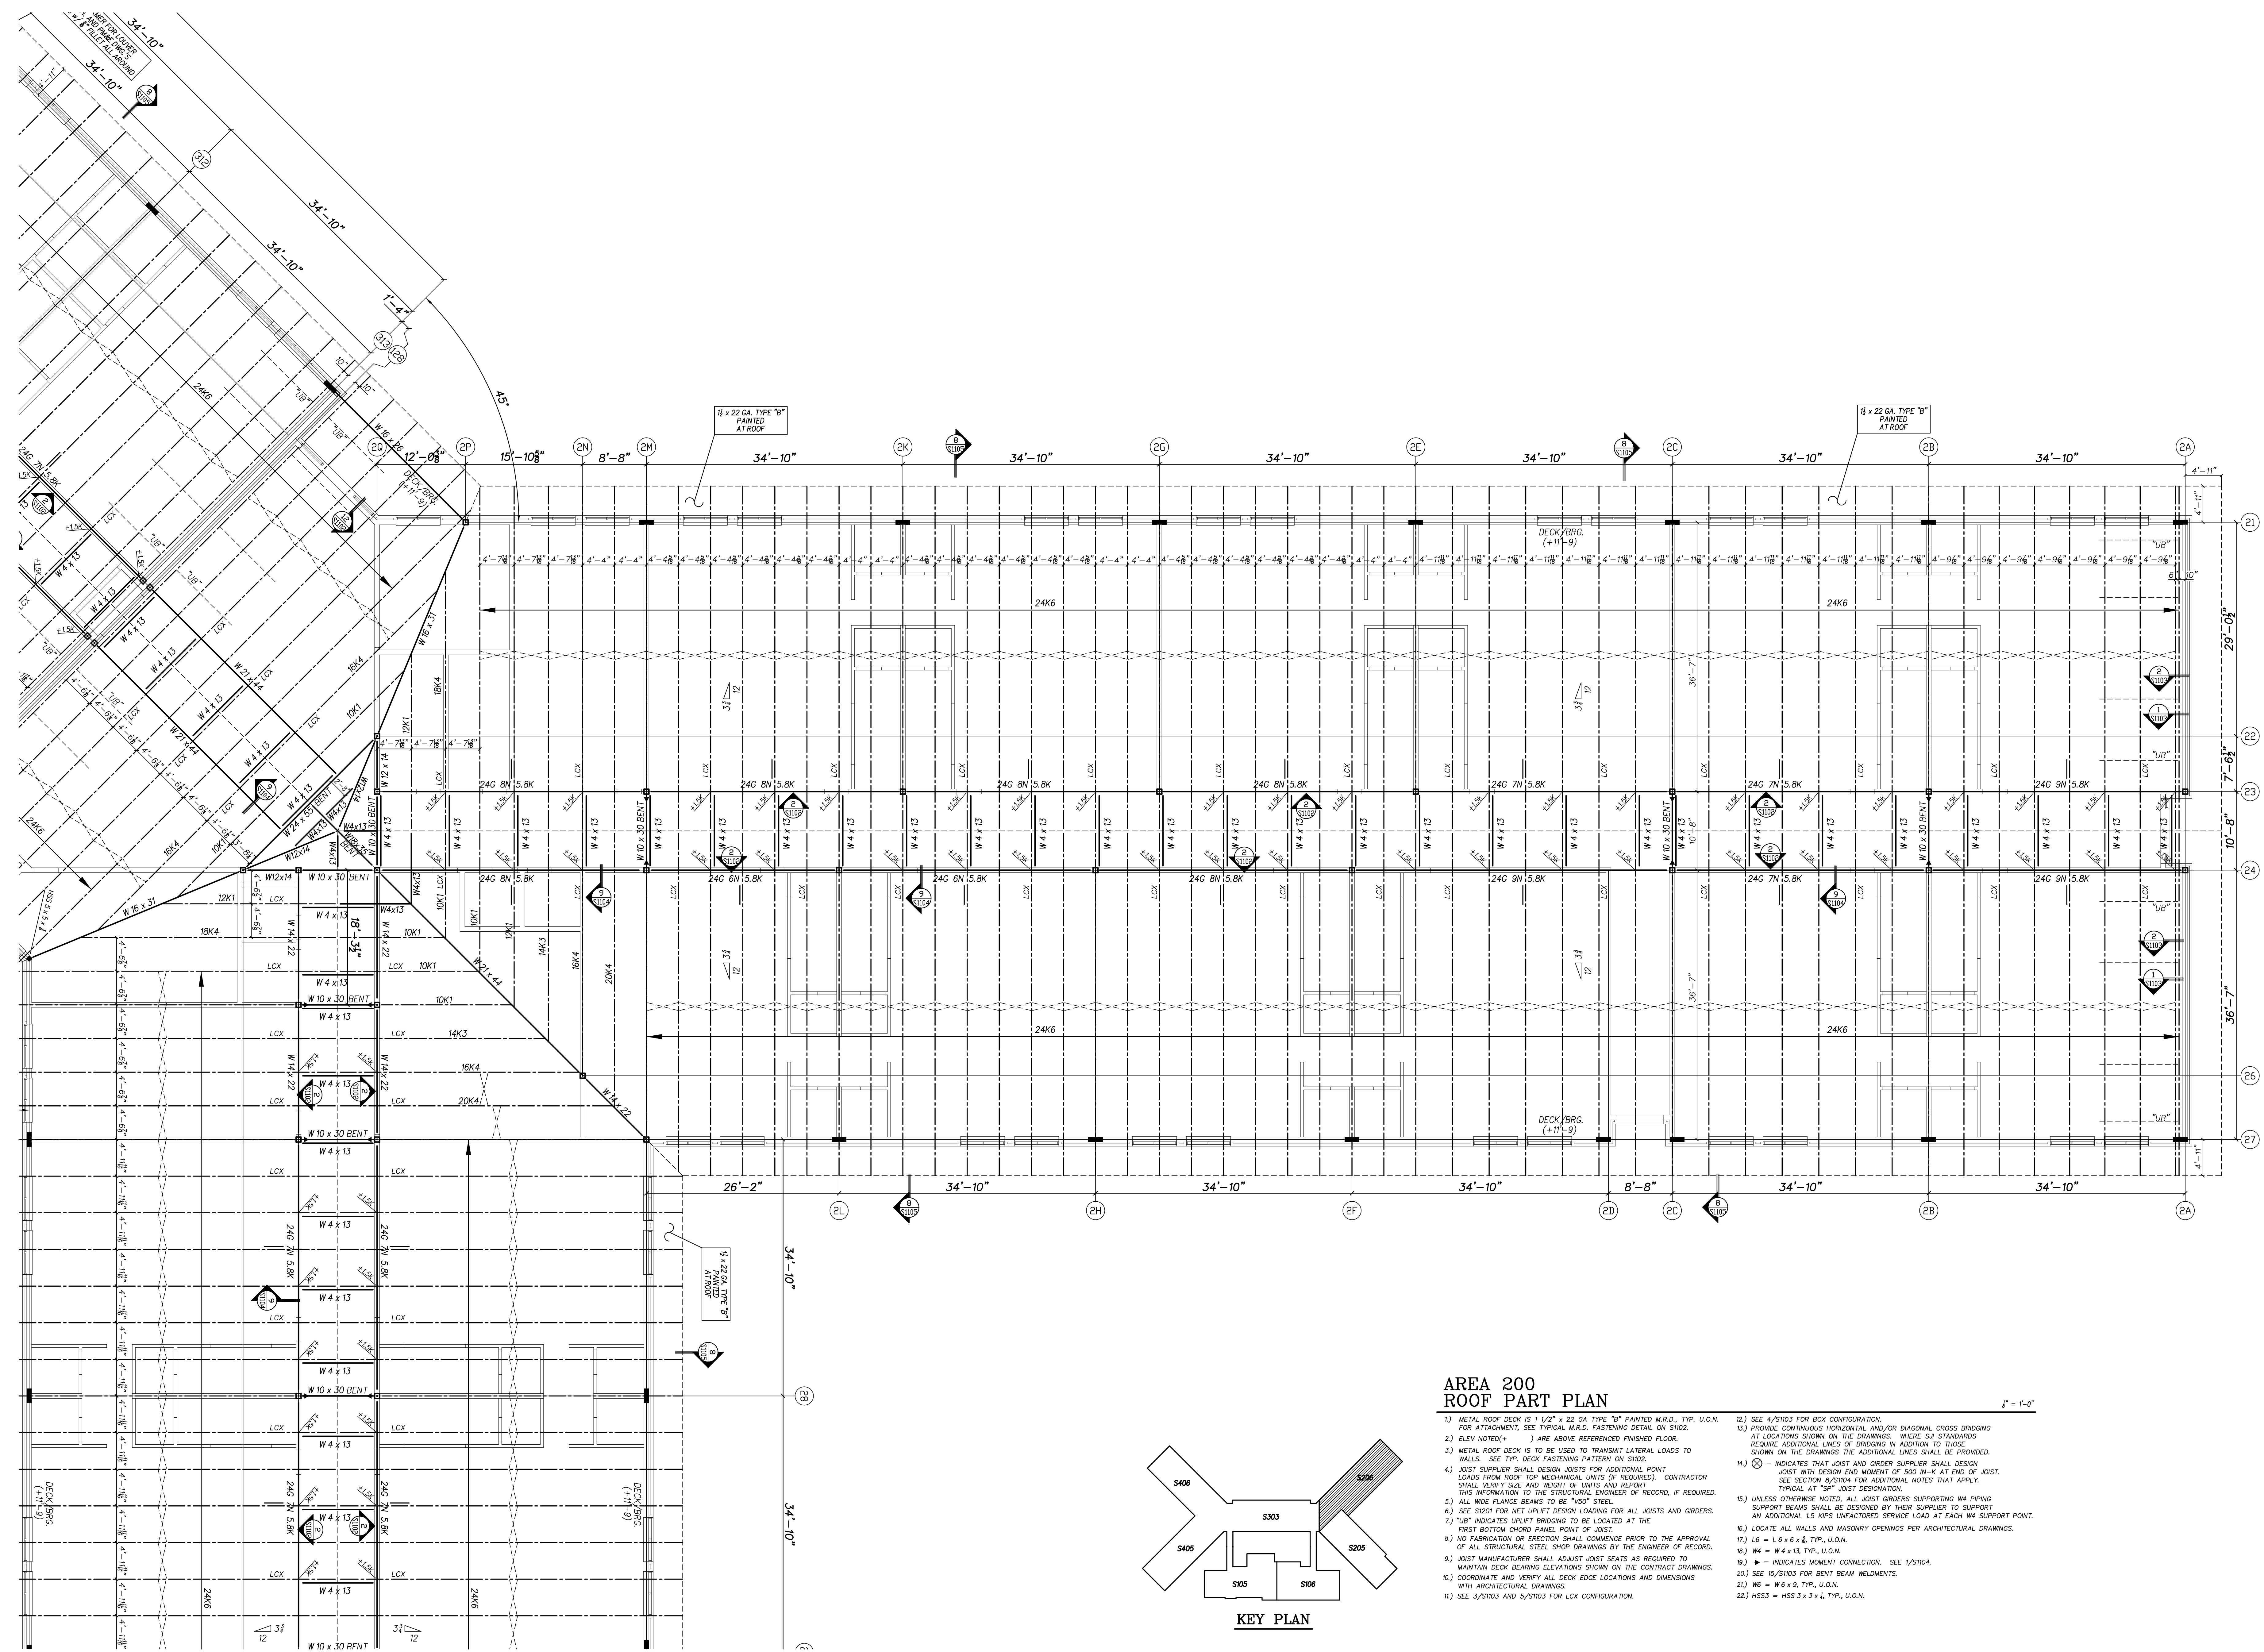

**AREA 200
ROOF PART PLAN**

- 1.) METAL ROOF DECK IS 1 1/2" x 22 GA TYPE "B" PAINTED M.R.D., TYP. U.O.N. FOR ATTACHMENT, SEE TYPICAL M.R.D. FASTENING DETAIL ON S102.
- 2.) ELEV. NOTED () ARE ABOVE REFERENCED FINISHED FLOOR.
- 3.) METAL ROOF DECK IS TO BE USED TO TRANSMIT LATERAL LOADS TO WALLS. SEE TYP. DECK FASTENING PATTERN ON S102.
- 4.) JOIST SUPPLIER SHALL DESIGN JOISTS FOR ADDITIONAL POINT LOADS FROM ROOF TOP MECHANICAL UNITS (IF REQUIRED). CONTRACTOR SHALL VERIFY SIZE AND WEIGHT OF UNITS AND REPORT THIS INFORMATION TO THE STRUCTURAL ENGINEER OF RECORD, IF REQUIRED.
- 5.) ALL WIDE FLANGE BEAMS TO BE "A50" STEEL.
- 6.) SEE S1021 FOR NET UPLIFT DESIGN LOADING FOR ALL JOISTS AND GIRDERS.
- 7.) "UB" INDICATES UPLIFT BRIDGING TO BE LOCATED AT THE FIRST BOTTOM CHORD PANEL POINT OF JOIST.
- 8.) NO FABRICATION OR ERECTION SHALL COMMENCE PRIOR TO THE APPROVAL OF ALL STRUCTURAL STEEL SHOP DRAWINGS BY THE ENGINEER OF RECORD.
- 9.) JOIST MANUFACTURER SHALL ADJUST JOIST SEATS AS REQUIRED TO MAINTAIN DECK BEARING ELEVATIONS SHOWN ON THE CONTRACT DRAWINGS.
- 10.) COORDINATE AND VERIFY ALL DECK EDGE LOCATIONS AND DIMENSIONS WITH ARCHITECTURAL DRAWINGS.
- 11.) SEE S10103 AND S10103 FOR LCX CONFIGURATION.
- 12.) SEE S10103 FOR BCX CONFIGURATION.
- 13.) PROVIDE CONTINUOUS HORIZONTAL AND/OR DIAGONAL CROSS BRIDGING AT LOCATIONS SHOWN ON THE DRAWINGS. WHERE S41 STANDARDS REQUIRE ADDITIONAL LINES OF BRIDGING IN ADDITION TO THOSE SHOWN ON THE DRAWINGS THE ADDITIONAL LINES SHALL BE PROVIDED.
- 14.) ⊗ - INDICATES THAT JOIST AND GIRDER SUPPLIER SHALL DESIGN JOIST WITH DESIGN END MOMENT OF 500 IN-K AT END OF JOIST. SEE SECTION S10104 FOR ADDITIONAL NOTES THAT APPLY. TYPICAL AT "SP" JOIST DESIGNATION.
- 15.) UNLESS OTHERWISE NOTED, ALL JOIST ORDERS SUPPORTING W4 PIPING SUPPORT BEAMS SHALL BE DESIGNED BY THEIR SUPPLIER TO SUPPORT AN ADDITIONAL 1.5 KIPS UNFACTORED SERVICE LOAD AT EACH W4 SUPPORT POINT.
- 16.) LOCATE ALL WALLS AND MASONRY OPENINGS PER ARCHITECTURAL DRAWINGS.
- 17.) L6 = L6 x 6 x 6, TYP. U.O.N.
- 18.) W4 = W4 x 13, TYP. U.O.N.
- 19.) ◻ = INDICATES MOMENT CONNECTION. SEE S10104.
- 20.) SEE S10103 FOR BENT BEAM WELDMENTS.
- 21.) W6 = W6 x 9, TYP. U.O.N.
- 22.) HSS3 = HSS 3 x 3 x 4, TYP. U.O.N.

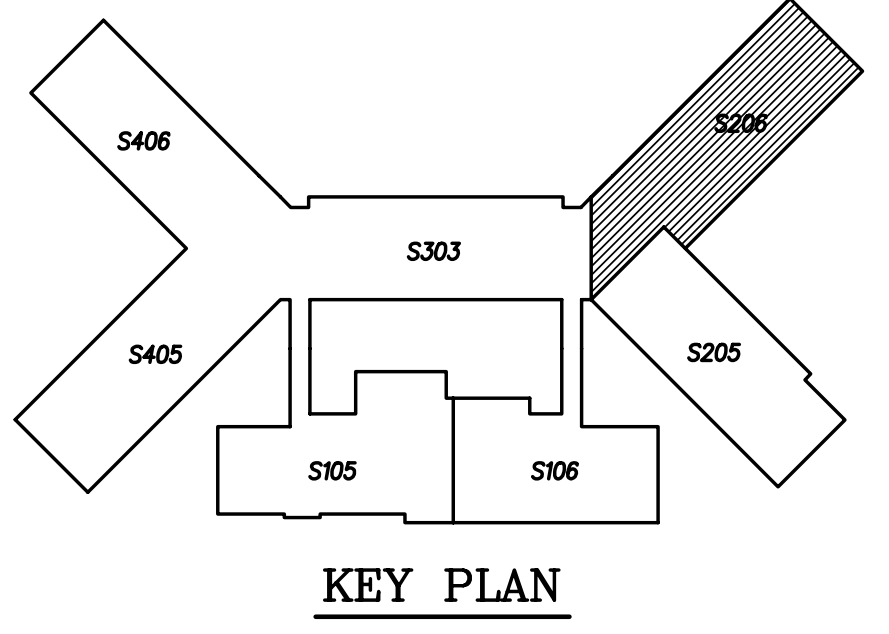


No.	Date	Revision

Hite associates
ARCHITECTURE / ENGINEERING / TECHNOLOGY
2600 Meridian Drive / Greenville, NC 27838 / tel (252) 757-0333

NE LIC C-1000
QED
QUEEN ENGINEERING & DESIGN
REGISTERED PROFESSIONAL ENGINEER
BRIDGE ENGINEER
09 OCT 2024

Beaufort PK-3 School
BEAUFORT COUNTY SCHOOLS
Washington / North Carolina / 27889

Project No. 22344
Date: 09 OCT 2024
Drawing No. S 206

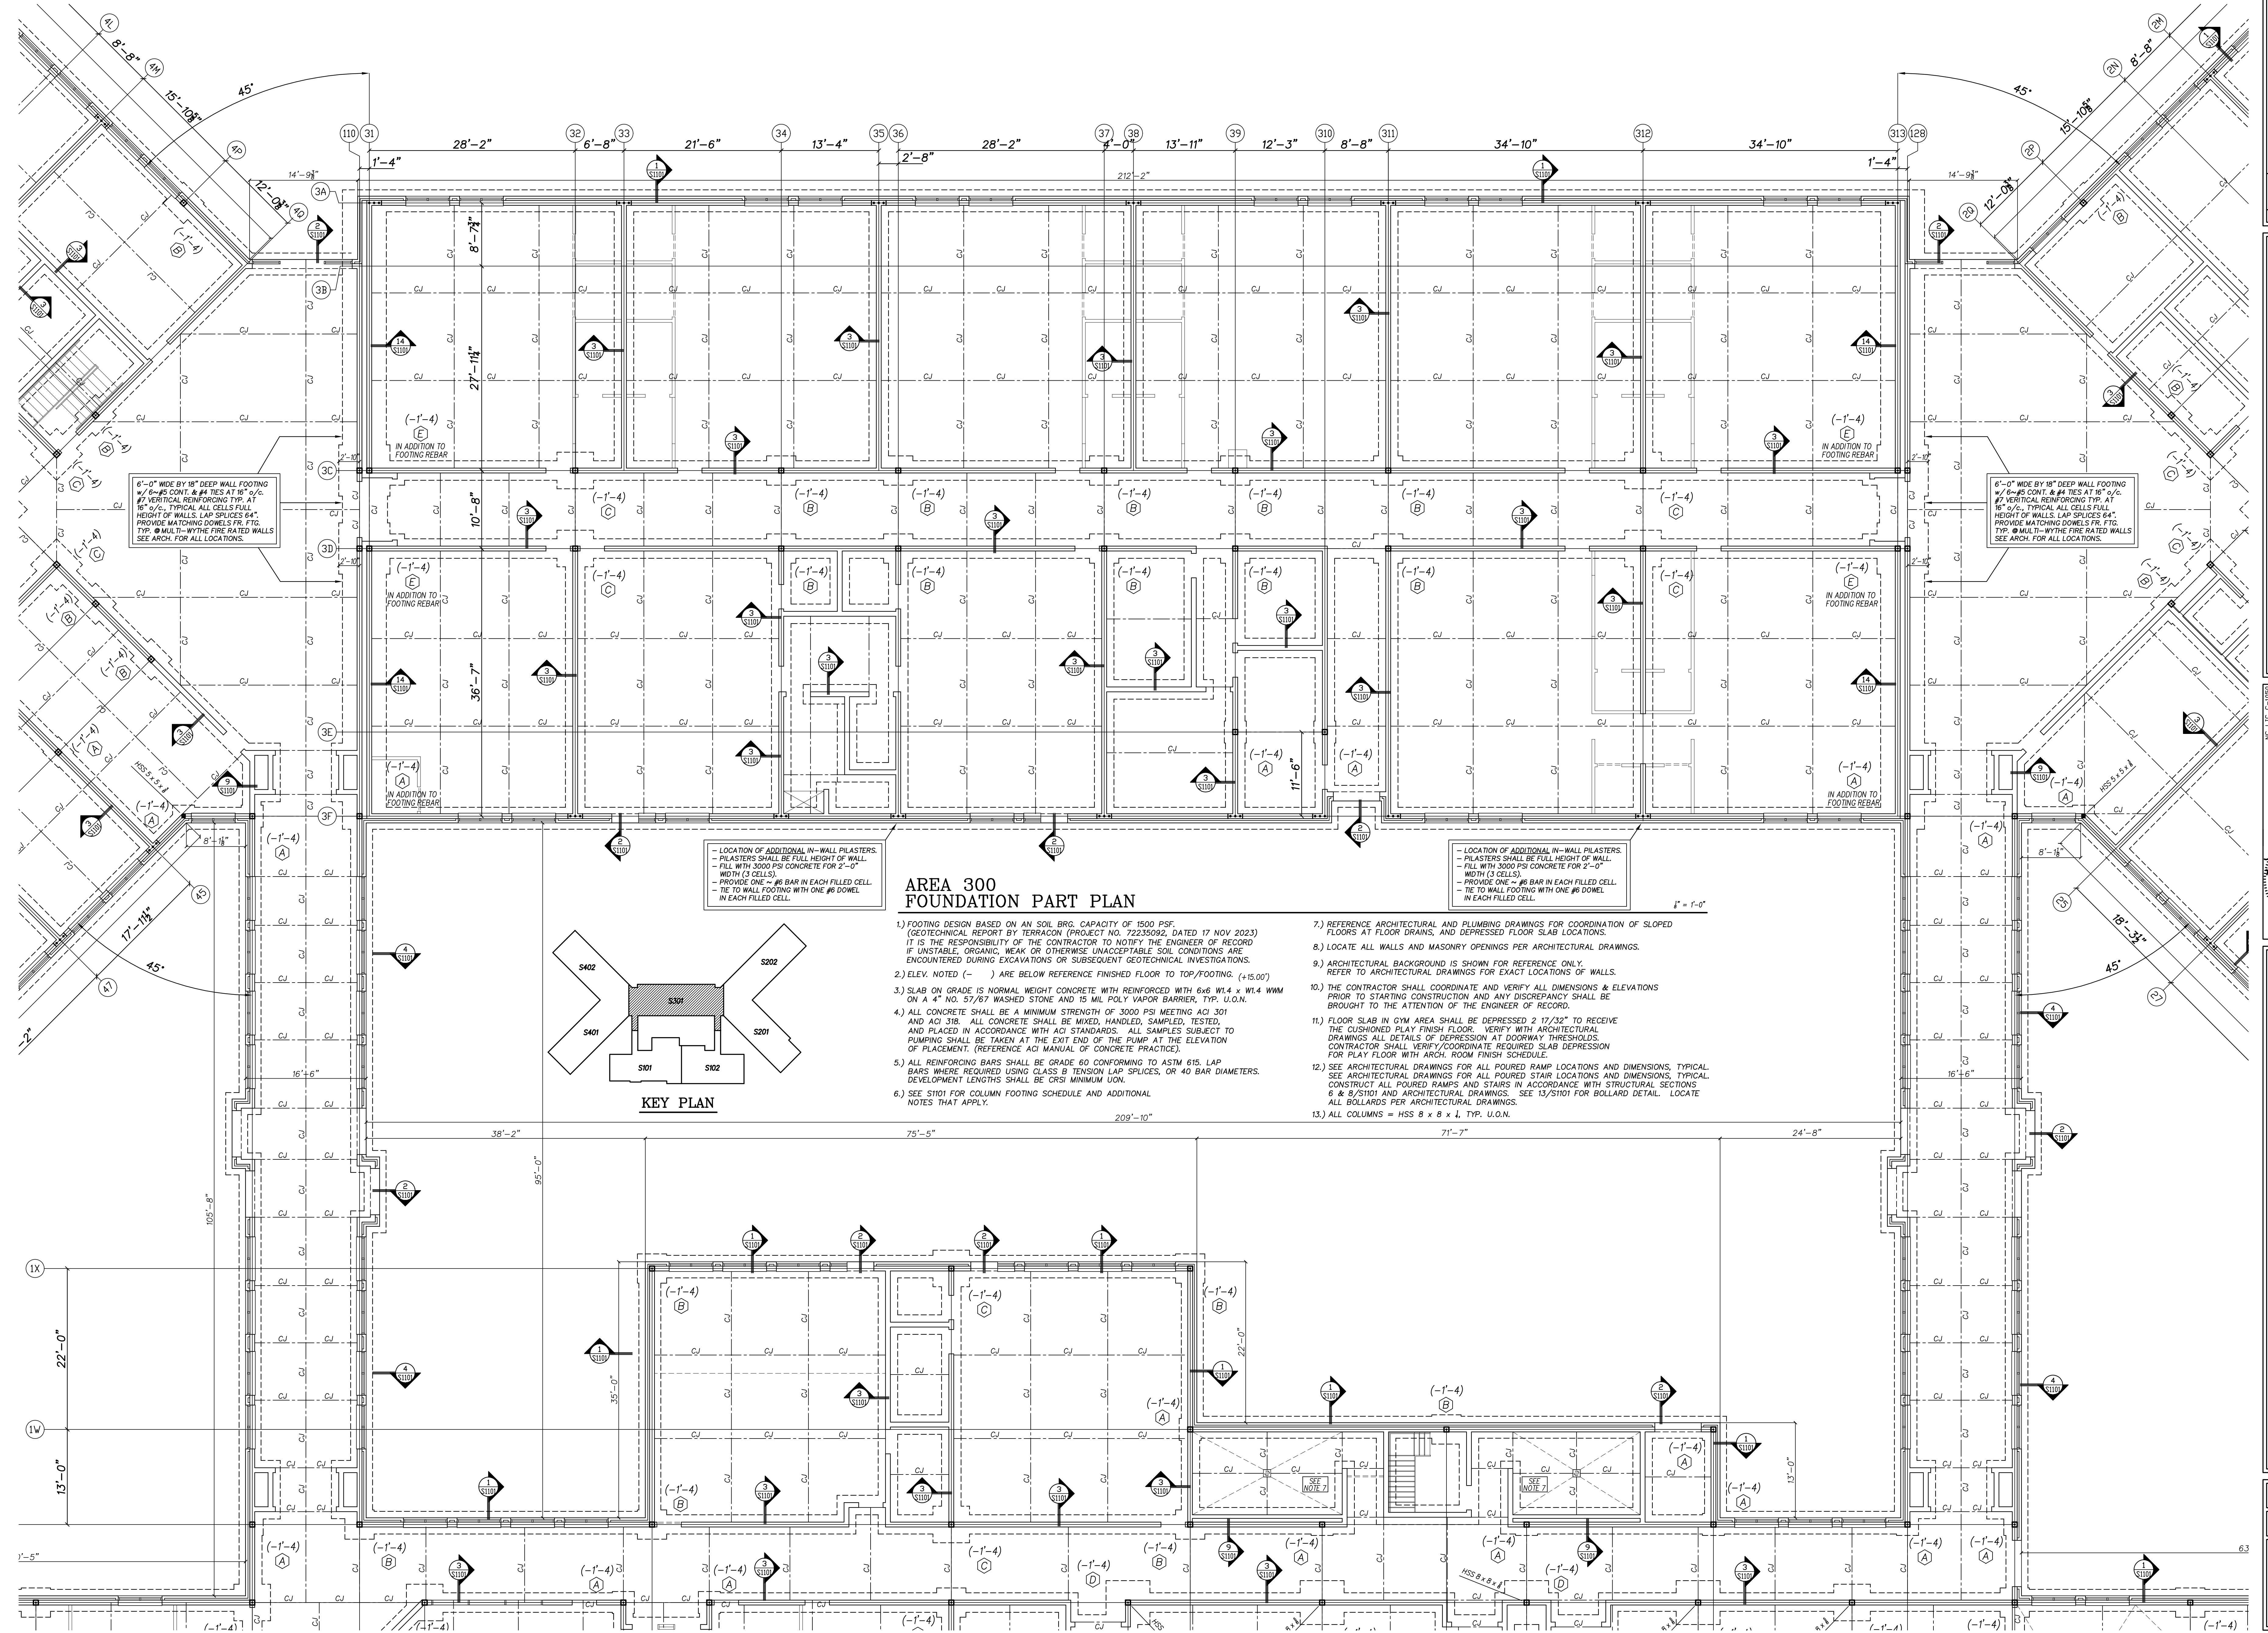

6'-0" WIDE BY 18" DEEP WALL FOOTING
#4 CONT. & #4 TIES AT 18" o/c.
#7 VERTICAL REINFORCING TYP. AT
18" o/c. TYPICAL ALL CELLS FULL
HEIGHT OF WALLS LAP SPICES 64".
PROVIDE MATCHING DOWELS FR. FTG.
TYP. # MULT-WYTHE FIRE RATED WALLS
SEE ARCH. FOR ALL LOCATIONS.


6'-0" WIDE BY 18" DEEP WALL FOOTING
#4 CONT. & #4 TIES AT 18" o/c.
#7 VERTICAL REINFORCING TYP. AT
18" o/c. TYPICAL ALL CELLS FULL
HEIGHT OF WALLS LAP SPICES 64".
PROVIDE MATCHING DOWELS FR. FTG.
TYP. # MULT-WYTHE FIRE RATED WALLS
SEE ARCH. FOR ALL LOCATIONS.

LOCATION OF ADDITIONAL IN-WALL PILASTERS.
PILASTERS SHALL BE FULL HEIGHT OF WALL.
FILL WITH 3000 PSI CONCRETE FOR 2'-0"
WIDTH (3 CELLS).
PROVIDE ONE #6 BAR IN EACH FILLED CELL.
TIE TO WALL FOOTING WITH ONE #6 DOWEL
IN EACH FILLED CELL.

LOCATION OF ADDITIONAL IN-WALL PILASTERS.
PILASTERS SHALL BE FULL HEIGHT OF WALL.
FILL WITH 3000 PSI CONCRETE FOR 2'-0"
WIDTH (3 CELLS).
PROVIDE ONE #6 BAR IN EACH FILLED CELL.
TIE TO WALL FOOTING WITH ONE #6 DOWEL
IN EACH FILLED CELL.

**AREA 300
FOUNDATION PART PLAN**

- 1.) FOOTING DESIGN BASED ON AN SOIL BRG. CAPACITY OF 1500 PSF. (GEOTECHNICAL REPORT BY TERRACON (PROJECT NO. 72235092, DATED 17 NOV 2023) IT IS THE RESPONSIBILITY OF THE CONTRACTOR TO NOTIFY THE ENGINEER OF RECORD IF UNSTABLE, ORGANIC, WEAK OR OTHERWISE UNACCEPTABLE SOIL CONDITIONS ARE ENCOUNTERED DURING EXCAVATIONS OR SUBSEQUENT GEOTECHNICAL INVESTIGATIONS.
- 2.) ELEV. NOTED (-) ARE BELOW REFERENCE FINISHED FLOOR TO TOP/FOOTING. (+15.00')
- 3.) SLAB ON GRADE IS NORMAL WEIGHT CONCRETE WITH REINFORCED WITH 6x6 W1.4 x W1.4 W/M ON A 4" NO. 57/67 WASHED STONE AND 15 MIL POLY VAPOR BARRIER, TYP. U.O.N.
- 4.) ALL CONCRETE SHALL BE A MINIMUM STRENGTH OF 3000 PSI MEETING ACI 301 AND ACI 318. ALL CONCRETE SHALL BE MIXED, HANDLED, SAMPLED, TESTED AND PLACED IN ACCORDANCE WITH ACI STANDARDS. ALL SAMPLES SUBJECT TO PUMPING SHALL BE TAKEN AT THE EXIT END OF THE PUMP AT THE ELEVATION OF PLACEMENT. (REFERENCE ACI MANUAL OF CONCRETE PRACTICE).
- 5.) ALL REINFORCING BARS SHALL BE GRADE 60 CONFORMING TO ASTM 615. LAP BARS WHERE REQUIRED USING CLASS B TENSION LAP SPICES, OR 40 BAR DIAMETERS. DEVELOPMENT LENGTHS SHALL BE CRSI MINIMUM UON.
- 6.) SEE S101 FOR COLUMN FOOTING SCHEDULE AND ADDITIONAL NOTES THAT APPLY.
- 7.) REFERENCE ARCHITECTURAL AND PLUMBING DRAWINGS FOR COORDINATION OF SLOPED FLOORS AT FLOOR DRAINS, AND DEPRESSED FLOOR SLAB LOCATIONS.
- 8.) LOCATE ALL WALLS AND MASONRY OPENINGS PER ARCHITECTURAL DRAWINGS.
- 9.) ARCHITECTURAL BACKGROUND IS SHOWN FOR REFERENCE ONLY. REFER TO ARCHITECTURAL DRAWINGS FOR EXACT LOCATIONS OF WALLS.
- 10.) THE CONTRACTOR SHALL COORDINATE AND VERIFY ALL DIMENSIONS & ELEVATIONS PRIOR TO STARTING CONSTRUCTION AND ANY DISCREPANCY SHALL BE BROUGHT TO THE ATTENTION OF THE ENGINEER OF RECORD.
- 11.) FLOOR SLAB IN GYM AREA SHALL BE DEPRESSED 2 17/32" TO RECEIVE THE CUSHIONED PLAY FINISH FLOOR. VERIFY WITH ARCHITECTURAL DRAWINGS ALL DETAILS OF DEPRESSION AT DOORWAY THRESHOLDS. CONTRACTOR SHALL COORDINATE REQUIRED SLAB DEPRESSION FOR PLAY FLOOR WITH ARCH. ROOM FINISH SCHEDULE.
- 12.) SEE ARCHITECTURAL DRAWINGS FOR ALL POURED RAMP LOCATIONS AND DIMENSIONS. TYPICAL SEE ARCHITECTURAL DRAWINGS FOR ALL POURED STAIR LOCATIONS AND DIMENSIONS. TYPICAL CONSTRUCT ALL POURED RAMPS AND STAIRS IN ACCORDANCE WITH STRUCTURAL SECTIONS 6 & 8/S101 AND ARCHITECTURAL DRAWINGS. SEE 13/S101 FOR BOLLARD DETAIL. LOCATE ALL BOLLARDS PER ARCHITECTURAL DRAWINGS.
- 13.) ALL COLUMNS = HSS 8 x 8 x 1, TYP. U.O.N.

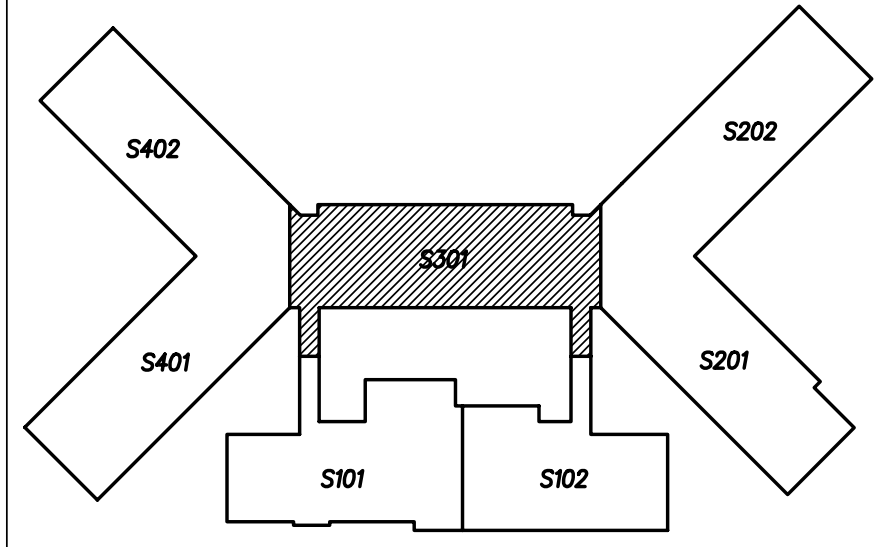


Hite associates
ARCHITECTURE/ENGINEERING/TECHNOLOGY
2600 Meridian Drive / Greenville, NC 27838 / tel (252) 757-0333

QED
QUINN ENGINEERING & DESIGN
ARCHITECTURE/ENGINEERING/TECHNOLOGY
1000 W. WOOD ST. SUITE 400
GREENVILLE, NC 27834
PH: 252.757.0333
WWW.QED-NC.COM

Prince Green
NORTH CAROLINA
REGISTERED PROFESSIONAL ENGINEER
18991
BRUCE QUINN
09 OCT 2024

Project No. 22344
Date: 09 OCT 2024
Drawing No. S 301



Beaufort PK-3 School
BEAUFORT COUNTY SCHOOLS
Washington / North Carolina / 27889

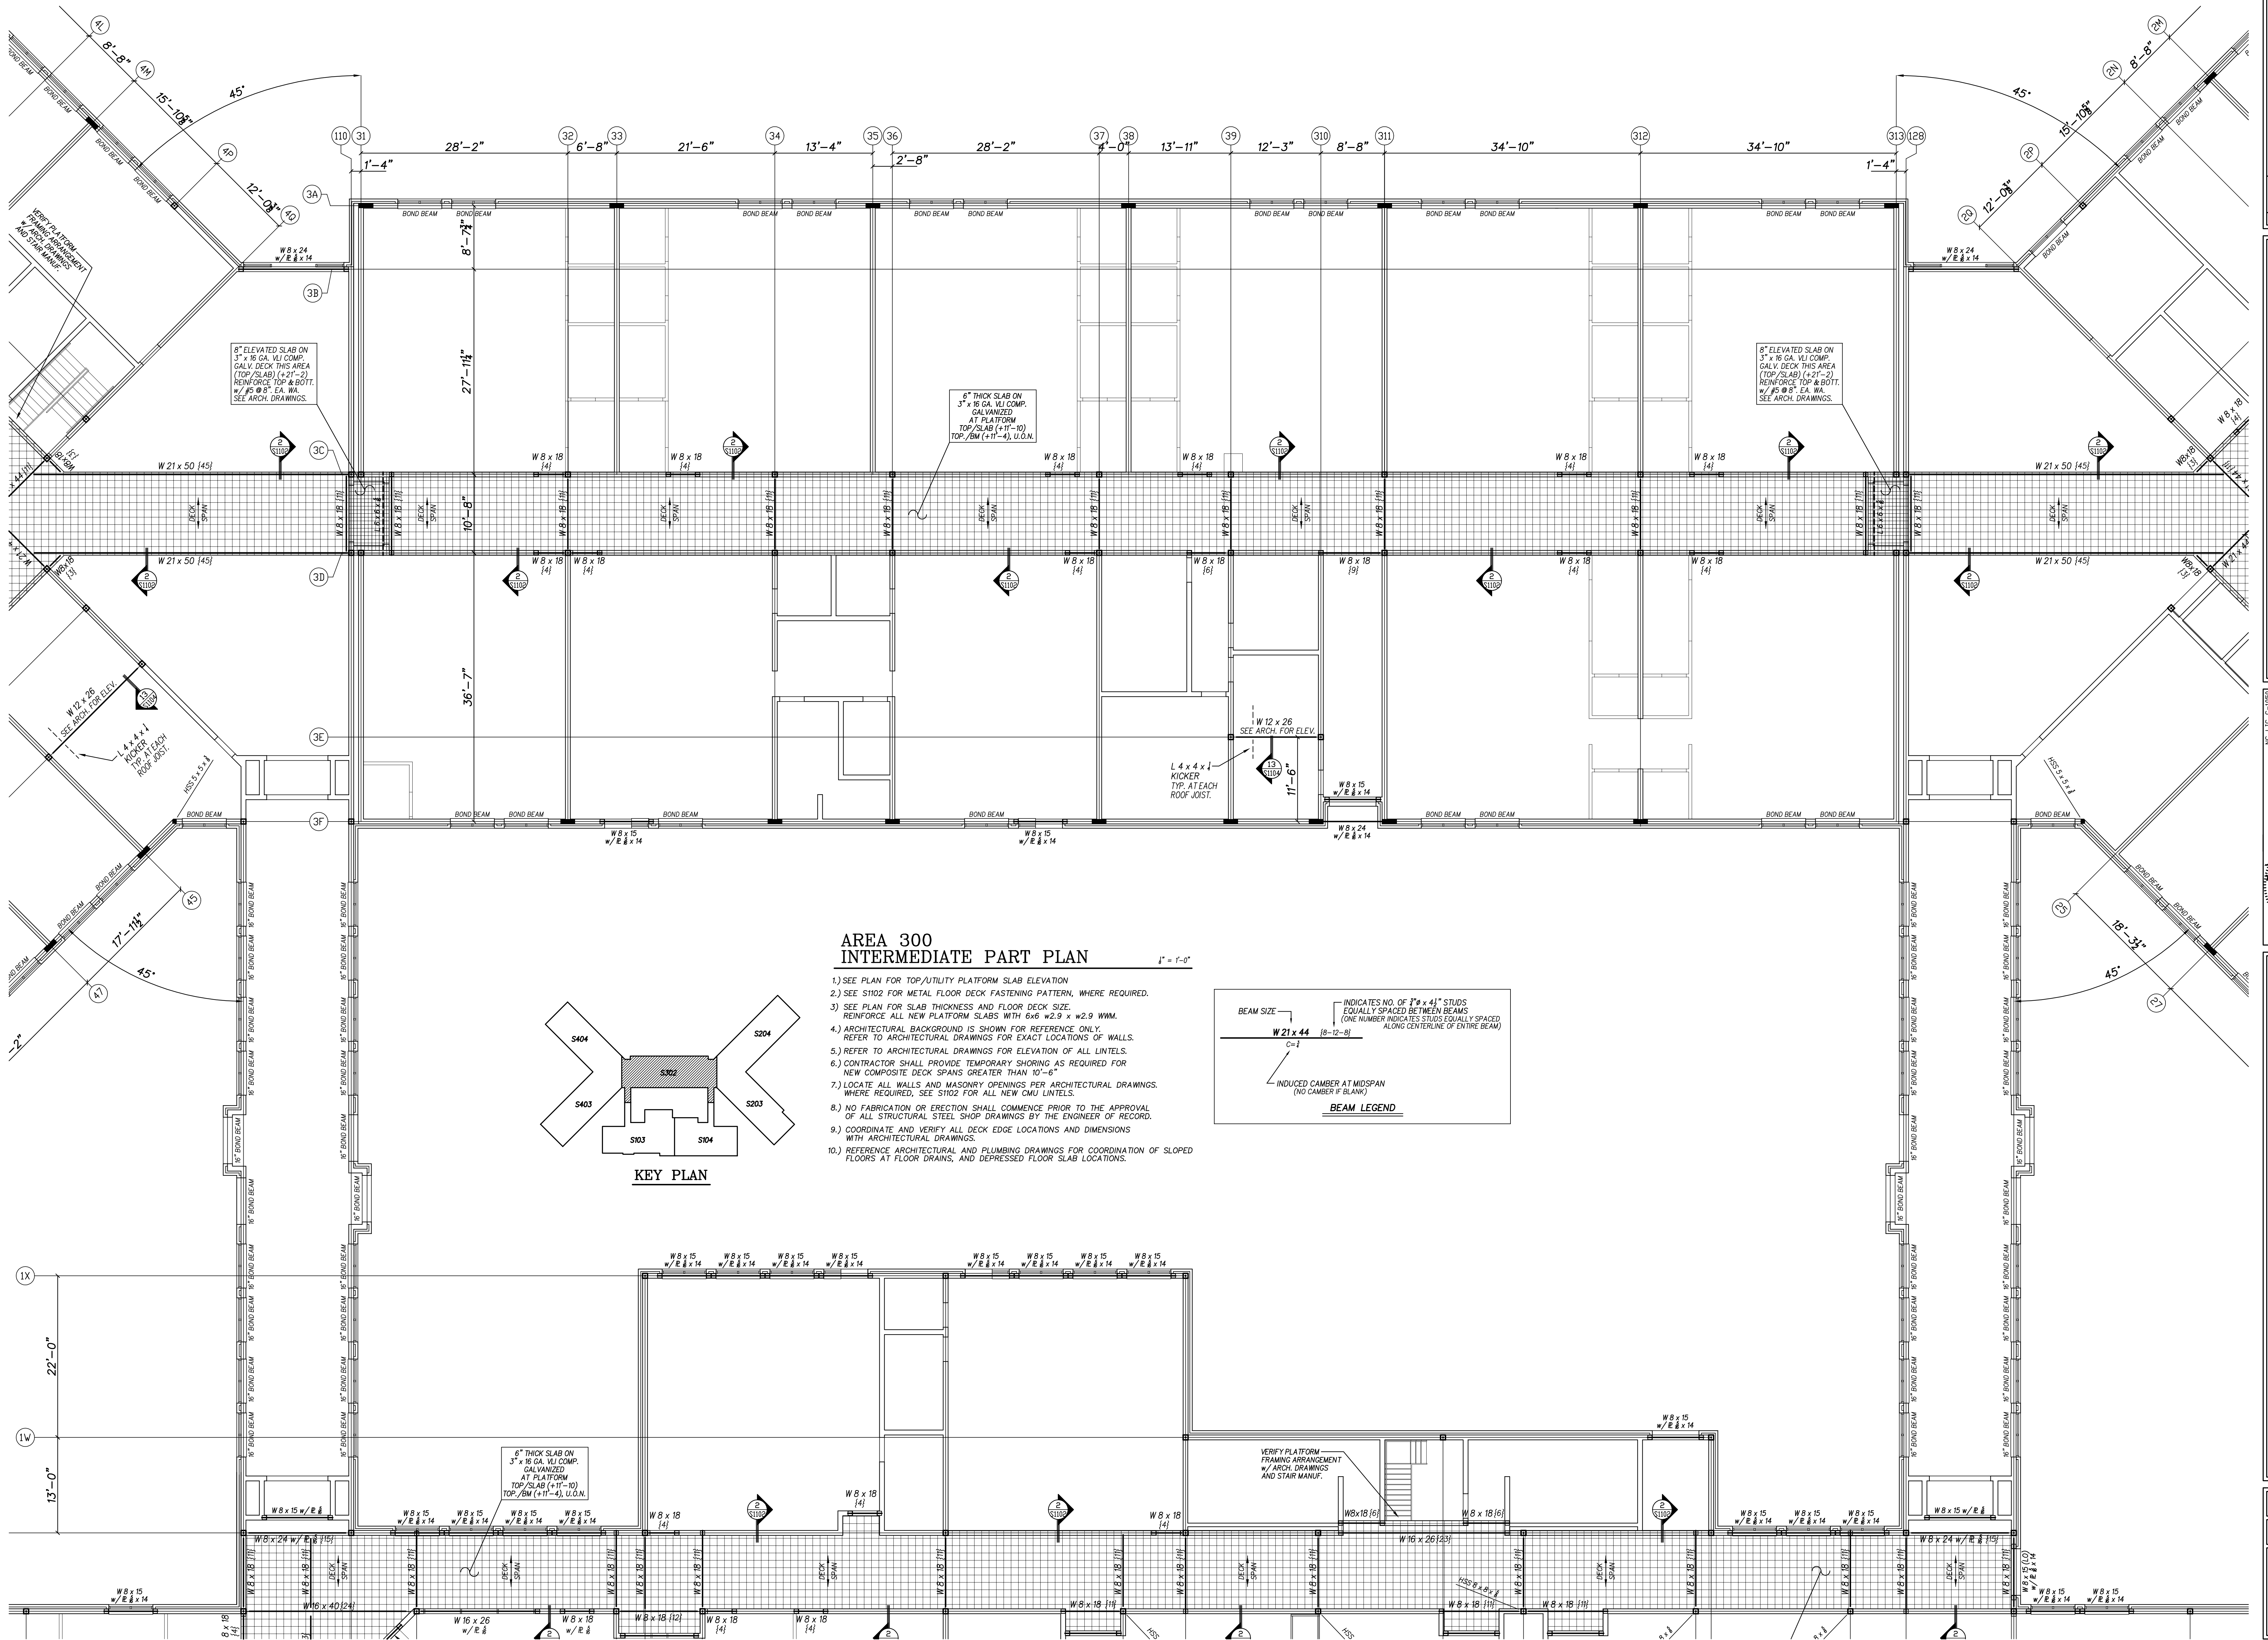

**AREA 300
INTERMEDIATE PART PLAN**

1" = 1'-0"

- 1.) SEE PLAN FOR TOP/UTILITY PLATFORM SLAB ELEVATION
- 2.) SEE S102 FOR METAL FLOOR DECK FASTENING PATTERN, WHERE REQUIRED.
- 3.) SEE PLAN FOR SLAB THICKNESS AND FLOOR DECK SIZE.
- 4.) REINFORCE ALL NEW PLATFORM SLABS WITH 6x6 w2.9 x w2.9 WWM.
- 5.) ARCHITECTURAL BACKGROUND IS SHOWN FOR REFERENCE ONLY. REFER TO ARCHITECTURAL DRAWINGS FOR EXACT LOCATIONS OF WALLS.
- 6.) REFER TO ARCHITECTURAL DRAWINGS FOR ELEVATION OF ALL LINTELS.
- 7.) CONTRACTOR SHALL PROVIDE TEMPORARY SHORING AS REQUIRED FOR NEW COMPOSITE DECK SPANS GREATER THAN 10'-6"
- 8.) LOCATE ALL WALLS AND MASONRY OPENINGS PER ARCHITECTURAL DRAWINGS. WHERE REQUIRED, SEE S102 FOR ALL NEW CMU LINTELS.
- 9.) NO FABRICATION OR ERECTION SHALL COMMENCE PRIOR TO THE APPROVAL OF ALL STRUCTURAL STEEL SHOP DRAWINGS BY THE ENGINEER OF RECORD.
- 10.) COORDINATE AND VERIFY ALL DECK EDGE LOCATIONS AND DIMENSIONS WITH ARCHITECTURAL DRAWINGS.
- 11.) REFERENCE ARCHITECTURAL AND PLUMBING DRAWINGS FOR COORDINATION OF SLOPED FLOORS AT FLOOR DRAINS, AND DEPRESSED FLOOR SLAB LOCATIONS.

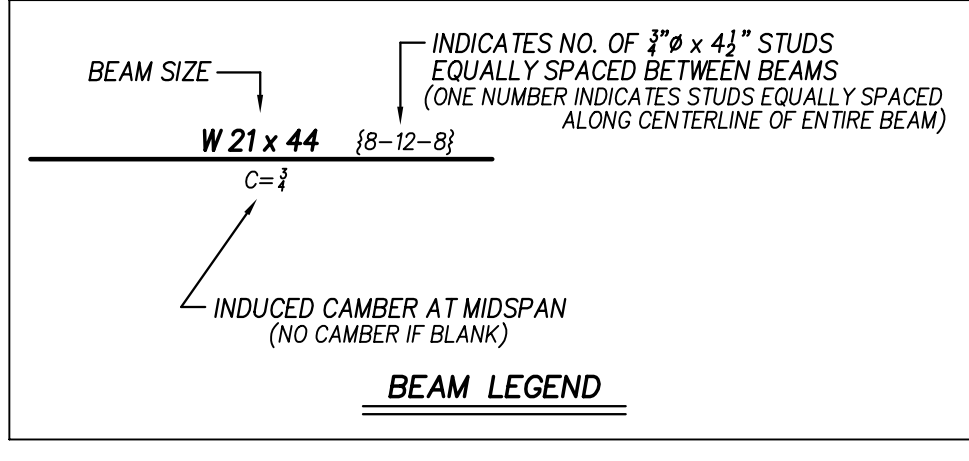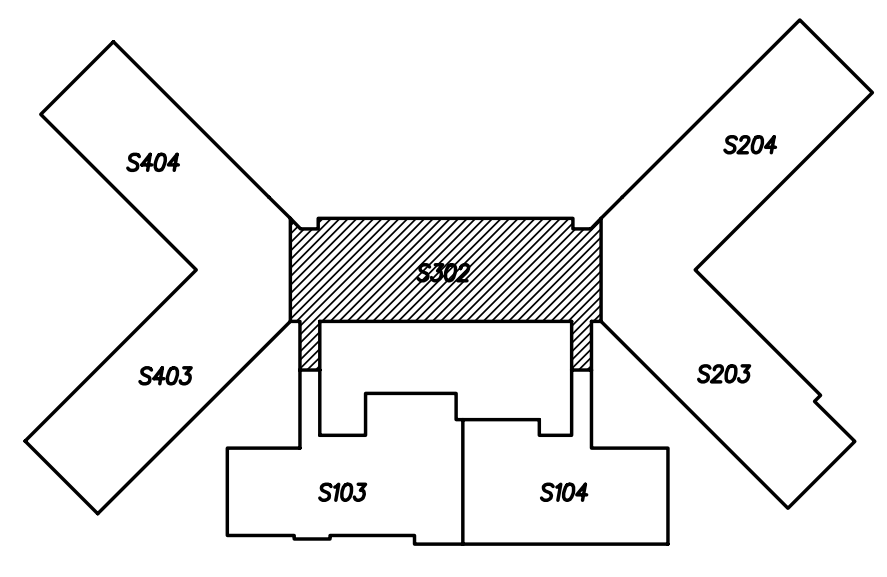


No.	Date	Revision

Hite associates
 ARCHITECTURE / ENGINEERING / TECHNOLOGY
 2600 Meridian Drive / Greenville, NC 27858 / tel (252) 757-0333

QED
 QUEEN ENGINEERING & DESIGN
 1000 W. WILSON DRIVE, SUITE 4115
 WASHINGTON, NC 27883
 NC LIC. C-10242
 ENGINEER
 BRUCE L. QUEEN
 09 OCT 2024


Beaufort PK-3 School
 BEAUFORT COUNTY SCHOOLS
 Washington / North Carolina / 27889

Project No. 22344
 Date: 09 OCT 2024
 Drawing no. S 302

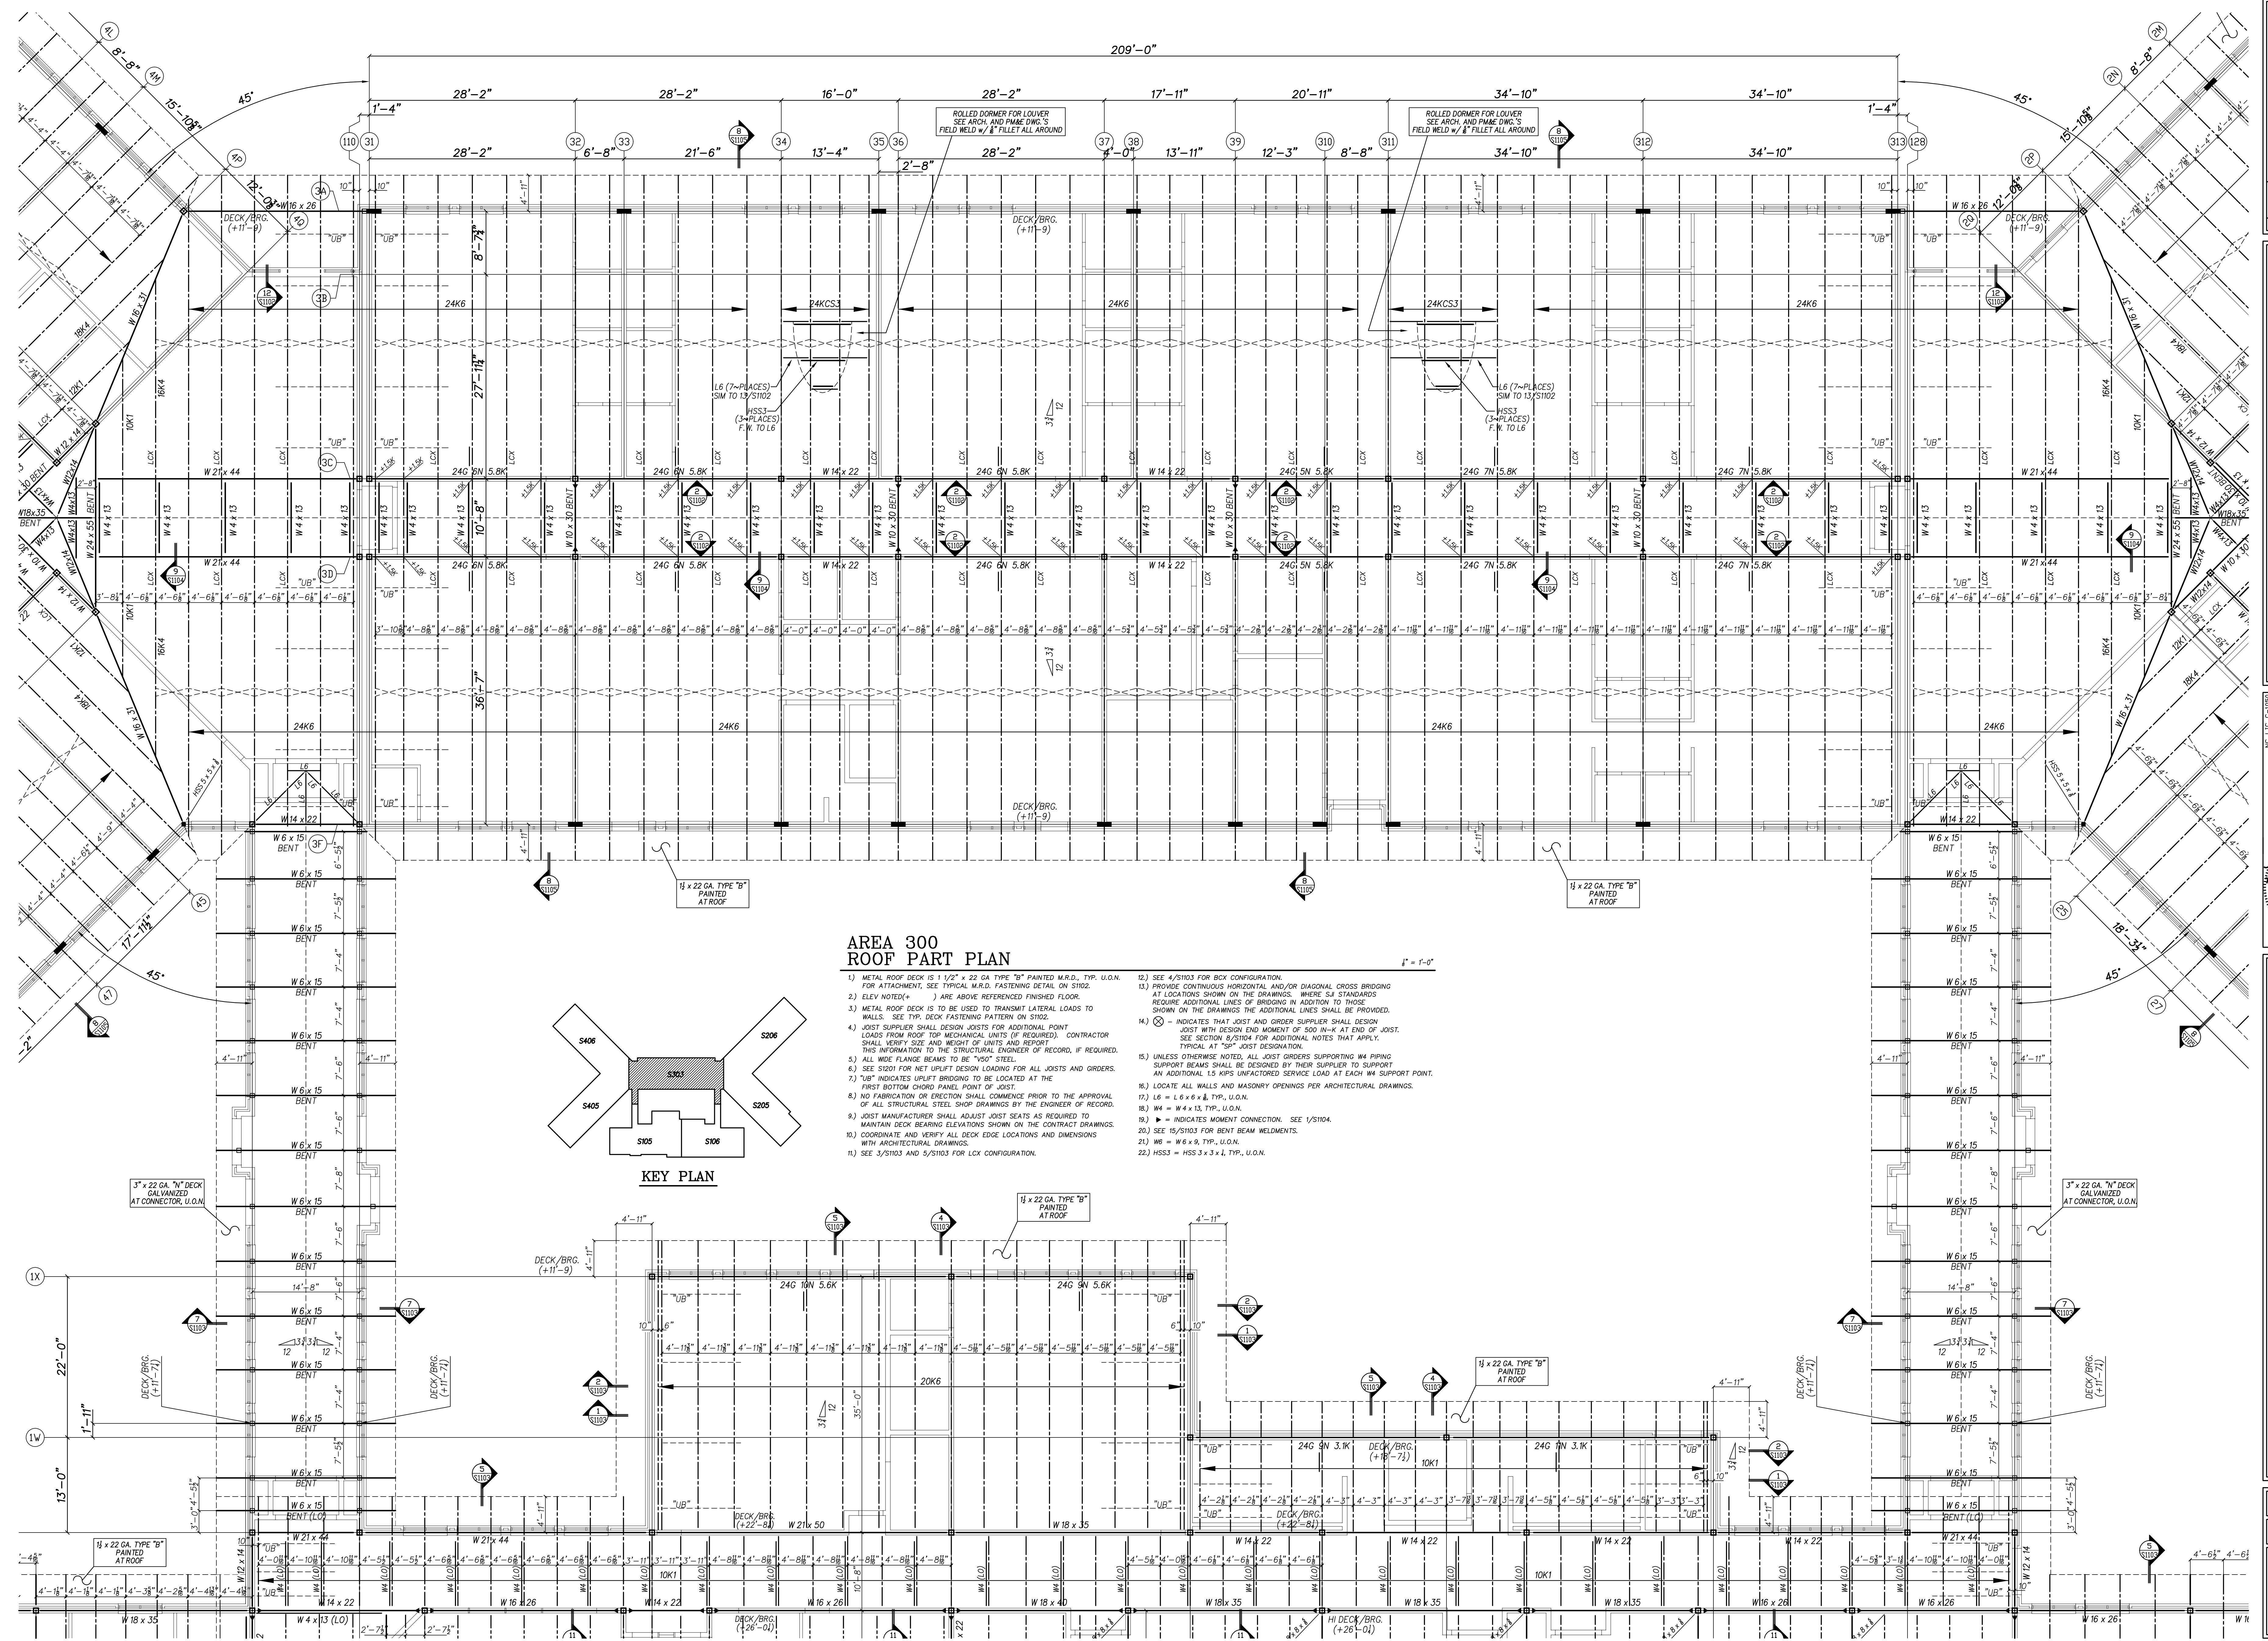

**AREA 300
ROOF PART PLAN**

- 1) METAL ROOF DECK IS 1/2" x 22 GA TYPE "B" PAINTED M.R.D., TYP. U.O.N. FOR ATTACHMENT, SEE TYPICAL M.A.D. FASTENING DETAIL ON S102.
- 2) ELEV NOTED (+) ARE ABOVE REFERENCED FINISHED FLOOR.
- 3) METAL ROOF DECK IS TO BE USED TO TRANSMIT LATERAL LOADS TO WALLS. SEE TYP. DECK FASTENING PATTERN ON S102.
- 4) JOIST SUPPLIER SHALL DESIGN JOISTS FOR ADDITIONAL POINT LOADS FROM ROOF MECHANICAL UNITS (IF REQUIRED). CONTRACTOR SHALL VERIFY SIZE AND HEIGHT OF UNITS AND REPORT THIS INFORMATION TO THE STRUCTURAL ENGINEER OF RECORD, IF REQUIRED.
- 5) ALL WIDE FLANGE BEAMS TO BE "A50" STEEL.
- 6) SEE S201 FOR NET UPLIFT DESIGN LOADINGS FOR ALL JOISTS AND GIRDERS.
- 7) "UB" INDICATES UPLIFT BRIDGING TO BE LOCATED AT THE FIRST BOTTOM CHORD PANEL POINT OF JOIST.
- 8) NO FABRICATION OR ERECTION SHALL COMMENCE PRIOR TO THE APPROVAL OF ALL STRUCTURAL STEEL SHOP DRAWINGS BY THE ENGINEER OF RECORD.
- 9) JOIST MANUFACTURER SHALL ADJUST JOIST SEATS AS REQUIRED TO MAINTAIN DECK BEARING ELEVATIONS SHOWN ON THE CONTRACT DRAWINGS.
- 10) COORDINATE AND VERIFY ALL DECK EDGE LOCATIONS AND DIMENSIONS WITH ARCHITECTURAL DRAWINGS.
- 11) SEE S/5103 AND S/5103 FOR LCK CONFIGURATION.
- 12) SEE S/20103 FOR BEY CONFIGURATION.
- 13) PROVIDE CONTINUOUS HORIZONTAL AND/OR DIAGONAL CROSS BRIDGING AT LOCATIONS SHOWN ON THE DRAWINGS. WHERE S/J STANDARDS REQUIRE ADDITIONAL LINES OF BRIDGING IN ADDITION TO THOSE SHOWN ON THE DRAWINGS THE ADDITIONAL LINES SHALL BE PROVIDED.
- 14) ⊗ INDICATES THAT JOIST AND GIRDER SUPPLIER SHALL DESIGN JOIST WITH DESIGN END MOMENT OF 150 IN-K AT END OF JOIST. SEE SECTION S/5104 FOR ADDITIONAL NOTES THAT APPLY. TYPICAL AT "SP" JOIST DESIGNATION.
- 15) UNLESS OTHERWISE NOTED, ALL JOIST GIRDERS SUPPORTING W4 PIPING SUPPORT BEAMS SHALL BE DESIGNED BY THEIR SUPPLIER TO SUPPORT AN ADDITIONAL 1.5 KIIPS UNFACTORED SERVICE LOAD AT EACH W4 SUPPORT POINT.
- 16) LOCATE ALL WALLS AND MASONRY OPENINGS PER ARCHITECTURAL DRAWINGS.
- 17) L6 = L6 x 6 x 8, TYP., U.O.N.
- 18) W4 = W4 x 13, TYP., U.O.N.
- 19) ▶ = INDICATES MOMENT CONNECTION. SEE S/5104.
- 20) SEE S/5103 FOR BENT BEAM WELDMENTS.
- 21) W6 = W6 x 9, TYP., U.O.N.
- 22) HSS3 = HSS 3 x 3 x 1/4, TYP., U.O.N.

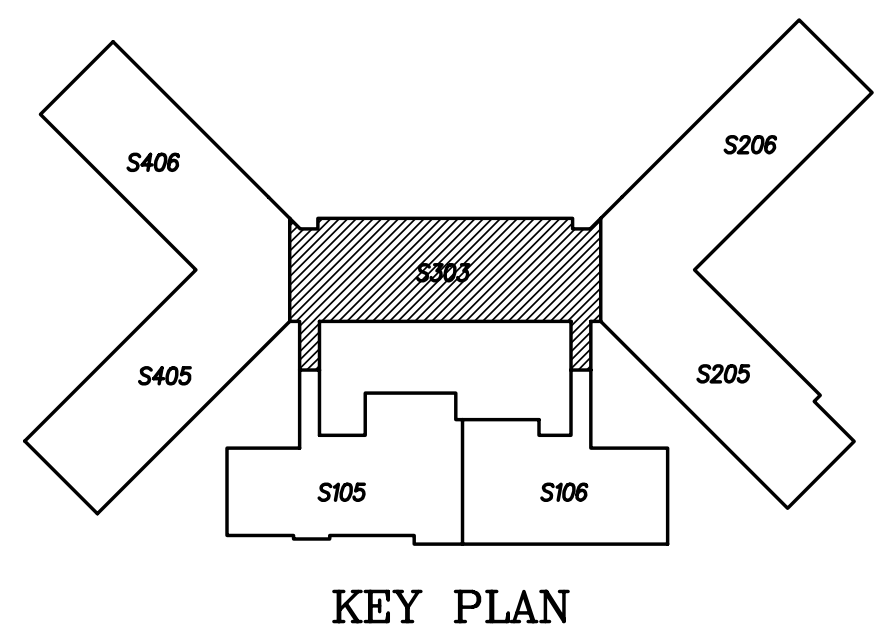

No.	Date	Revision

Hite associates
ARCHITECTURE / ENGINEERING / TECHNOLOGY
2600 Meridian Drive / Greenville, NC 27838 / tel (252) 757-0333

QED
QUEEN ENGINEERING & DESIGN
REGISTERED PROFESSIONAL ENGINEER
STATE OF NORTH CAROLINA
NO. 10000
1989

Prince Owen
REGISTERED PROFESSIONAL ENGINEER
STATE OF NORTH CAROLINA
NO. 10000
1989


09 OCT 2024

Beaufort PK-3 School
BEAUFORT COUNTY SCHOOLS
Washington / North Carolina / 27889

Project No. 22344
Date: 09 OCT 2024
Drawing No. S 303

AREA 400 FOUNDATION PART PLAN


1" = 1'-0"

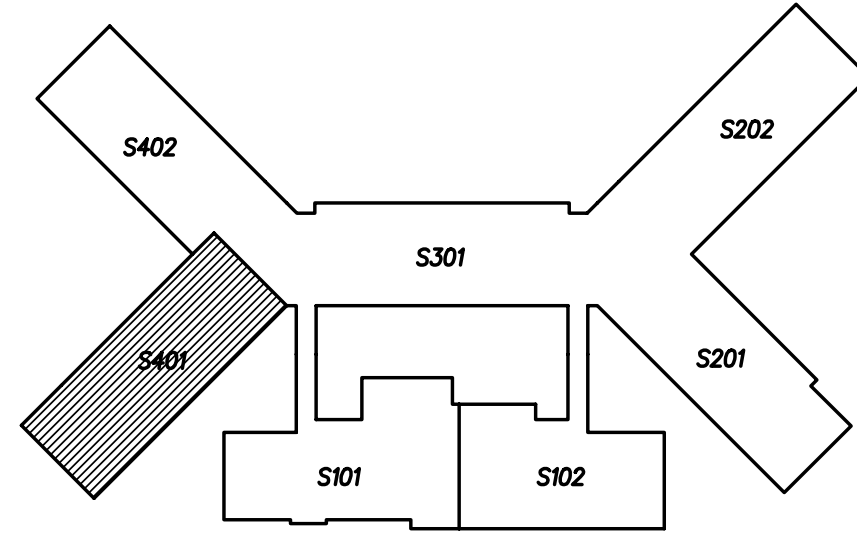

KEY PLAN

- 1.) FOOTING DESIGN BASED ON AN SOIL BRG. CAPACITY OF 1500 PSF. (GEO TECHNICAL REPORT BY TERRACON (PROJECT NO. 72235092, DATED 17 NOV 2023). IT IS THE RESPONSIBILITY OF THE CONTRACTOR TO NOTIFY THE ENGINEER OF RECORD IF UNSTABLE, ORGANIC, WEAK OR OTHERWISE UNACCEPTABLE SOIL CONDITIONS ARE ENCOUNTERED DURING EXCAVATIONS OR SUBSEQUENT GEO TECHNICAL INVESTIGATIONS.
- 2.) ELEV. NOTED (-) ARE BELOW REFERENCE FINISHED FLOOR TO TOP OF FOOTING. (+15.00')
- 3.) SLAB ON GRADE IS NORMAL WEIGHT CONCRETE WITH REINFORCED WITH 6x6 W14 x W14 W/M ON A 4" NO. 37/67 WASHED STONE AND 15 MIL POLY VAPOR BARRIER, TYP. U.O.N.
- 4.) ALL CONCRETE SHALL BE A MINIMUM STRENGTH OF 3000 PSI MEETING ACI 301 AND ACI 318. ALL CONCRETE SHALL BE MIXED, HANDLED, SAMPLED, TESTED, AND PLACED IN ACCORDANCE WITH ACI STANDARDS. ALL SAMPLES SUBJECT TO PUMPING SHALL BE TAKEN AT THE EXIT END OF THE PUMP AT THE ELEVATION OF PLACEMENT. (REFERENCE ACI MANUAL OF CONCRETE PRACTICE).
- 5.) ALL REINFORCING BARS SHALL BE GRADE 60 CONFORMING TO ASTM 615. LAP BARS WHERE REQUIRED USING CLASS B TENSION LAP SPLICES, OR 40 BAR DIAMETERS. DEVELOPMENT LENGTHS SHALL BE CRSI MINIMUM UO.N.
- 6.) SEE S101 FOR COLUMN FOOTING SCHEDULE AND ADDITIONAL NOTES THAT APPLY.
- 7.) REFERENCE ARCHITECTURAL AND PLUMBING DRAWINGS FOR COORDINATION OF SLOPED FLOORS AT FLOOR DRAINS, AND DEPRESSED FLOOR SLAB LOCATIONS.
- 8.) LOCATE ALL WALLS AND MASONRY OPENINGS PER ARCHITECTURAL DRAWINGS.
- 9.) ARCHITECTURAL BACKGROUND IS SHOWN FOR REFERENCE ONLY. REFER TO ARCHITECTURAL DRAWINGS FOR EXACT LOCATIONS OF WALLS.
- 10.) THE CONTRACTOR SHALL COORDINATE AND VERIFY ALL DIMENSIONS & ELEVATIONS PRIOR TO STARTING CONSTRUCTION AND ANY DISCREPANCY SHALL BE BROUGHT TO THE ATTENTION OF THE ENGINEER OF RECORD.
- 11.) FLOOR SLAB IN GYM AREA SHALL BE DEPRESSED 2 17/32" TO RECEIVE THE CUSHIONED PLAY FINISH FLOOR. VERIFY WITH ARCHITECTURAL DRAWINGS ALL DETAILS OF DEPRESSION AT DOORWAY THRESHOLDS. CONTRACTOR SHALL VERIFY/COORDINATE REQUIRED SLAB DEPRESSION FOR PLAY FLOOR WITH ARCH. ROOM FINISH SCHEDULE.
- 12.) SEE ARCHITECTURAL DRAWINGS FOR ALL POURED RAMP LOCATIONS AND DIMENSIONS. TYPICAL SEE ARCHITECTURAL DRAWINGS FOR ALL POURED STAIR LOCATIONS AND DIMENSIONS. TYPICAL CONSTRUCT ALL POURED RAMPS AND STAIRS IN ACCORDANCE WITH STRUCTURAL SECTIONS 6 & 8/S101 AND ARCHITECTURAL DRAWINGS. SEE 13/S101 FOR BOLLARD DETAIL. LOCATE ALL BOLLARDS PER ARCHITECTURAL DRAWINGS.
- 13.) ALL COLUMNS = HSS 8 x 8 x 4, TYP. U.O.N.

LOCATION OF ADDITIONAL IN-WALL PILASTERS.
 - PILASTERS SHALL BE FULL HEIGHT OF WALL.
 - FILL WITH 3000 PSI CONCRETE FOR 2'-0" WIDTH (3 CELLS).
 - PROVIDE ONE #6 BAR IN EACH FILLED CELL.
 - TIE TO WALL FOOTING WITH ONE #6 DOWEL IN EACH FILLED CELL.

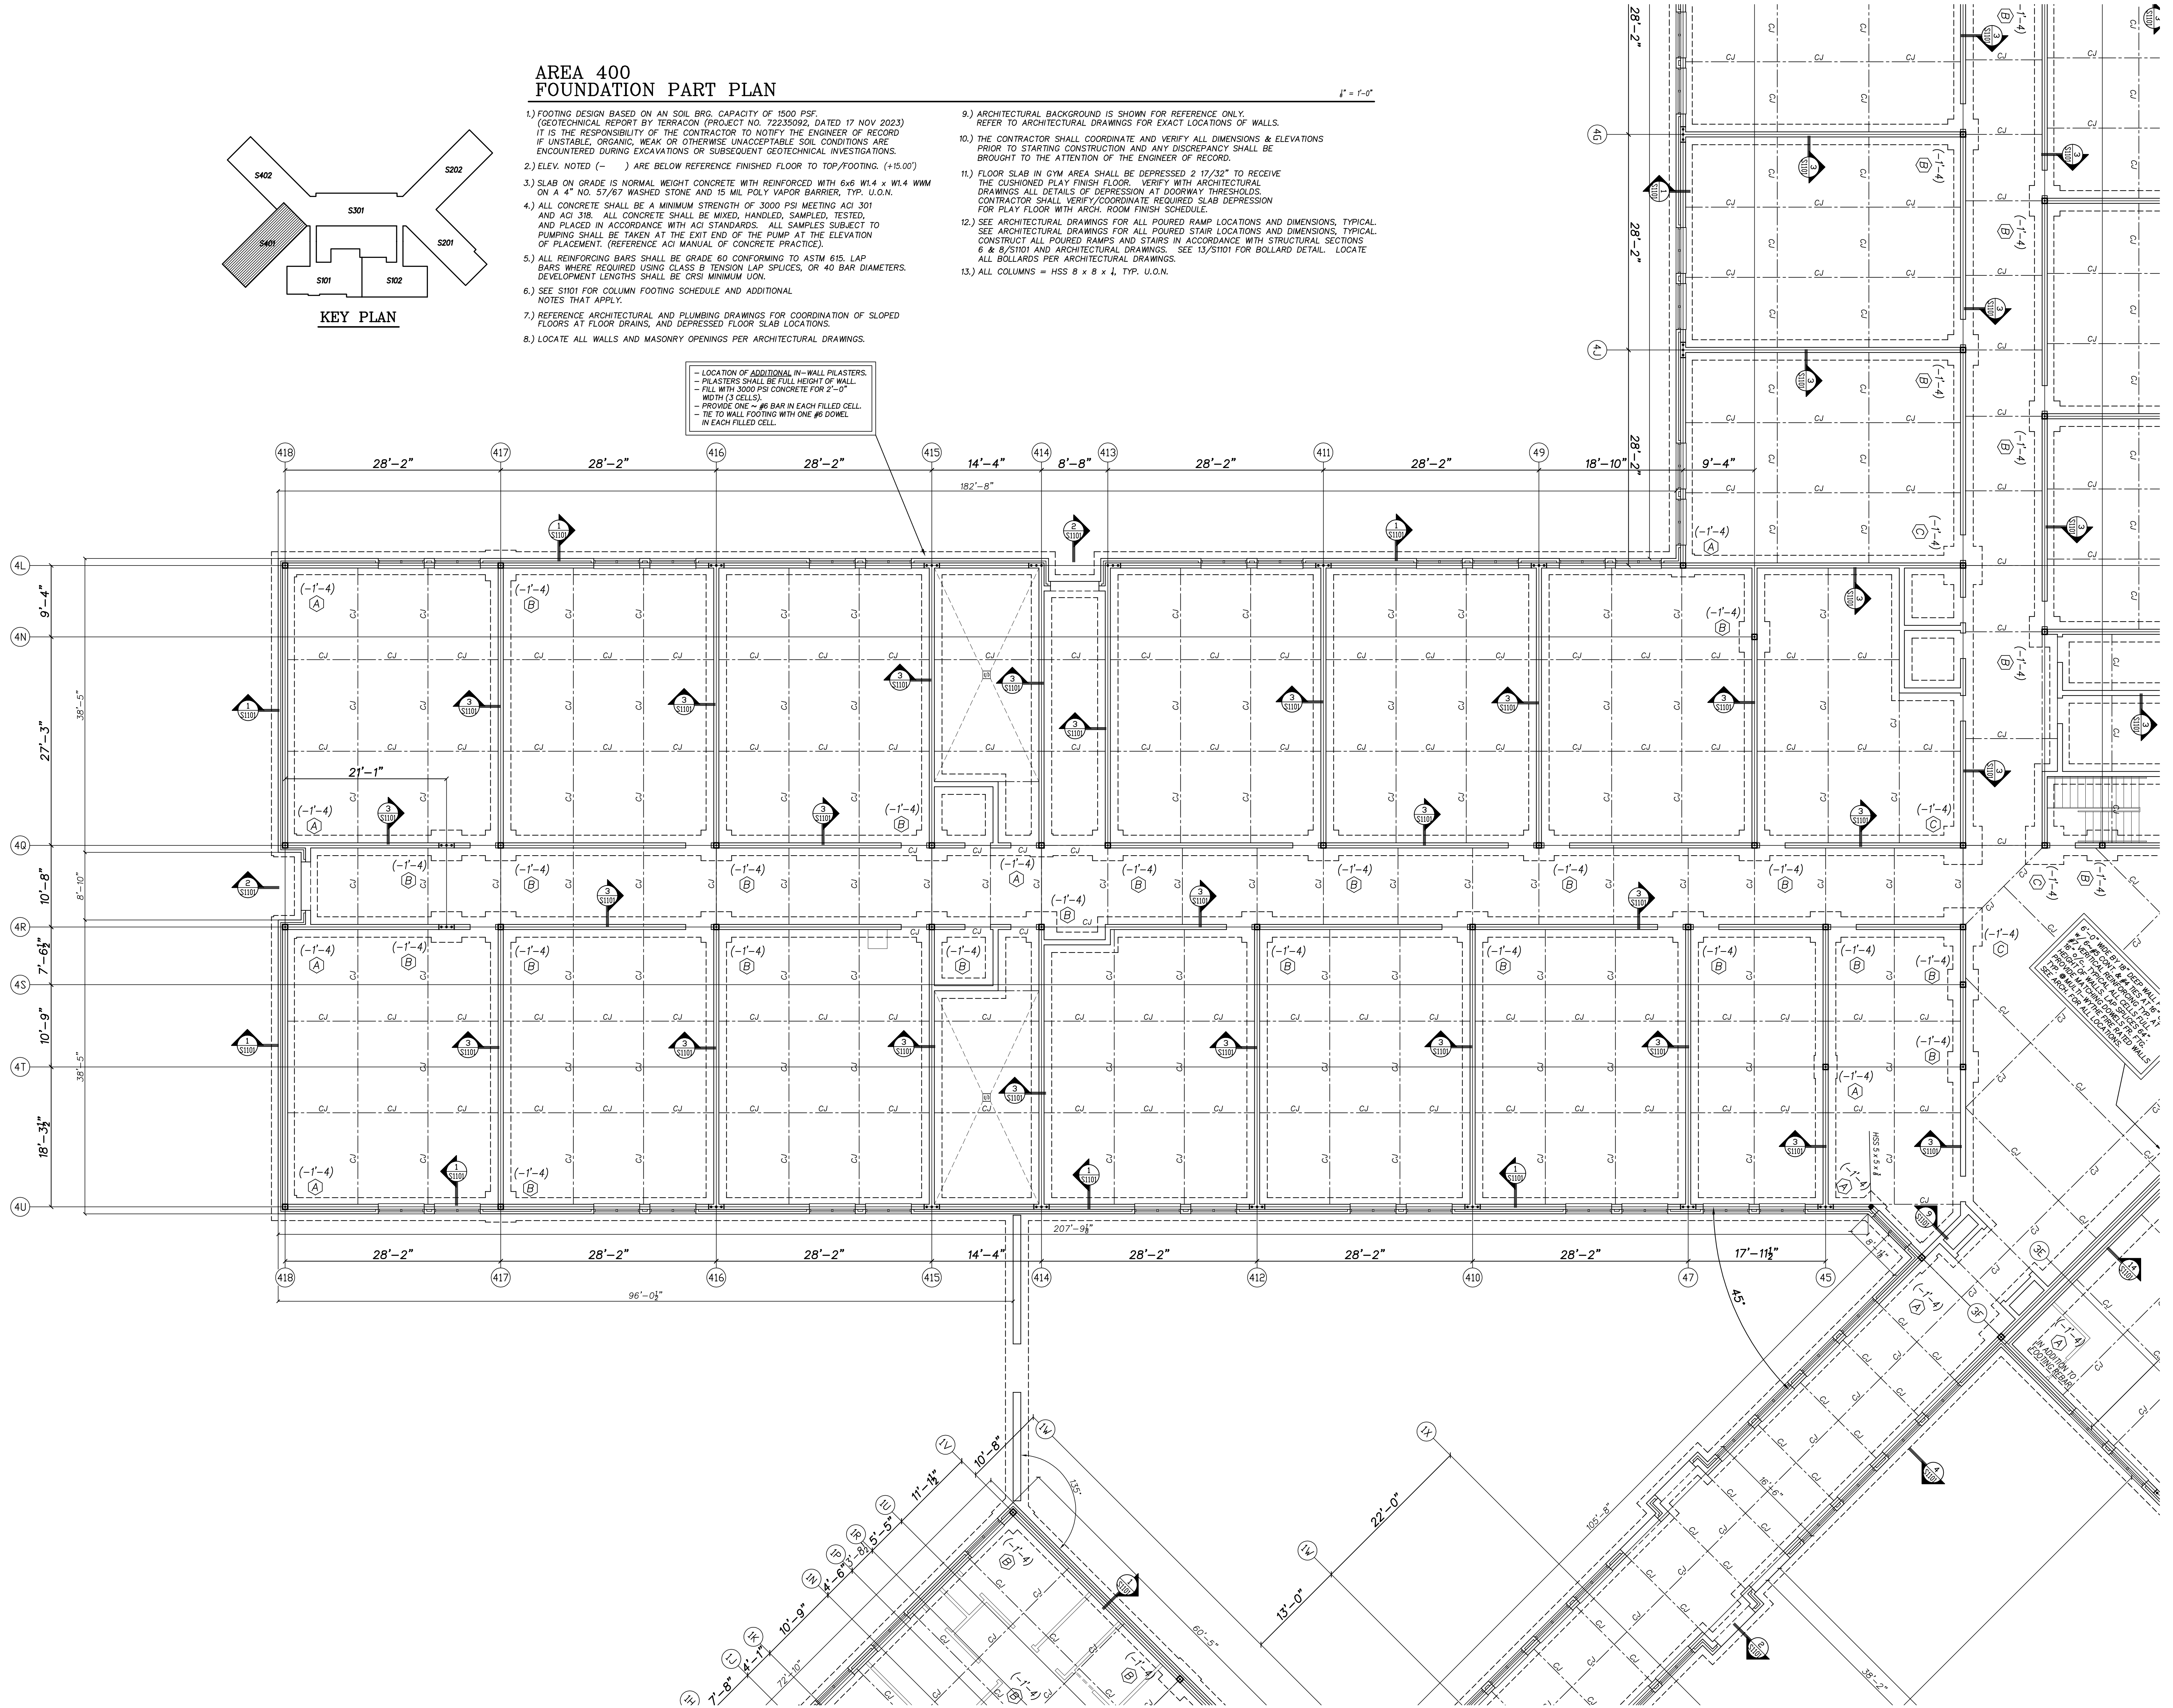

No.	Date	Revision

Hite associates
 ARCHITECTURE / ENGINEERING / TECHNOLOGY
 2600 Meridian Drive / Greenville, NC 27838 / tel (252) 757-0333


QED
 QUEEN ENGINEERING & DESIGN
 2600 Meridian Drive, Suite 415
 Greenville, NC 27838
 NC LIC. C-1020
 ENGINEER
 BRUCE A. QUEEN
 18991
 09 OCT 2024

Beaufort PK-3 School
 BEAUFORT COUNTY SCHOOLS
 Washington / North Carolina / 27889

Project No. 22344
 Date: 09 OCT 2024
 Drawing No. S 401

AREA 400 FOUNDATION PART PLAN


1" = 1'-0"

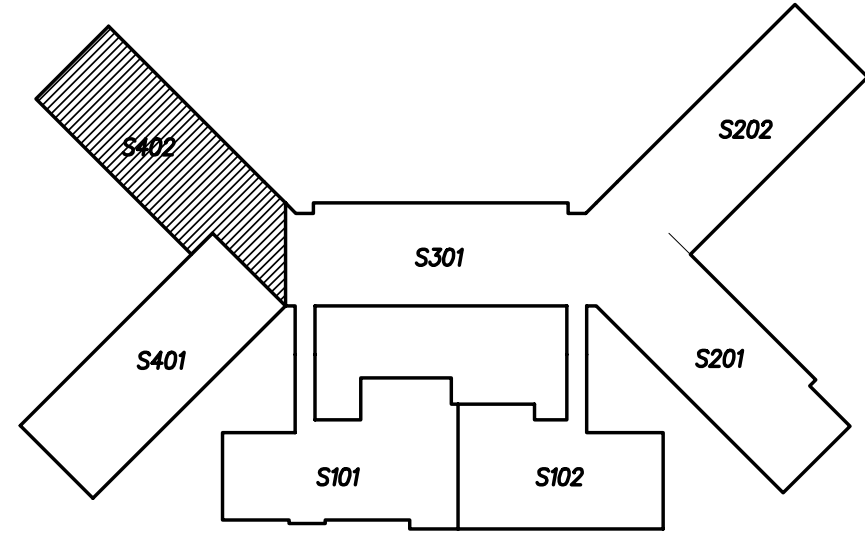

KEY PLAN

- 1.) FOOTING DESIGN BASED ON AN SOIL BRG. CAPACITY OF 1500 PSF. (GEOTECHNICAL REPORT BY TERRACON (PROJECT NO. 72235092, DATED 17 NOV 2023) IT IS THE RESPONSIBILITY OF THE CONTRACTOR TO NOTIFY THE ENGINEER OF RECORD IF UNSTABLE, ORGANIC, WEAK OR OTHERWISE UNACCEPTABLE SOIL CONDITIONS ARE ENCOUNTERED DURING EXCAVATIONS OR SUBSEQUENT GEOTECHNICAL INVESTIGATIONS.
- 2.) ELEV. NOTED (-) ARE BELOW REFERENCE FINISHED FLOOR TO TOP/FOOTING. (+15.00')
- 3.) SLAB ON GRADE IS NORMAL WEIGHT CONCRETE WITH REINFORCED WITH 6x6 W1.4 x W1.4 WMM ON A 4" NO. 57/67 WASHED STONE AND 15 MIL POLY VAPOR BARRIER, TYP. U.O.N.
- 4.) ALL CONCRETE SHALL BE A MINIMUM STRENGTH OF 3000 PSI MEETING ACI 301 AND ACI 318. ALL CONCRETE SHALL BE MIXED, HANDLED, SAMPLED, TESTED, AND PLACED IN ACCORDANCE WITH ACI STANDARDS. ALL SAMPLES SUBJECT TO PUMPING SHALL BE TAKEN AT THE EXIT END OF THE PUMP AT THE ELEVATION OF PLACEMENT. (REFERENCE ACI MANUAL OF CONCRETE PRACTICE).
- 5.) ALL REINFORCING BARS SHALL BE GRADE 60 CONFORMING TO ASTM 615. LAP BARS WHERE REQUIRED USING CLASS B TENSION LAP SPLICES, OR 40 BAR DIAMETERS. DEVELOPMENT LENGTHS SHALL BE CRSI MINIMUM UON.
- 6.) SEE S1101 FOR COLUMN FOOTING SCHEDULE AND ADDITIONAL NOTES THAT APPLY.
- 7.) REFERENCE ARCHITECTURAL AND PLUMBING DRAWINGS FOR COORDINATION OF SLOPED FLOORS AT FLOOR DRAINS, AND DEPRESSED FLOOR SLAB LOCATIONS.
- 8.) LOCATE ALL WALLS AND MASONRY OPENINGS PER ARCHITECTURAL DRAWINGS.
- 9.) ARCHITECTURAL BACKGROUND IS SHOWN FOR REFERENCE ONLY. REFER TO ARCHITECTURAL DRAWINGS FOR EXACT LOCATIONS OF WALLS.
- 10.) THE CONTRACTOR SHALL COORDINATE AND VERIFY ALL DIMENSIONS & ELEVATIONS PRIOR TO STARTING CONSTRUCTION AND ANY DISCREPANCY SHALL BE BROUGHT TO THE ATTENTION OF THE ENGINEER OF RECORD.
- 11.) FLOOR SLAB IN GYM AREA SHALL BE DEPRESSED 2 17/32" TO RECEIVE THE CUSHIONED PLAY FINISH FLOOR. VERIFY WITH ARCHITECTURAL DRAWINGS ALL DETAILS OF DEPRESSION AT DOORWAY THRESHOLDS. CONTRACTOR SHALL VERIFY/COORDINATE REQUIRED SLAB DEPRESSION FOR PLAY FLOOR WITH ARCH. ROOM FINISH SCHEDULE.
- 12.) SEE ARCHITECTURAL DRAWINGS FOR ALL POURED RAMP LOCATIONS AND DIMENSIONS, TYPICAL. SEE ARCHITECTURAL DRAWINGS FOR ALL POURED STAIR LOCATIONS AND DIMENSIONS, TYPICAL. CONSTRUCT ALL POURED RAMPS AND STAIRS IN ACCORDANCE WITH STRUCTURAL SECTIONS 6 & 8/S1101 AND ARCHITECTURAL DRAWINGS. SEE 13/S1101 FOR BOLLARD DETAIL. LOCATE ALL BOLLARDS PER ARCHITECTURAL DRAWINGS.
- 13.) ALL COLUMNS = HSS 8 x 8 x 4, TYP. U.O.N.

LOCATION OF ADDITIONAL IN-WALL PILASTERS:
 - PILASTERS SHALL BE FULL HEIGHT OF WALL.
 - FILL WITH 3000 PSI CONCRETE FOR 2'-0" WIDTH (3 CELLS).
 - PROVIDE ONE #6 BAR IN EACH FILLED CELL.
 - TIE TO WALL FOOTING WITH ONE #6 DOWEL IN EACH FILLED CELL.

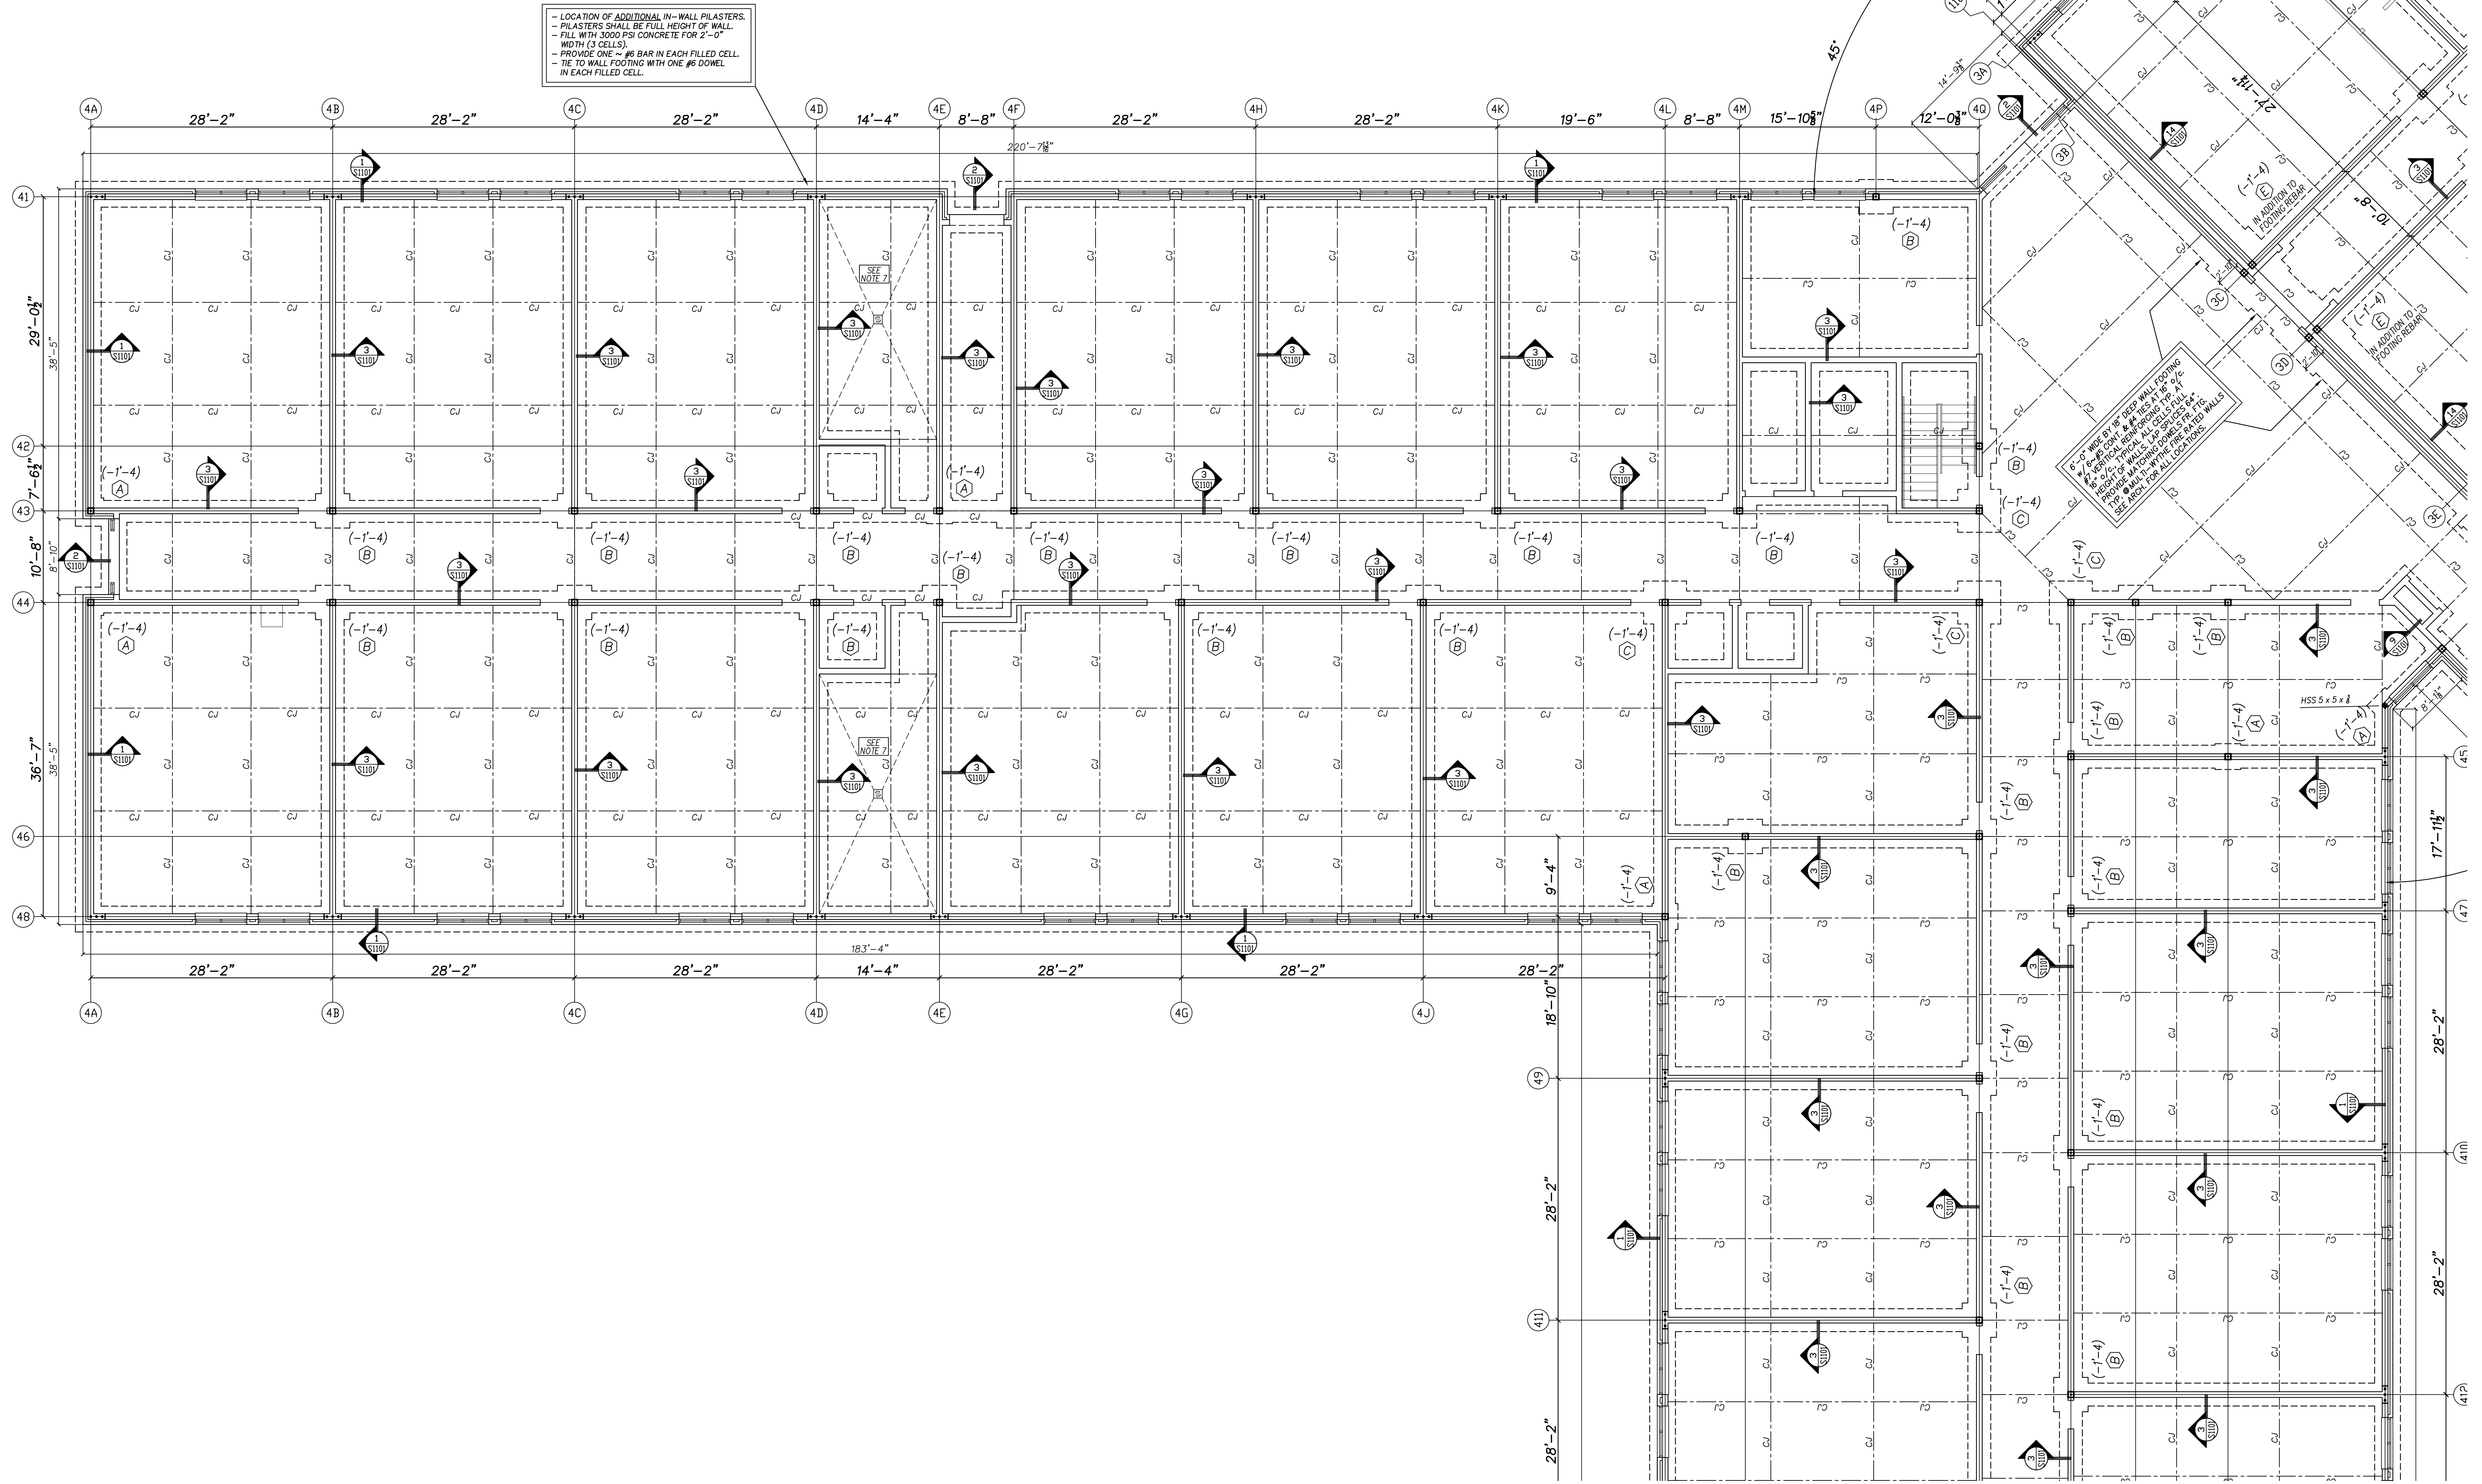

No.	Date	Revision

Hite associates
 ARCHITECTURE / ENGINEERING / TECHNOLOGY
 2600 Meridian Drive / Greenville, NC 27838 / tel (252) 757-0333

NE L.L.C. C-1024
QED
 QUEEN ENGINEERING & DESIGN
 1000 W. WOOD ST. SUITE 412
 WASHINGTON, NC 27888
 ENGINEER
 BRUCE W. QUEEN
 1891
 09 OCT 2024




Beaufort PK-3 School
 BEAUFORT COUNTY SCHOOLS
 Washington / North Carolina / 27889

Project No. 22344
 Date: 09 OCT 2024
 Drawing No. S 402

AREA 400 INTERMEDIATE PART PLAN

1/8" = 1'-0"

- 1.) SEE PLAN FOR TOP/UTILITY PLATFORM SLAB ELEVATION
- 2.) SEE S1102 FOR METAL FLOOR DECK FASTENING PATTERN, WHERE REQUIRED.
- 3.) SEE PLAN FOR SLAB THICKNESS AND FLOOR DECK SIZE.
REINFORCE ALL NEW PLATFORM SLABS WITH 6x6 W2.9 x W2.9 WWM.
- 4.) ARCHITECTURAL BACKGROUND IS SHOWN FOR REFERENCE ONLY.
REFER TO ARCHITECTURAL DRAWINGS FOR EXACT LOCATIONS OF WALLS.
- 5.) REFER TO ARCHITECTURAL DRAWINGS FOR ELEVATION OF ALL LINTELS.
- 6.) CONTRACTOR SHALL PROVIDE TEMPORARY SHORING AS REQUIRED FOR NEW COMPOSITE DECK SPANS GREATER THAN 10'-6"
- 7.) LOCATE ALL WALLS AND MASONRY OPENINGS PER ARCHITECTURAL DRAWINGS.
WHERE REQUIRED, SEE S1102 FOR ALL NEW CMU LINTELS.
- 8.) NO FABRICATION OR ERECTION SHALL COMMENCE PRIOR TO THE APPROVAL OF ALL STRUCTURAL STEEL SHOP DRAWINGS BY THE ENGINEER OF RECORD.
- 9.) COORDINATE AND VERIFY ALL DECK EDGE LOCATIONS AND DIMENSIONS WITH ARCHITECTURAL DRAWINGS.
- 10.) REFERENCE ARCHITECTURAL AND PLUMBING DRAWINGS FOR COORDINATION OF SLOPED FLOORS AT FLOOR DRAINS, AND DEPRESSED FLOOR SLAB LOCATIONS.

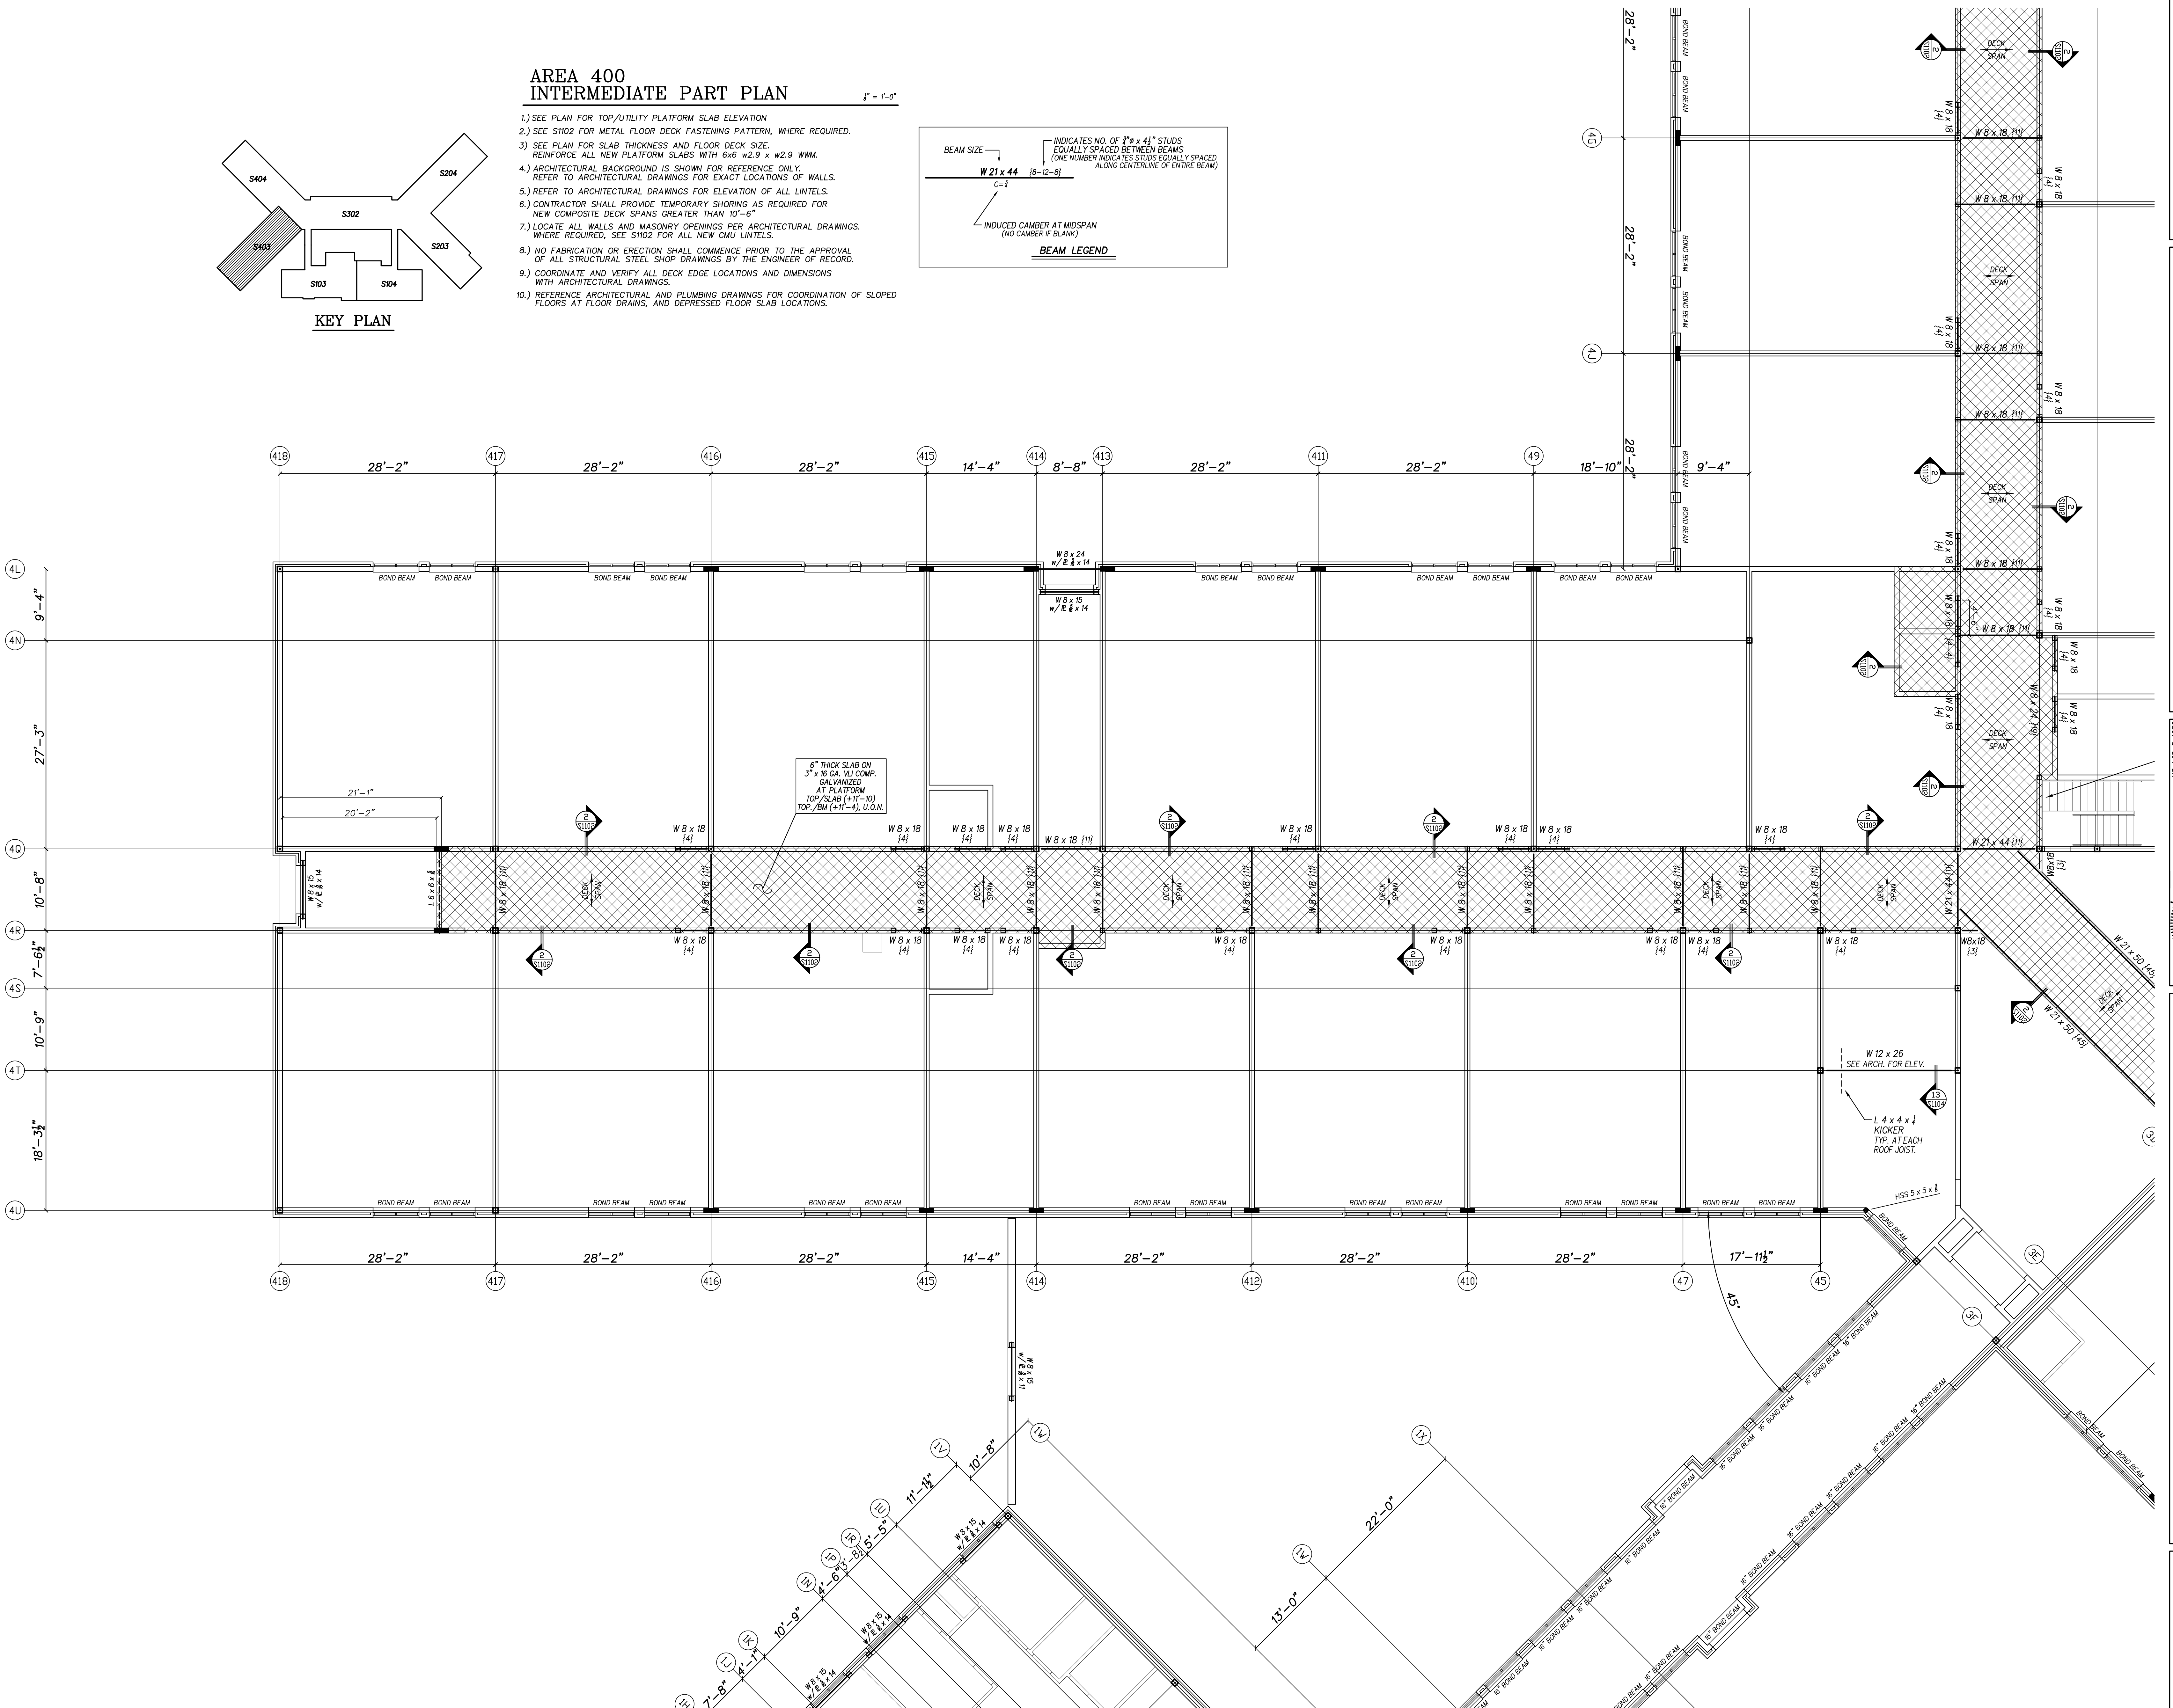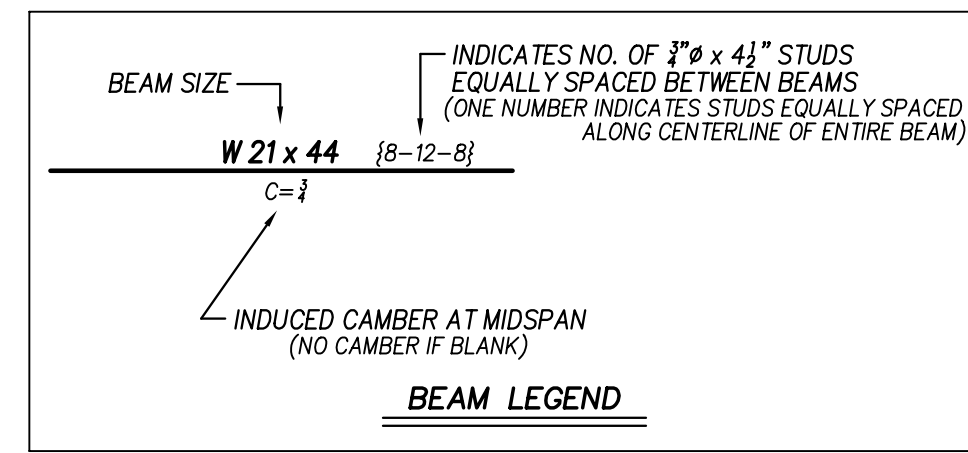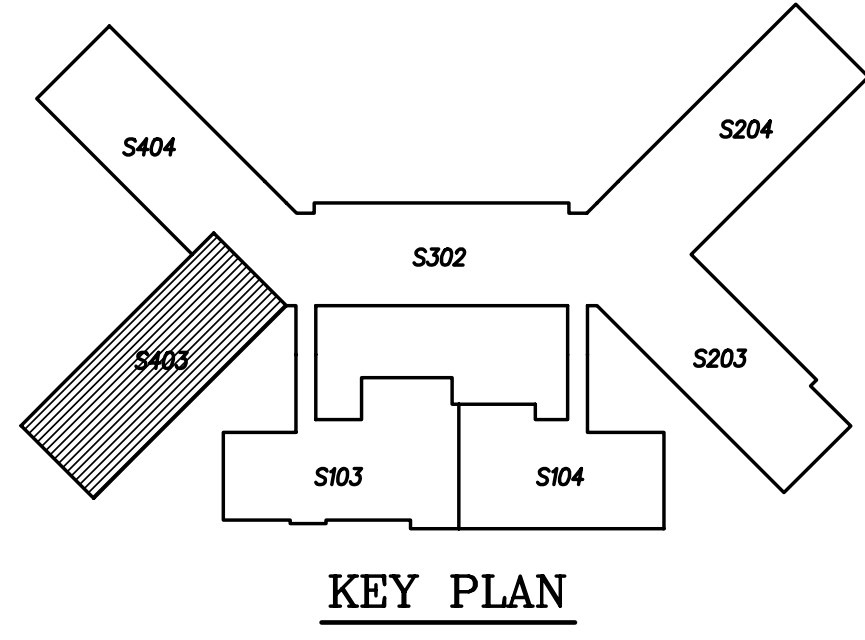

No.	Date	Revision

Hite associates
ARCHITECTURE / ENGINEERING / TECHNOLOGY
2600 Meridian Drive / Greenville, NC 27838 / tel (252) 757-0333

QED
QUEEN ENGINEERING & DESIGN
REGISTERED PROFESSIONAL ENGINEER
STATE OF NORTH CAROLINA
18891
BRUCE QUEEN
ENGINEER
09 OCT 2024


Beaufort PK-3 School
BEAUFORT COUNTY SCHOOLS
Washington / North Carolina / 27889

Project No. 22344
Date: 09 OCT 2024
Drawing no. S 403



AREA 400 INTERMEDIATE PART PLAN

1" = 1'-0"

- 1.) SEE PLAN FOR TOP/UTILITY PLATFORM SLAB ELEVATION
- 2.) SEE S102 FOR METAL FLOOR DECK FASTENING PATTERN, WHERE REQUIRED.
- 3.) SEE PLAN FOR SLAB THICKNESS AND FLOOR DECK SIZE. REINFORCE ALL NEW PLATFORM SLABS WITH 6x6 w2.9 x w2.9 WWM.
- 4.) ARCHITECTURAL BACKGROUND IS SHOWN FOR REFERENCE ONLY. REFER TO ARCHITECTURAL DRAWINGS FOR EXACT LOCATIONS OF WALLS.
- 5.) REFER TO ARCHITECTURAL DRAWINGS FOR ELEVATION OF ALL LINTELS.
- 6.) CONTRACTOR SHALL PROVIDE TEMPORARY SHORING AS REQUIRED FOR NEW COMPOSITE DECK SPANS GREATER THAN 10'-6".
- 7.) LOCATE ALL WALLS AND MASONRY OPENINGS PER ARCHITECTURAL DRAWINGS. WHERE REQUIRED, SEE S102 FOR ALL NEW CMU LINTELS.
- 8.) NO FABRICATION OR ERECTION SHALL COMMENCE PRIOR TO THE APPROVAL OF ALL STRUCTURAL STEEL SHOP DRAWINGS BY THE ENGINEER OF RECORD.
- 9.) COORDINATE AND VERIFY ALL DECK EDGE LOCATIONS AND DIMENSIONS WITH ARCHITECTURAL DRAWINGS.
- 10.) REFERENCE ARCHITECTURAL AND PLUMBING DRAWINGS FOR COORDINATION OF SLOPED FLOORS AT FLOOR DRAINS, AND DEPRESSED FLOOR SLAB LOCATIONS.

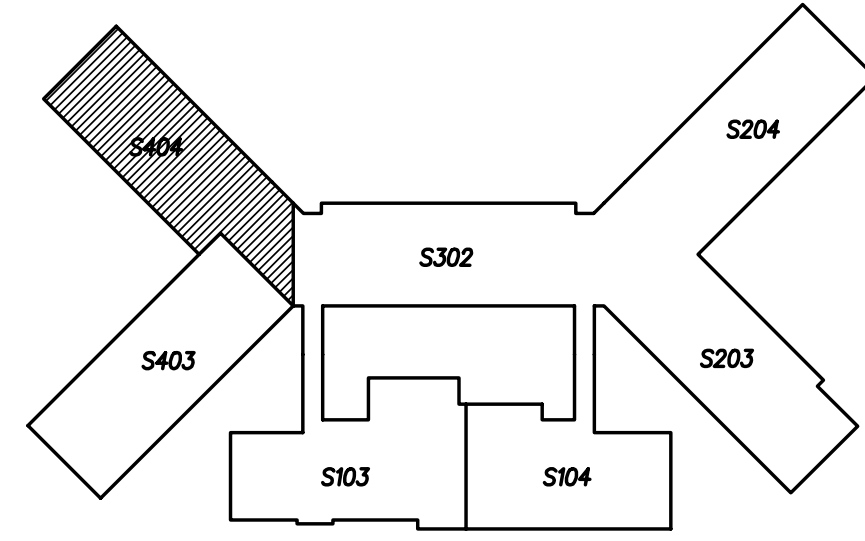

KEY PLAN

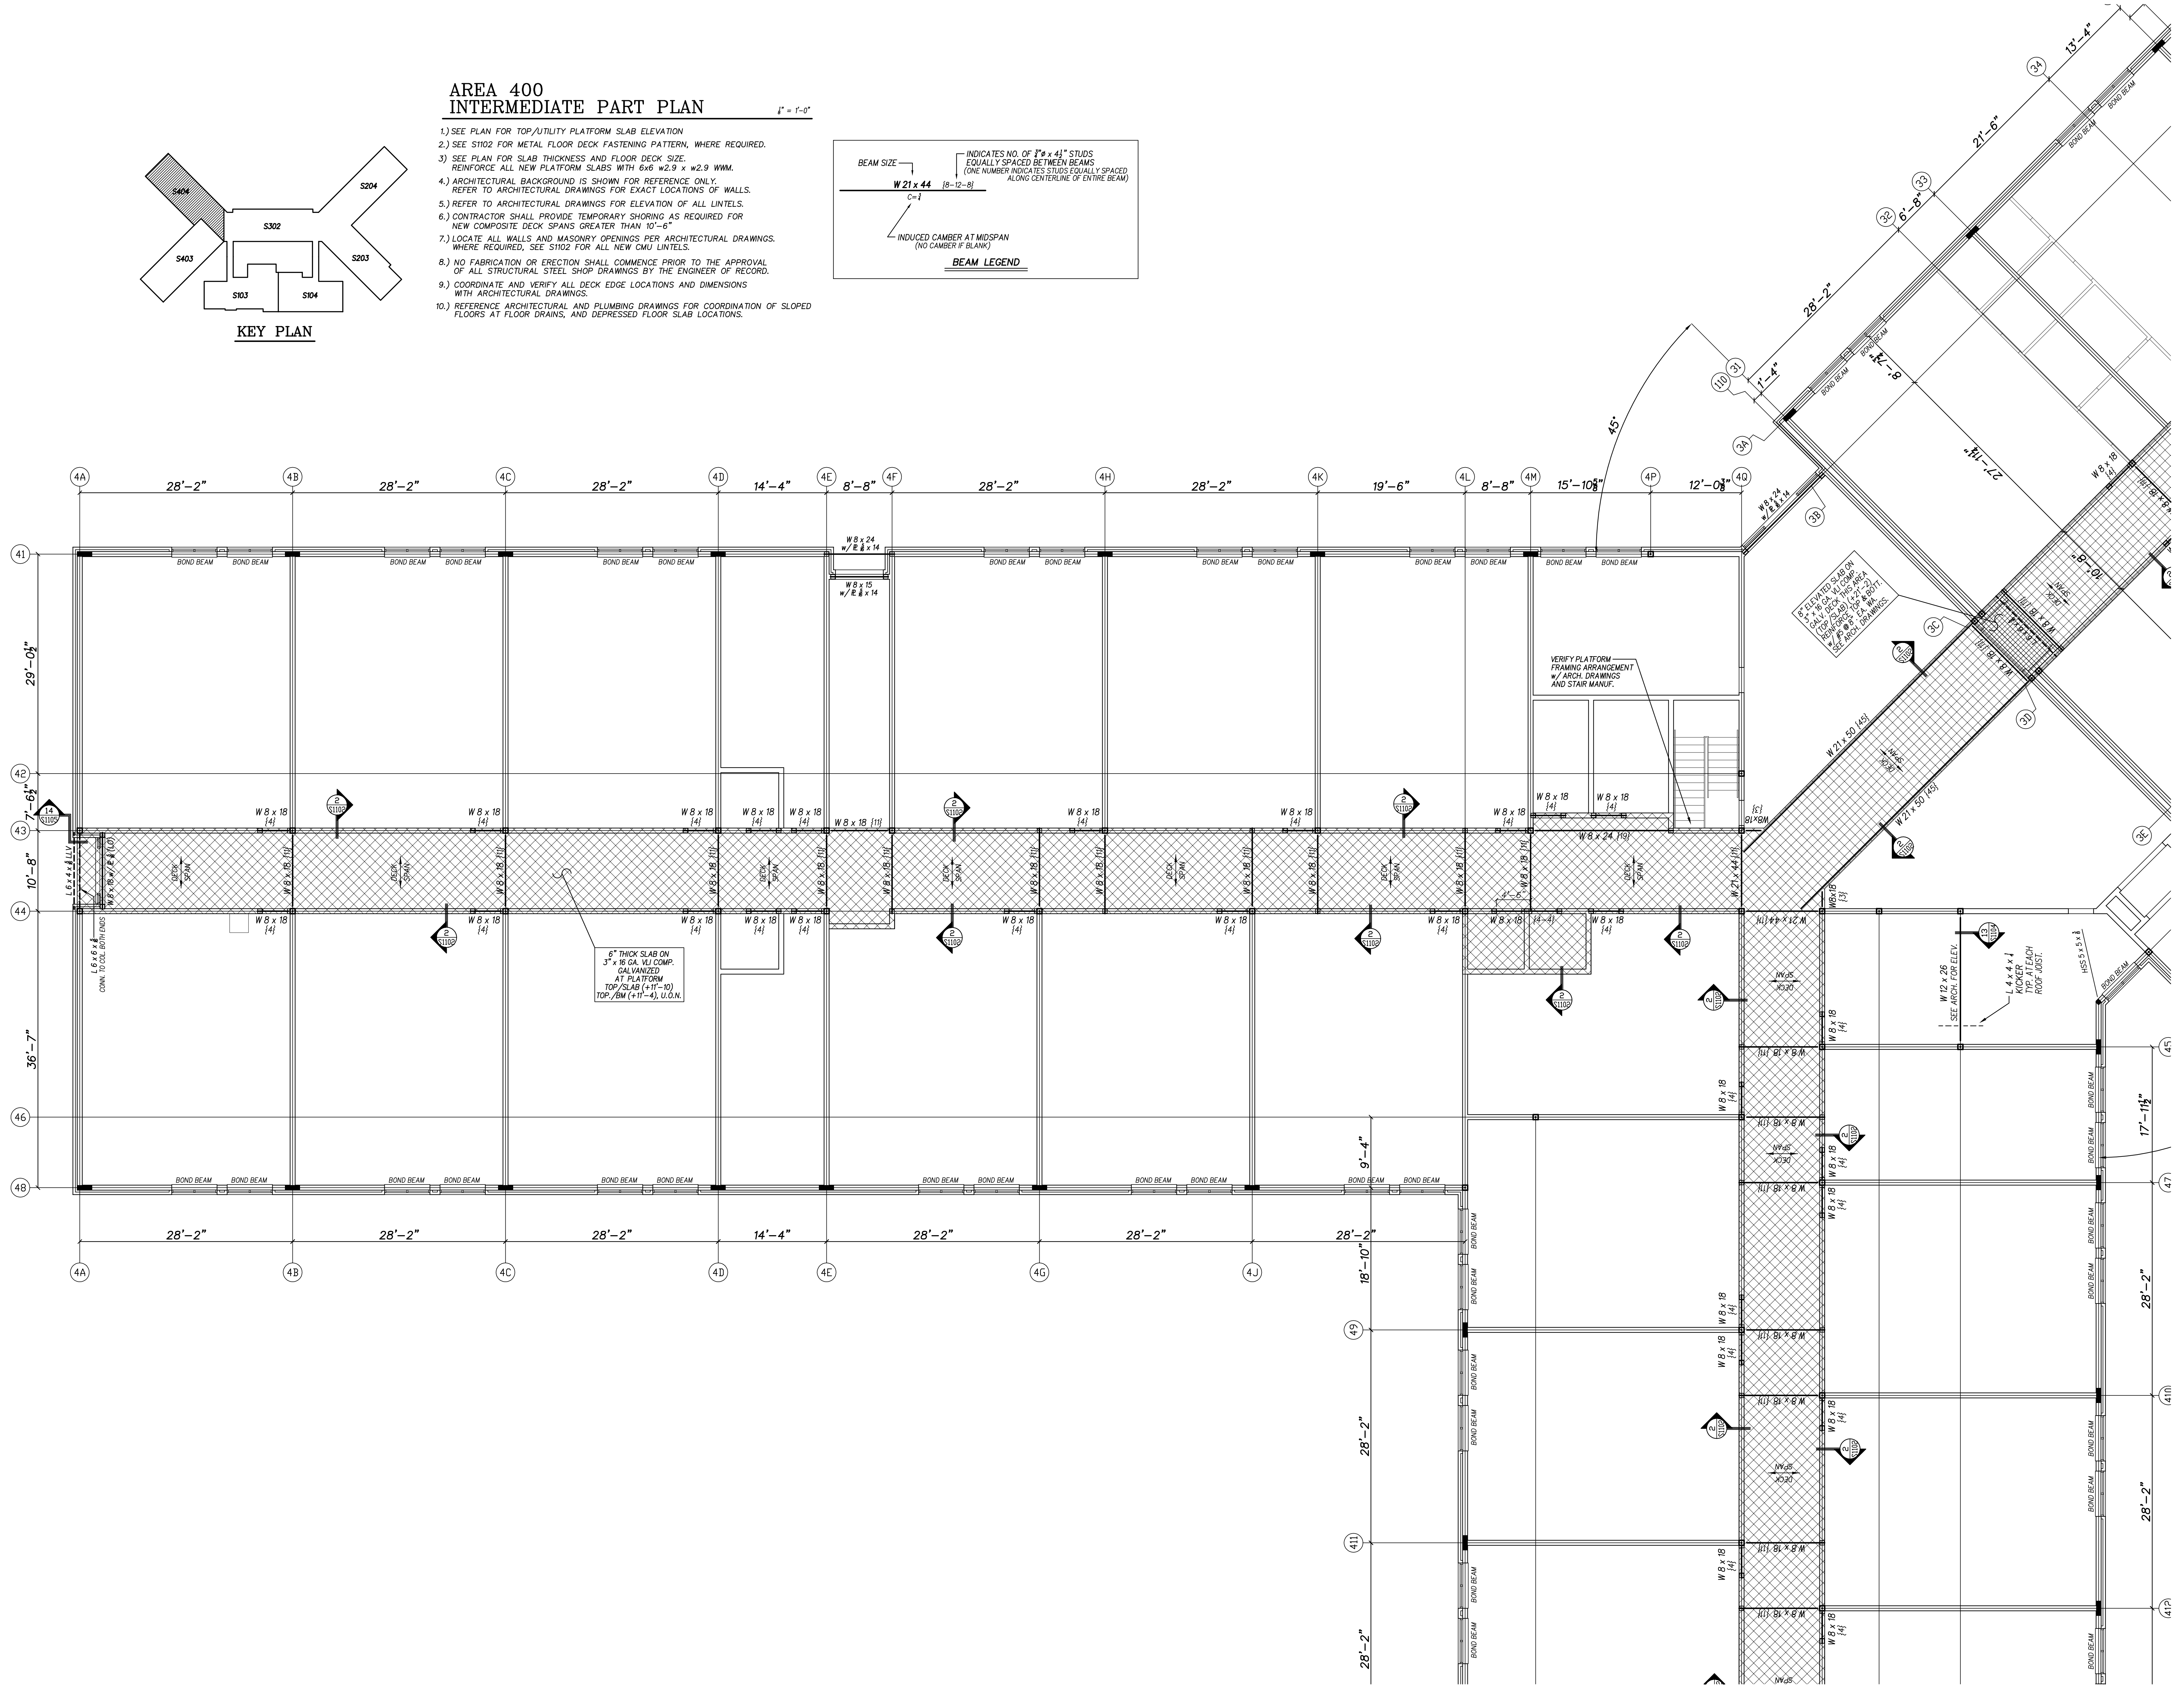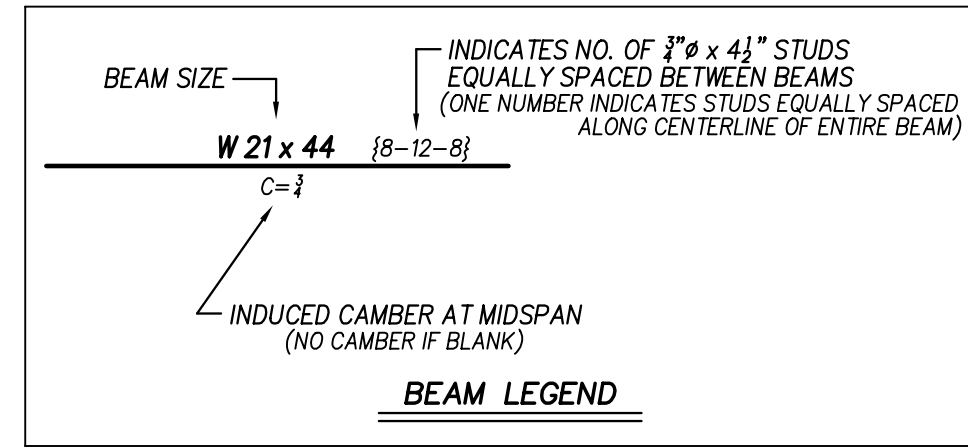

No.	Date	Revision

Hite associates
ARCHITECTURE / ENGINEERING / TECHNOLOGY
2600 Meridian Drive / Greenville, NC 27838 / tel (252) 757-0333


NE L.L.C. C-1020
QED
QUINN ENGINEERING & DESIGN
REGISTERED PROFESSIONAL ENGINEER
STATE OF NORTH CAROLINA
09 OCT 2024

Beaufort PK-3 School
BEAUFORT COUNTY SCHOOLS
Washington / North Carolina / 27889

Project No. 22344
Date: 09 OCT 2024
Drawing no. S 404


AREA 400 ROOF PART PLAN

1" = 1'-0"

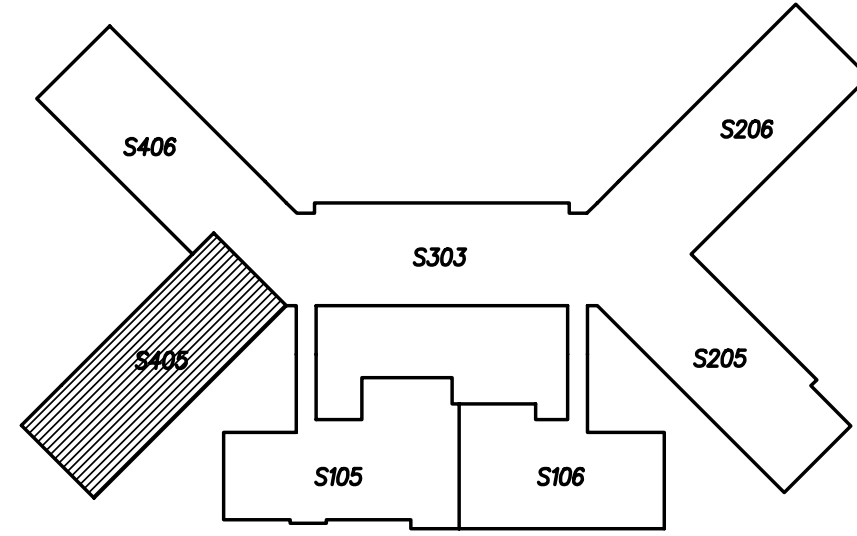

KEY PLAN

- 1.) METAL ROOF DECK IS 1/2" x 22 GA TYPE "B" PAINTED M.R.D. TYP. U.O.N. FOR ATTACHMENT. SEE TYPICAL M.R.D. FASTENING DETAIL ON S102.
- 2.) ELEV. NOTED (+) ARE ABOVE REFERENCED FINISHED FLOOR.
- 3.) METAL ROOF DECK IS TO BE USED TO TRANSMIT LATERAL LOADS TO WALLS. SEE TYP. DECK FASTENING PATTERN ON S102.
- 4.) JOIST SUPPLIER SHALL DESIGN JOISTS FOR ADDITIONAL POINT LOADS FROM ROOF TOP MECHANICAL UNITS (IF REQUIRED). CONTRACTOR SHALL VERIFY SIZE AND HEIGHT OF UNITS AND REPORT THIS INFORMATION TO THE STRUCTURAL ENGINEER OF RECORD, IF REQUIRED.
- 5.) ALL WIDE FLANGE BEAMS TO BE "A50" STEEL.
- 6.) SEE S100 FOR NET UPLIFT DESIGN LOADING FOR ALL JOISTS AND ORDERS.
- 7.) "UB" INDICATES UPLIFT BRIDGING TO BE LOCATED AT THE FIRST BOTTOM CHORD PANEL POINT OF JOIST.
- 8.) NO FABRICATION OR ERECTION SHALL COMMENCE PRIOR TO THE APPROVAL OF ALL STRUCTURAL STEEL SHOP DRAWINGS BY THE ENGINEER OF RECORD.
- 9.) JOIST MANUFACTURER SHALL ADJUST JOIST SEATS AS REQUIRED TO MAINTAIN DECK BEARING ELEVATIONS SHOWN ON THE CONTRACT DRAWINGS.
- 10.) COORDINATE AND VERIFY ALL DECK EDGE LOCATIONS AND DIMENSIONS WITH ARCHITECTURAL DRAWINGS.
- 11.) SEE 3/S103 AND 5/S103 FOR LCX CONFIGURATION.
- 12.) SEE 4/S103 FOR BCX CONFIGURATION.
- 13.) PROVIDE CONTINUOUS HORIZONTAL AND/OR DIAGONAL CROSS BRIDGING AT LOCATIONS SHOWN ON THE DRAWINGS. WHERE "S" STANDARDS REQUIRE ADDITIONAL LINES OF BRIDGING IN ADDITION TO THOSE SHOWN ON THE DRAWINGS THE ADDITIONAL LINES SHALL BE PROVIDED.
- 14.) INDICATES THAT JOIST AND ORDER SUPPLIER SHALL DESIGN JOIST WITH DESIGN END MOMENT OF 500 IN-K AT END OF JOIST. SEE SECTION 8/S104 FOR ADDITIONAL NOTES THAT APPLY. TYPICAL AT "SP" JOIST DESIGNATION.
- 15.) UNLESS OTHERWISE NOTED, ALL JOIST ORDERS SUPPORTING W4 PIPING SUPPORT BEAMS SHALL BE DESIGNED BY THEIR SUPPLIER TO SUPPORT AN ADDITIONAL 1.5 KIPS UNFACTORED SERVICE LOAD AT EACH W4 SUPPORT POINT.
- 16.) LOCATE ALL WALLS AND MASONRY OPENINGS PER ARCHITECTURAL DRAWINGS.
- 17.) LB = L 6 x 6 x 1/2, TYP. U.O.N.
- 18.) W4 = W 4 x 13, TYP. U.O.N.
- 19.) INDICATES MOMENT CONNECTION. SEE 1/S104.
- 20.) SEE 15/S103 FOR BENT BEAM WELDMENTS.
- 21.) W6 = W 6 x 9, TYP., U.O.N.
- 22.) HSS3 = HSS 3 x 3 x 1/4, TYP., U.O.N.

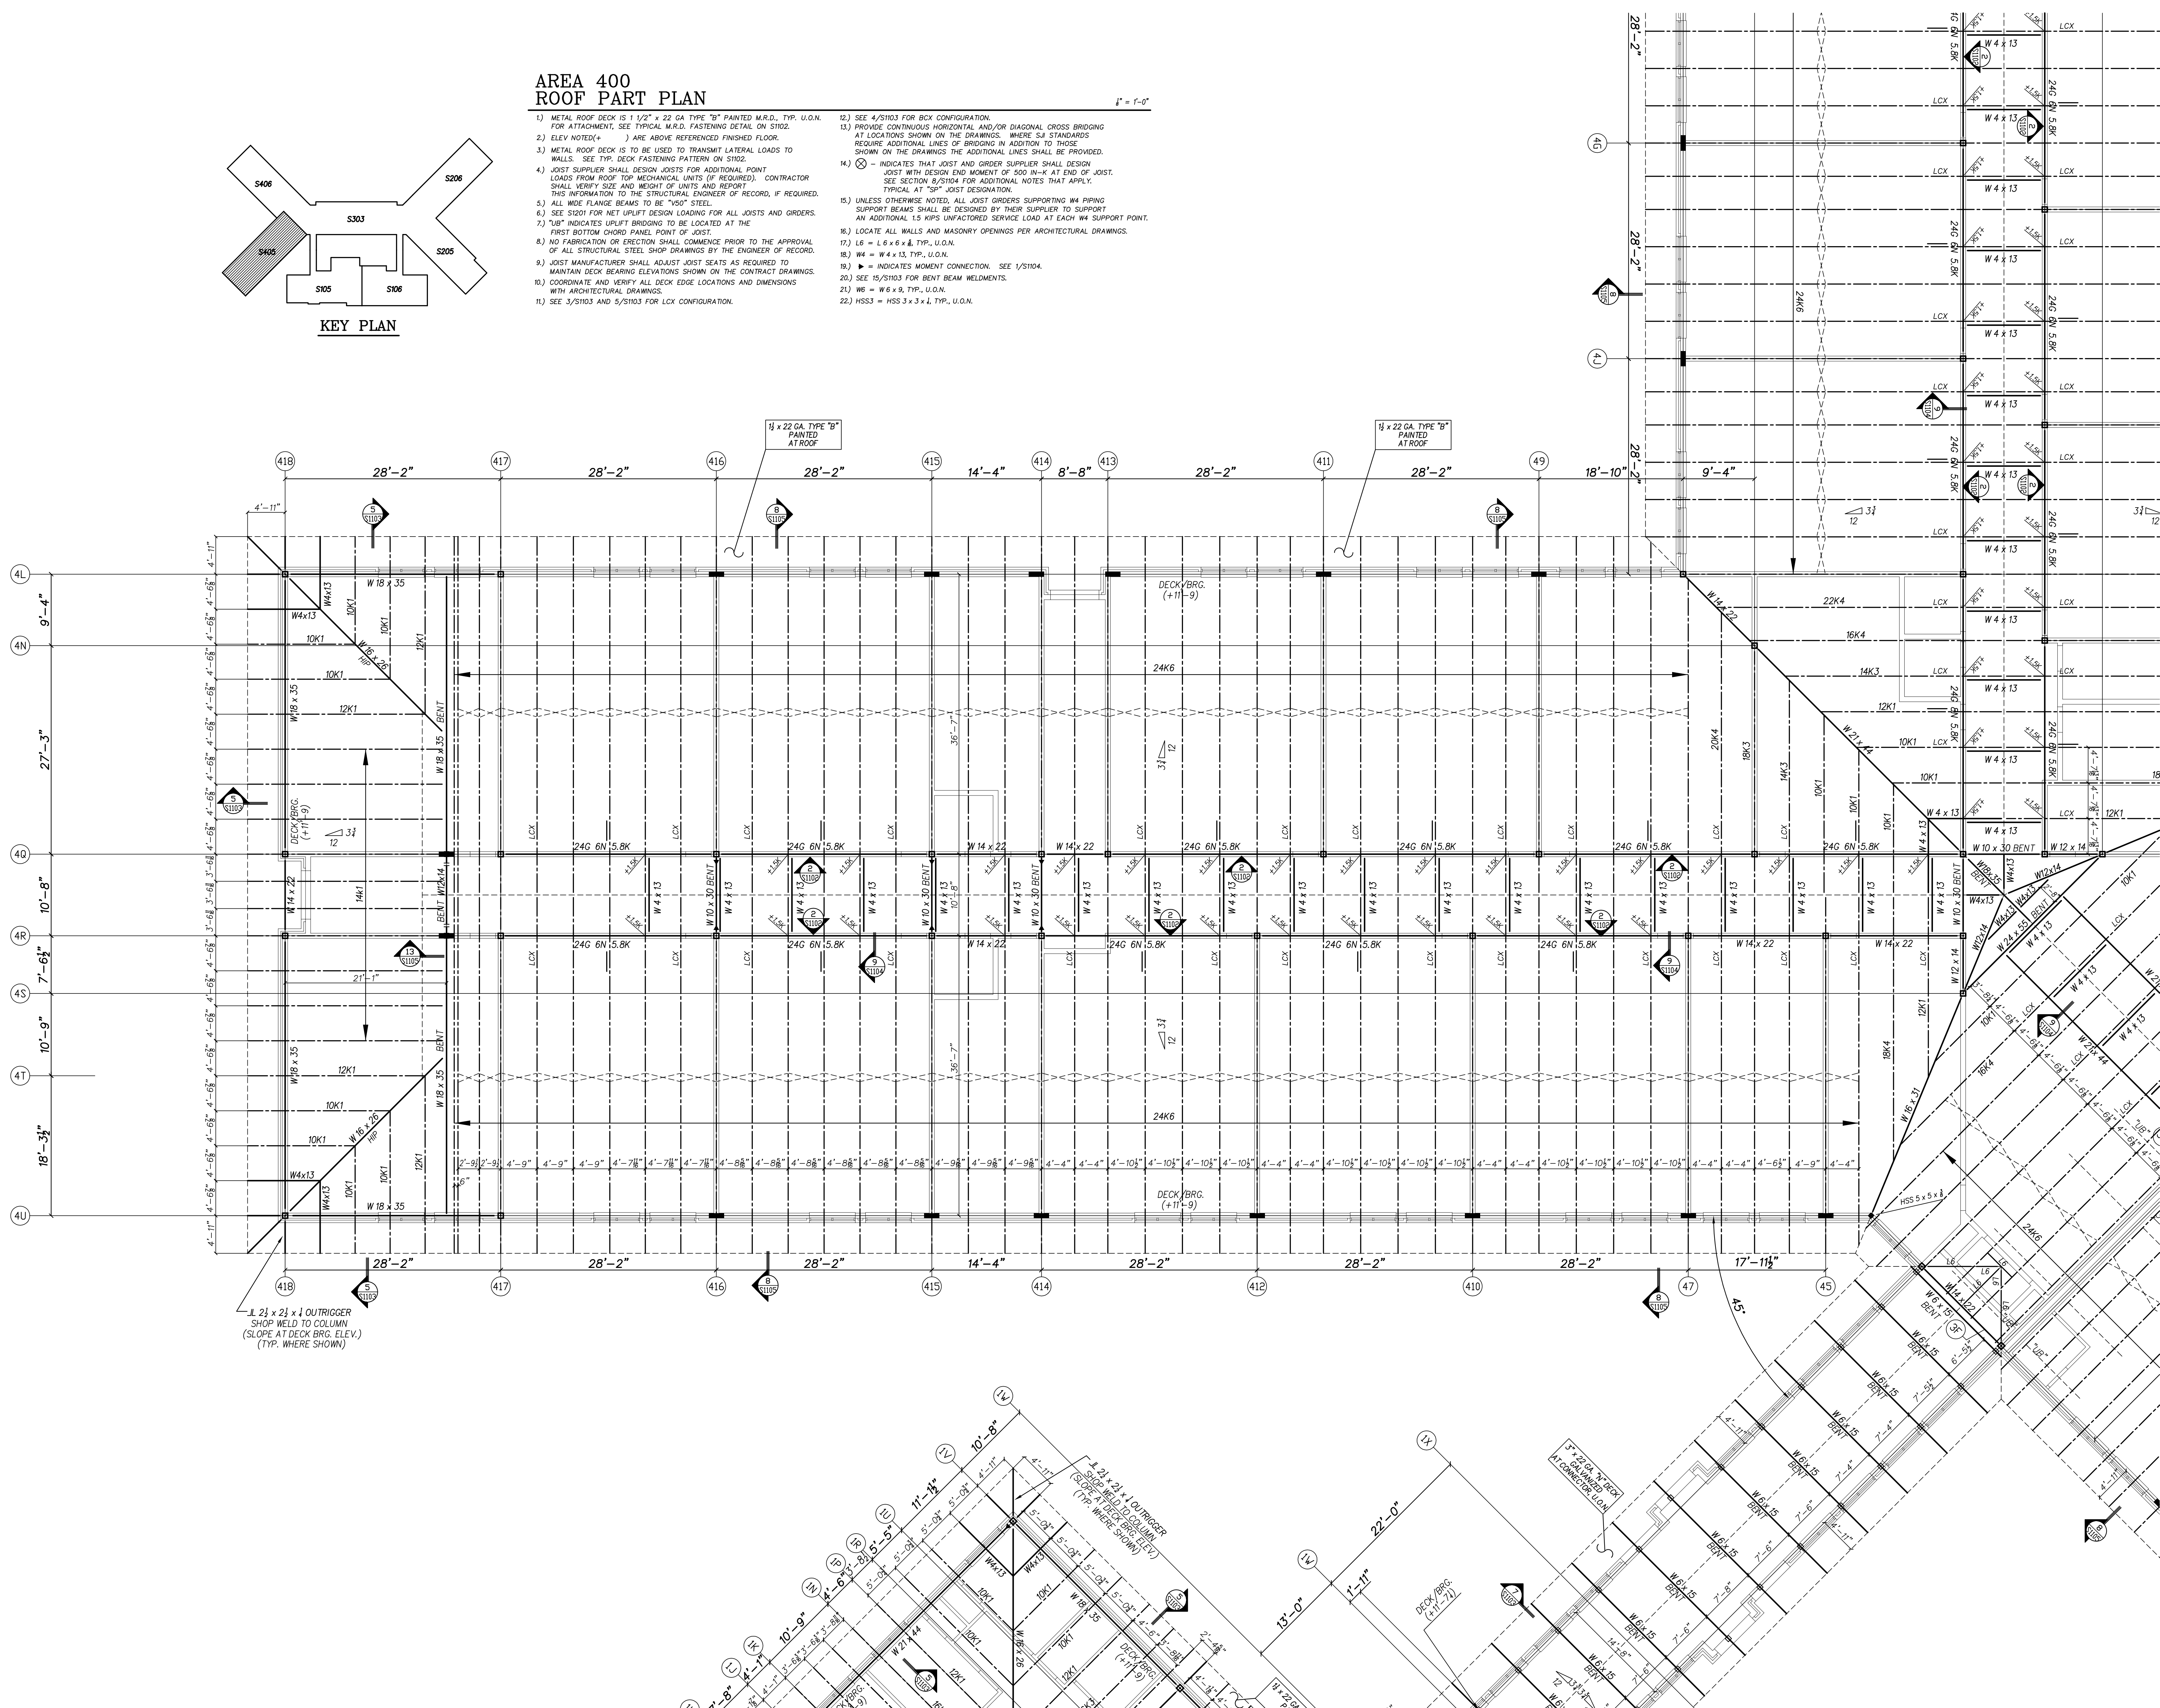

No.	Date	Revision

Hite associates
ARCHITECTURE / ENGINEERING / TECHNOLOGY
2600 Meridian Drive / Greenville, NC 27838 / tel (252) 757-0333

NE LIC C-1020
QED
QUEEN ENGINEERING & DESIGN
ARCHITECTURE / ENGINEERING / DESIGN
2600 MERIDIAN DRIVE, SUITE 405
GREENVILLE, NC 27838
PH: 252-757-0333
FAX: 252-757-0334
www.qednc.com


Prucha Owen
ENGINEER
BRUCE OWEN
18991
09 OCT 2024

Beaufort PK-3 School
BEAUFORT COUNTY SCHOOLS
Washington / North Carolina / 27889


Project No. 22344
Date: 09 OCT 2024
Drawing no. **S 405**

AREA 400
ROOF PART PLAN

1" = 1'-0"

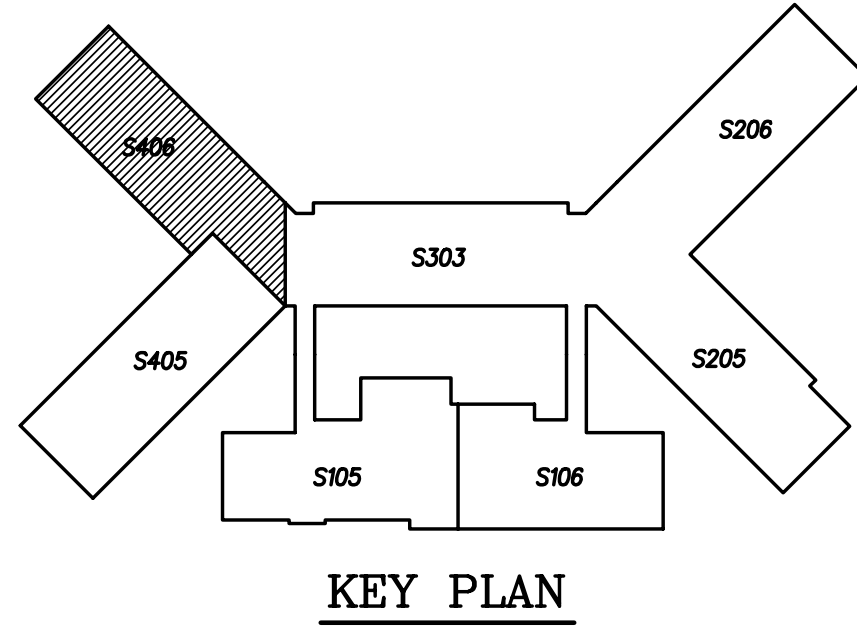

- 1) METAL ROOF DECK IS 1/2" x 22 GA TYPE "B" PAINTED M.R.D., TYP. U.O.N. FOR ATTACHMENT; SEE TYPICAL M.R.D. FASTENING DETAIL ON S102.
- 2) ELEV NOTED(+) ARE ABOVE REFERENCED FINISHED FLOOR.
- 3) METAL ROOF DECK IS TO BE USED TO TRANSMIT LATERAL LOADS TO WALLS. SEE TYP. DECK FASTENING PATTERN ON S102.
- 4) JOIST SUPPLIER SHALL DESIGN JOISTS FOR ADDITIONAL POINT LOADS FROM ROOF TOP MECHANICAL UNITS (IF REQUIRED). CONTRACTOR SHALL VERIFY SIZE AND WEIGHT OF UNITS AND REPORT THIS INFORMATION TO THE STRUCTURAL ENGINEER OF RECORD, IF REQUIRED.
- 5) ALL WIDE FLANGE BEAMS TO BE "A50" STEEL.
- 6) SEE S101 FOR NET UPLIFT DESIGN LOADING FOR ALL JOISTS AND GIRDERS.
- 7) "UB" INDICATES UPLIFT BRIDGING TO BE LOCATED AT THE FIRST BOTTOM CHORD PANEL POINT OF JOIST.
- 8) NO FABRICATION OR ERECTION SHALL COMMENCE PRIOR TO THE APPROVAL OF ALL STRUCTURAL STEEL SHOP DRAWINGS BY THE ENGINEER OF RECORD.
- 9) JOIST MANUFACTURER SHALL ADJUST JOIST SEATS AS REQUIRED TO MAINTAIN DECK BEARING ELEVATIONS SHOWN ON THE CONTRACT DRAWINGS.
- 10) COORDINATE AND VERIFY ALL DECK EDGE LOCATIONS AND DIMENSIONS WITH ARCHITECTURAL DRAWINGS.
- 11) SEE 3/S103 AND 5/S103 FOR LCH CONFIGURATION.
- 12) SEE 4/S103 FOR BCX CONFIGURATION.
- 13) PROVIDE CONTINUOUS HORIZONTAL AND/OR DIAGONAL CROSS BRIDGING AT LOCATIONS SHOWN ON THE DRAWINGS. WHERE S.F. STANDARDS REQUIRE ADDITIONAL LINES OF BRIDGING IN ADDITION TO THOSE SHOWN ON THE DRAWINGS THE ADDITIONAL LINES SHALL BE PROVIDED.
- 14) ⊗ - INDICATES THAT JOIST AND GIRDER SUPPLIER SHALL DESIGN JOIST WITH DESIGN END MOMENT OF 500 IN-K AT END OF JOIST. SEE SECTION 8/S104 FOR ADDITIONAL NOTES THAT APPLY. TYPICAL AT "SP" JOIST DESIGNATION.
- 15) UNLESS OTHERWISE NOTED, ALL JOIST ORDERS SUPPORTING W4 PIPING SUPPORT BEAMS SHALL BE DESIGNED BY THEIR SUPPLIER TO SUPPORT AN ADDITIONAL 1.5 KIPS UNFACTORED SERVICE LOAD AT EACH W4 SUPPORT POINT.
- 16) LOCATE ALL WALLS AND MASONRY OPENINGS PER ARCHITECTURAL DRAWINGS.
- 17) L6 = L 6 x 6 x 8, TYP., U.O.N.
- 18) W4 = W 4 x 13, TYP., U.O.N.
- 19) ► - INDICATES MOMENT CONNECTION. SEE 1/S104.
- 20) SEE 15/S103 FOR BENT BEAM MEMBERTS.
- 21) W6 = W 6 x 9, TYP., U.O.N.
- 22) HSS3 = HSS 3 x 3 x 4, TYP., U.O.N.

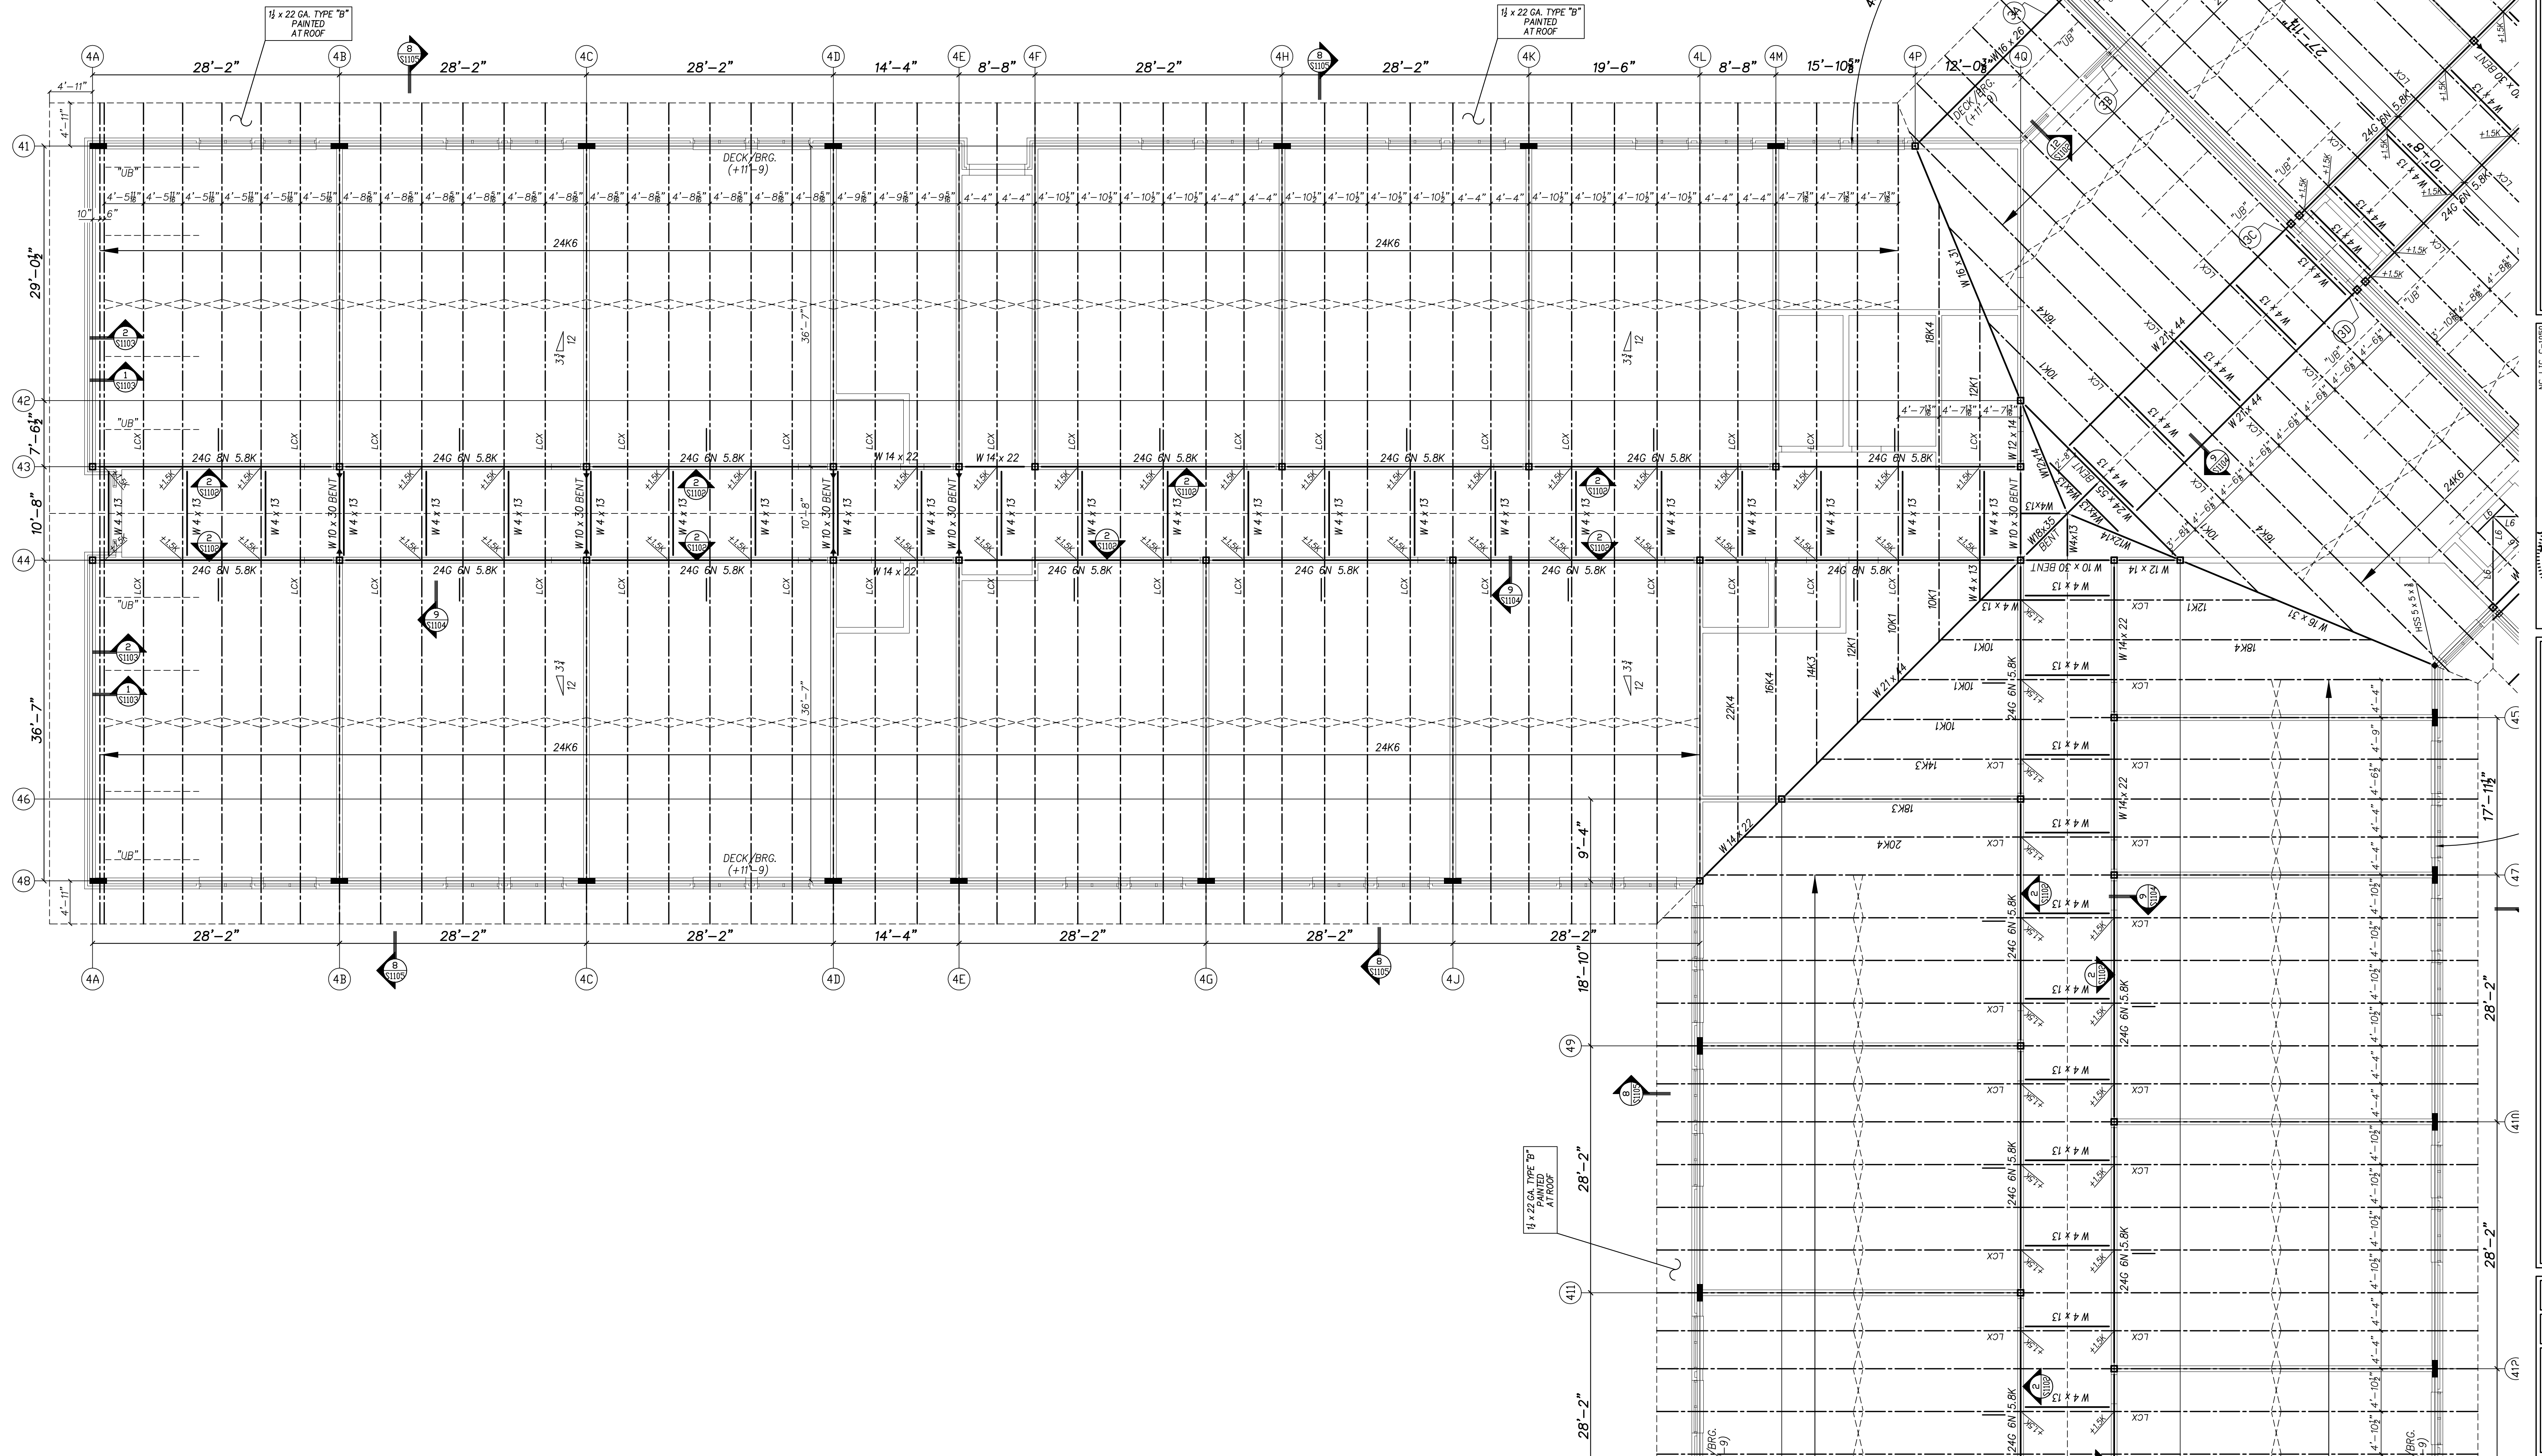


No.	Date	Revision

Hite associates
ARCHITECTURE / ENGINEERING / TECHNOLOGY
2600 Meridian Drive / Greenville, NC 27838 / tel (252) 757-0333


NE LIC C-1030
QED
QUINN ENGINEERING & DESIGN
REGISTERED PROFESSIONAL ENGINEER
IN THE STATE OF NORTH CAROLINA
1999
09 OCT 2024

Beaufort PK-3 School
BEAUFORT COUNTY SCHOOLS
Washington / North Carolina / 27889


Project No. 22344
Date: 09 OCT 2024
Drawing No. S 406

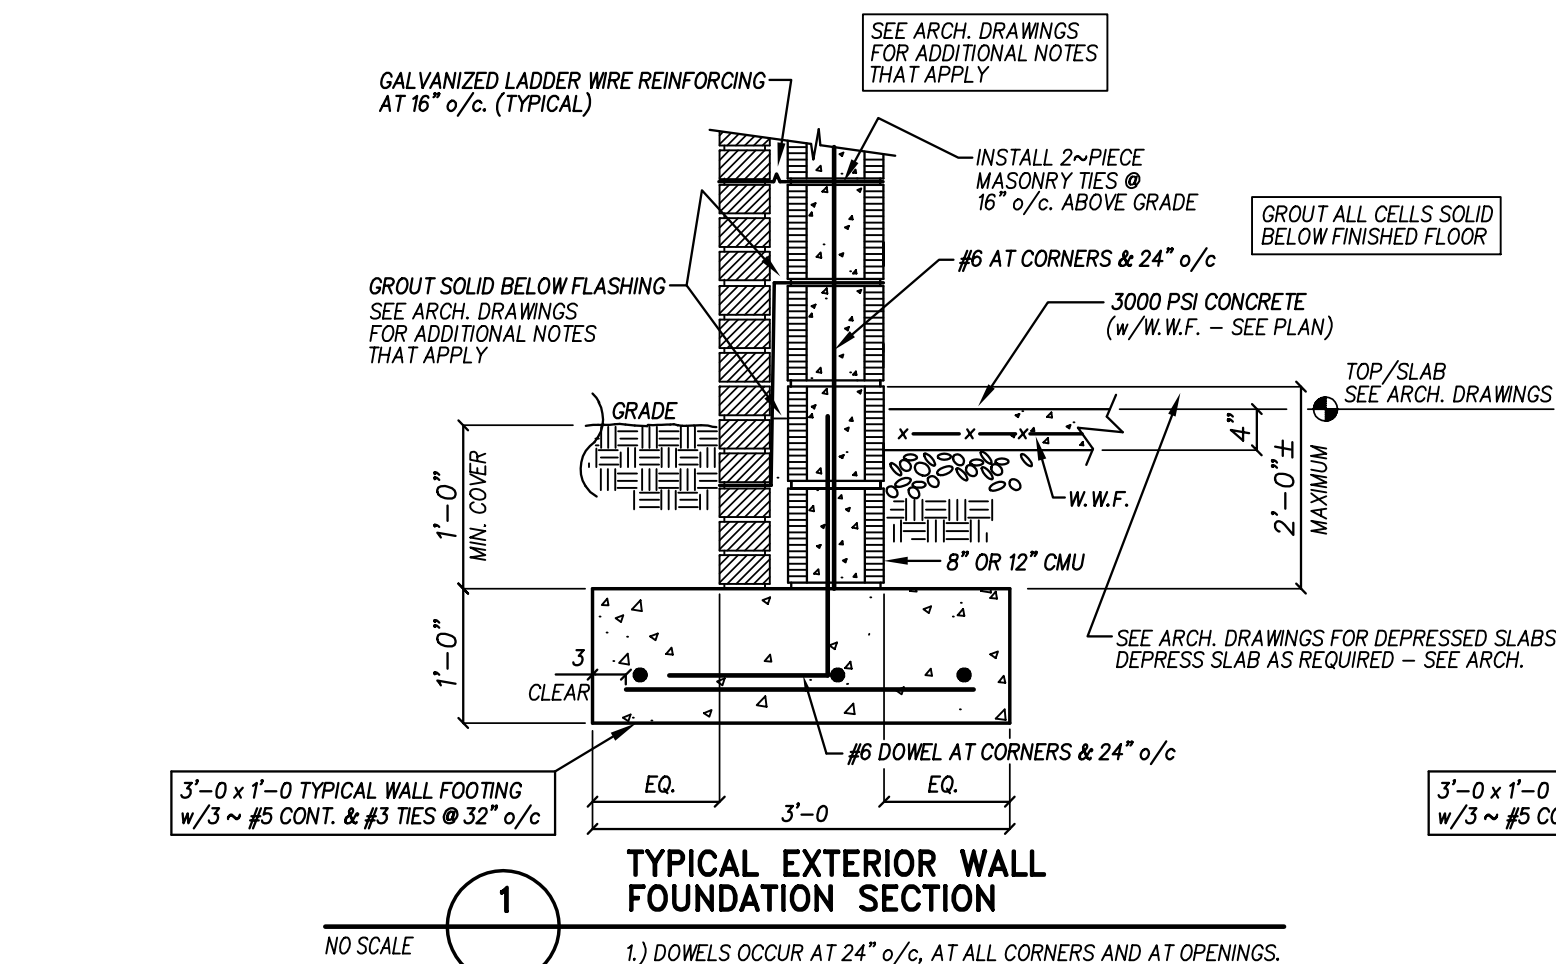


1) DOWELS OCCUR AT 24" o/c. AT ALL CORNERS AND AT OPENINGS. GROUT ALL FILLED CELLS SOLID.
2) ALL CMU CELLS BELOW FINISHED FLOOR SHALL BE FILLED WITH CONCRETE.

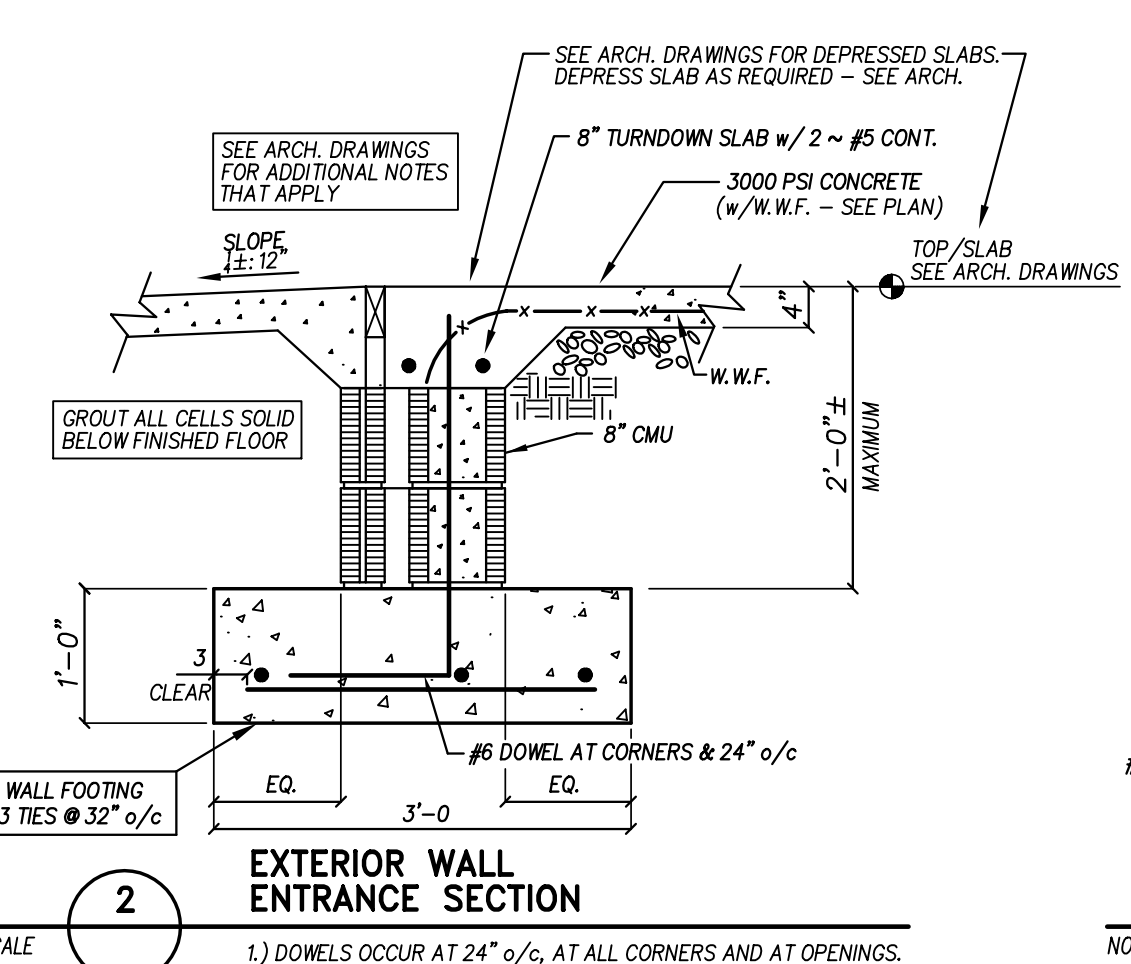


1) DOWELS OCCUR AT 24" o/c. AT ALL CORNERS AND AT OPENINGS. GROUT ALL FILLED CELLS SOLID.
2) ALL CMU CELLS BELOW FINISHED FLOOR SHALL BE FILLED WITH CONCRETE.

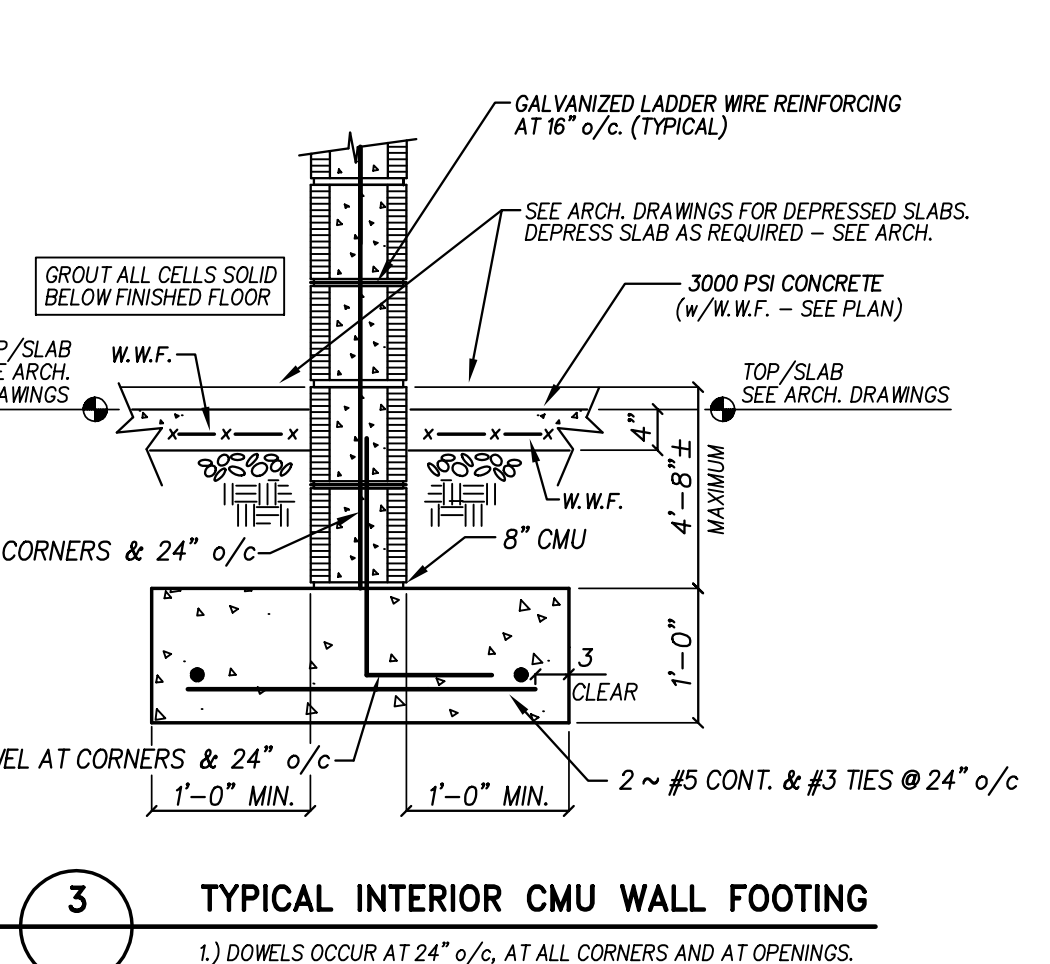


1) DOWELS OCCUR AT 24" o/c. AT ALL CORNERS AND AT OPENINGS. GROUT ALL FILLED CELLS SOLID.
2) ALL CMU CELLS BELOW FINISHED FLOOR SHALL BE FILLED WITH CONCRETE.

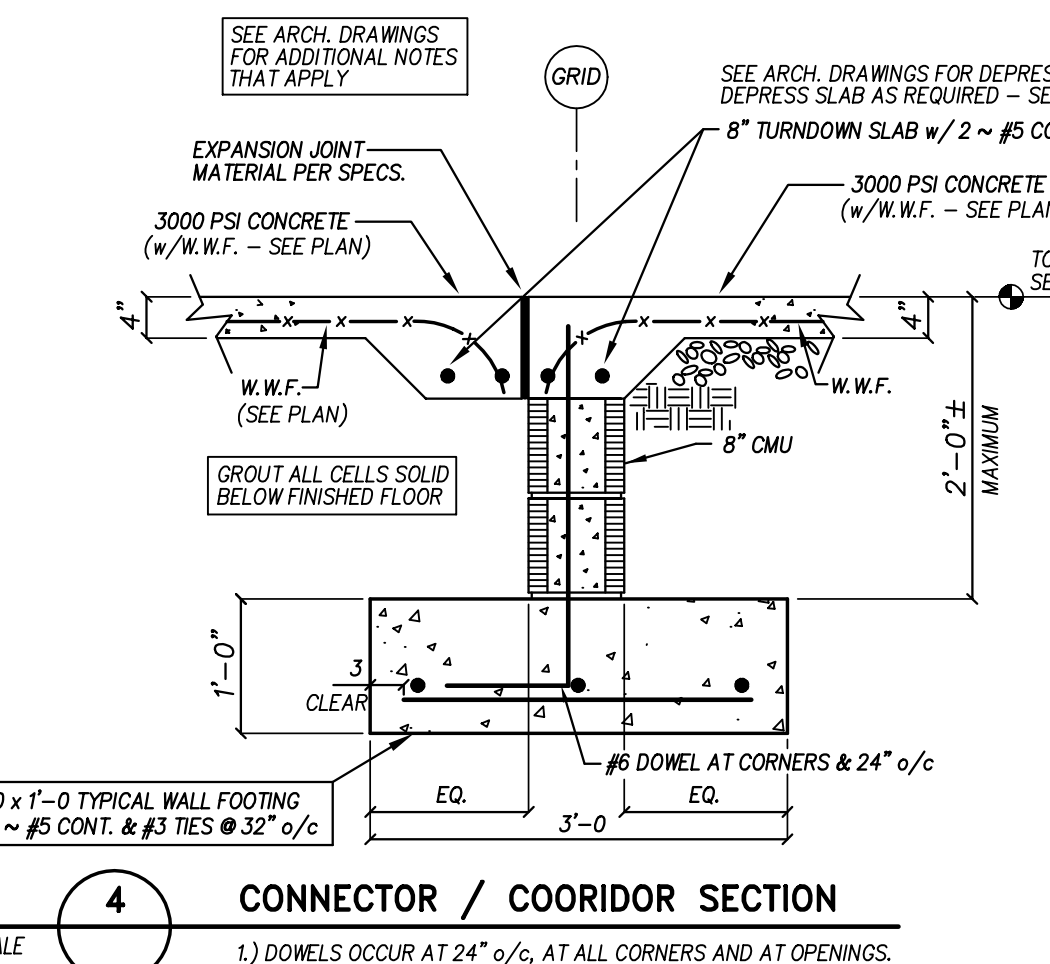


1) DOWELS OCCUR AT 24" o/c. AT ALL CORNERS AND AT OPENINGS. GROUT ALL FILLED CELLS SOLID.
2) ALL CMU CELLS BELOW FINISHED FLOOR SHALL BE FILLED WITH CONCRETE.

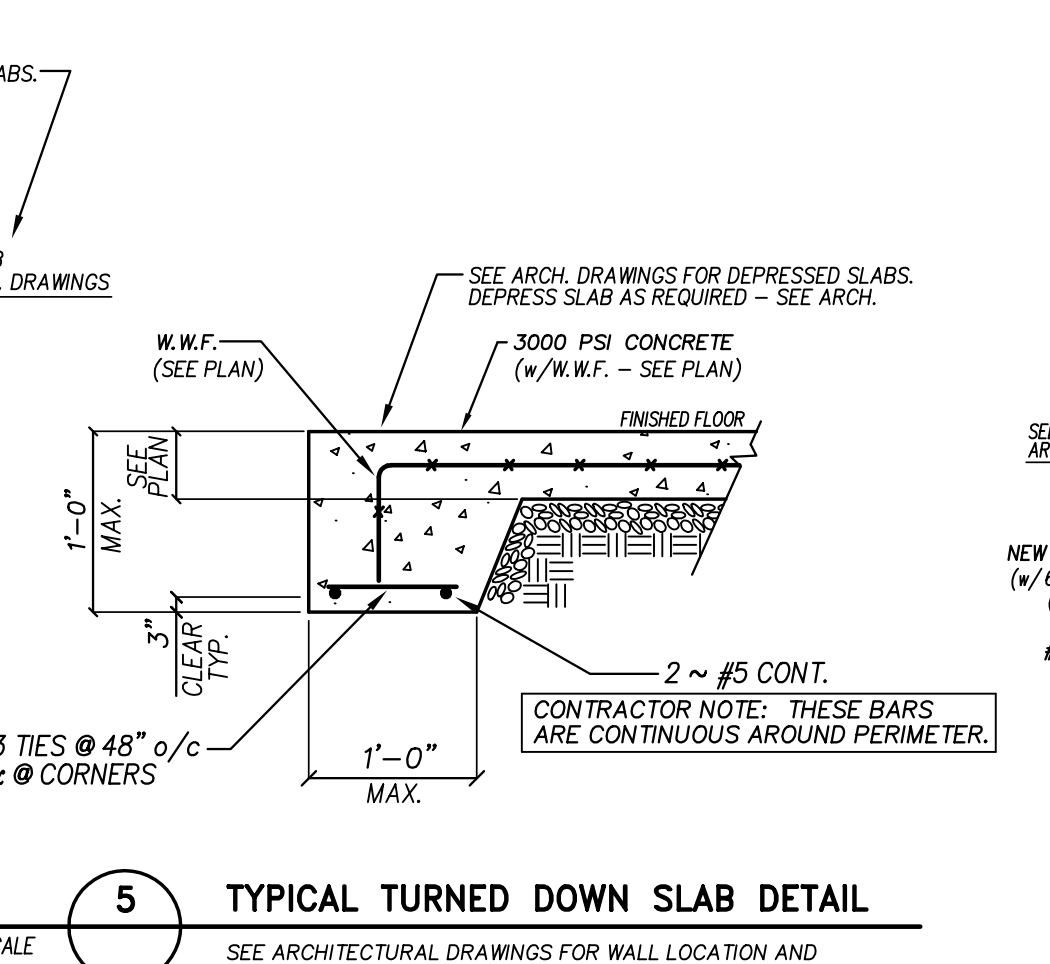


SEE ARCHITECTURAL DRAWINGS FOR WALL LOCATION AND DIMENSIONS OF ALL TURN DOWN SLAB EDGES.

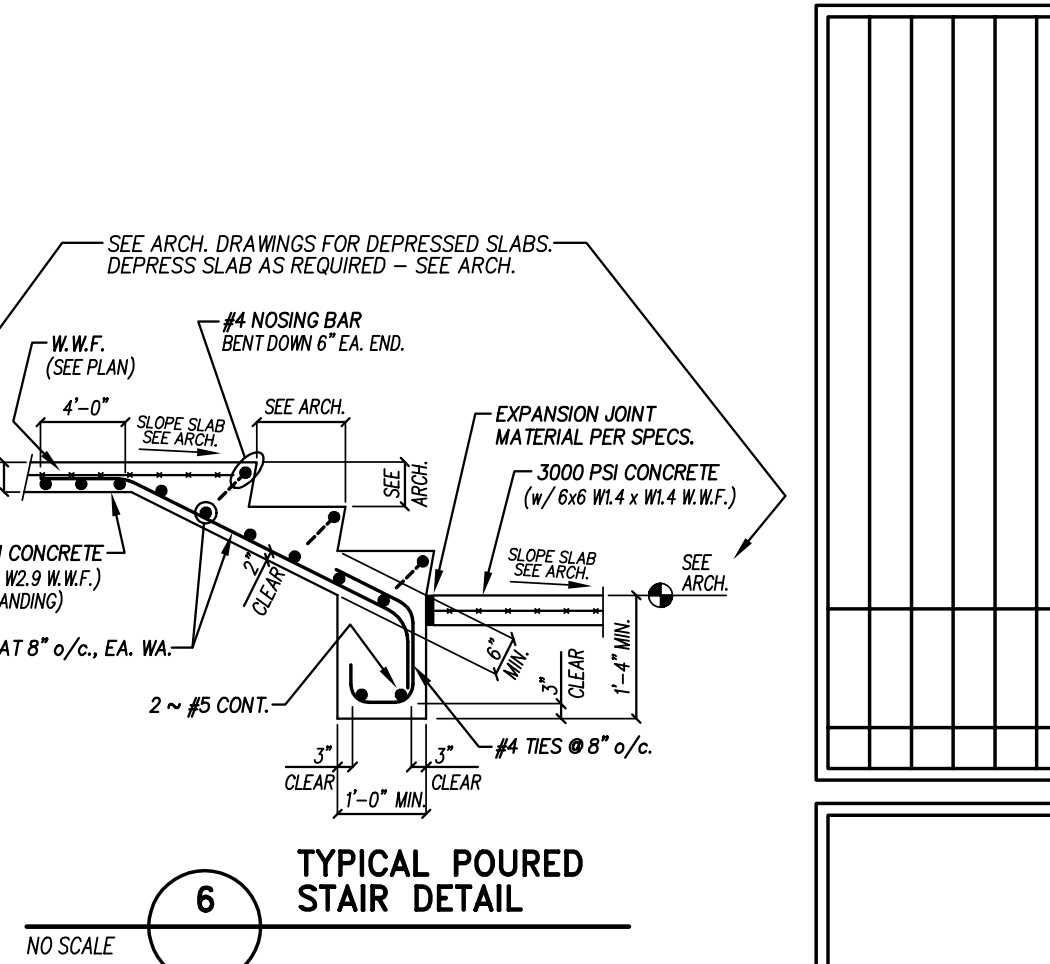


SEE ARCH. DRAWINGS FOR DERESSED SLABS. DEPRESS SLAB AS REQUIRED - SEE ARCH.

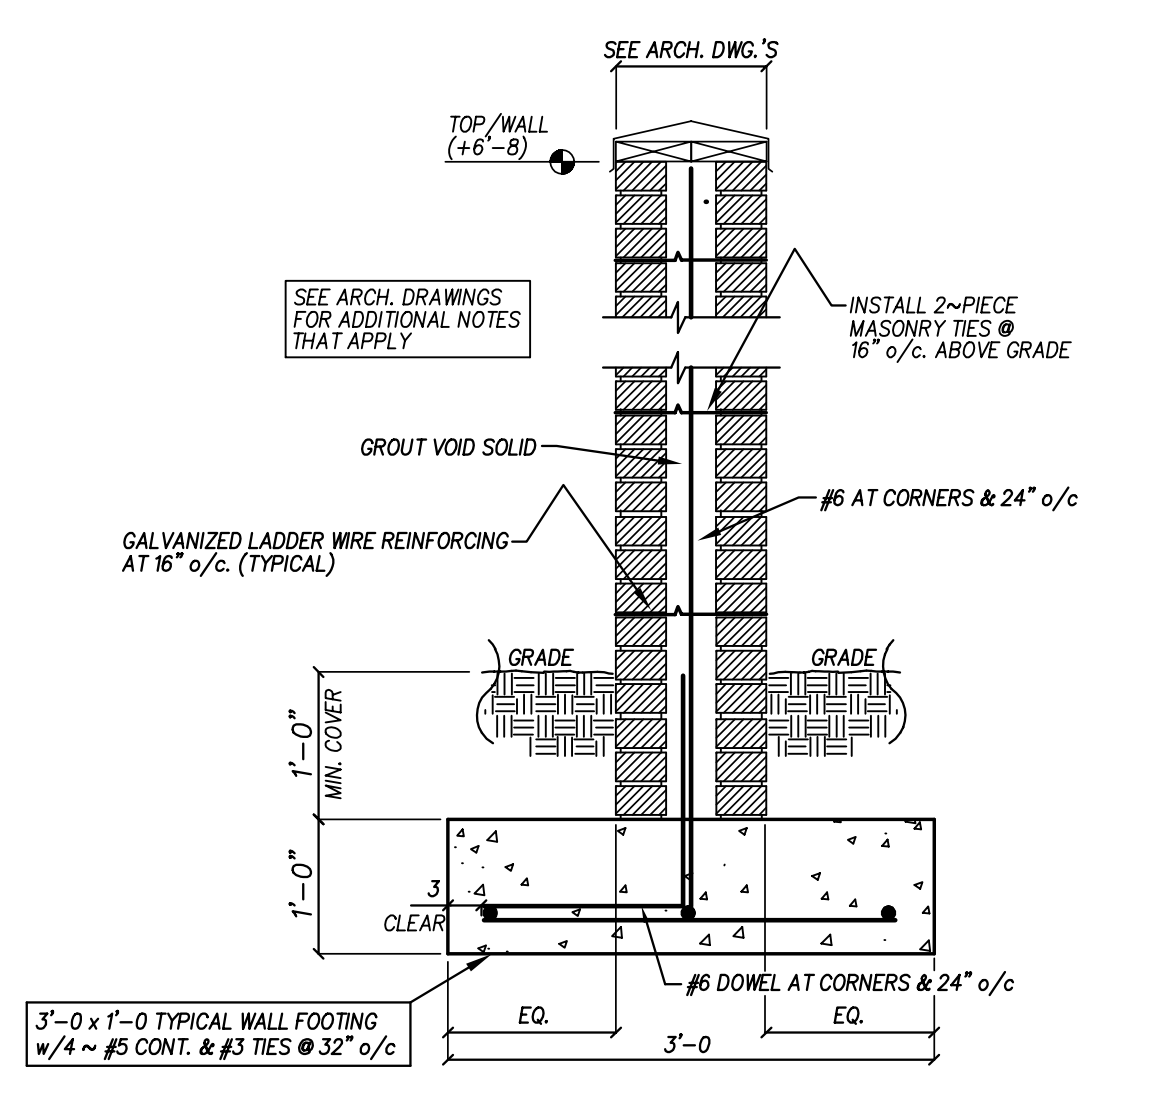


1) DOWELS OCCUR AT 24" o/c. AT ALL CORNERS AND AT OPENINGS. GROUT ALL FILLED CELLS SOLID.
2) ALL CMU CELLS BELOW FINISHED GRADE SHALL BE FILLED WITH CONCRETE.

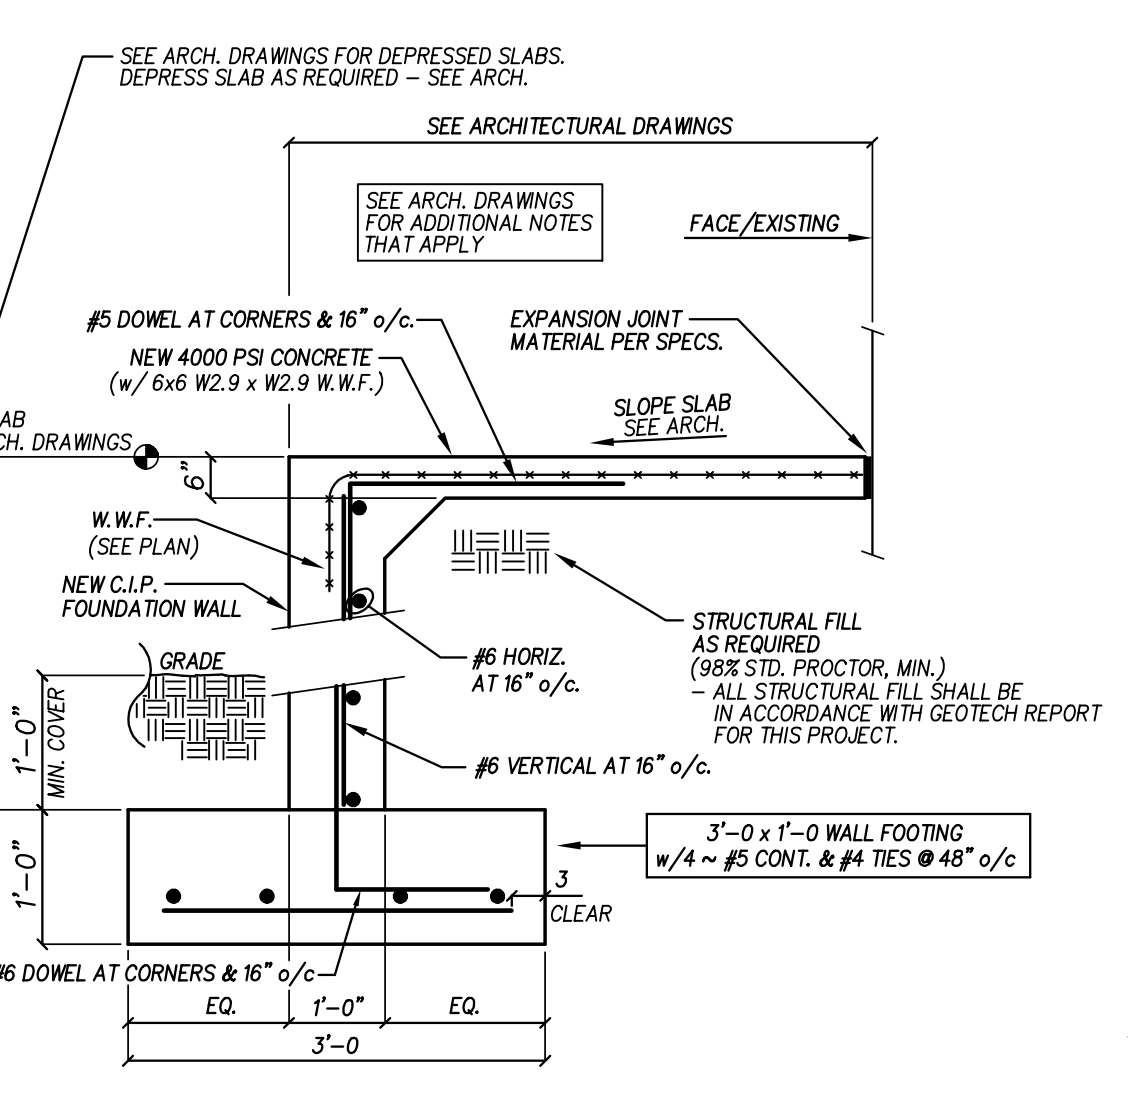


1) SEE ARCH. DRAWINGS FOR ALL RAMP & PLATFORM LOCATIONS.

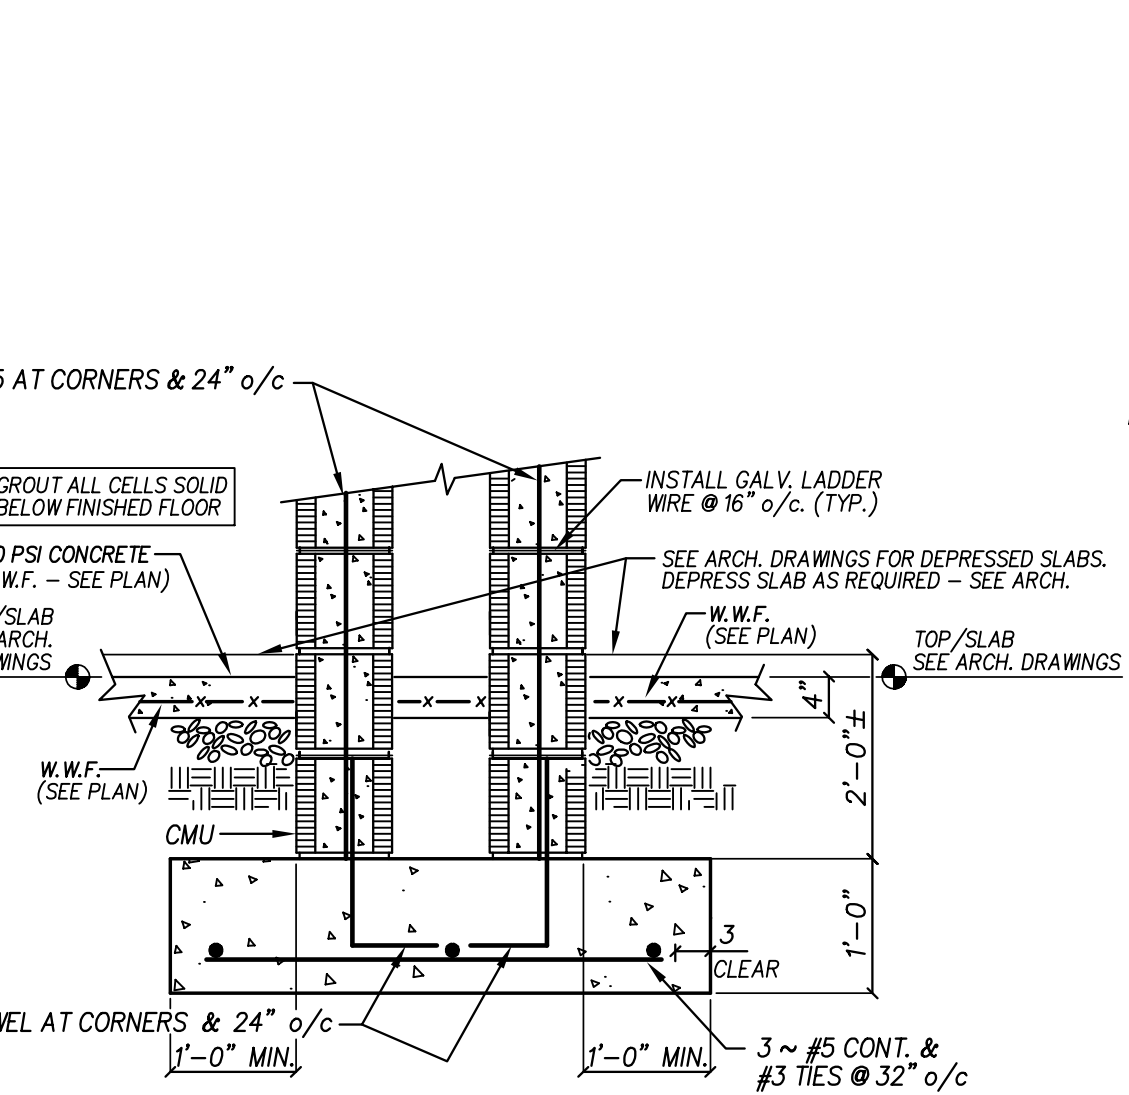


1) DOWELS OCCUR AT 24" o/c. AT ALL CORNERS AND AT OPENINGS. GROUT ALL FILLED CELLS SOLID.

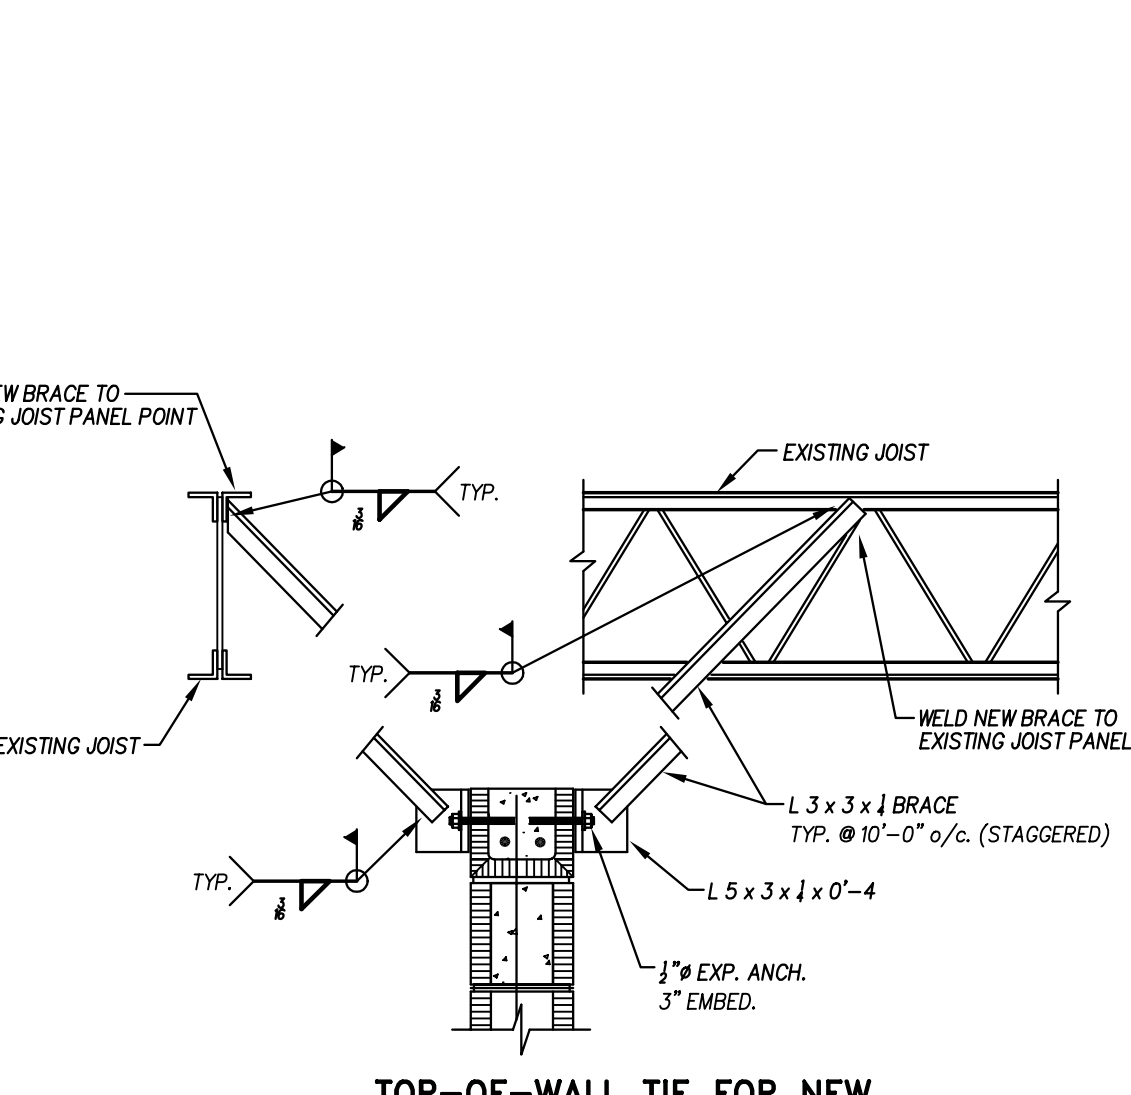

CONTRACTOR NOTE: THIS DETAIL IS NEEDED ONLY WHERE CORNER-TO-CORNER LENGTH OF WALLS IS GREATER THAN 20'-0".

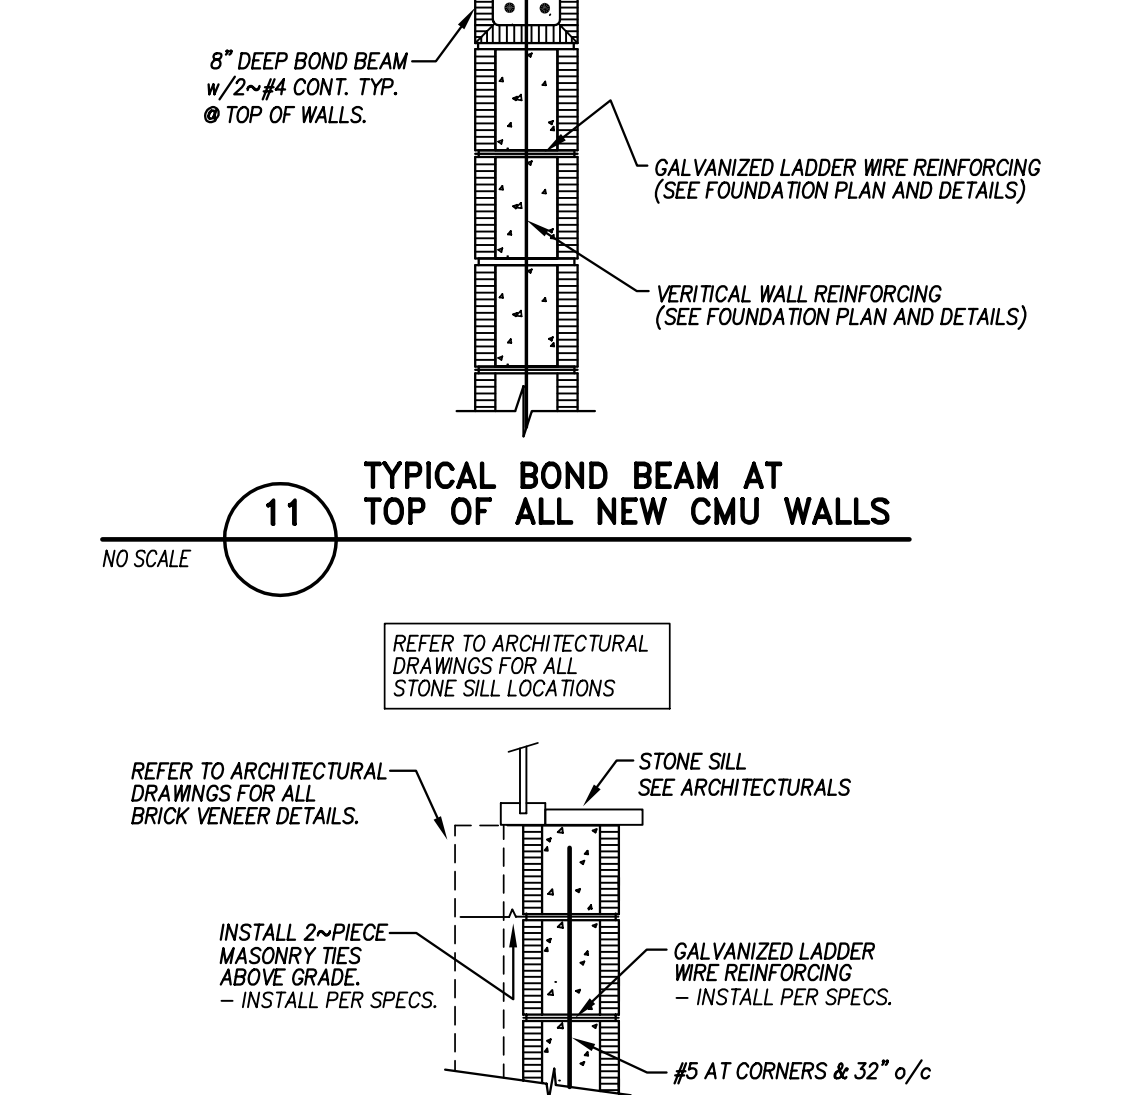

REFER TO ARCHITECTURAL DRAWINGS FOR ALL BRICK VENEER DETAILS.

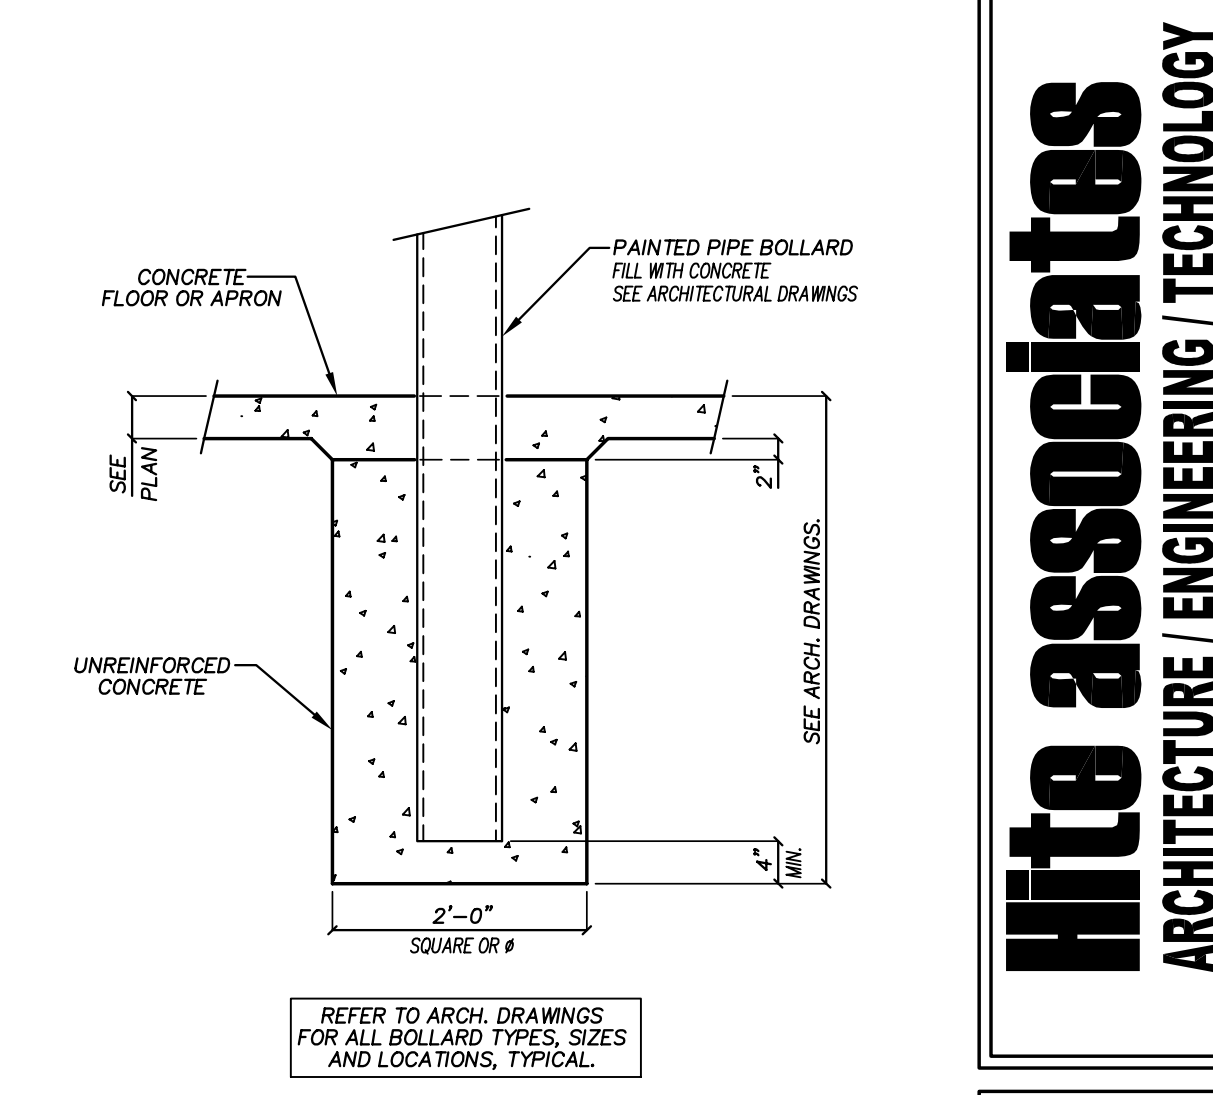


1) SEE ARCH. DWG.'S FOR ALL LOCATIONS THAT APPLY.
2) SEE ARCH. DWG.'S FOR ADDITIONAL NOTES THAT APPLY.


NO.	DATE	REVISION

Hite associates
ARCHITECTURE ENGINEERING TECHNOLOGY
2600 Meridian Drive / Greenville, NC 27958 / tel (252) 757-0333


QUEEN ENGINEERING & DESIGN
REGISTERED PROFESSIONAL ENGINEER
STATE OF NORTH CAROLINA
PRINCE L. QUEEN
1991
09 OCT 2024

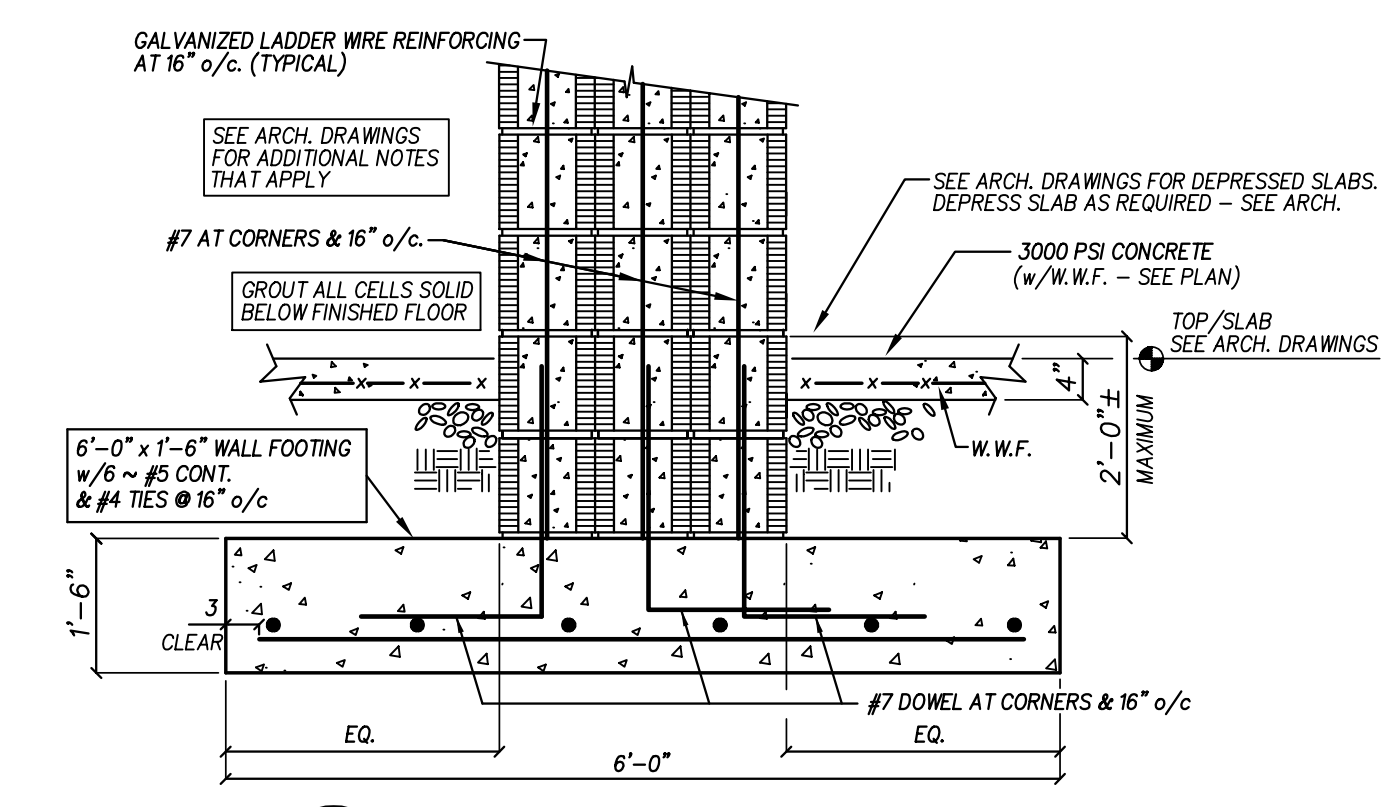

1) LAP VERTICAL SPICES 64"




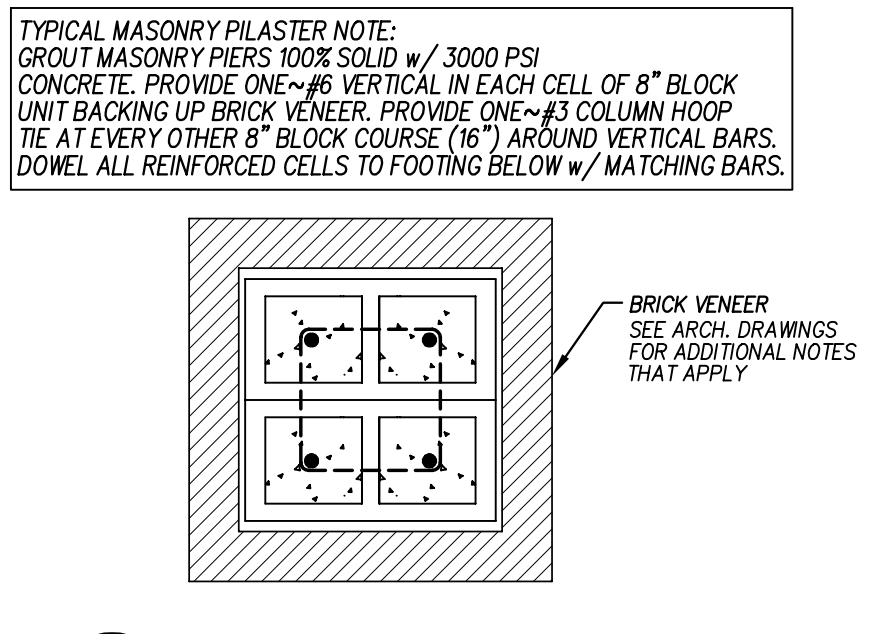


NOTE: SEE ARCH. DRAWINGS FOR ADDITIONAL NOTES AND SECTIONS THAT APPLY. AS NOTED 'P1' ON PLAN.

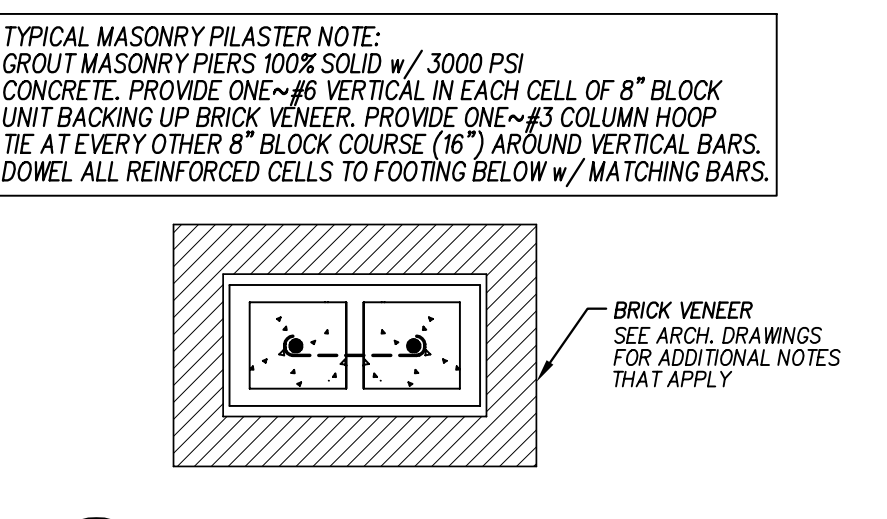

NOTE: SEE ARCH. DRAWINGS FOR ADDITIONAL NOTES AND SECTIONS THAT APPLY. AS NOTED 'P2' ON PLAN.


MARK	SIZE	REINFORCING & NOTES
(A)	3'-0" x 3'-0" x 12"	4 ~ #5 EA. WA. (BOTTOM ONLY)
(B)	4'-0" x 4'-0" x 12"	5 ~ #5 EA. WA. (BOTTOM ONLY)
(C)	5'-6" x 5'-6" x 12"	6 ~ #5 EA. WA. (BOTTOM ONLY)
(D)	6'-6" x 6'-6" x 12"	7 ~ #5 EA. WA. (BOTTOM ONLY)
(E)	7'-0" x 7'-0" x 14"	7 ~ #5 EA. WA. (BOTTOM ONLY)
(F)	9'-0" x 9'-0" x 18"	8 ~ #6 EA. WA. (BOTTOM ONLY)

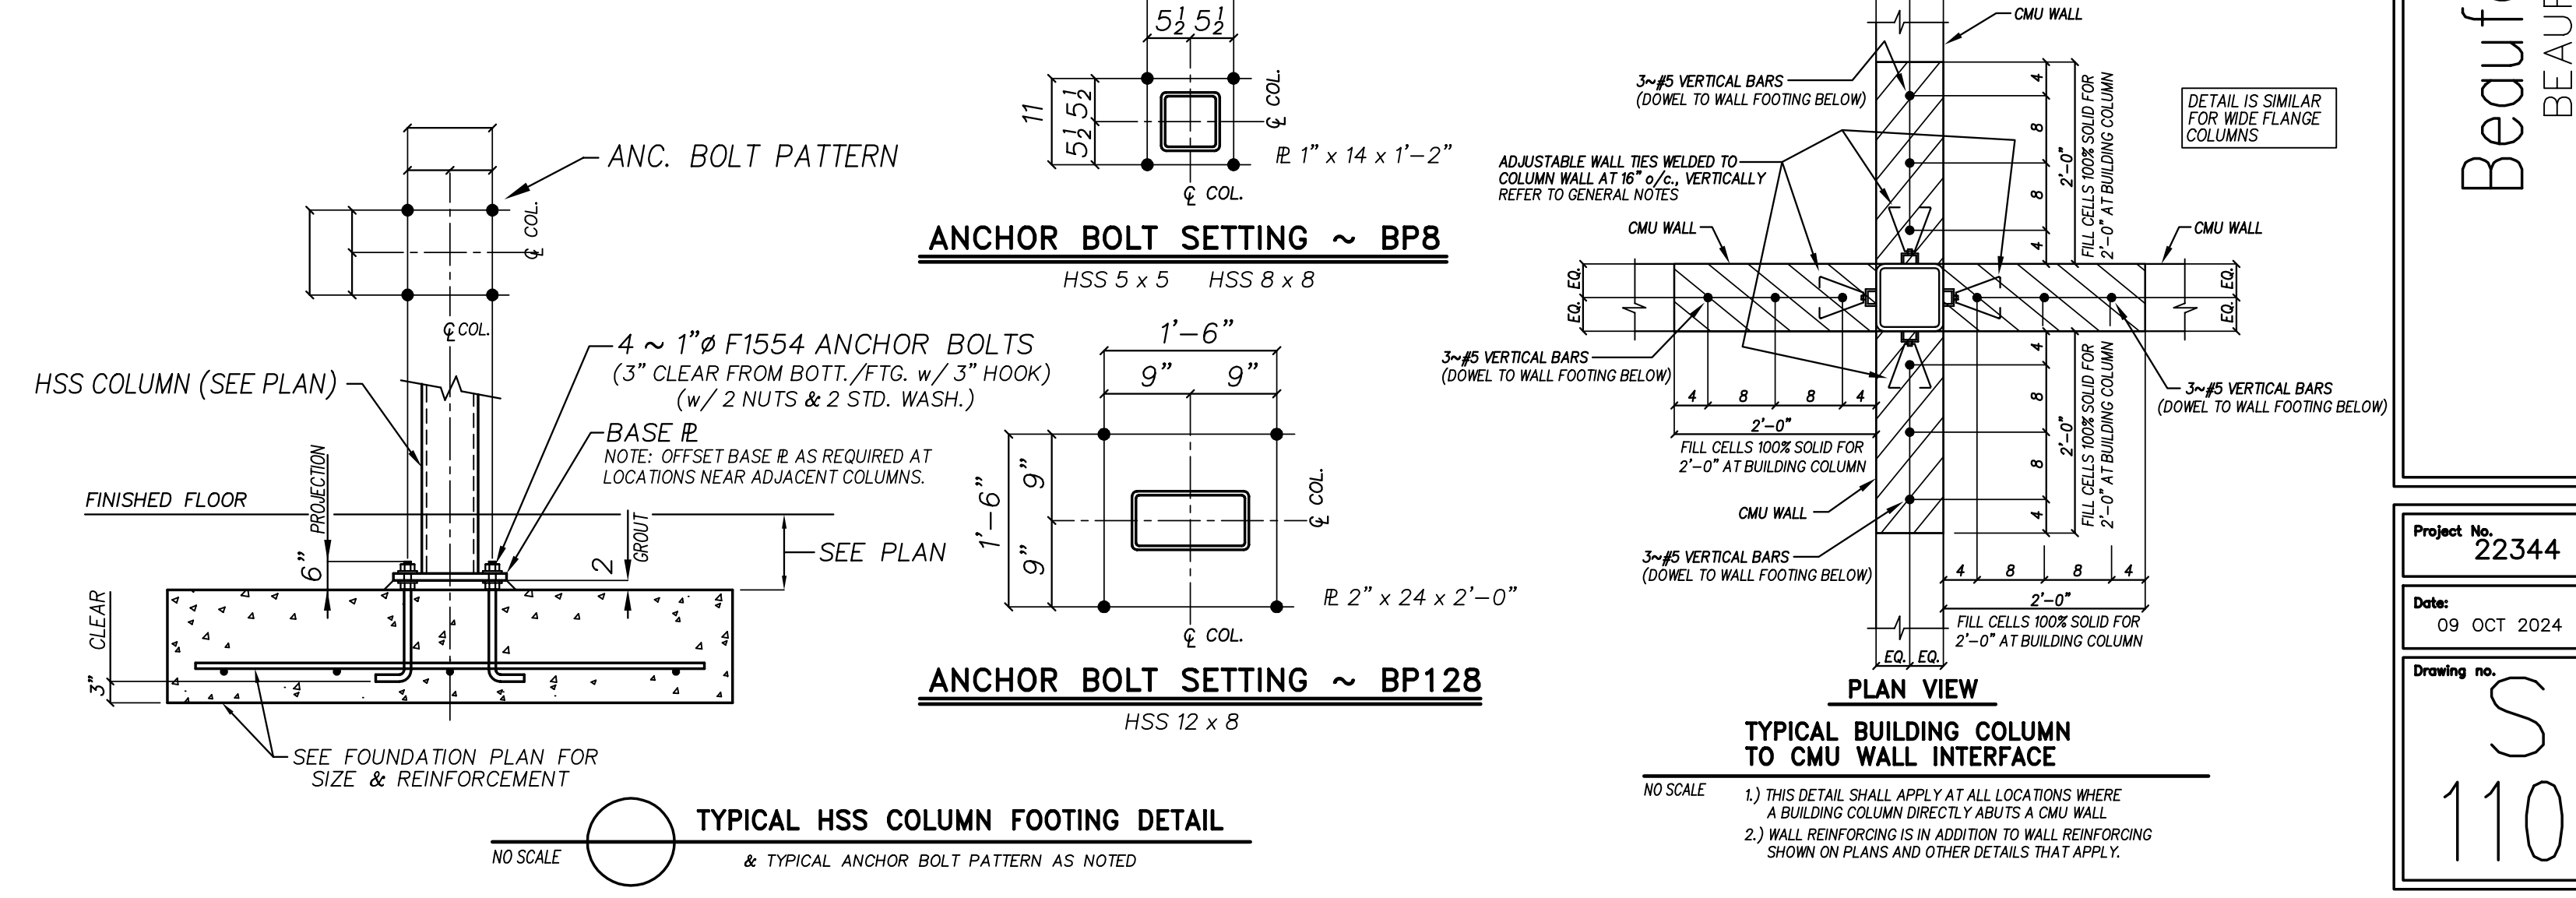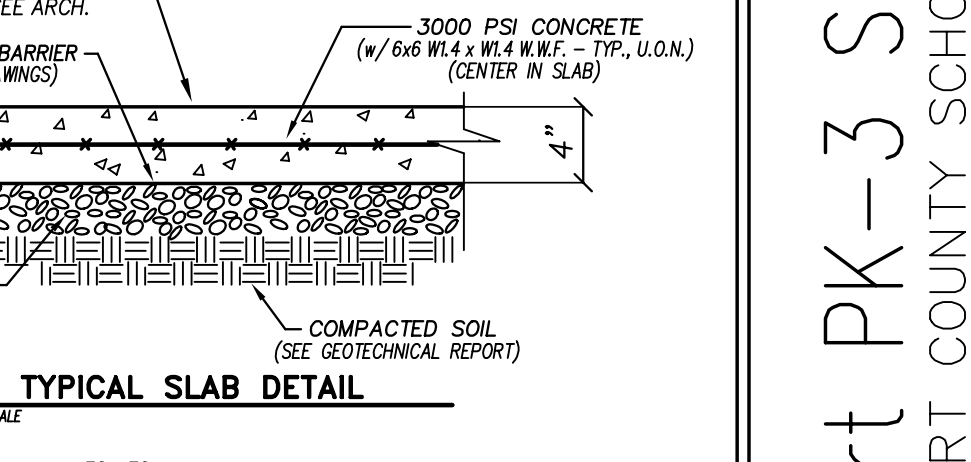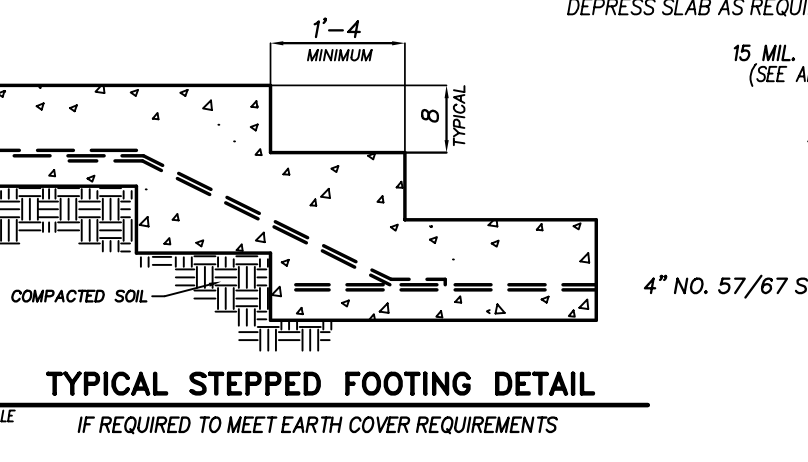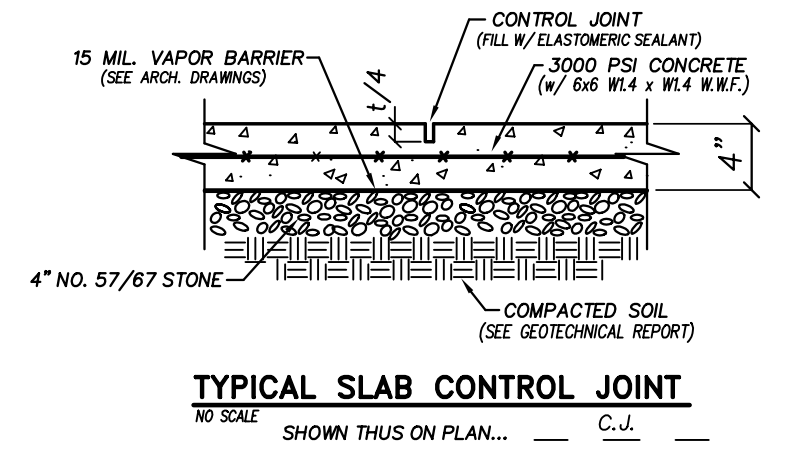


1) THIS DETAIL SHALL APPLY AT ALL LOCATIONS WHERE A BUILDING COLUMN DIRECTLY ABUTS A CMU WALL.
2) WALL REINFORCING IS IN ADDITION TO WALL REINFORCING SHOWN ON PLANS AND OTHER DETAILS THAT APPLY.

Beaufort PK-3 School
BEAUFORT COUNTY SCHOOLS
Washington / North Carolina / 27889


Project No. 22344
Date: 09 OCT 2024
Drawing no. S 1101

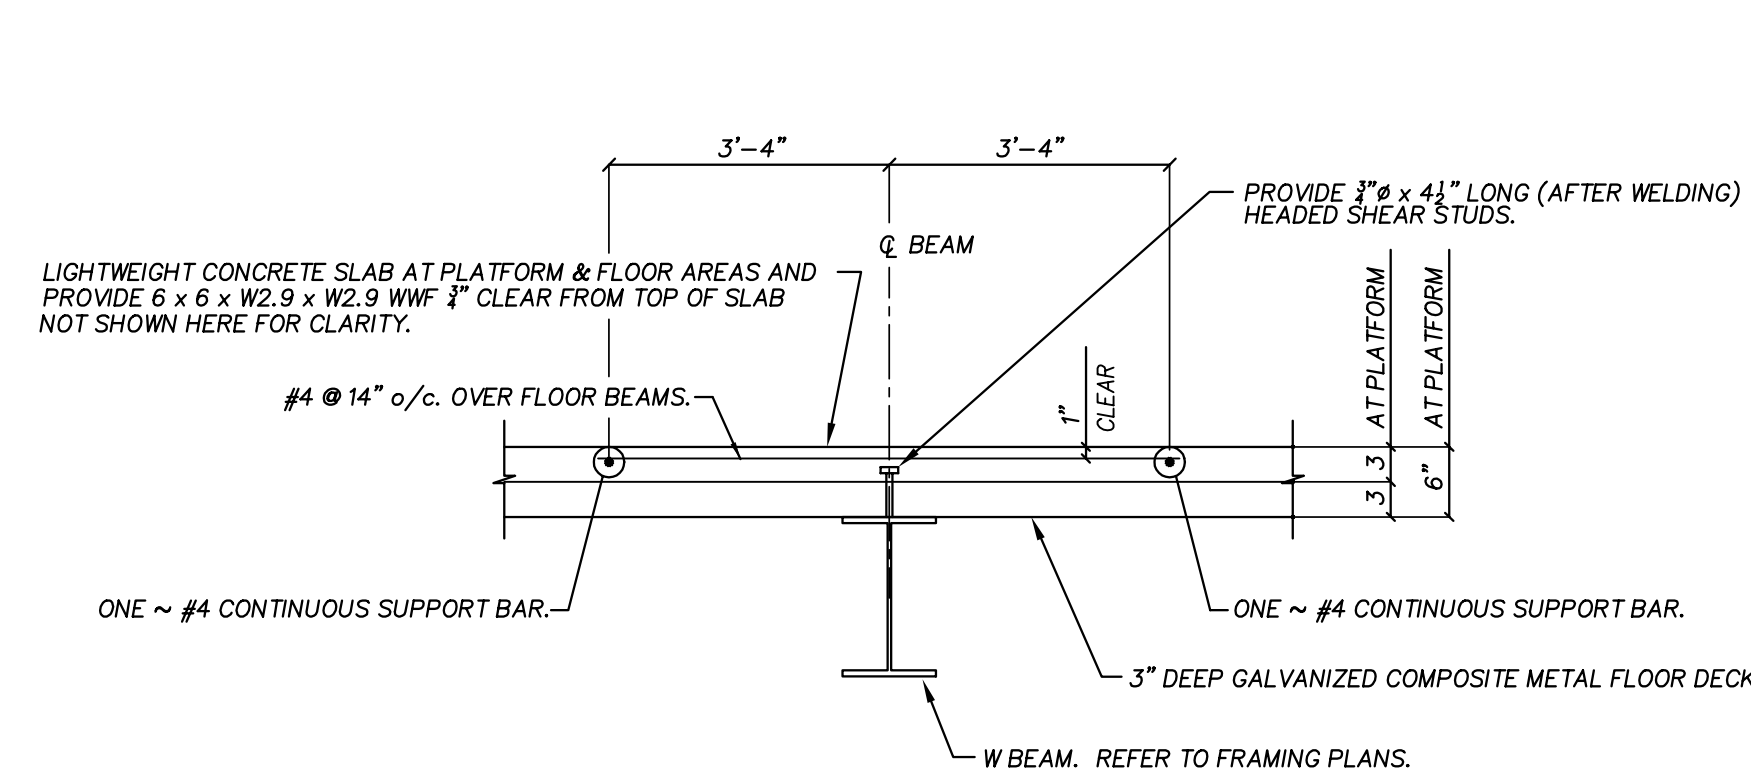


1 TYPICAL PLATFORM SUPPORT BEAM
NO SCALE

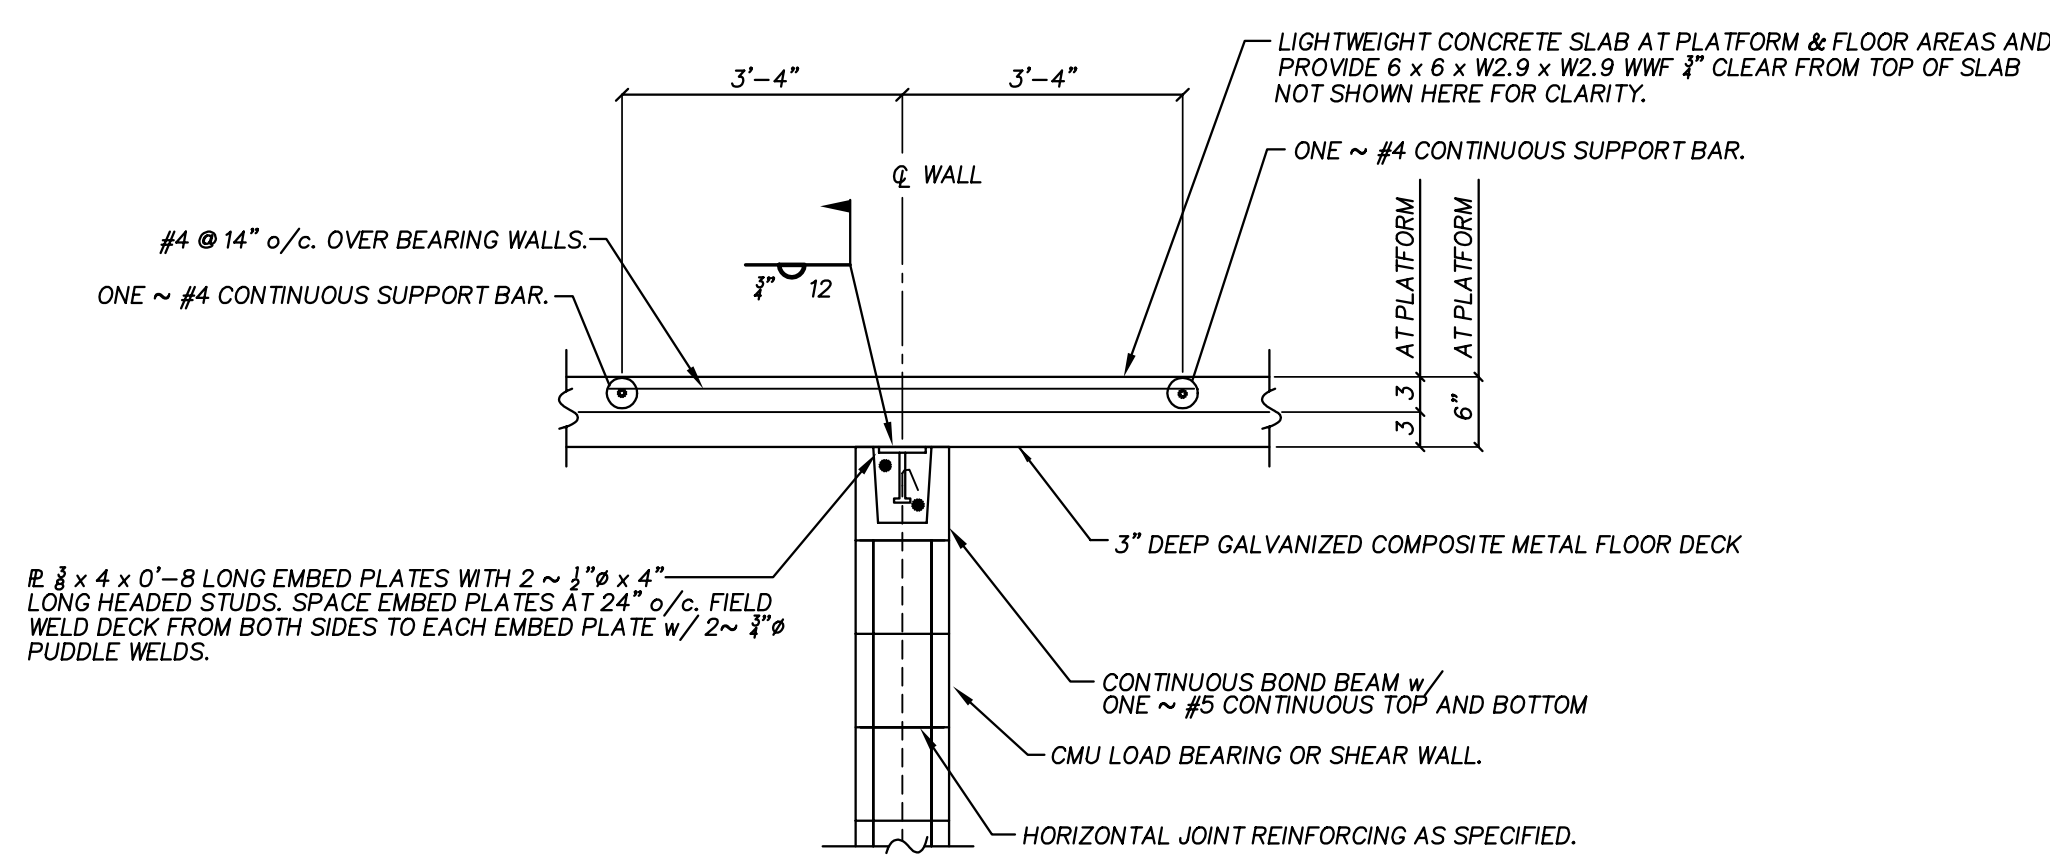


3 TYPICAL CMU LOAD BEARING WALL
DETAIL AT ELEVATED SLAB
NO SCALE

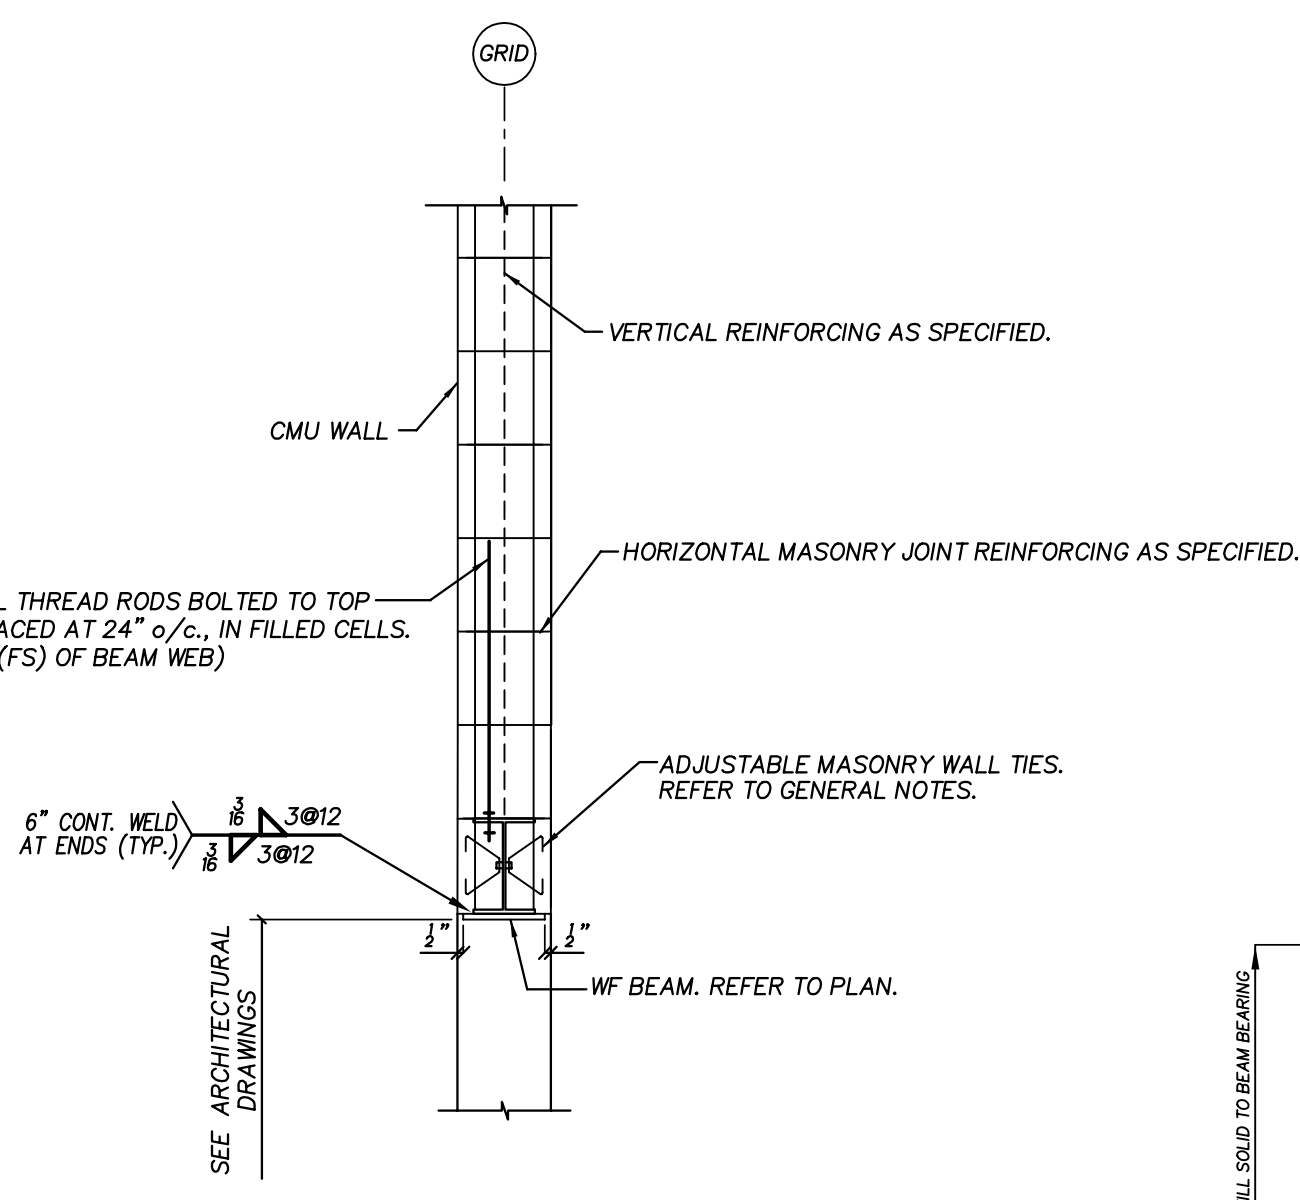


5 TYPICAL WF BEAM AT CMU WALL
NO SCALE

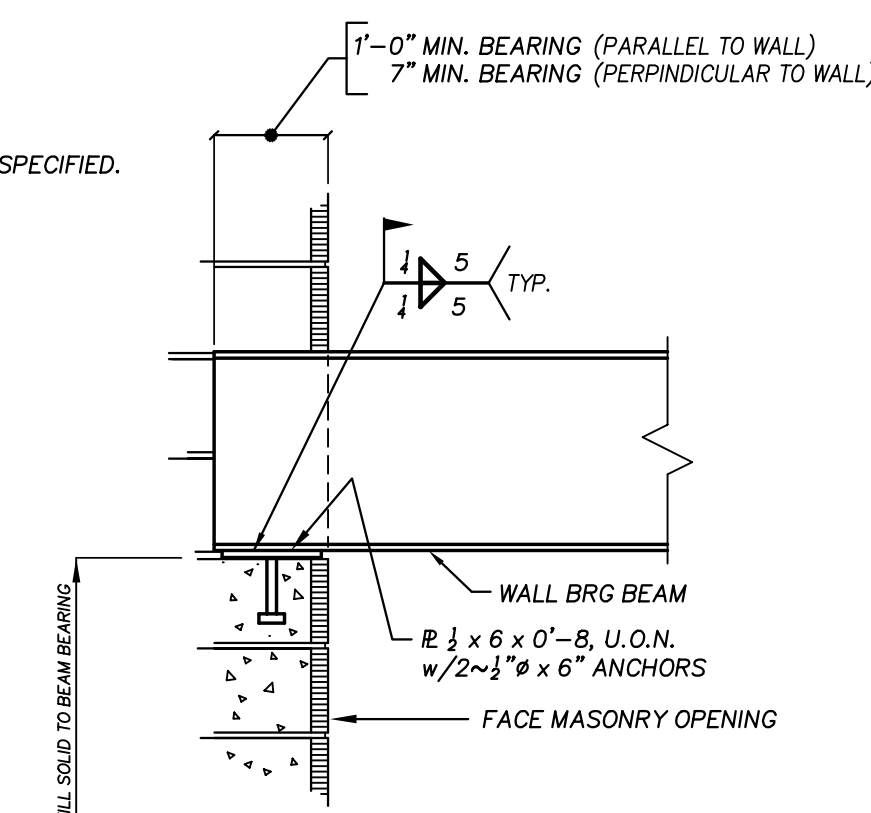


6 TYPICAL BEAM BEARING DETAIL
NO SCALE

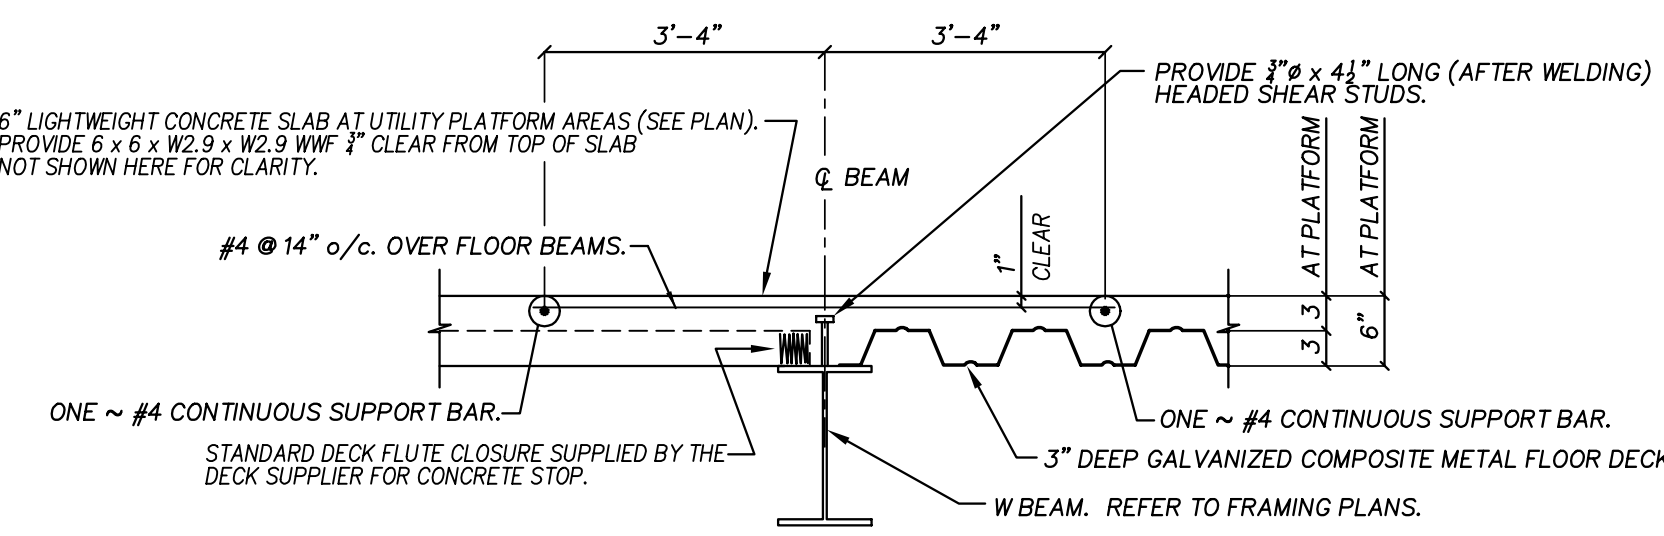


2 TYPICAL ELEVATED SLAB EDGE DETAILS
NO SCALE

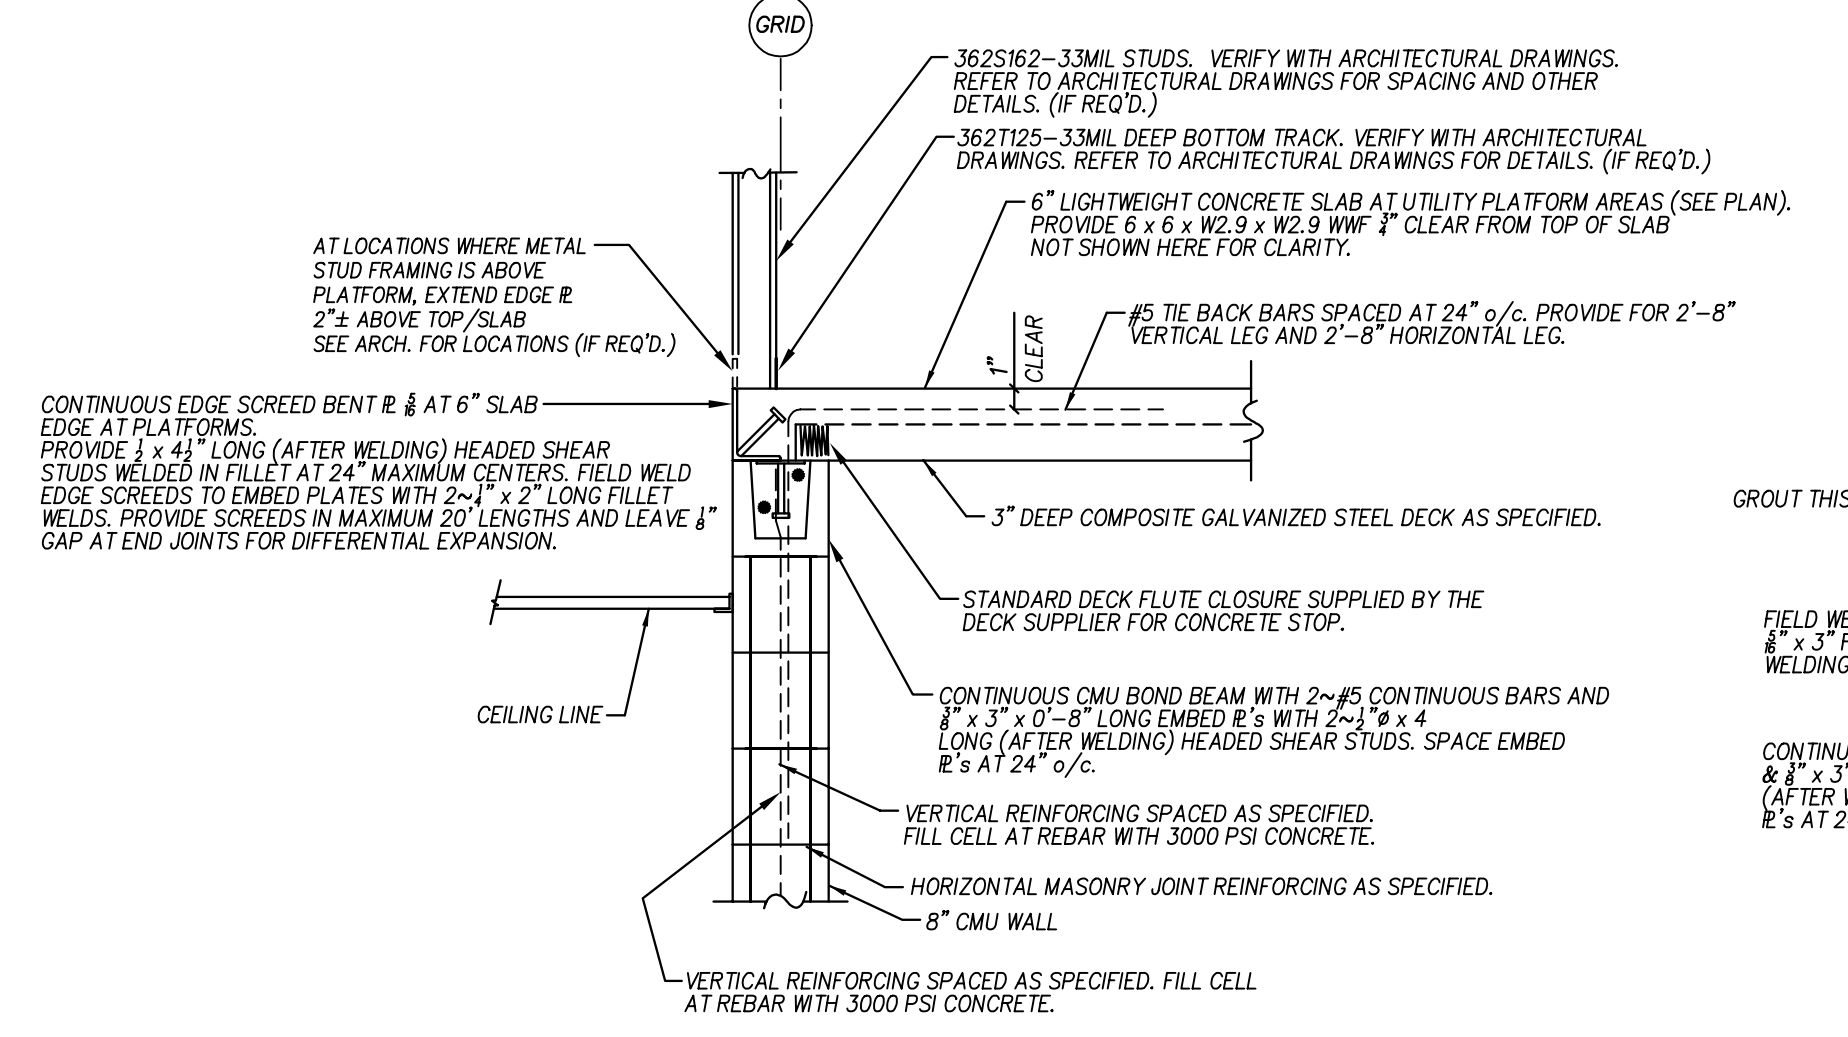

4 TYPICAL WF LINTEL BEAM AT CMU AND BRICK
NO SCALE

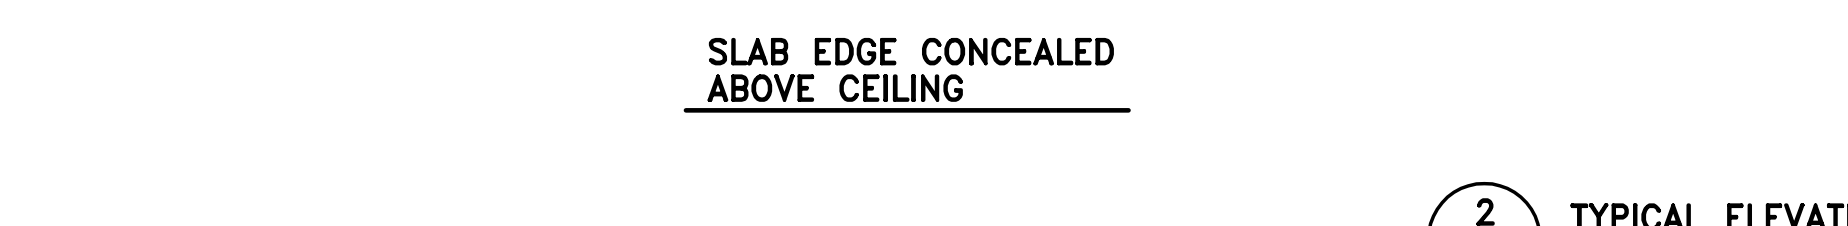

7 TYPICAL STAIR CONSTRUCTION
NO SCALE

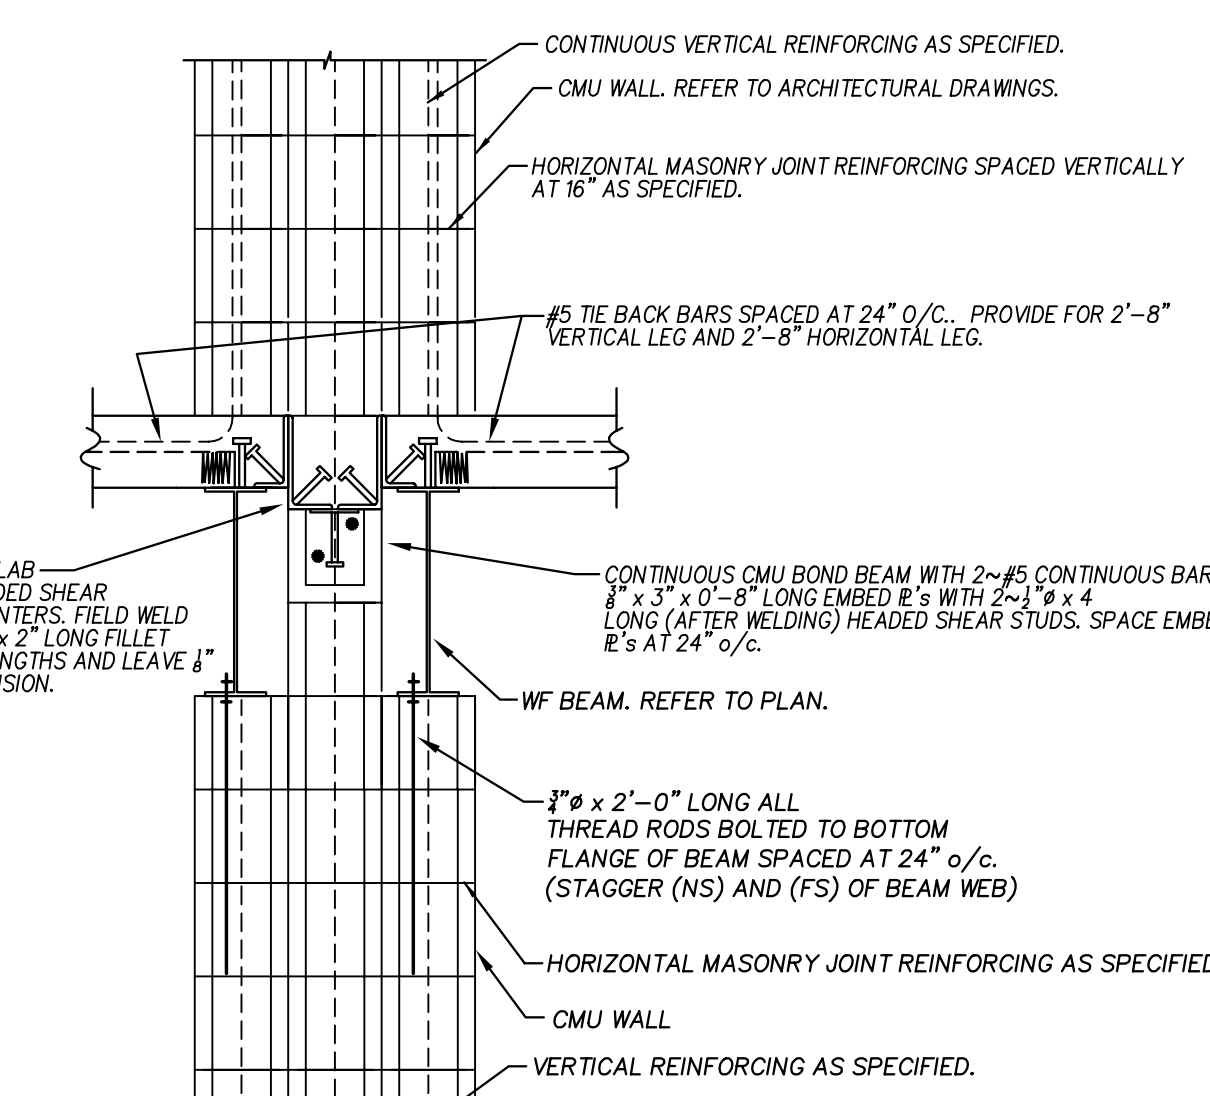


8 PLATFORM AT FIRE-RATED WALL
NO SCALE

NOTE: ALL METAL STUDS AND METAL SYSTEM TO BE MANUFACTURED BY DIETRICH INDUSTRIES OR APPROVED EQUAL CONNECTION SCHEDULE #10 TEK SCREWS (U.N.O.) (IF REQUIRED)


CONNECTION TYPE	COMMENTS
BOTTOM TRACK TO FLOOR	2~ POWDER DRIVEN FASTENERS @ 24" o/c
STUD TO BOTTOM TRACK	ONE SCREW IN EA. FLANGE, U.O.N.
STUD TO TOP TRACK	ONE SCREW IN EA. FLANGE, U.O.N.
TOP TRACK TO BEAM/GIRDER/JOIST	2~ POWDER DRIVEN FASTENERS @ 24" o/c
PLYWOOD TO STUDS	SCREW @ 6" o/c ALONG EA. STUD
TOP PL TO TRACK	#10 TEK AT 12" o/c
FC TO STUD	4~#10 TEK
FC TO SLAB	1" EXP. ANCH.
JOIST TO TOP TRACK (BEARING)	(2) SCREWS IN FLANGE
PLYWOOD FLOORING TO JOIST	SCREW @ 12" o/c ALONG EA. JOIST
BRIDGING TO JOISTS	16 GA. CLIP ANGLE w/ 4 SCREWS
BLOCKING TO JOISTS	16 GA. CLIP ANGLE w/ 4 SCREWS
TREAD TO VERTICAL STUD	(4) #10 TEK SCREWS IN WEB
WOOD SHEATHING	8d, 12" o/c AT SUPPORTS, 6" o/c. AT EDGES
HEADER TO HEADER	#10 TEK AT 12" o/c. STAGGERED (WEB TO WEB)
HEADER TO CRIPPLE	SA 18 GA. w/ 4~#8 TEK PER LEG
CRIPPLE TO LOWER TRACK	2~#8 TEK EA. FL.
HEADER TO BEARING STUD	SA 18 GA. w/ 4~#8 TEK PER LEG
BEARING STUD TO CRC BRACE	BRIDGE CLIP
BEARING STUD TO BRIDGE CLIP	4~#10 TEK
BRIDGE CLIP TO CRC	4~#10 TEK
STUD TO WALL	2 SCREWS IN EA. WEB @ 16" o/c
JOIST TO JOIST INTERFACE	ONE SCREW IN EA. FLANGE
PLYWOOD FLOORING TO JOIST	SCREW @ 12" o/c ALONG EA. JOIST
BRIDGING TO JOISTS	16 GA. CLIP ANGLE w/ 4 SCREWS
BLOCKING TO JOISTS	16 GA. CLIP ANGLE w/ 4 SCREWS
DOUBLE OR SINGLE 2x PLATE TO MASONRY	1" POWDER ACTUATED FASTENER OR MASONRY SCREW AT 12" o/c, TYPICAL

LOOSE LINTEL SCHEDULE (TYPICAL, U.O.N.)


MARK	SIZE	M.O.	BEARING	REMARKS
L1	L 3 1/2 x 3 1/2 x 1/8	1'-8" to 5'-0"	8" @ EA. END	
L2	L 5 x 3 1/2 x 1/8	5'-0" to 7'-0"	8" @ EA. END	
L3	L 6 x 3 1/2 x 1/8	7'-0" to 8'-0"	8" @ EA. END	
L4	W 8 x 10	w/E	8" @ EA. END	BEAR SIM TO 6/S1102
L5	W 8 x 18	w/E	10"-0" to 12'-0"	BEAR SIM TO 6/S1102
L6	W 16 x 26	w/E	12'-0" to 20'-0"	BEAR SIM TO 6/S1102
L7	W 16 x 31	w/E	20'-0" >	BEAR SIM TO 6/S1102

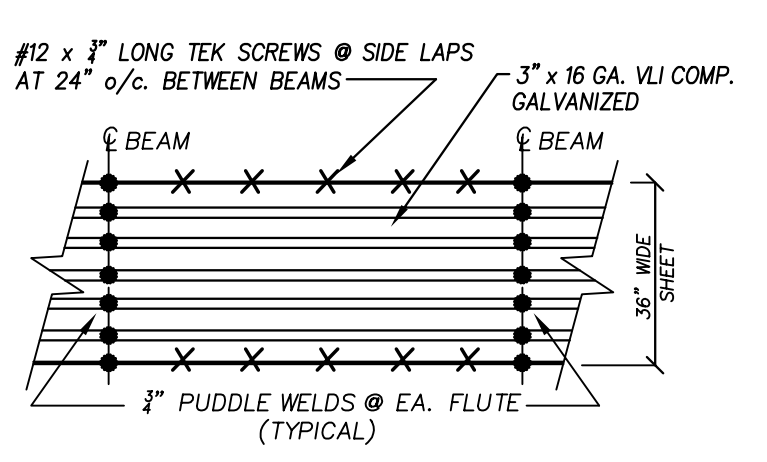


9 DECK FASTENING DETAIL TYPE "A" VLI COMPOSITE FLOOR DECK
NO SCALE

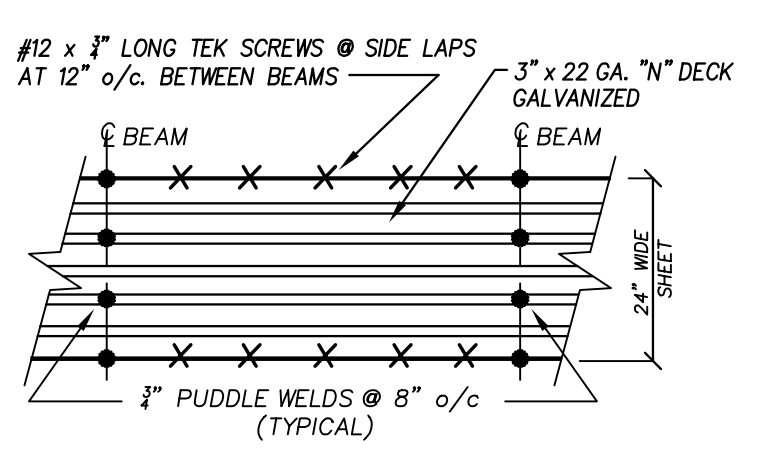


10 DECK FASTENING DETAIL TYPE "N" ROOF DECK
NO SCALE

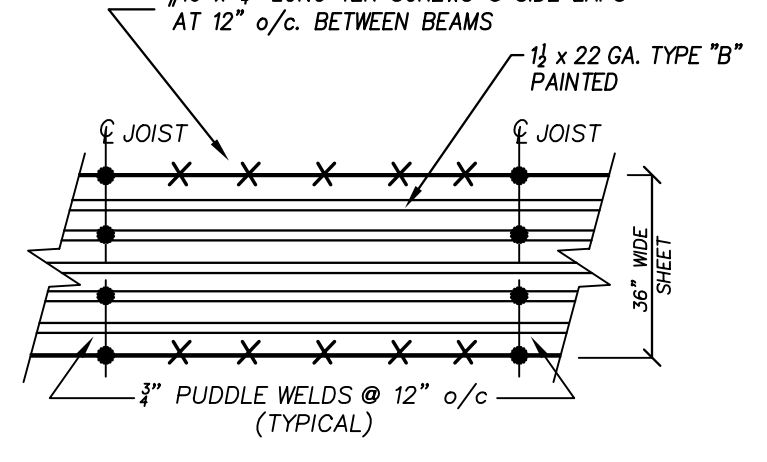

11 DECK FASTENING DETAIL TYPE "B" ROOF DECK
NO SCALE

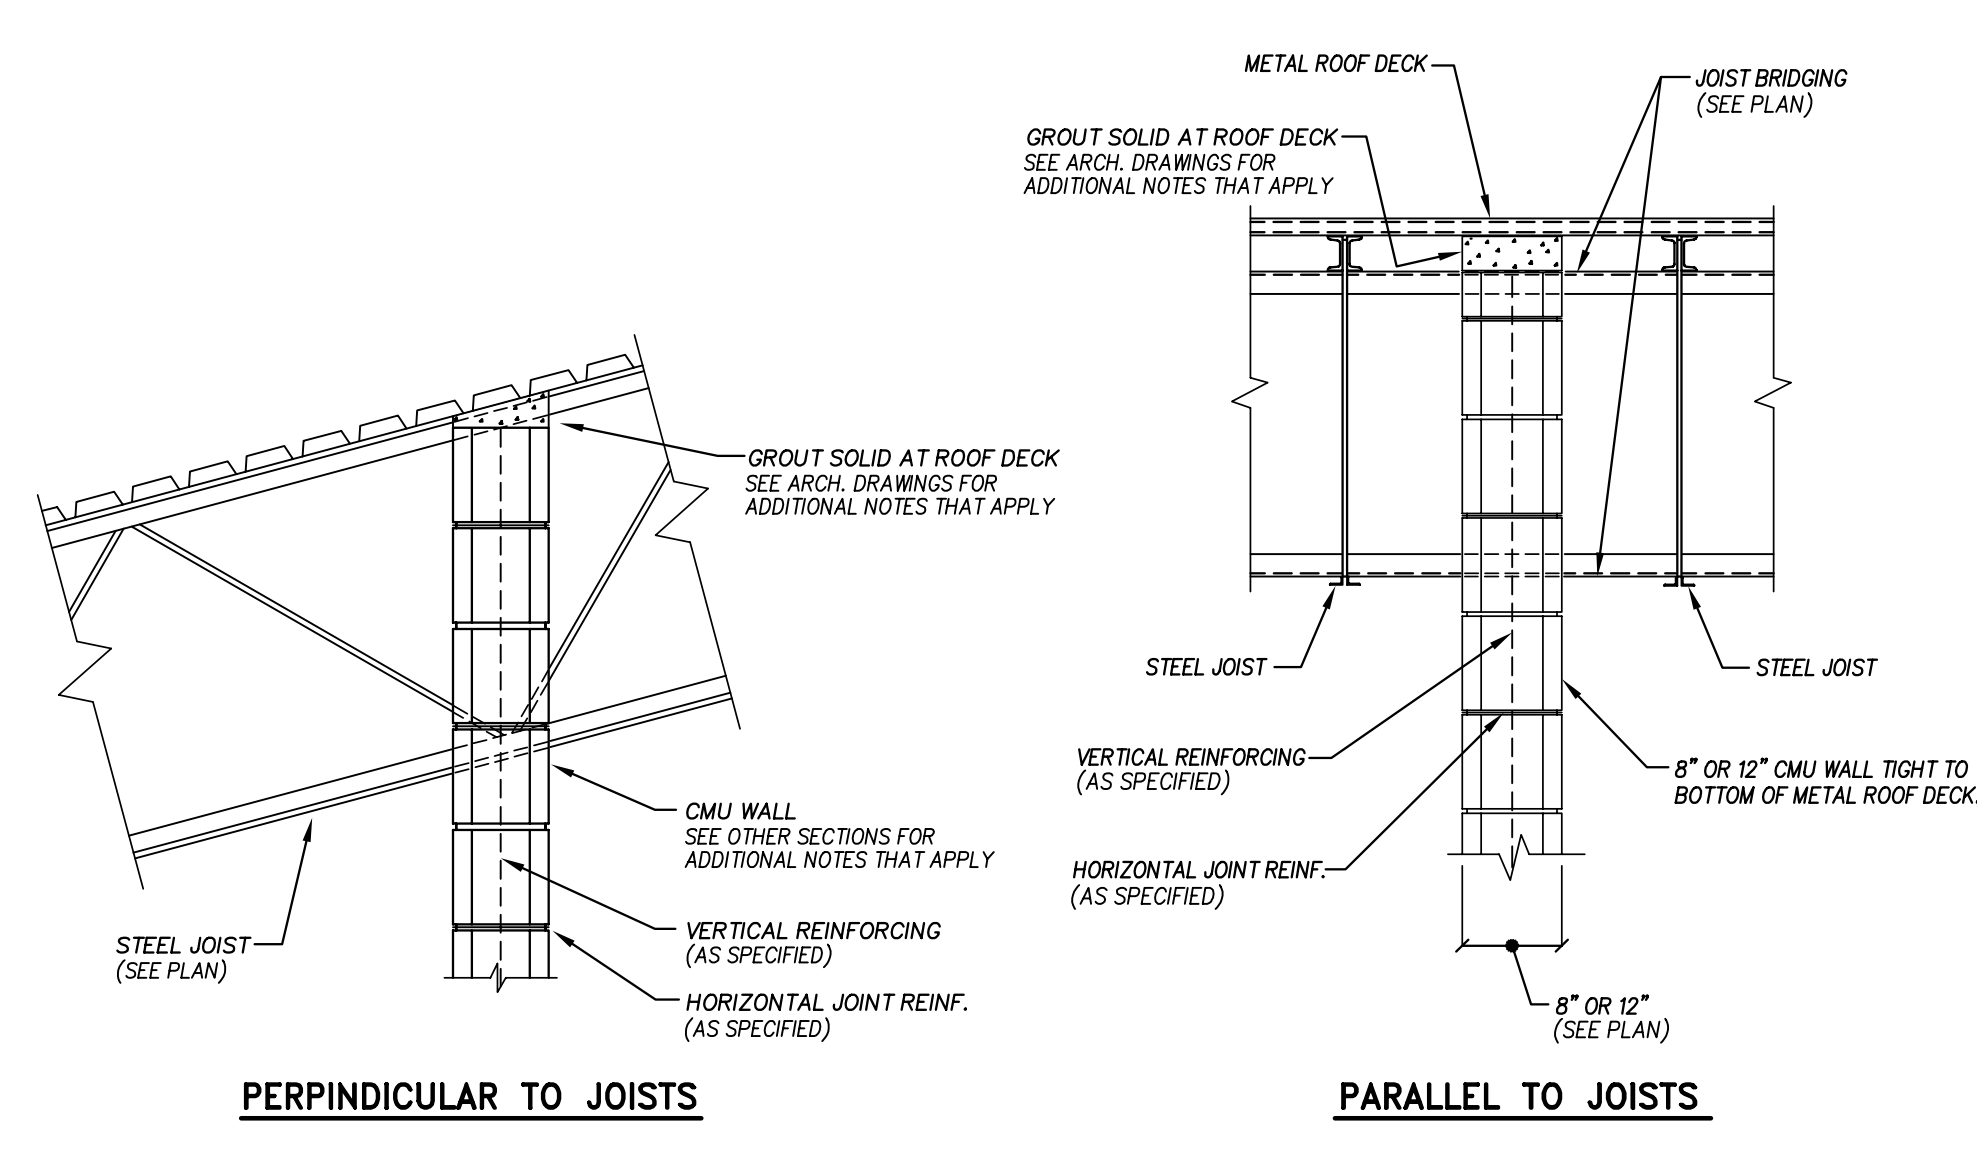


12 TYPICAL INTERIOR CMU WALL SEALED TO METAL ROOF DECK
NO SCALE

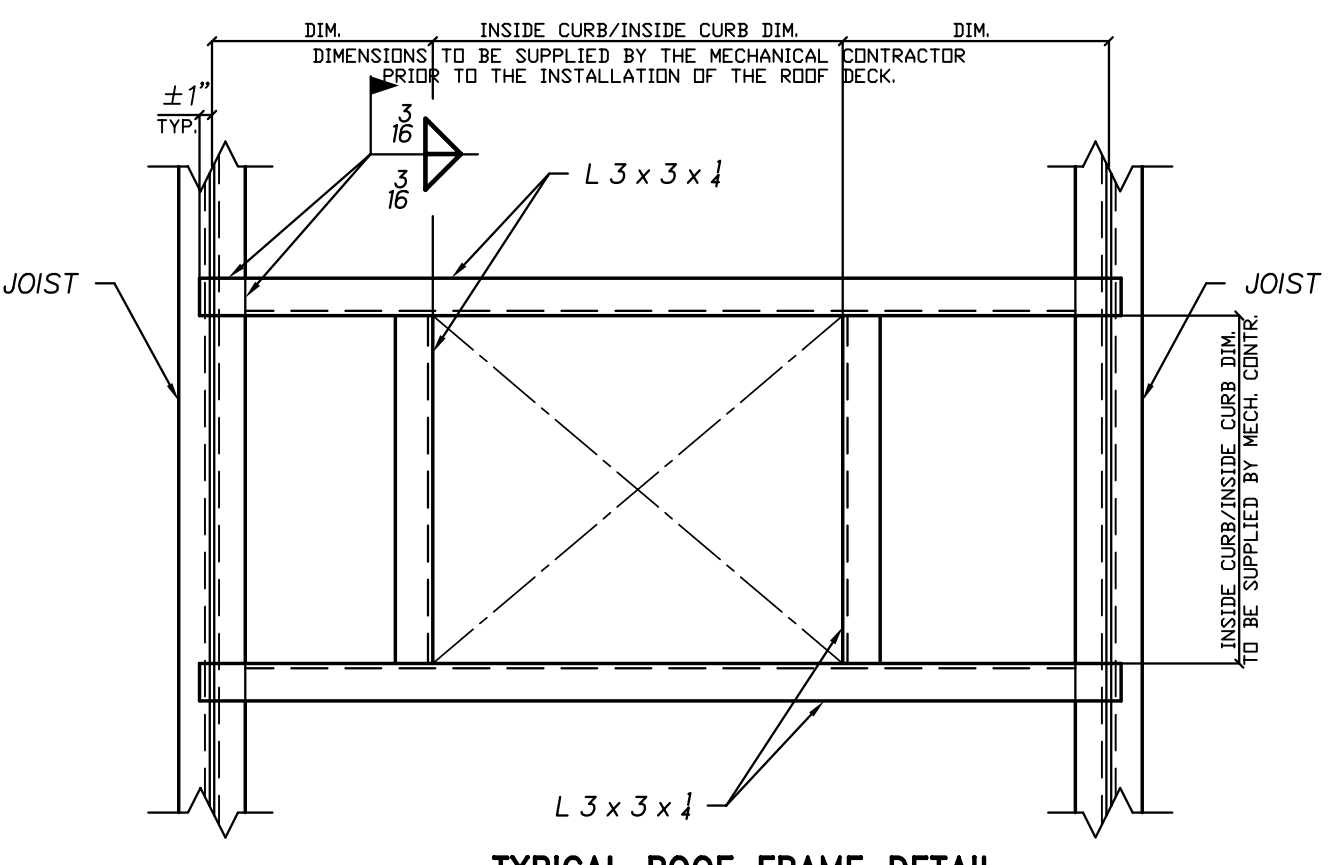


13 TYPICAL ROOF FRAME DETAIL (IF REQUIRED)
NO SCALE


- 9 NOT USED
- 10 NOT USED
- 11 NOT USED

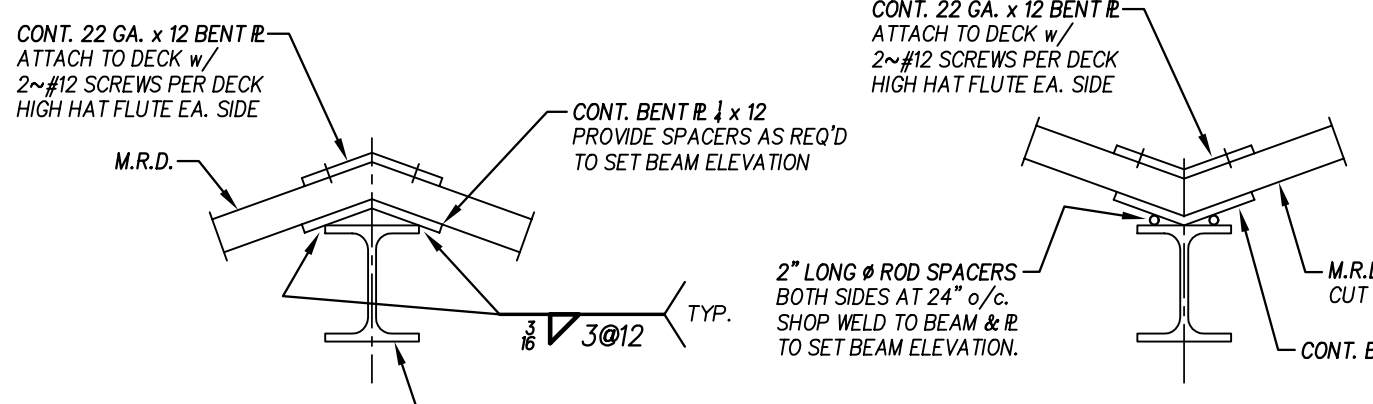


9 8" DEEP CMU LINTEL
NO SCALE

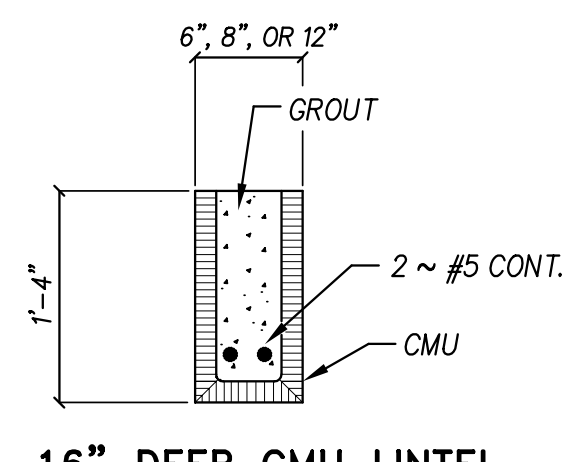


10 16" DEEP CMU LINTEL
NO SCALE

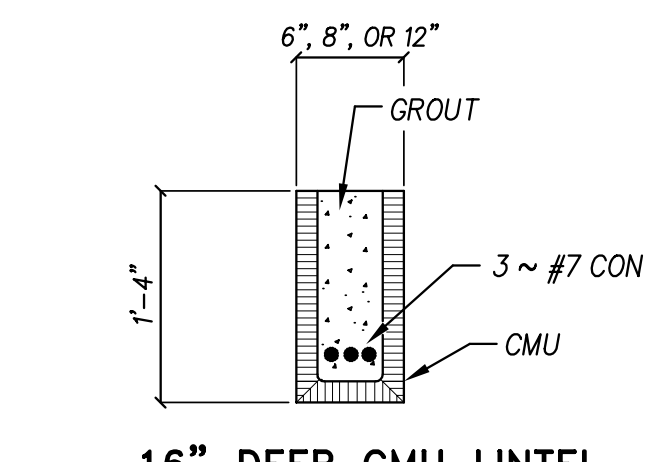

11 16" DEEP CMU LINTEL
NO SCALE

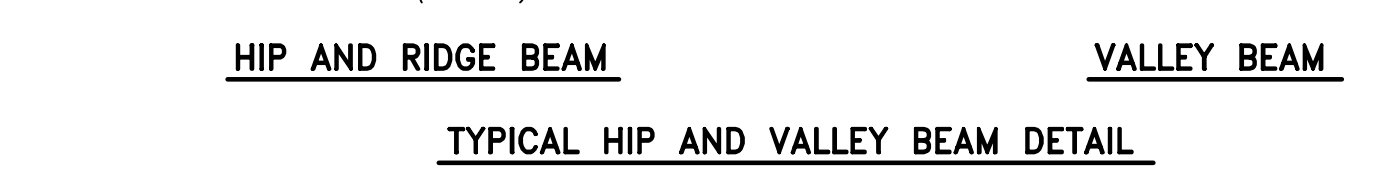

12 TYPICAL HIP AND VALLEY BEAM DETAIL
NO SCALE

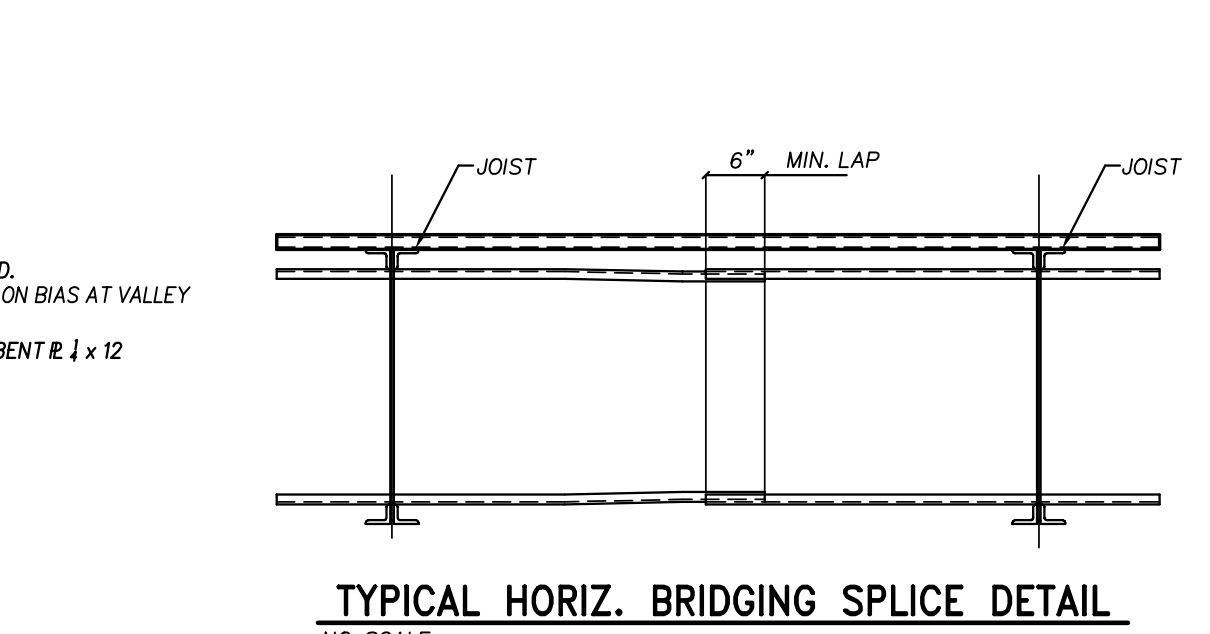

13 TYPICAL HORIZ. BRIDGING SPLICE DETAIL
NO SCALE










Revision	Date

Hite associates
ARCHITECTURE ENGINEERING TECHNOLOGY
2600 Meridian Drive / Greenville, NC 27858 / tel (252) 757-0333

QUEEN ENGINEERING & DESIGN
REGISTERED PROFESSIONAL ENGINEER
STATE OF NORTH CAROLINA
19991
09 OCT 2024

Beaufort PK-3 School
BEAUFORT COUNTY SCHOOLS
Washington / North Carolina / 27889

Project No. 22344
Date: 09 OCT 2024
Drawing no. S 1102


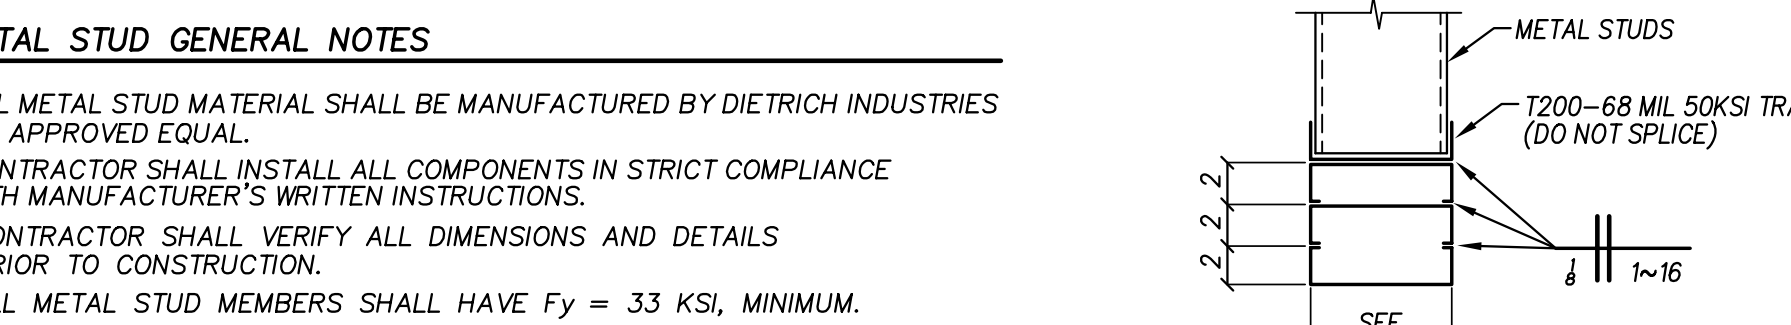
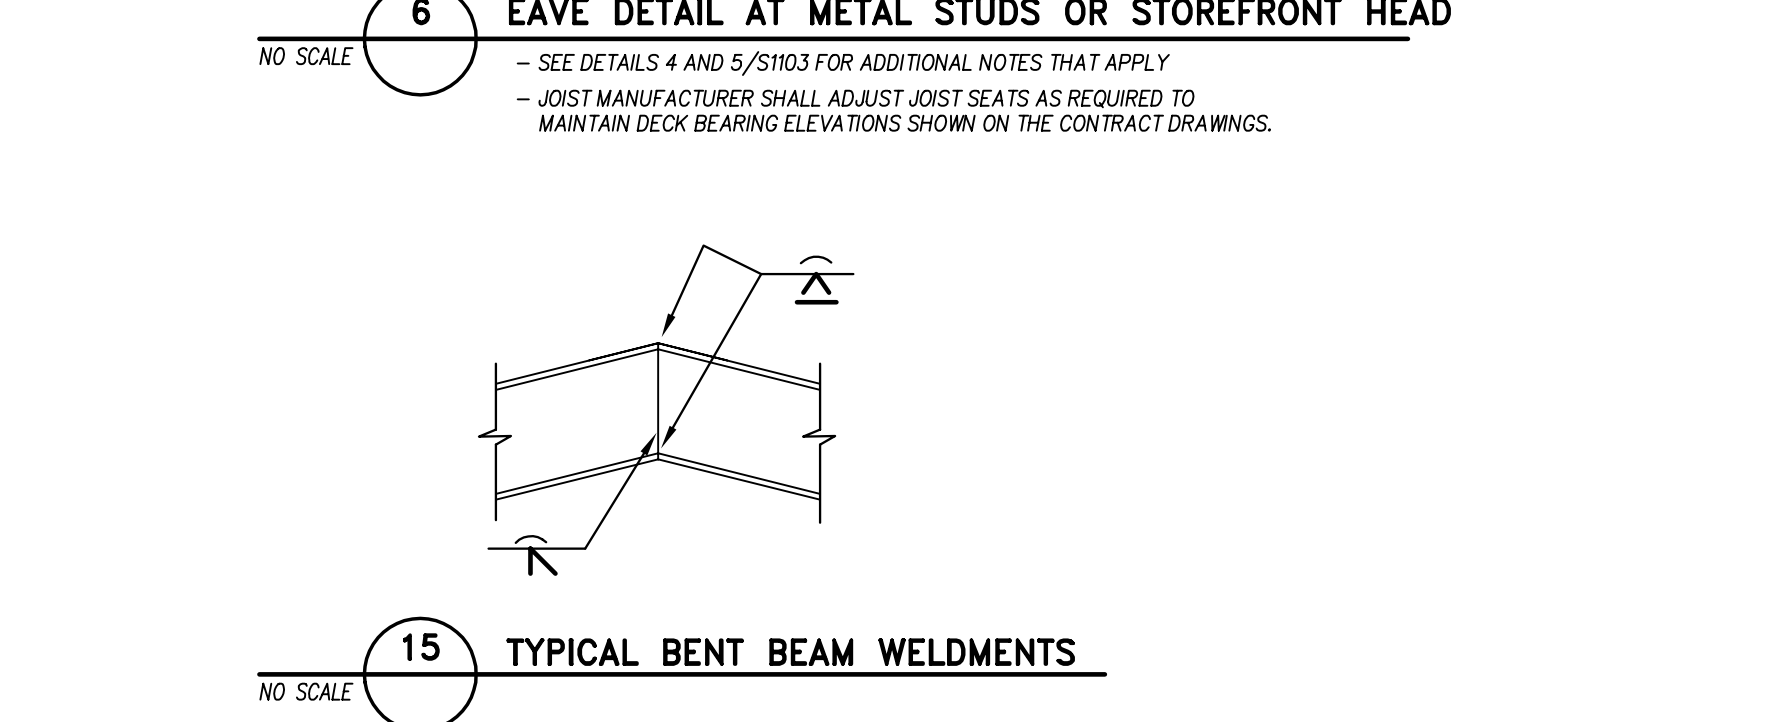
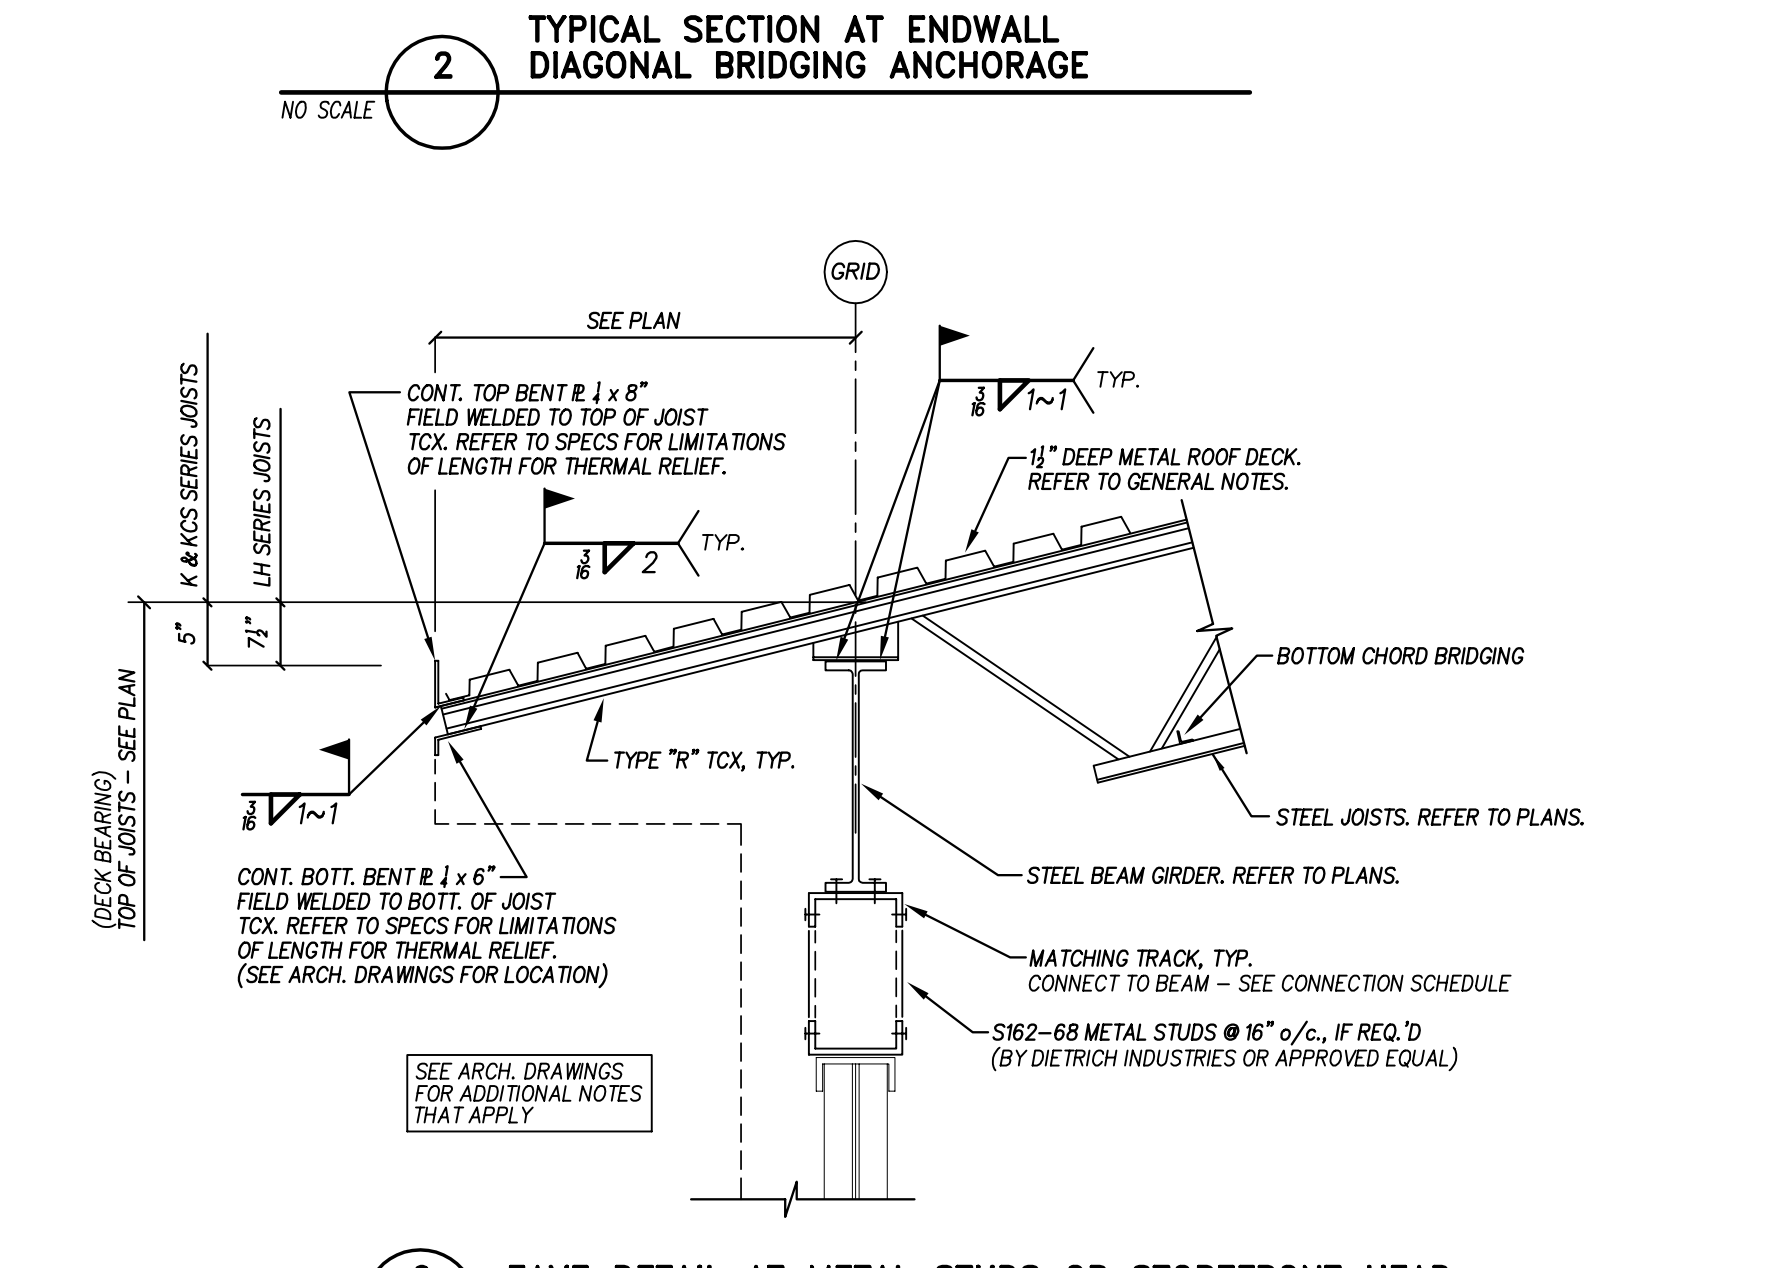
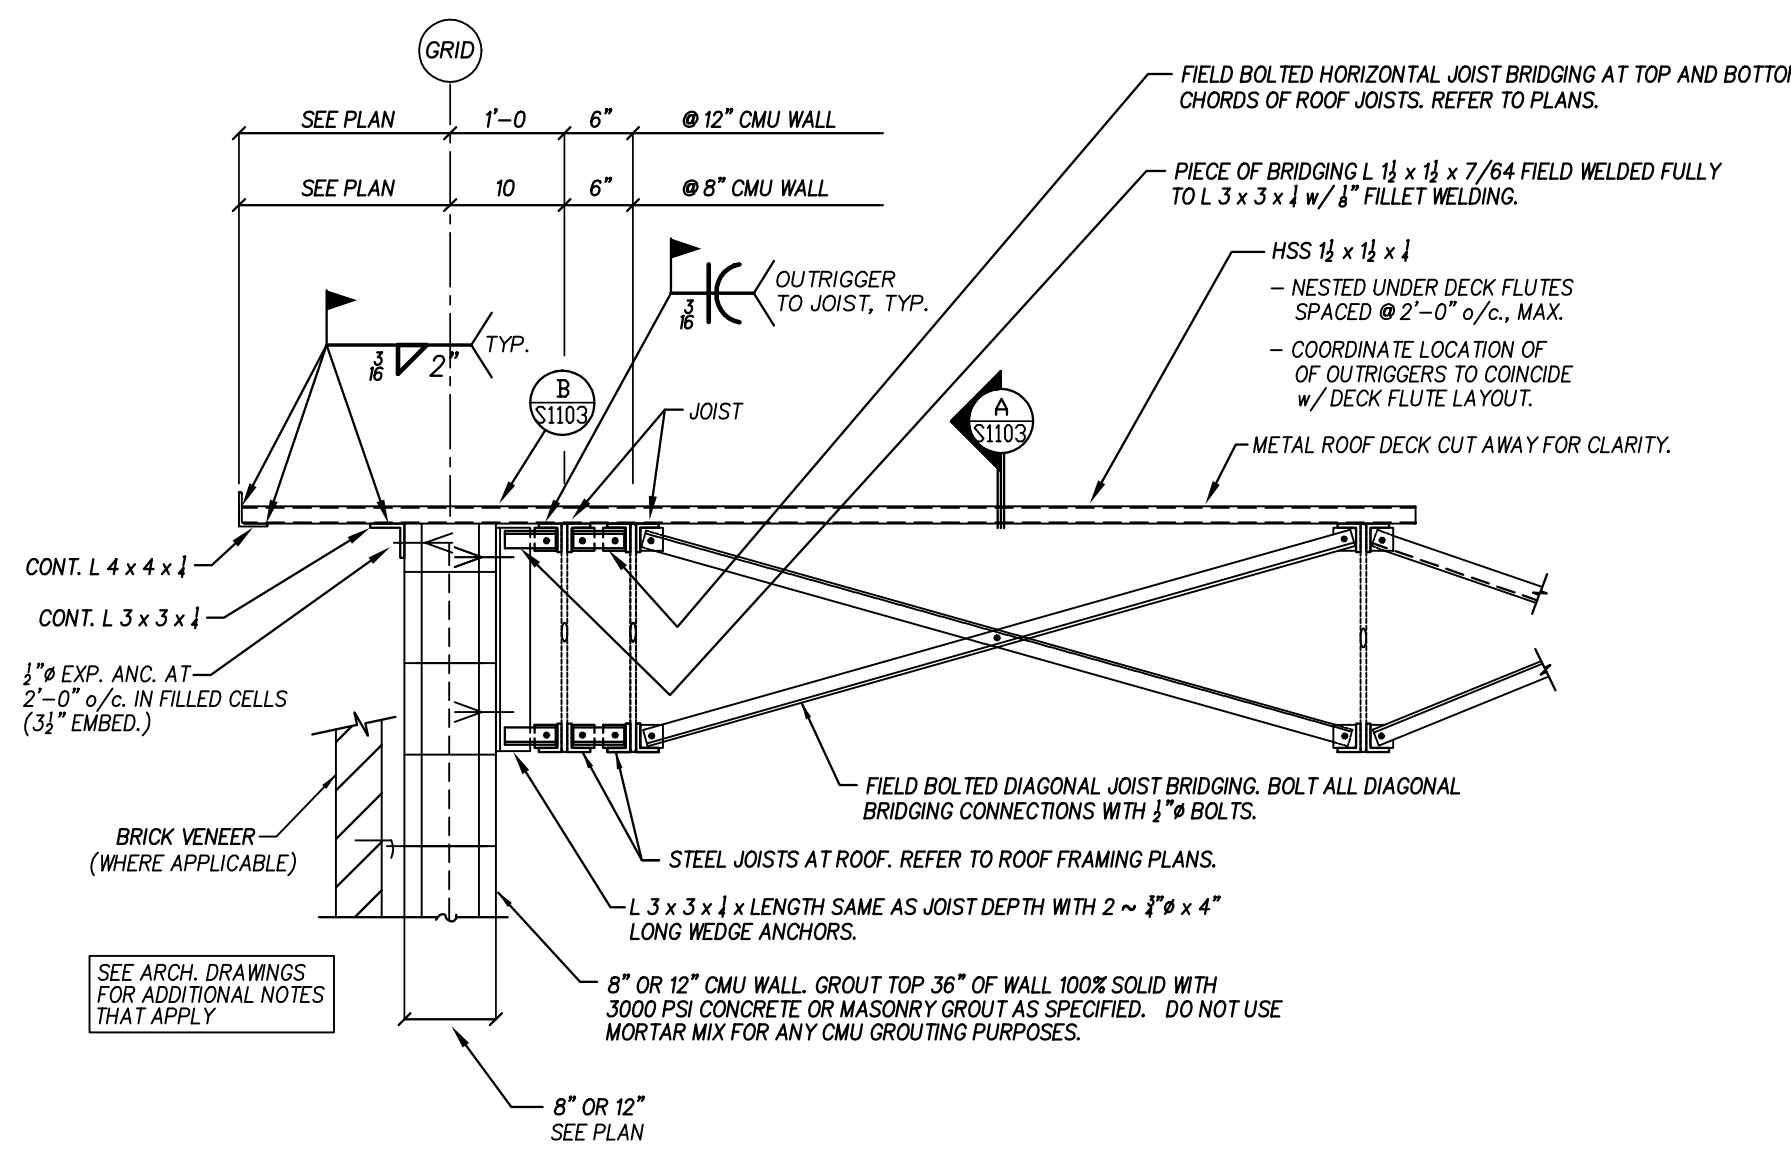
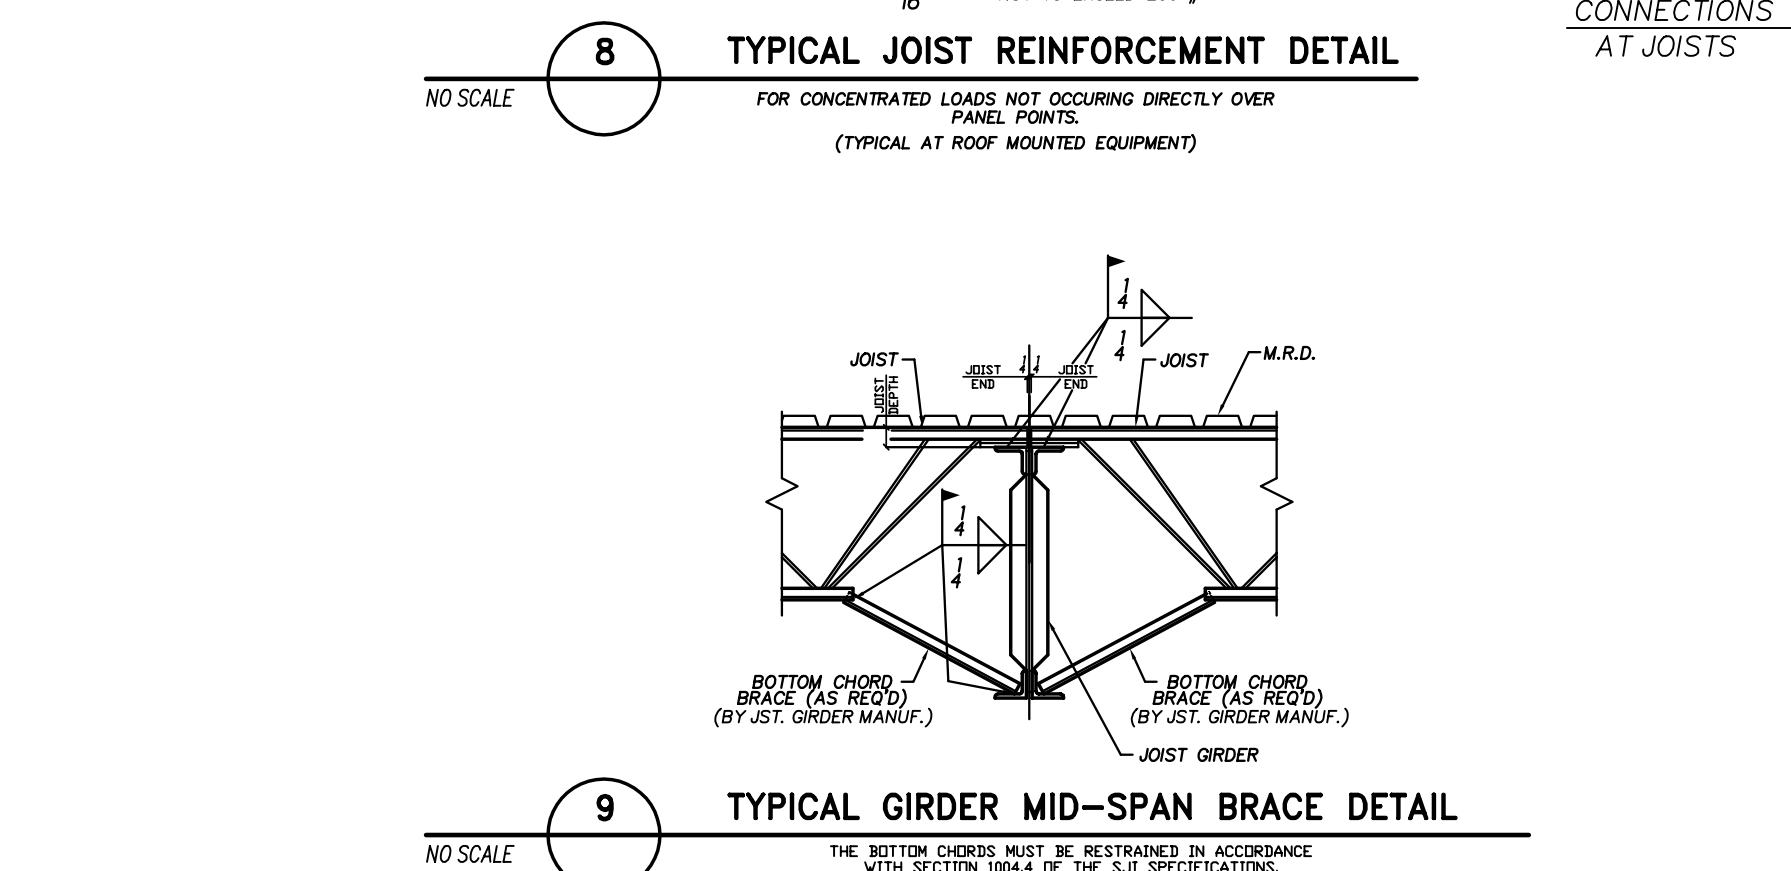
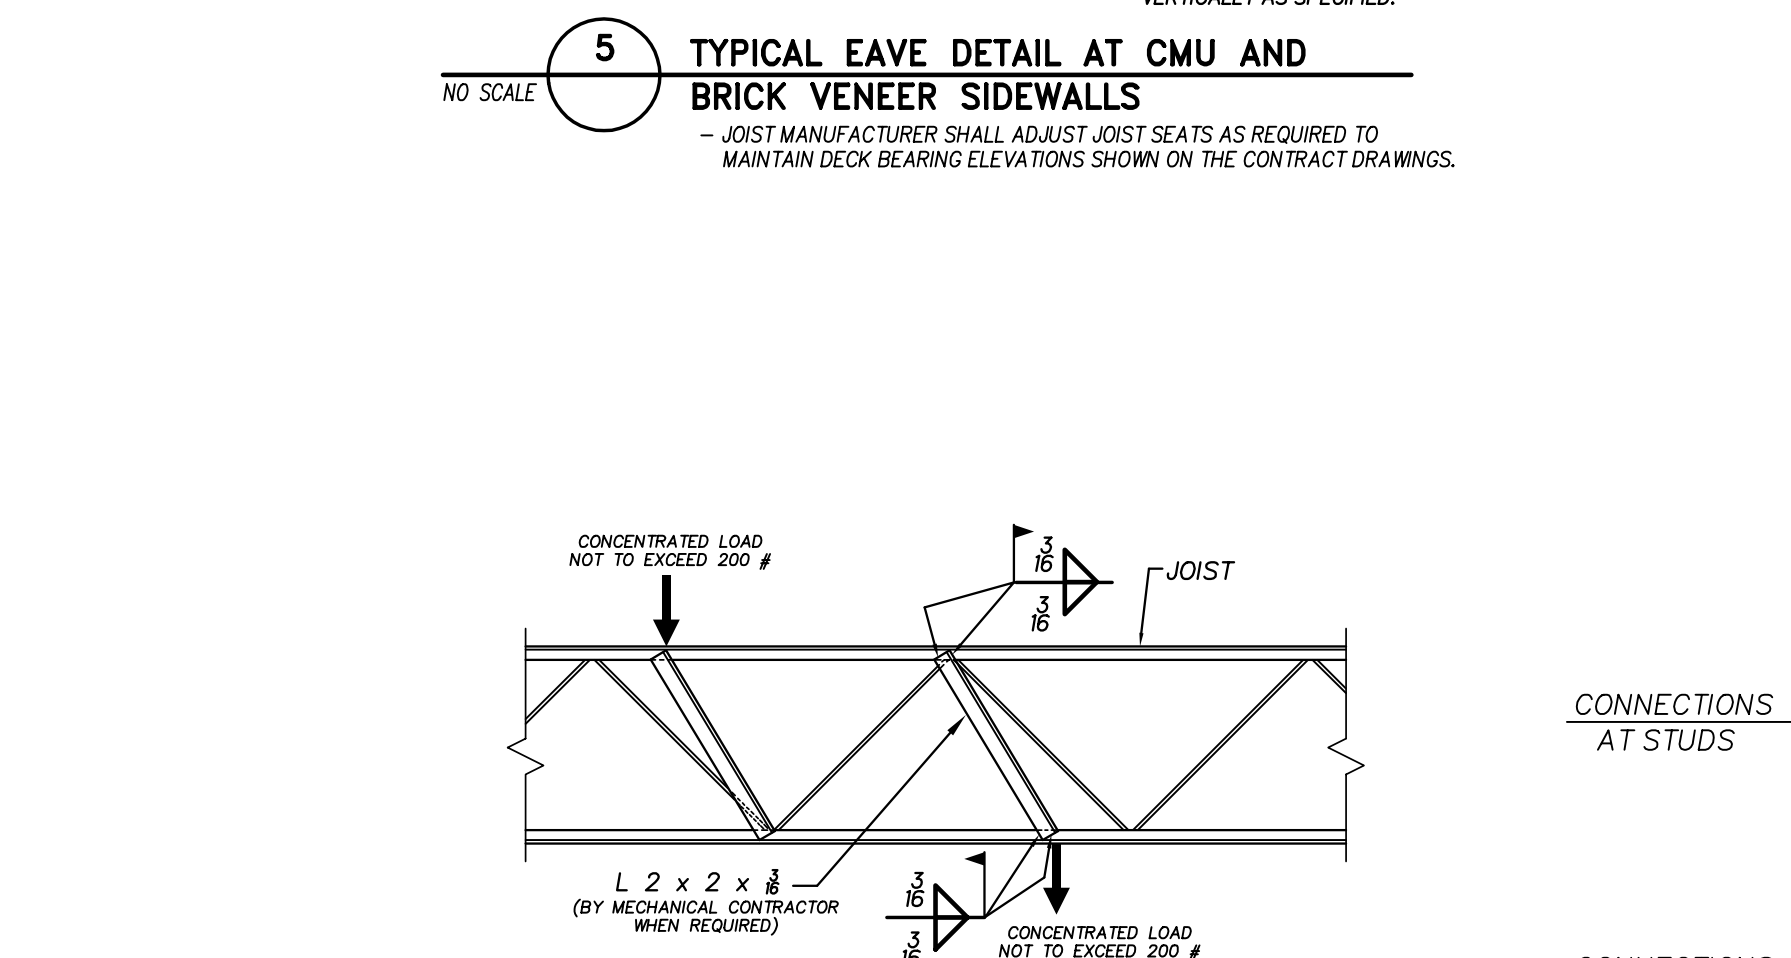
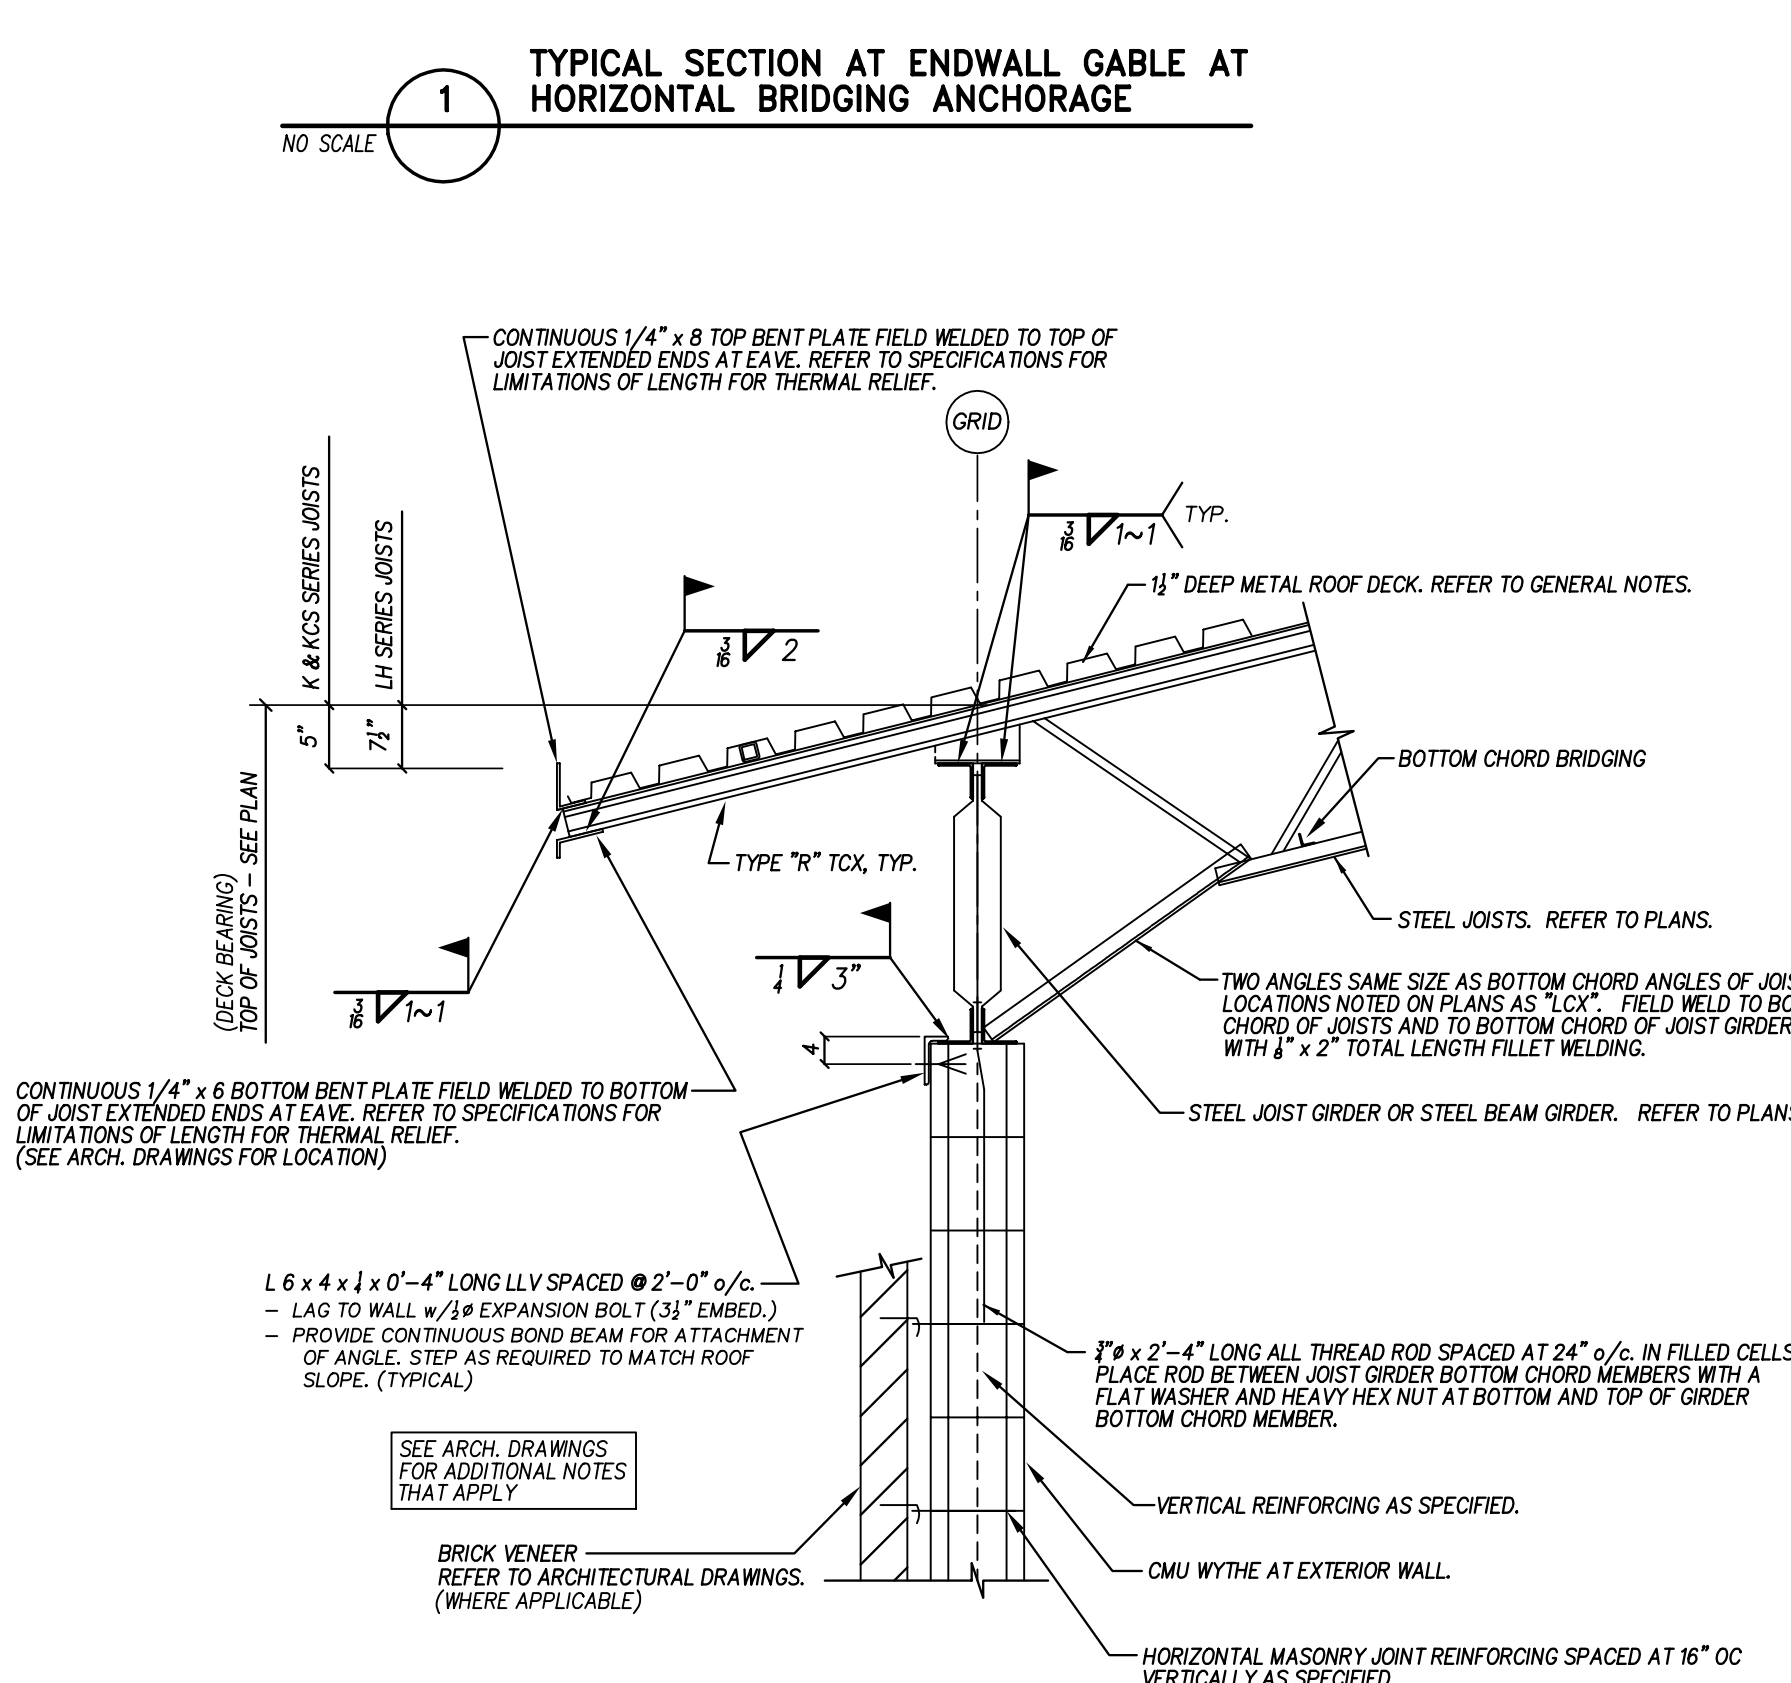
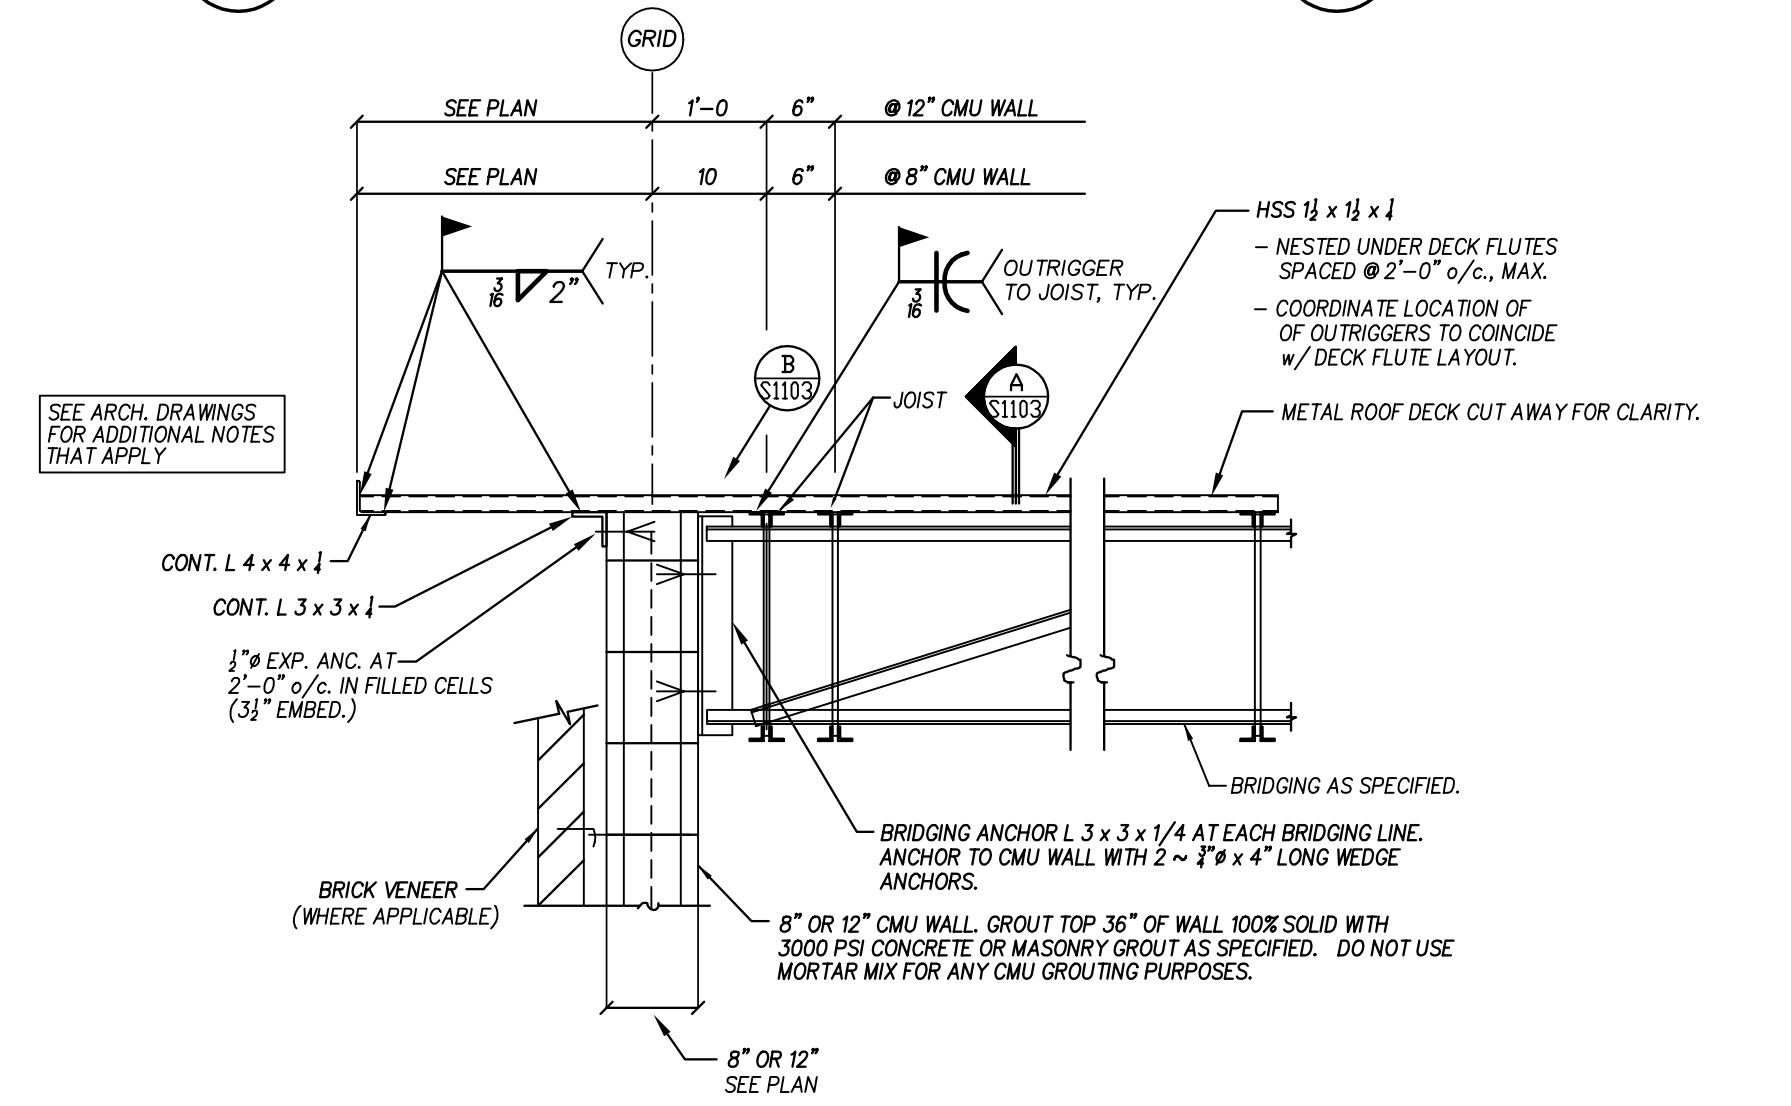
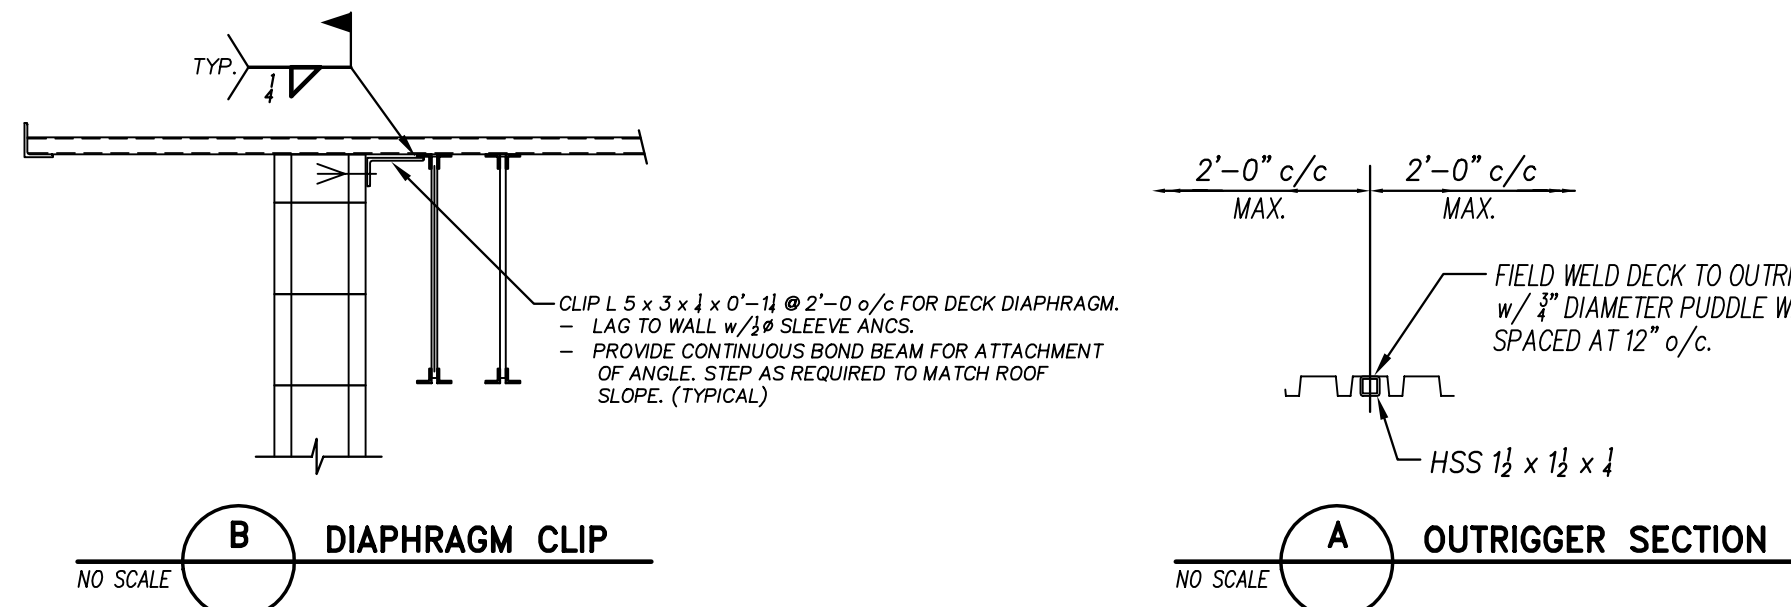


METAL STUD GENERAL NOTES

- ALL METAL STUD MATERIAL SHALL BE MANUFACTURED BY DIETRICH INDUSTRIES OR APPROVED EQUAL.
- CONTRACTOR SHALL INSTALL ALL COMPONENTS IN STRICT COMPLIANCE WITH MANUFACTURER'S WRITTEN INSTRUCTIONS.
- CONTRACTOR SHALL VERIFY ALL DIMENSIONS AND DETAILS PRIOR TO CONSTRUCTION.
- ALL METAL STUD MEMBERS SHALL HAVE $F_y = 33$ KSI, MINIMUM.

NOTE: ALL METAL STUDS AND METAL SYSTEM TO BE MANUFACTURED BY DIETRICH INDUSTRIES OR EQUAL

CONNECTION TYPE	COMMENTS
BOTTOM TRACK TO FLOOR	2~ POWDER DRIVEN FASTENERS @ 24" o/c
STUD TO BOTTOM TRACK	ONE SCREW IN EA. FLANGE, U.O.N.
STUD TO TOP TRACK	ONE SCREW IN EA. FLANGE, U.O.N.
PLYWOOD TO STUDS	SCREW @ 6" o/c ALONG EA. STUD
TOP PL. TO TRACK	#10 TEK AT 12" o/c
FC TO STUD	4~#10 TEK
FC TO SLAB	1" EXP. ANCH.
JOIST TO TOP TRACK (BEARING)	(2) SCREWS IN FLANGE
PLYWOOD FLOORING TO JOIST	SCREW @ 12" o/c ALONG EA. JOIST
BRIDGING TO JOISTS	16 GA. CLIP ANGLE w/ 4 SCREWS
BLOCKING TO JOISTS	16 GA. CLIP ANGLE w/ 4 SCREWS
TREAD TO VERTICAL STUD	(4) #10 TEK SCREWS IN WEB
WOOD SHEATHING	8d, 12" o/c AT SUPPORTS, 6" o/c AT EDGES
HEADER TO HEADER	#10 TEK AT 12" o/c, STAGGERED (WEB TO WEB)
HEADER TO CRIPPLE	SA18 GA. w/ 4#8 TEK PER LEG
CRIPPLE TO LOWER TRACK	2~#8 TEK EA. FL.
HEADER TO BEARING STUD	SA 18 GA. w/ 4~#8 TEK PER LEG
BEARING STUD TO CRC BRACE	BRIDGE CLIP
BEARING STUD TO BRIDGE CLIP	4~#10 TEK
BRIDGE CLIP TO CRC	4~#10 TEK
STUD TO WALL	2 SCREWS IN EA. WEB @ 16" o/c
JOIST TO JOIST INTERFACE	ONE SCREW IN EA. FLANGE
PLYWOOD FLOORING TO JOIST	SCREW @ 12" o/c ALONG EA. JOIST
BRIDGING TO JOISTS	16 GA. CLIP ANGLE w/ 4 SCREWS
BLOCKING TO JOISTS	16 GA. CLIP ANGLE w/ 4 SCREWS

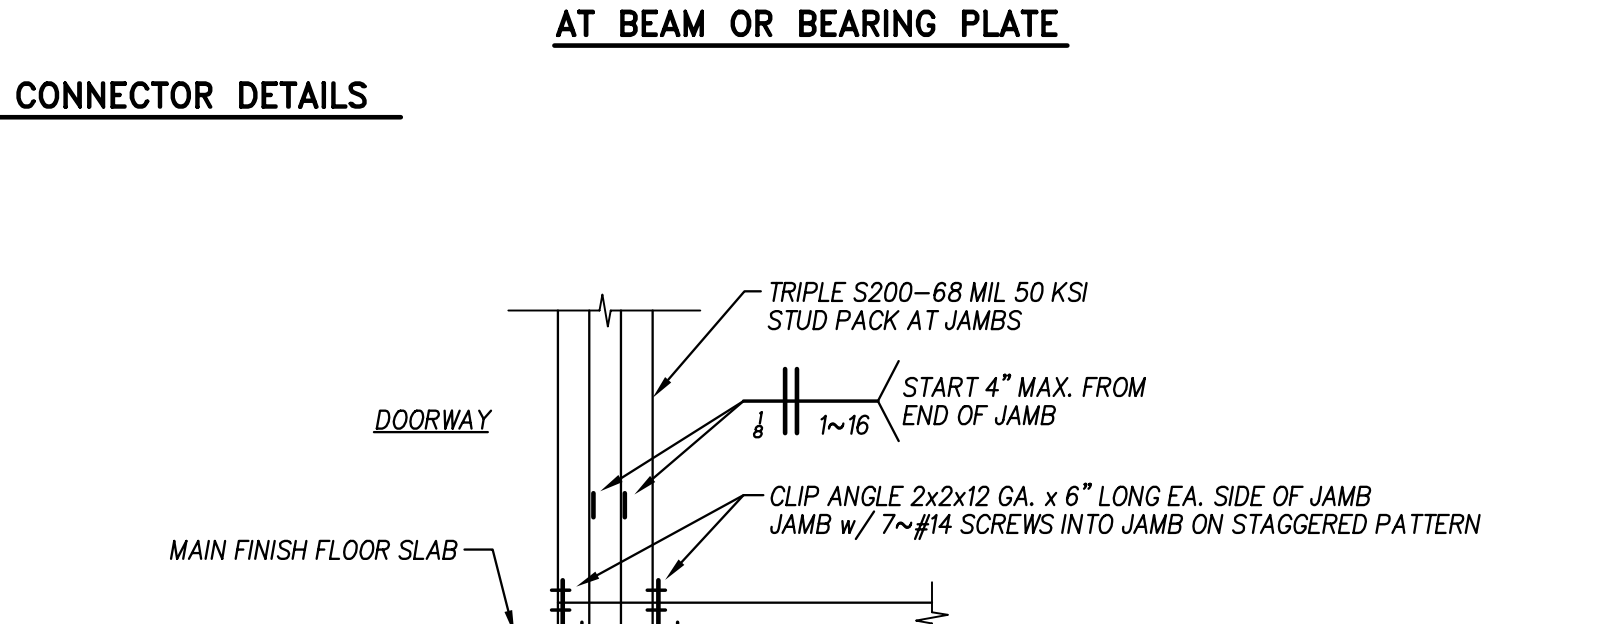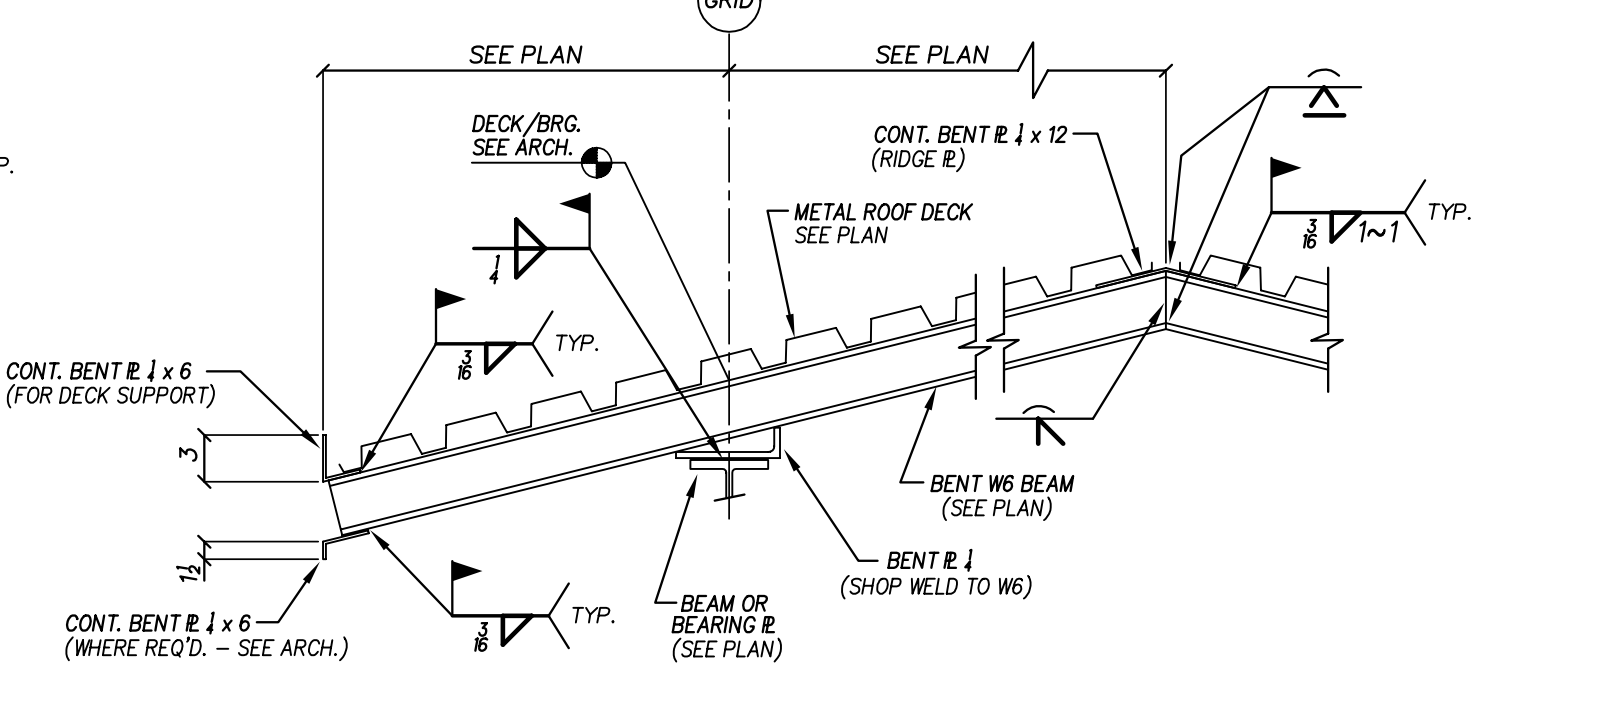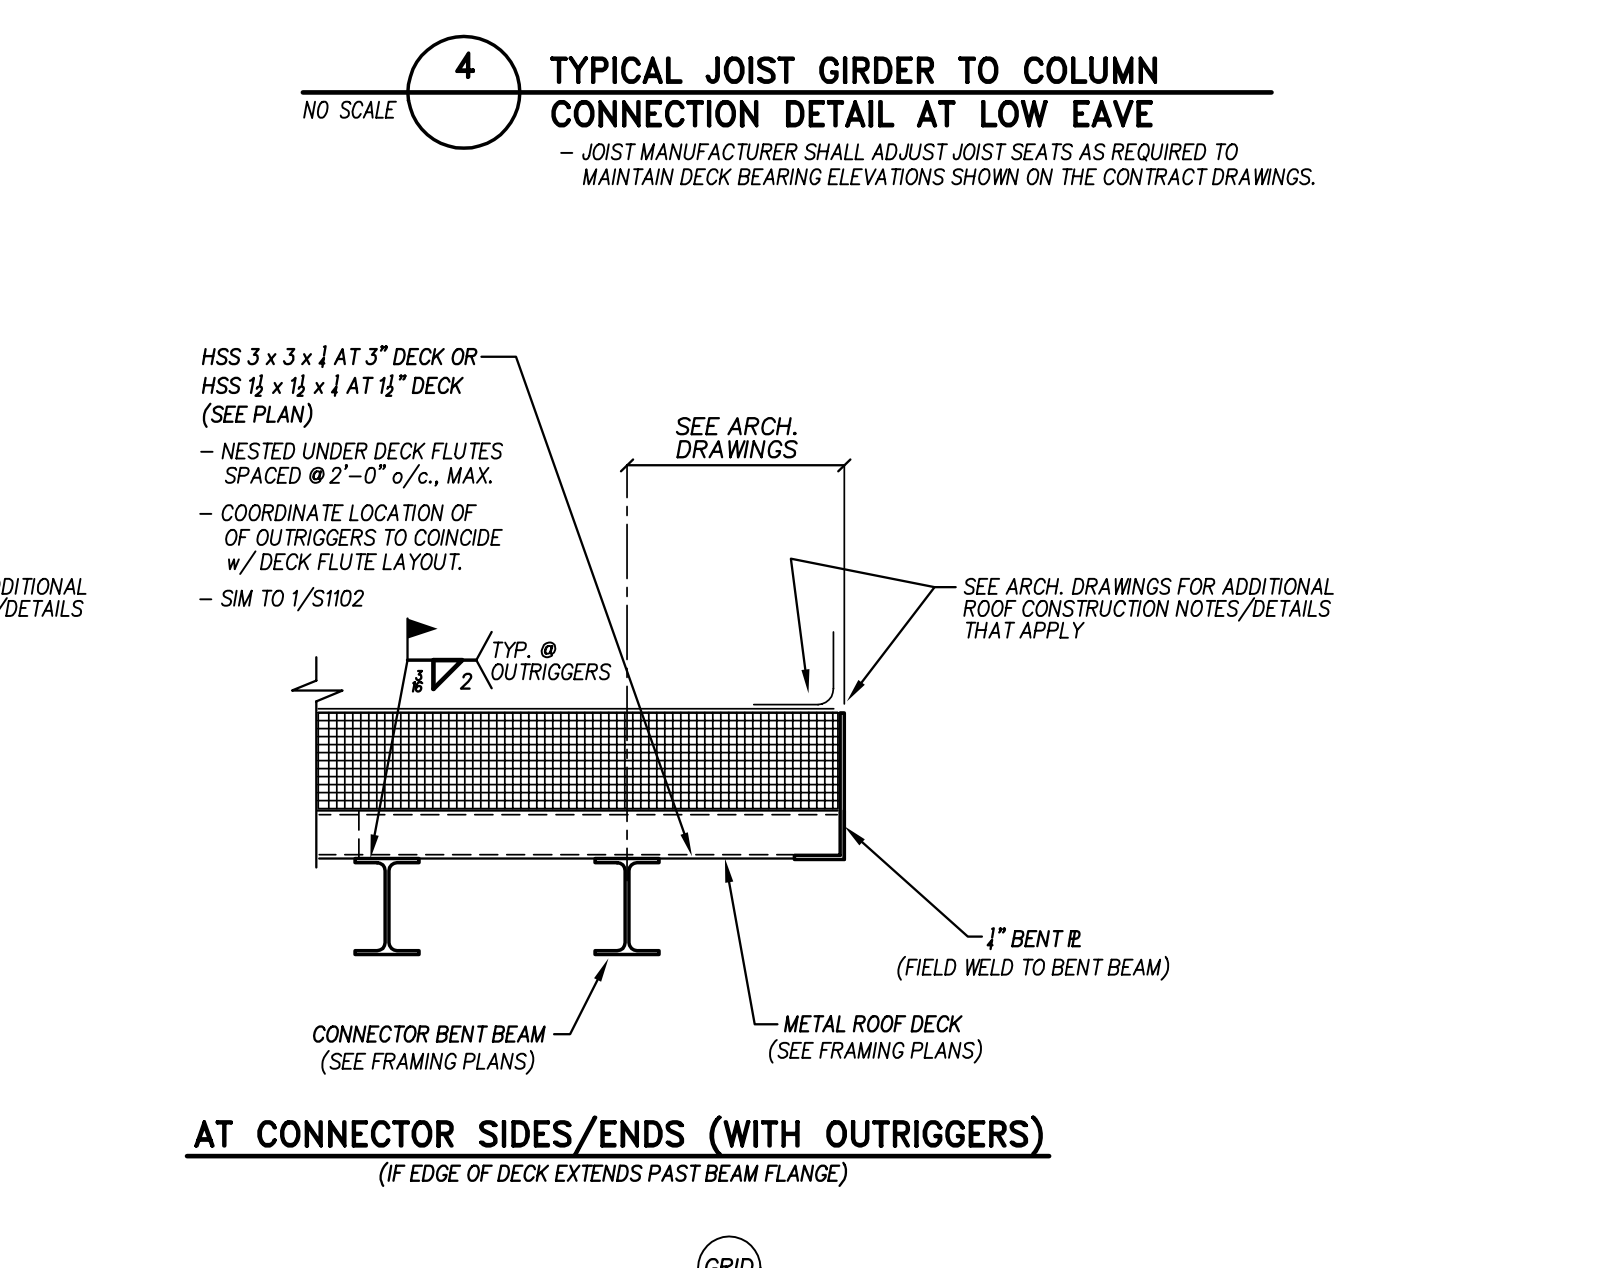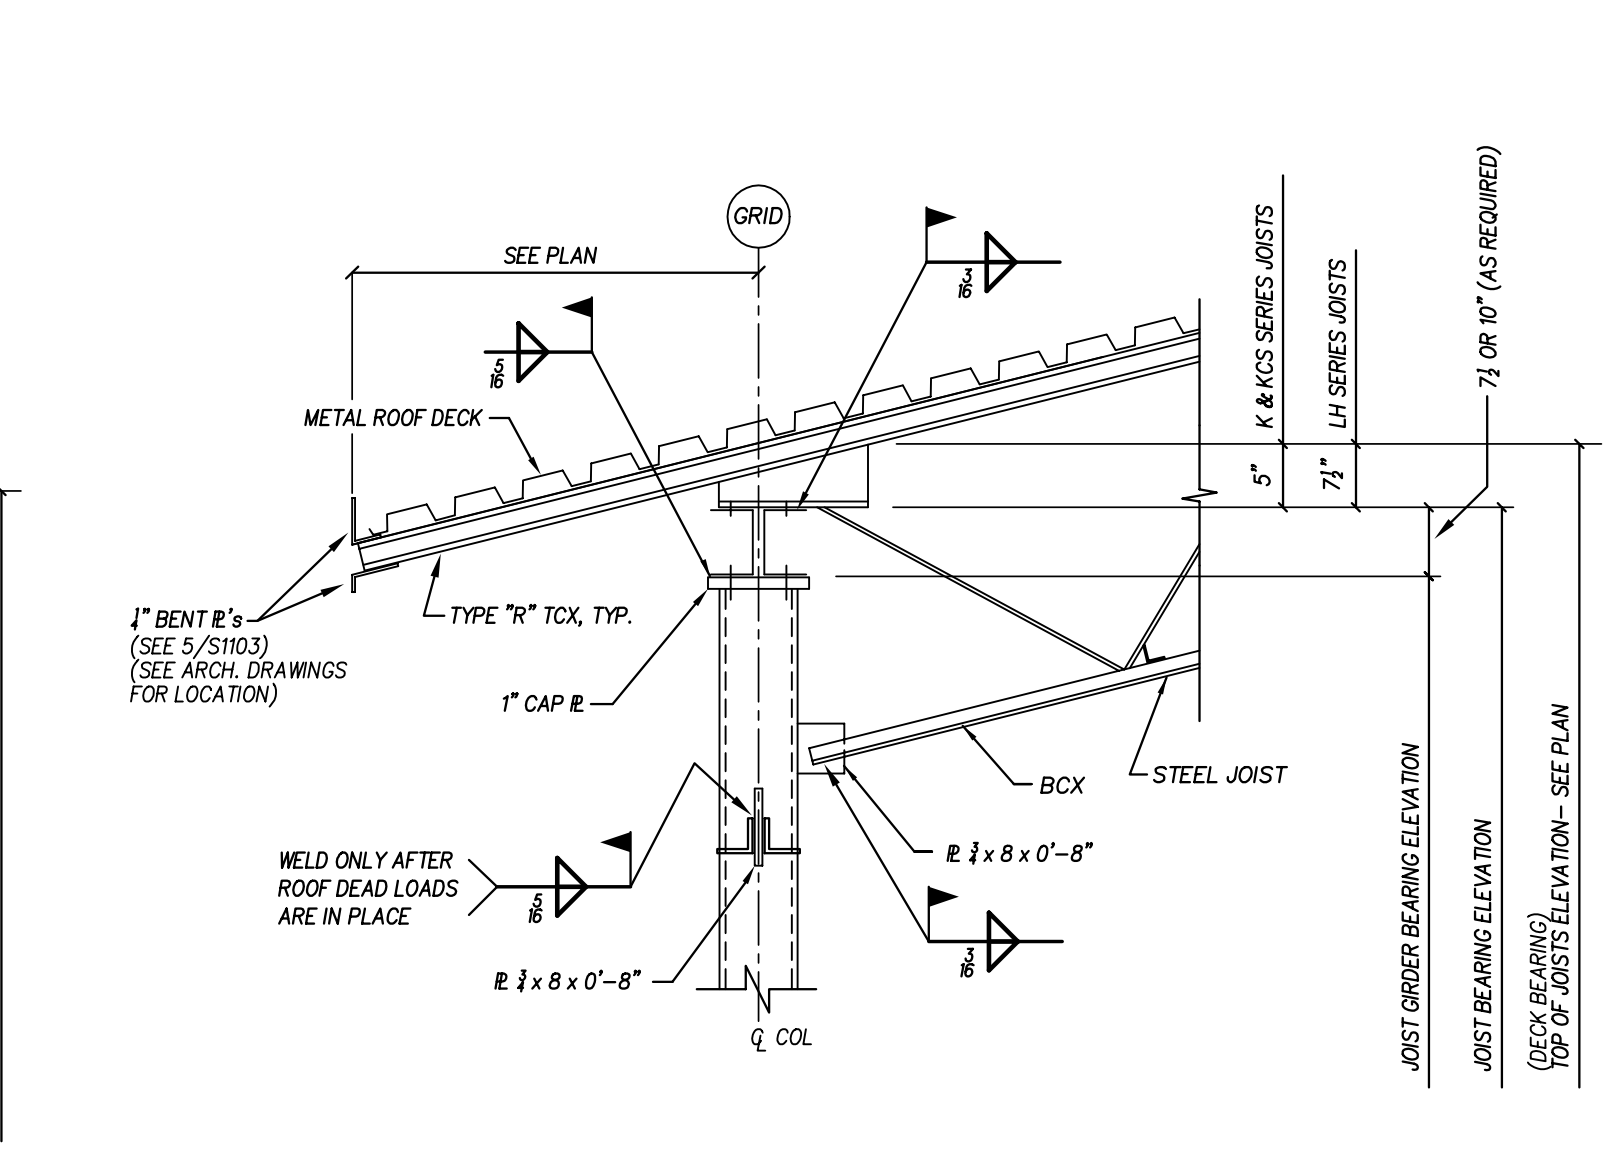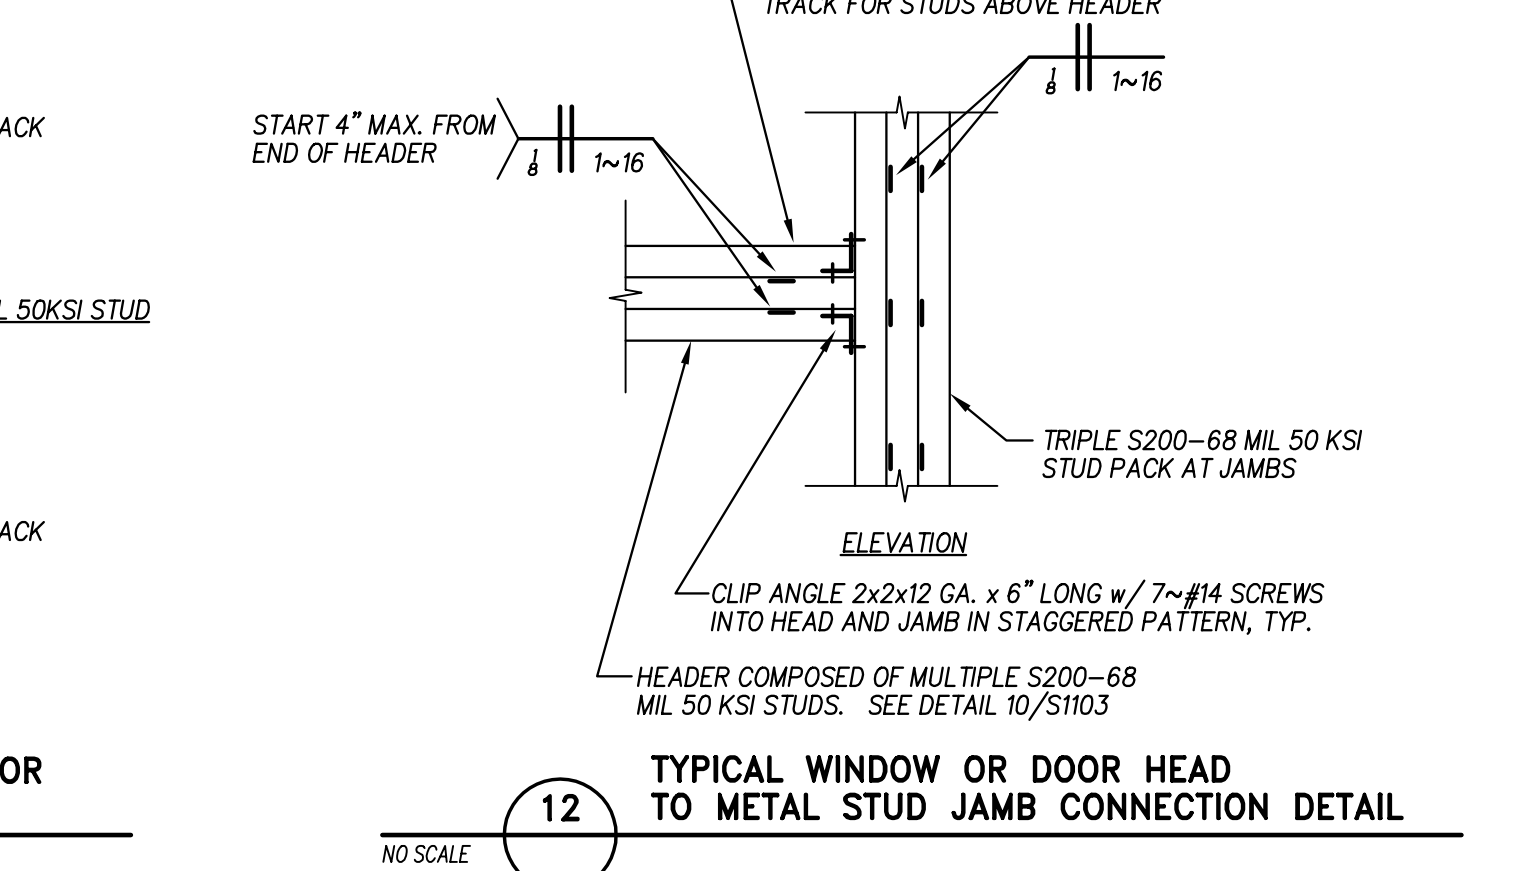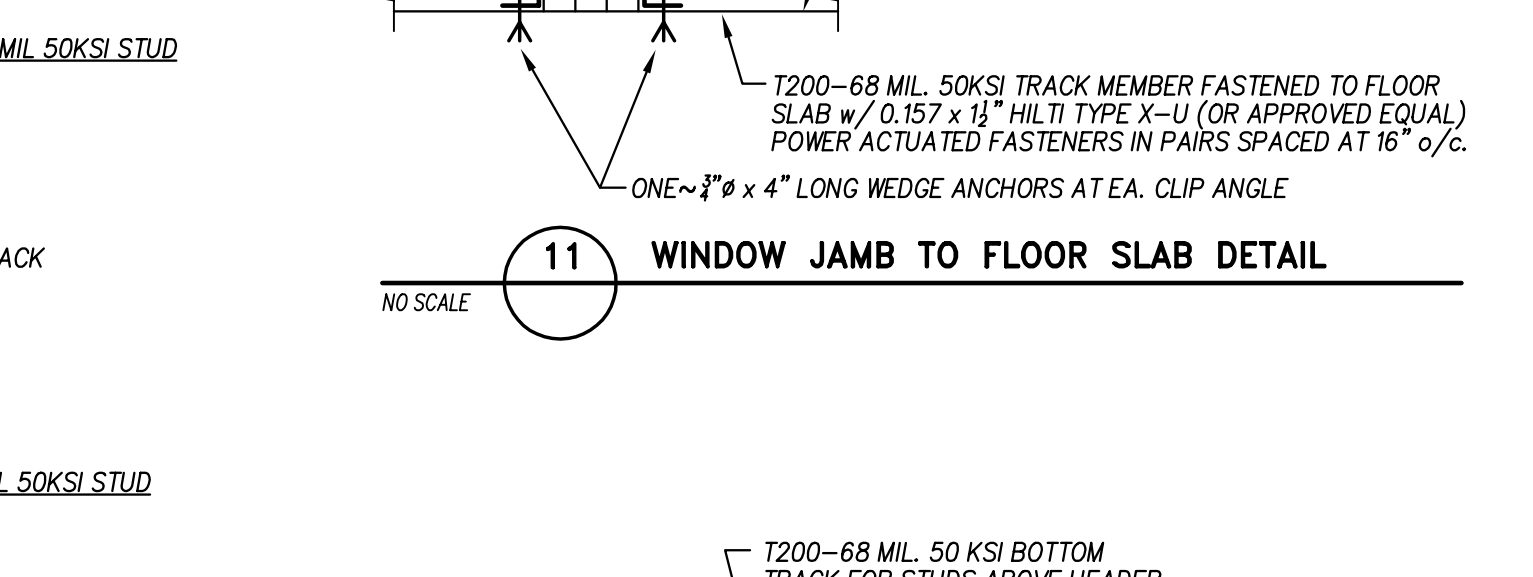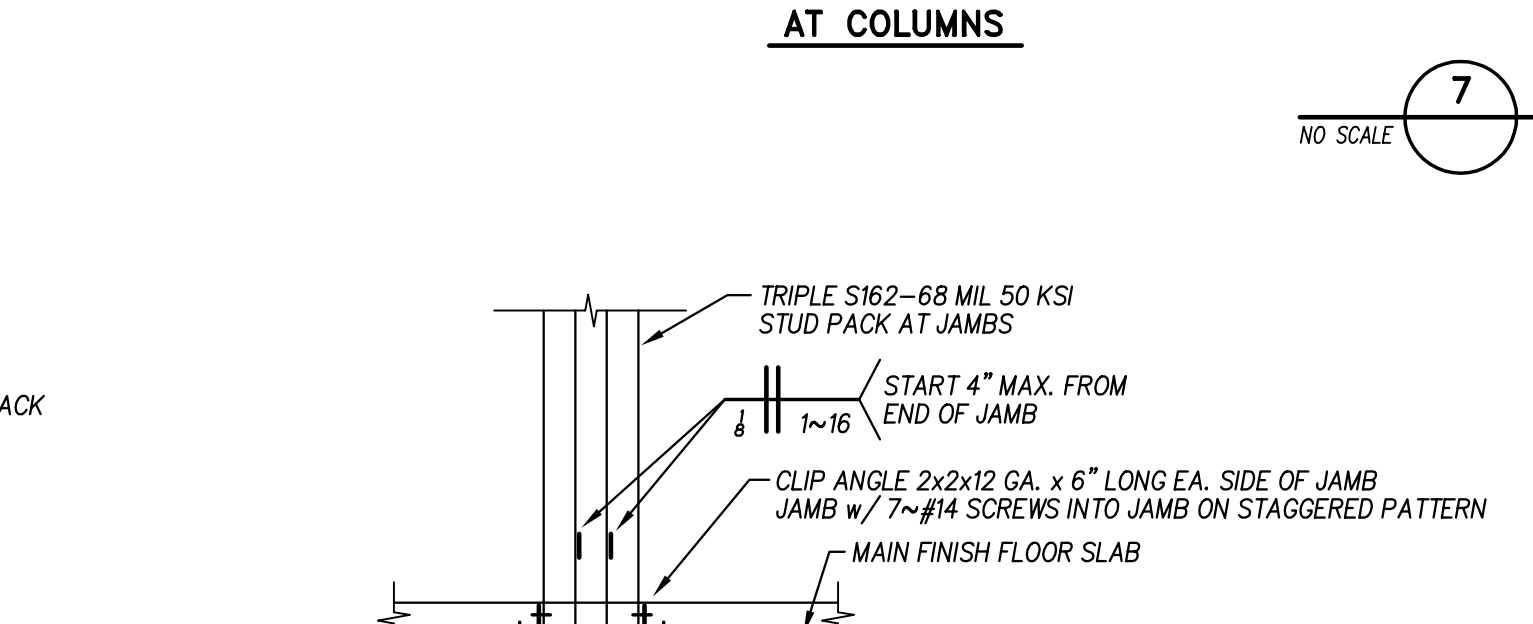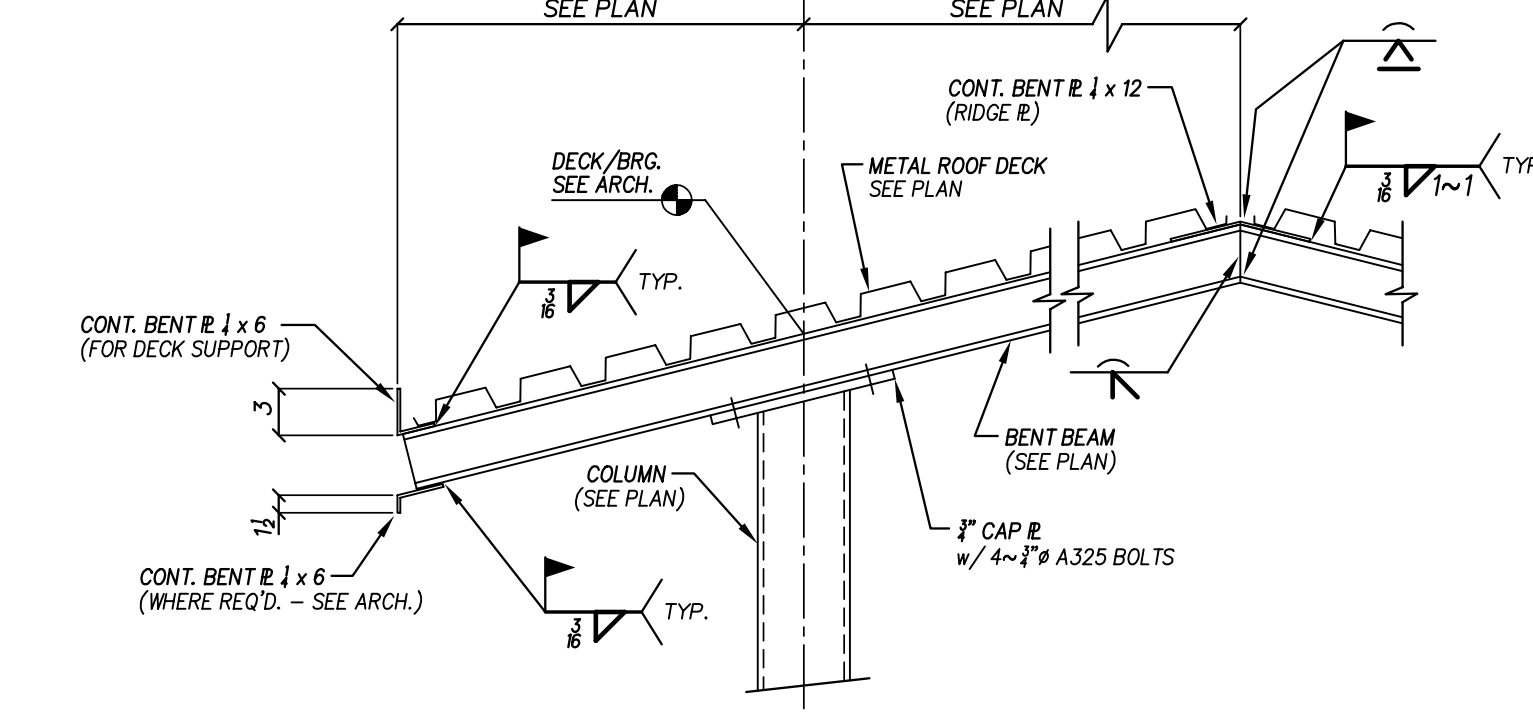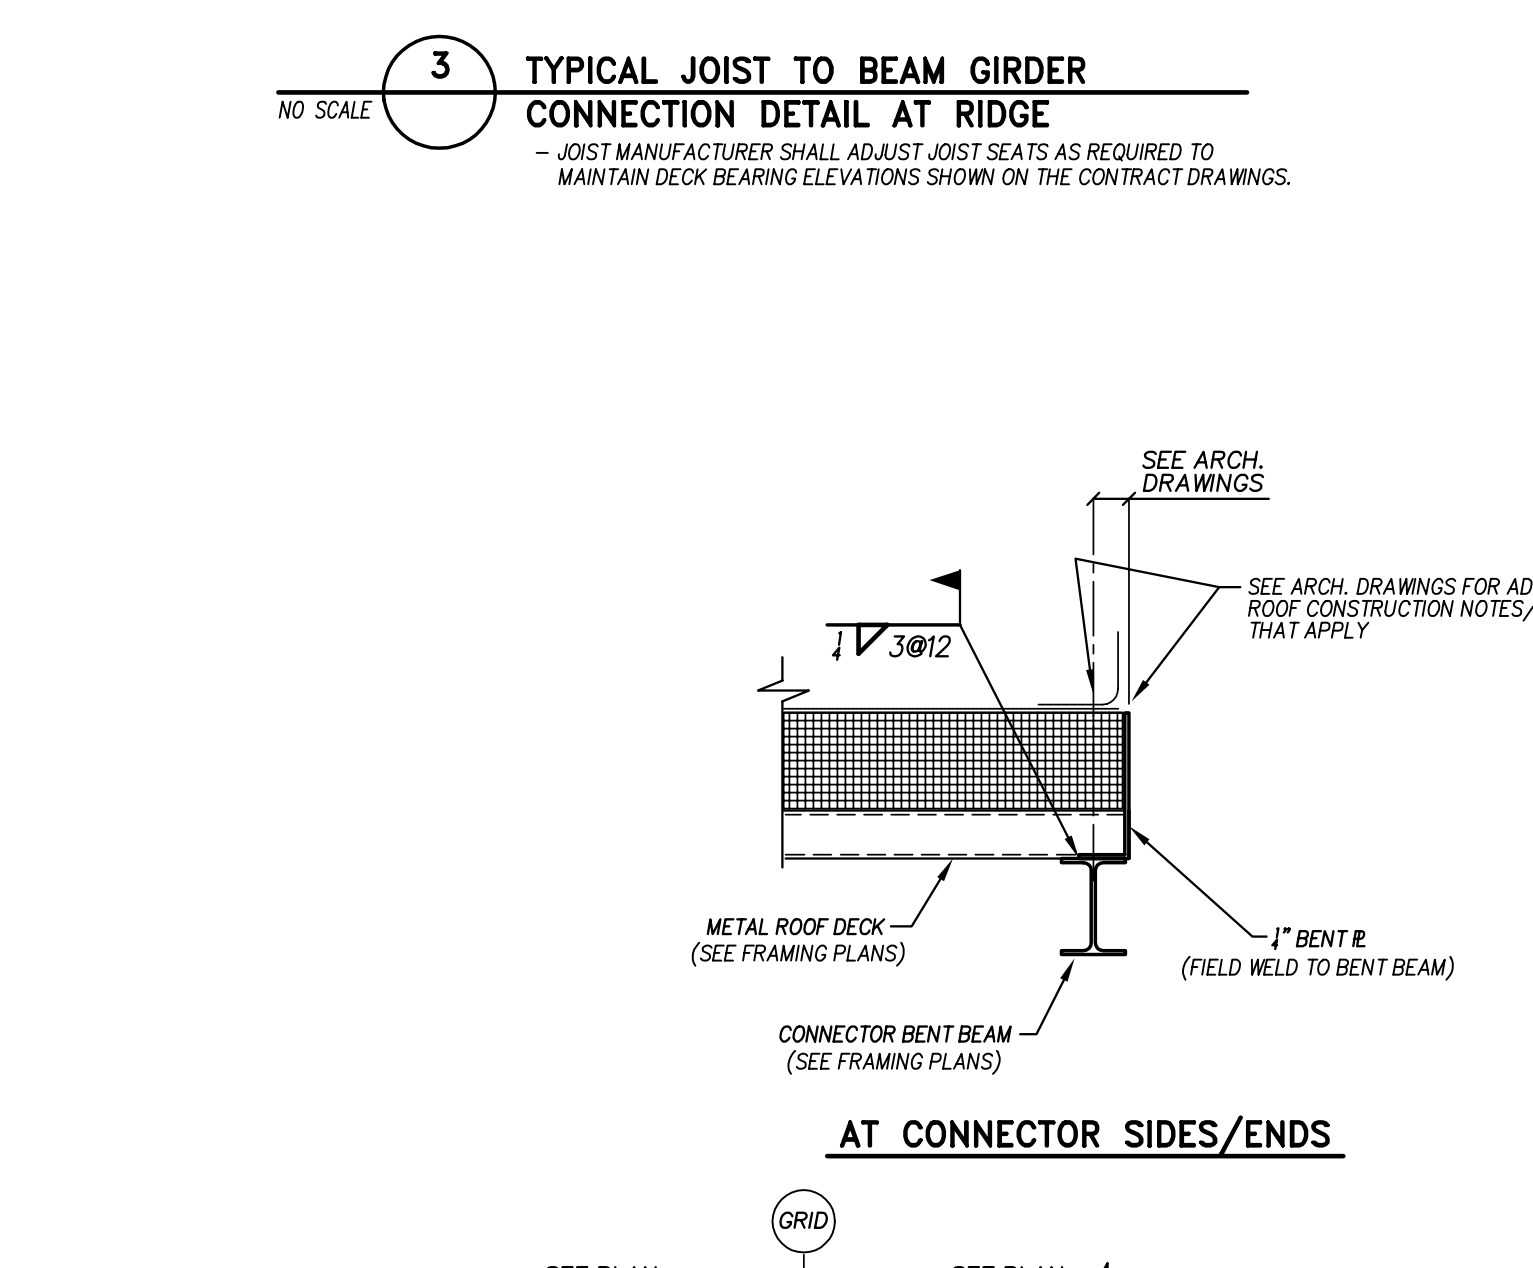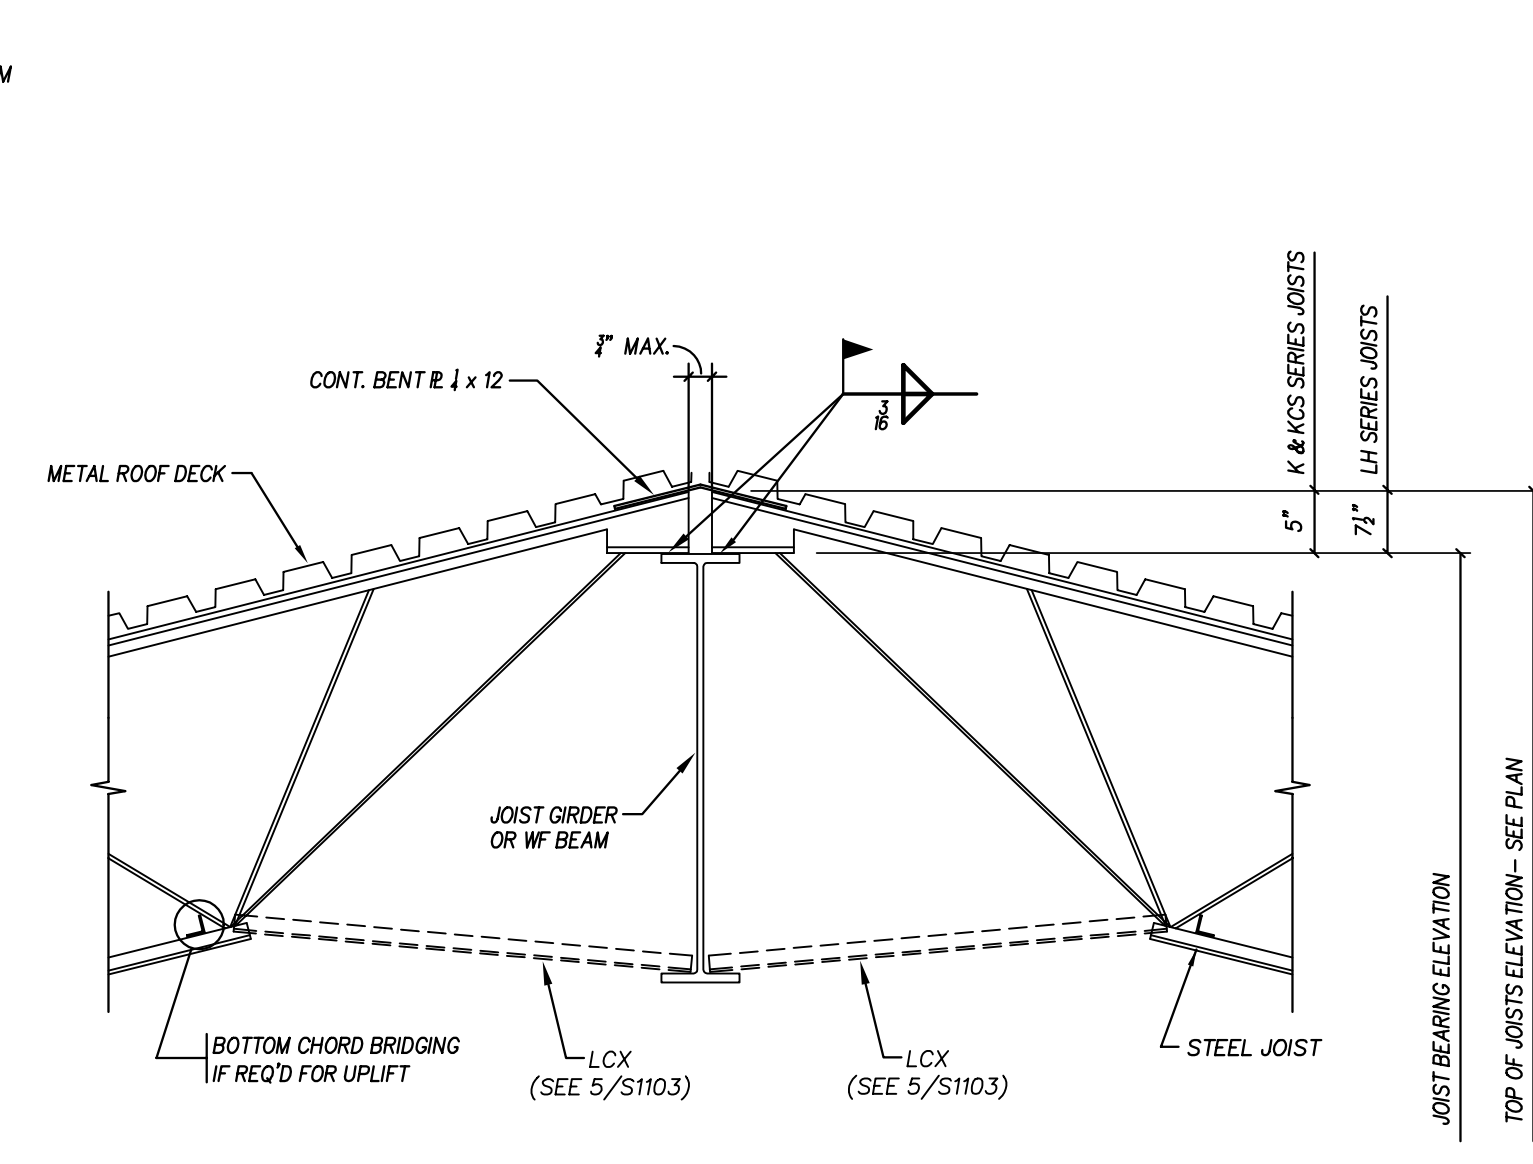


Hite associates
ARCHITECTURE/ENGINEERING/TECHNOLOGY
2600 Meridian Drive / Greenville, NC 27858 / tel (252) 757-0333


Project No: 22344
Date: 09 OCT 2024
Drawing No: S 1103

Beaufort PK-3 School
BEAUFORT COUNTY SCHOOLS
Washington / North Carolina / 27889


Revision
No. Date

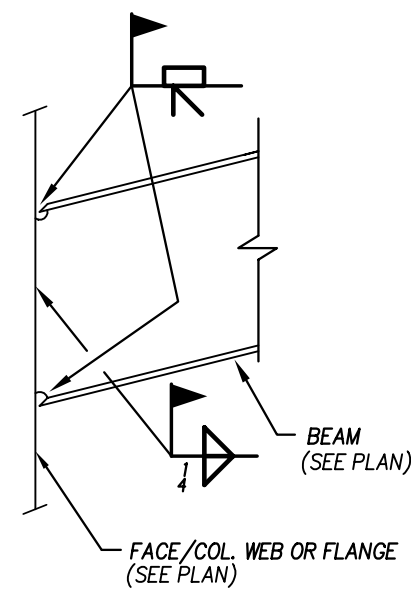


BEAM TO COLUMN

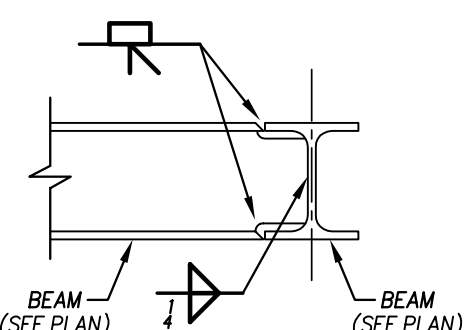


BEAM TO BEAM

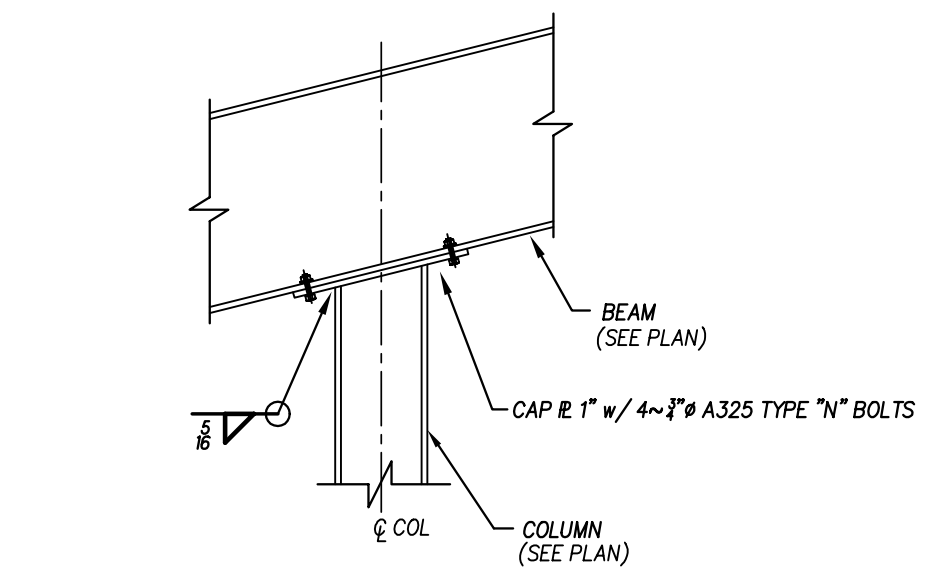


TYPICAL BEAM OVER COLUMN CONNECTION

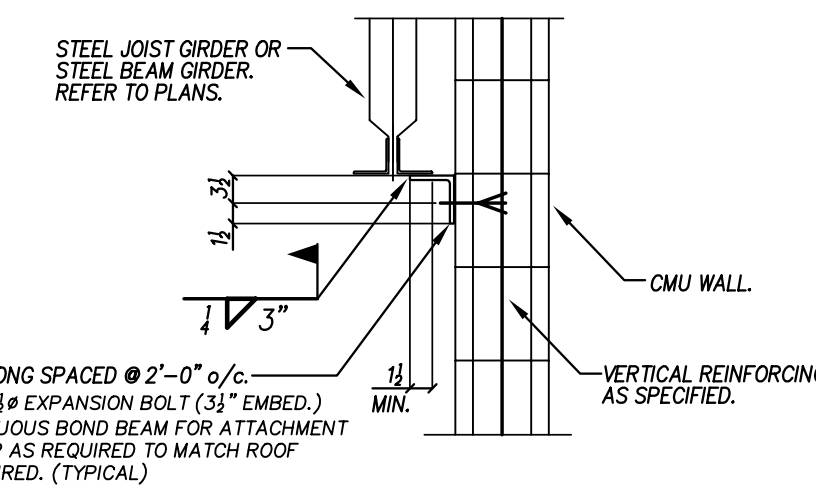


CMU WALL TIE DETAIL

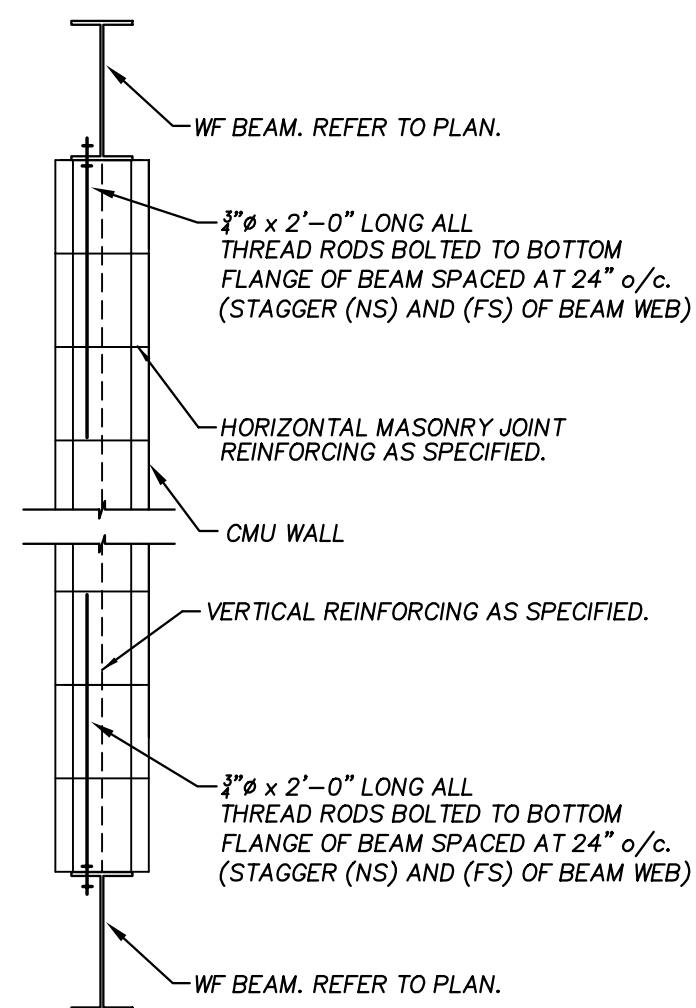


BEAM TO CMU WALL CONNECTION

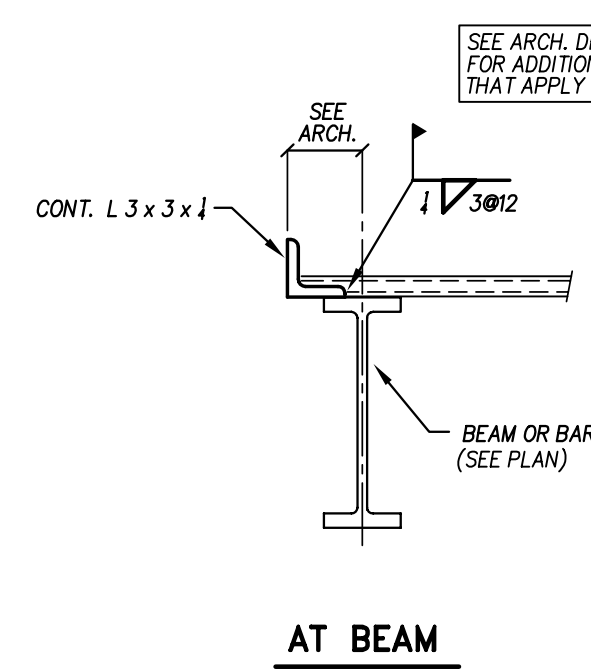


AT BEAM

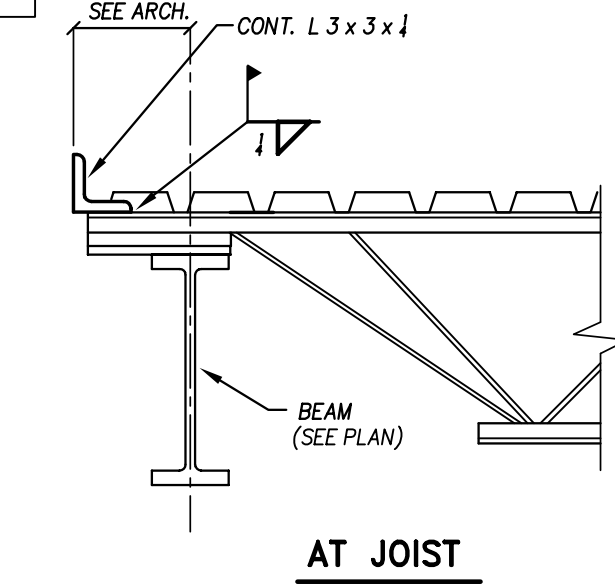


AT JOIST

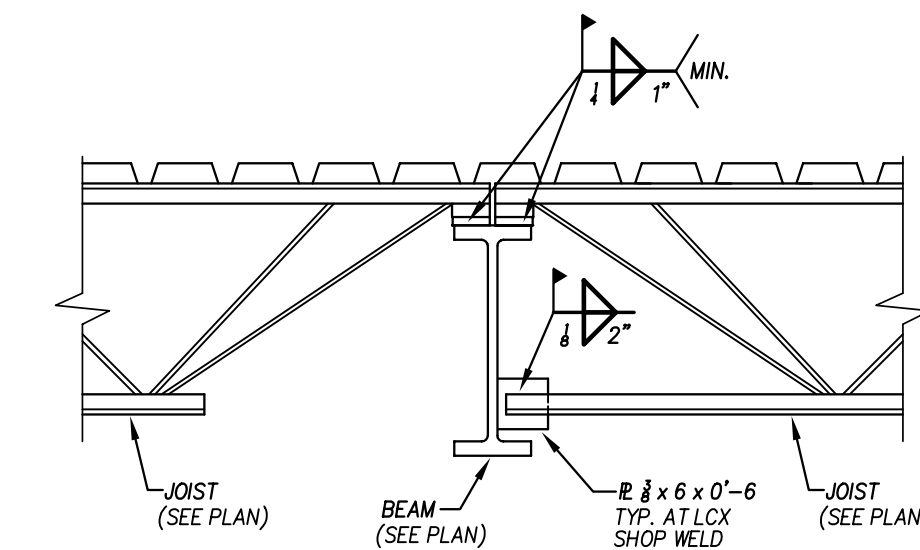


TYPICAL JOIST WELD

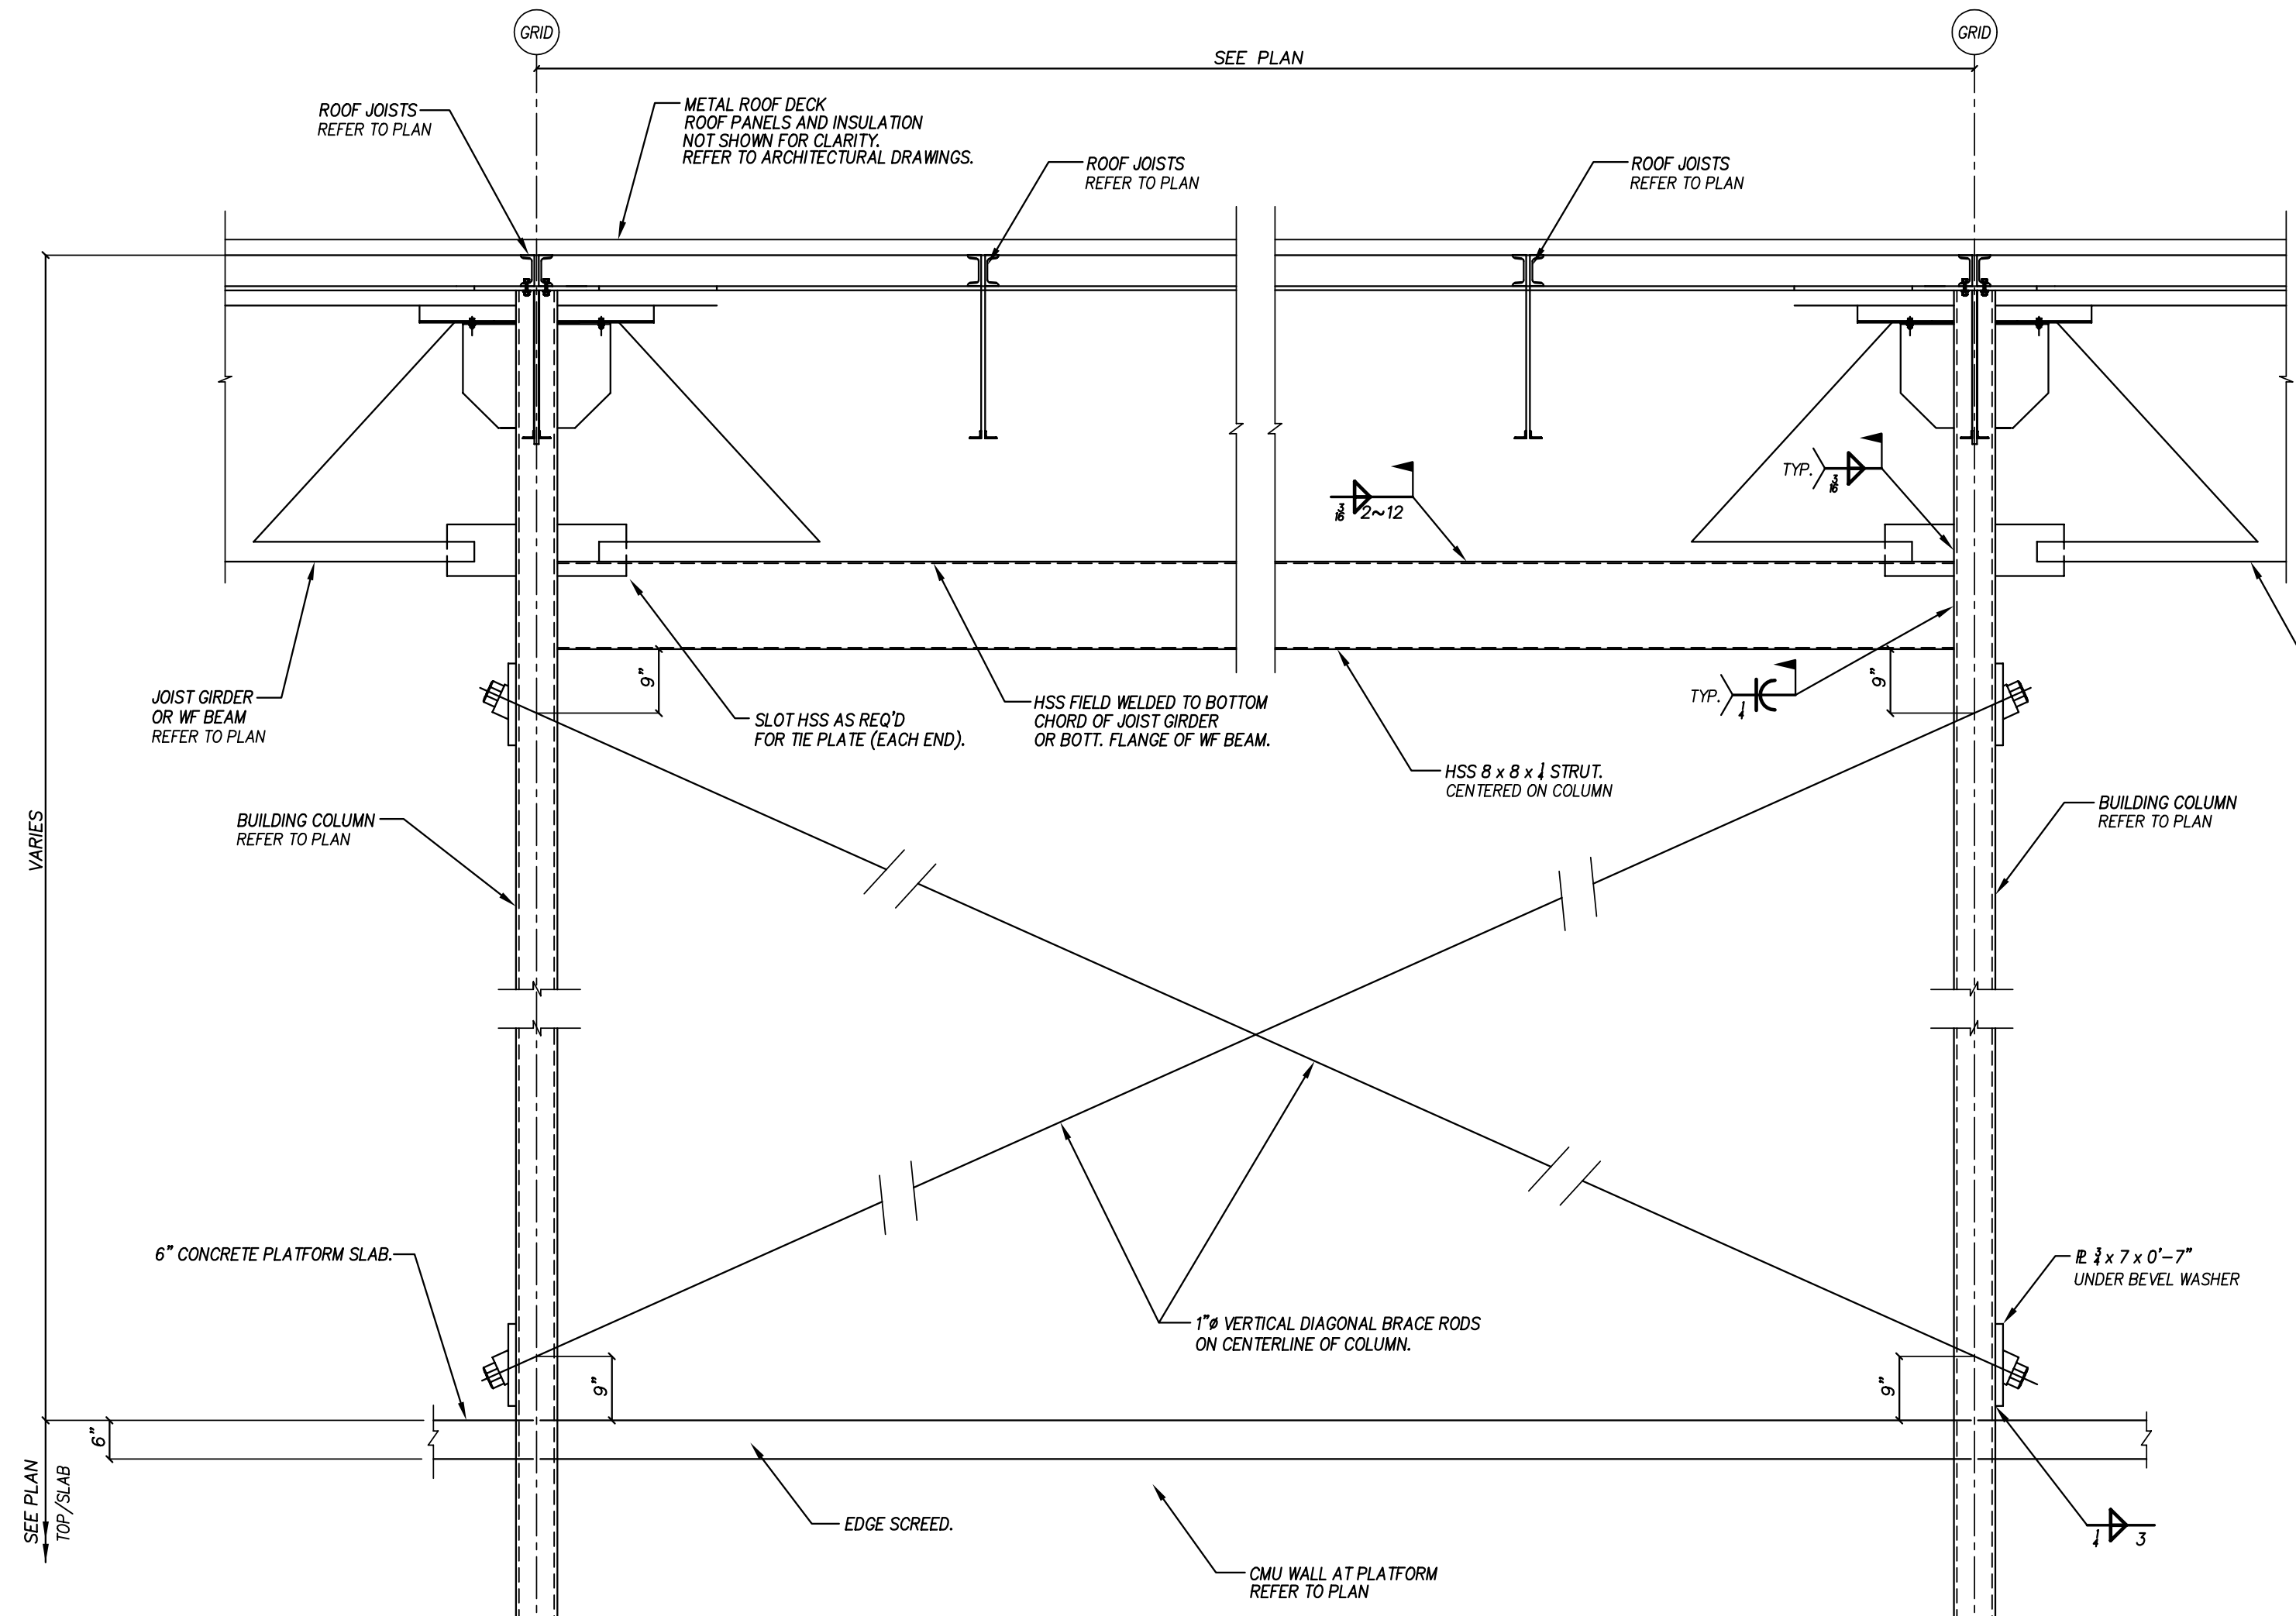

TYPICAL ROD VERTICAL BRACE VB-1 DETAIL ABOVE PLATFORM

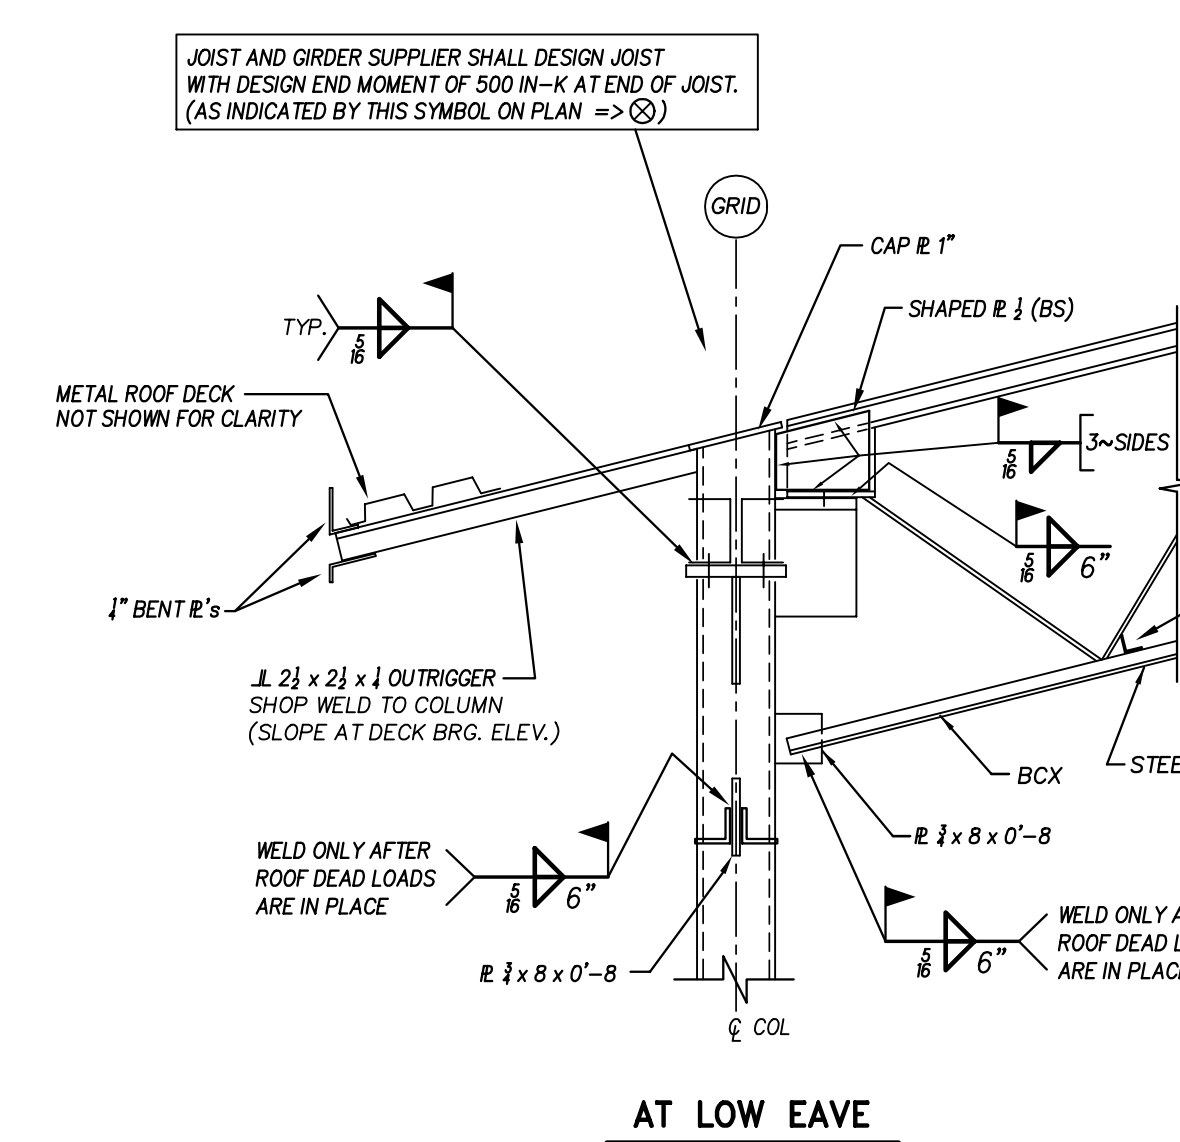


AT LOW EAVE

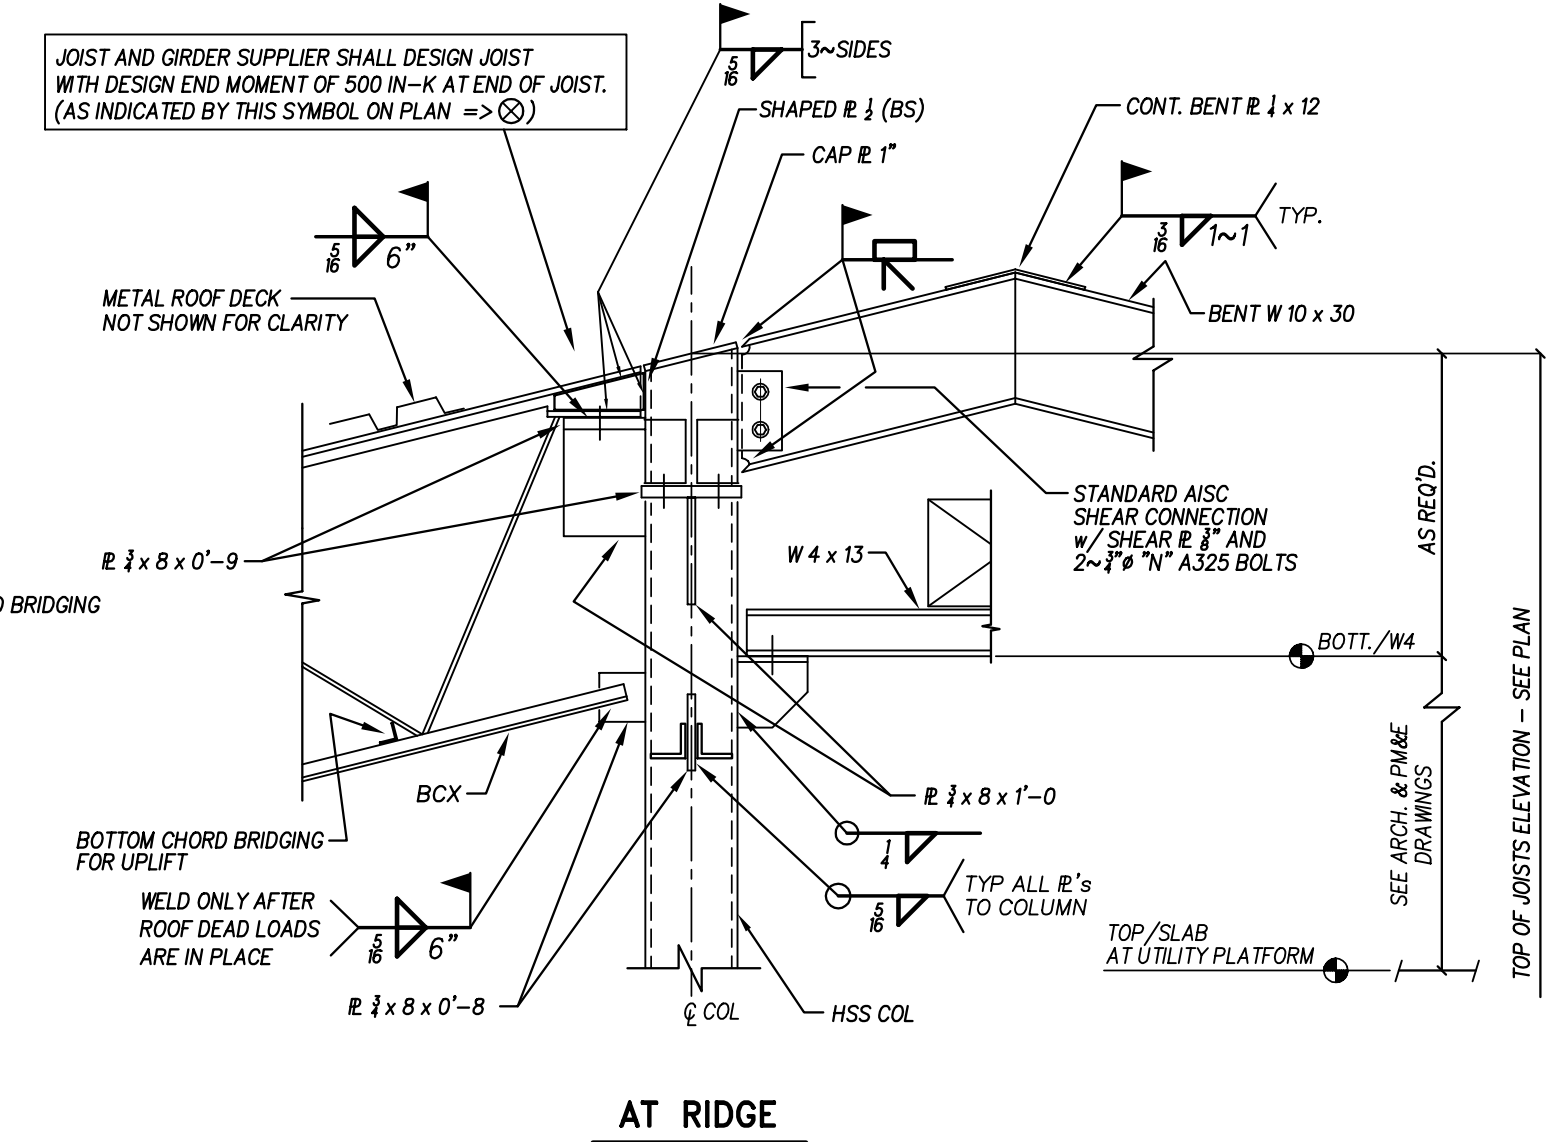

AT RIDGE


CLASSROOM RIDGE DETAIL AT BENT

1) SEE 4/51033 AND 5/51033 FOR ADDITIONAL NOTES THAT APPLY.
2) WELD ALL JOIST BOTTOM CHORDS AFTER ROOF DEAD LOADS ARE IN PLACE.

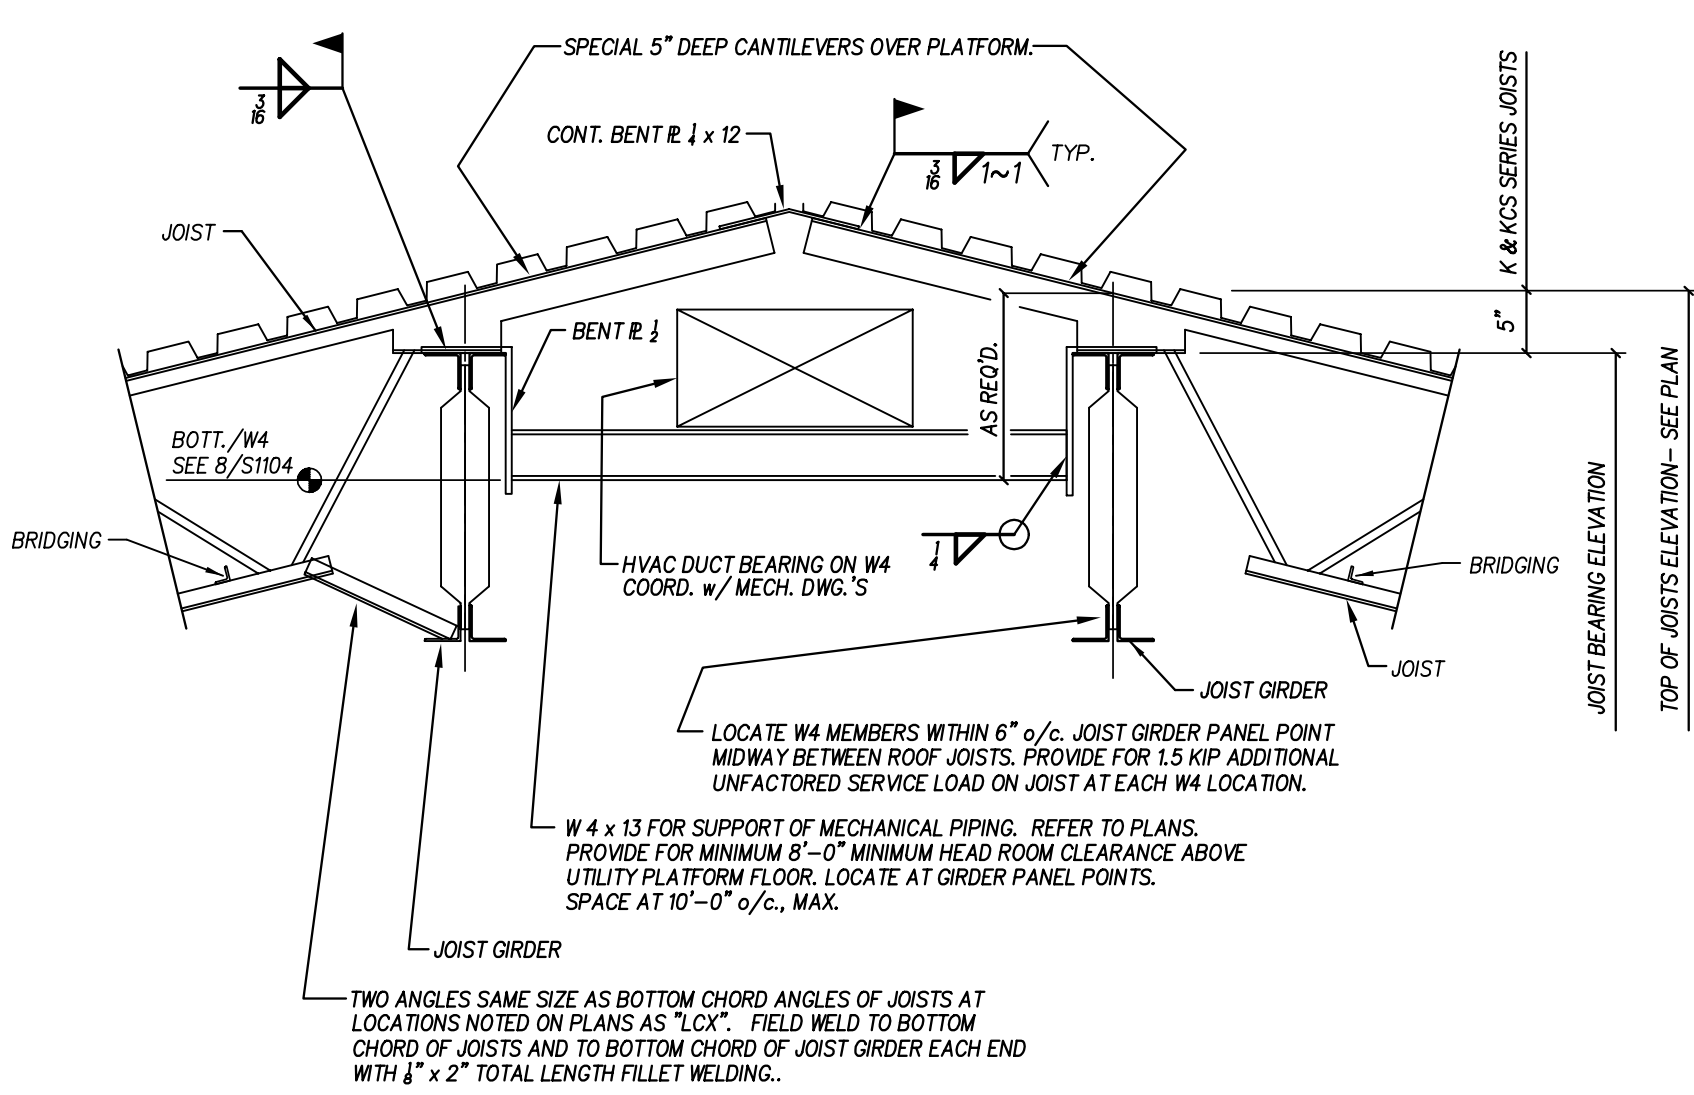


TYPICAL DETAIL AT RIDGE OVER PLATFORM


- JOIST MANUFACTURER SHALL ADJUST JOIST SEATS AS REQUIRED TO MAINTAIN DECK BEARING ELEVATIONS SHOWN ON THE CONTRACT DRAWINGS.

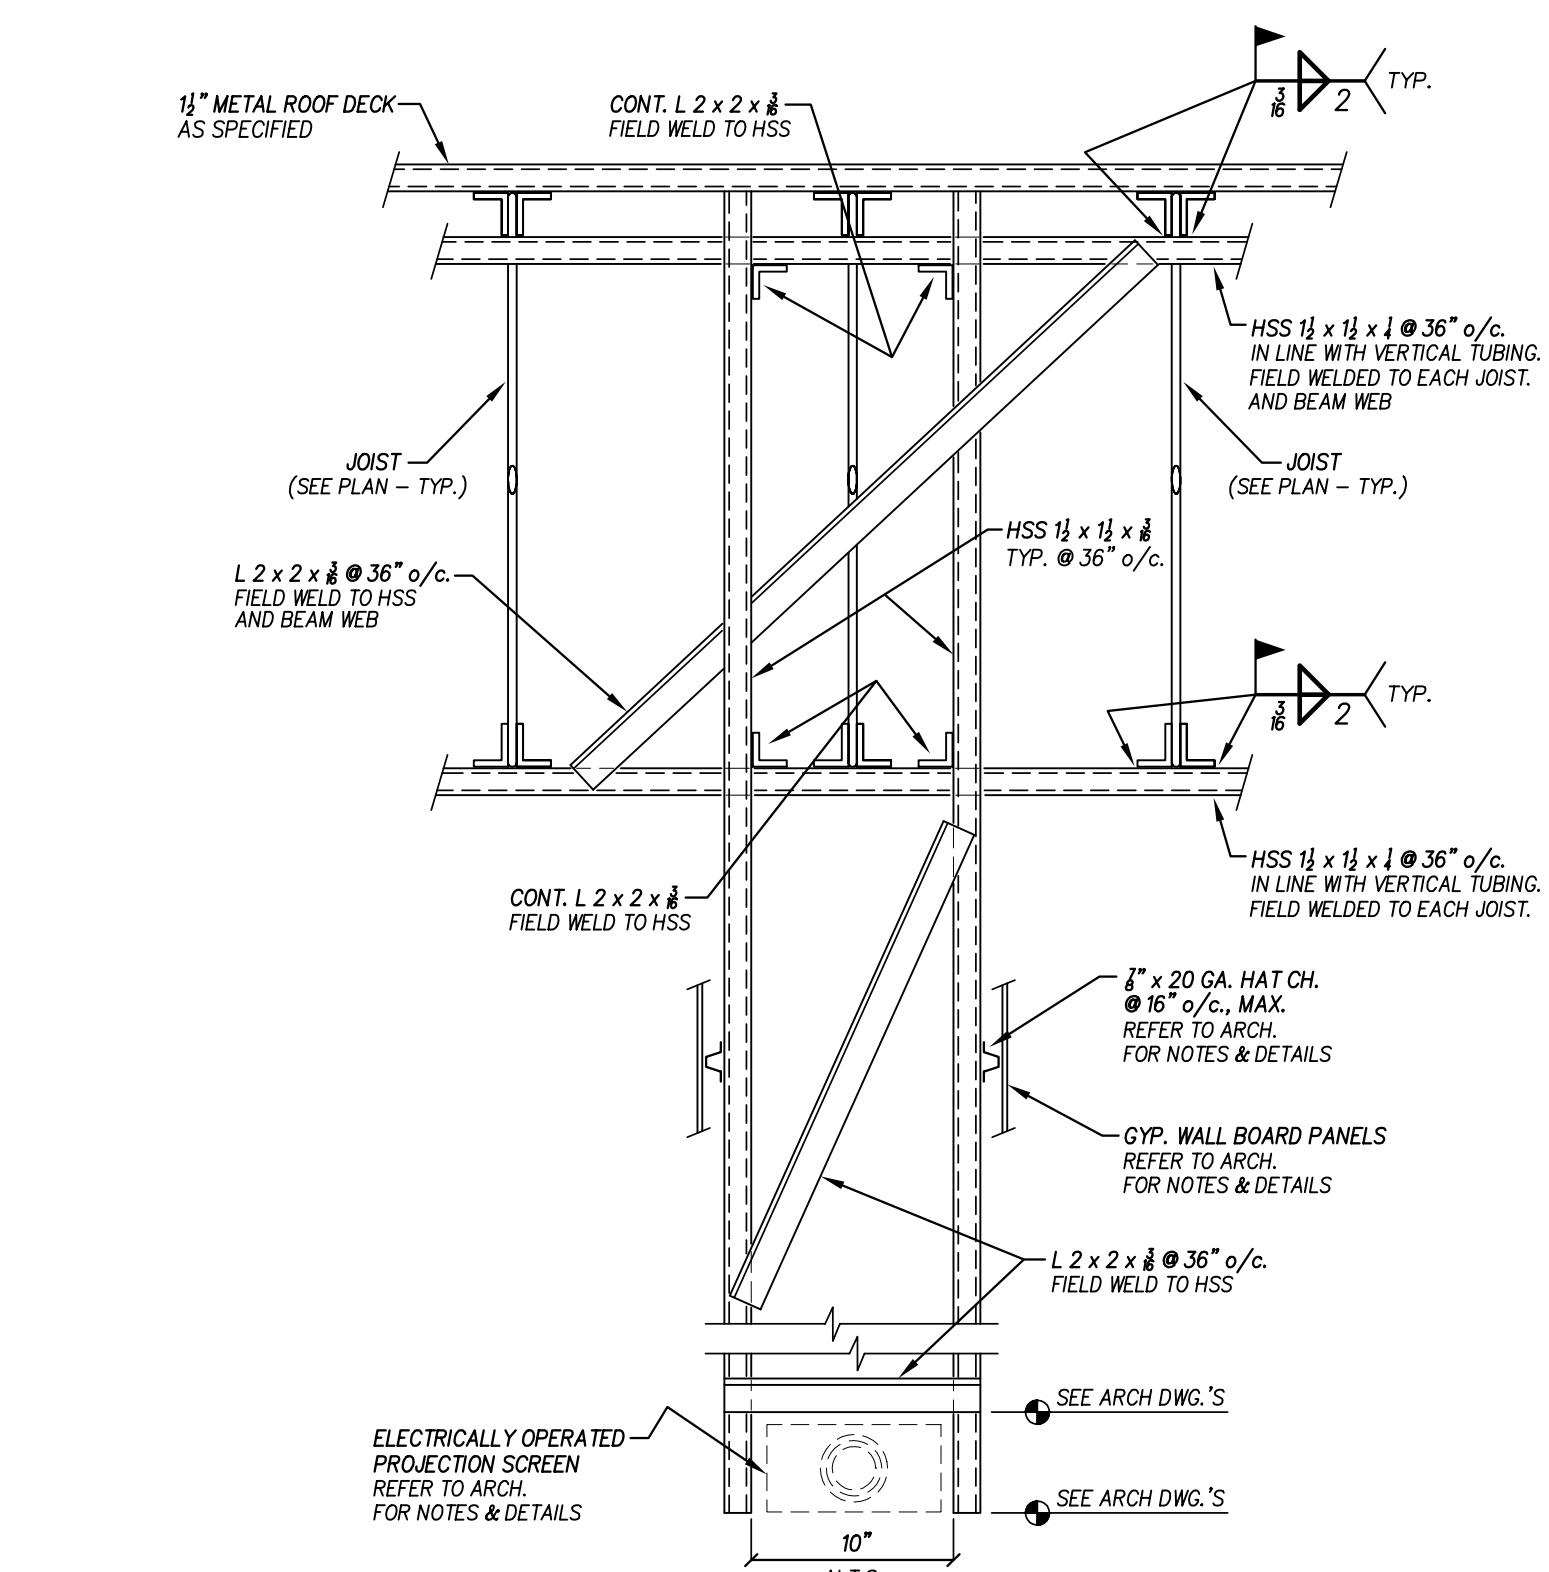


PROCENIUM FRAMING DETAIL

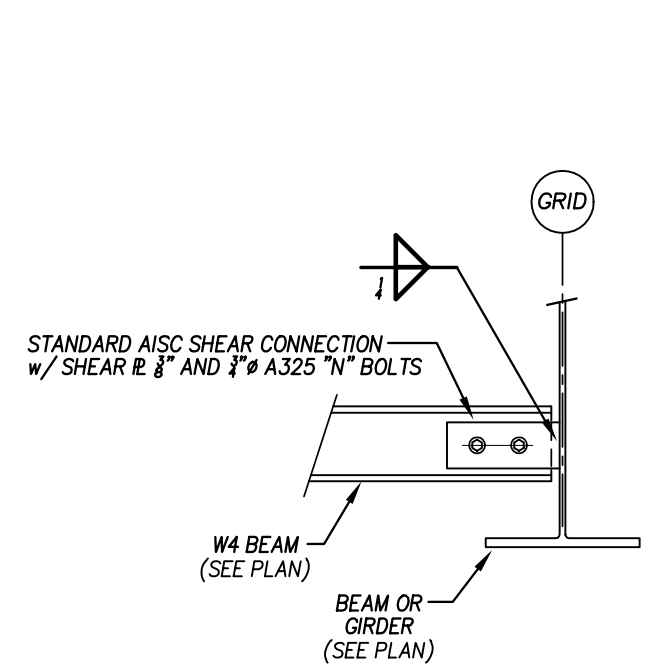


AT BEAM WEB (OVER-HAND WELD)

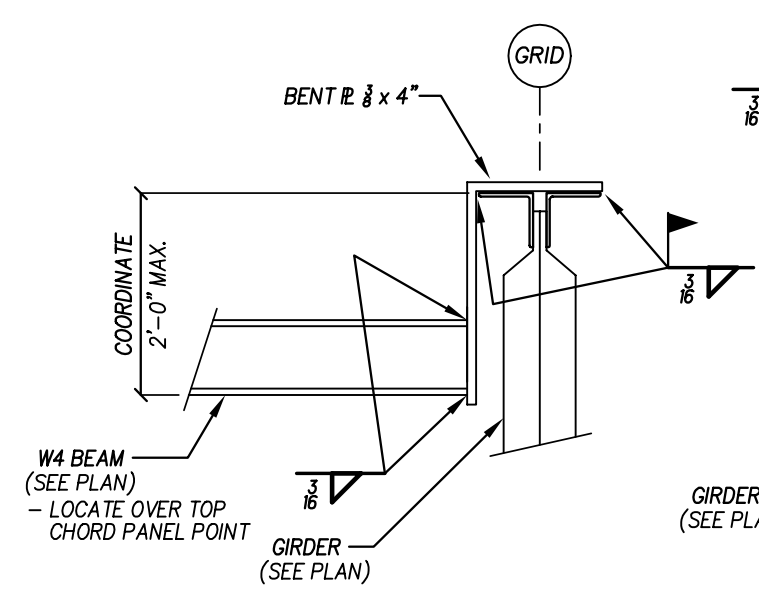


AT GIRDER PANEL POINT (OVER-HAND WELD)

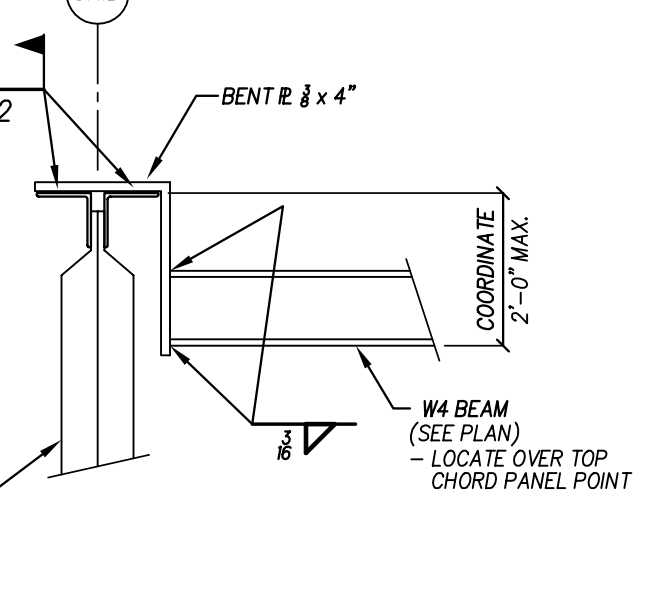

AT GIRDER PANEL POINT (TOP-HAND WELD)

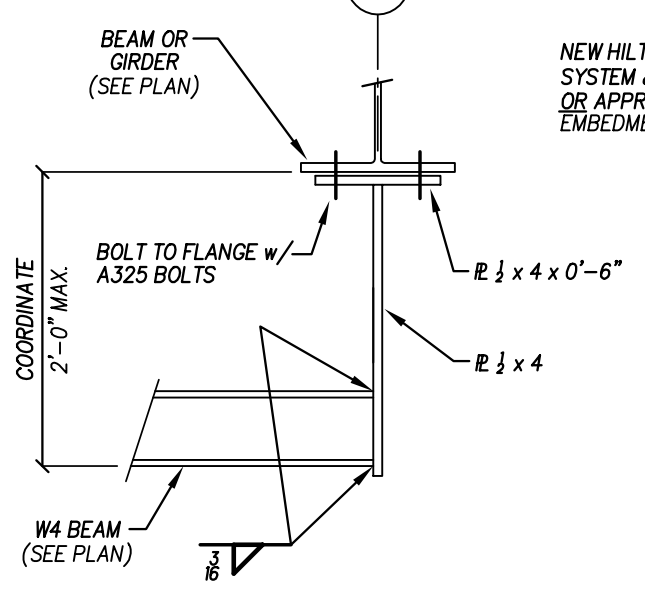


AT BEAM/GIRDER FLANGE

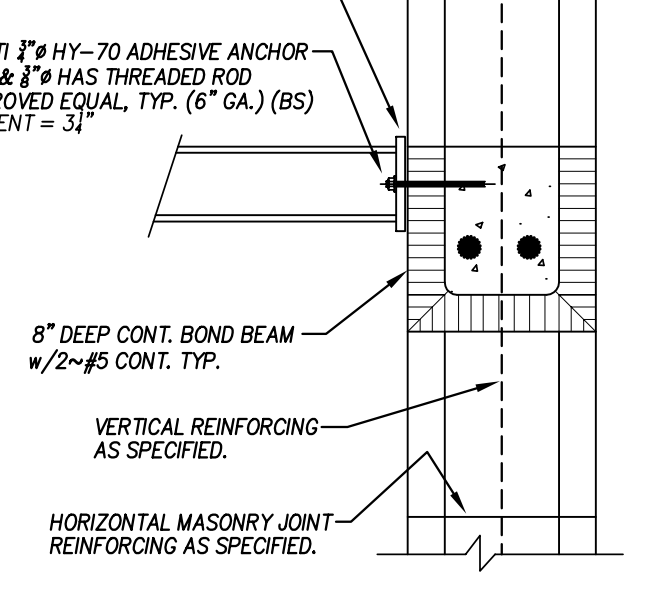


AT CMU WALL


PIPE HANGER SUPPORT DETAILS

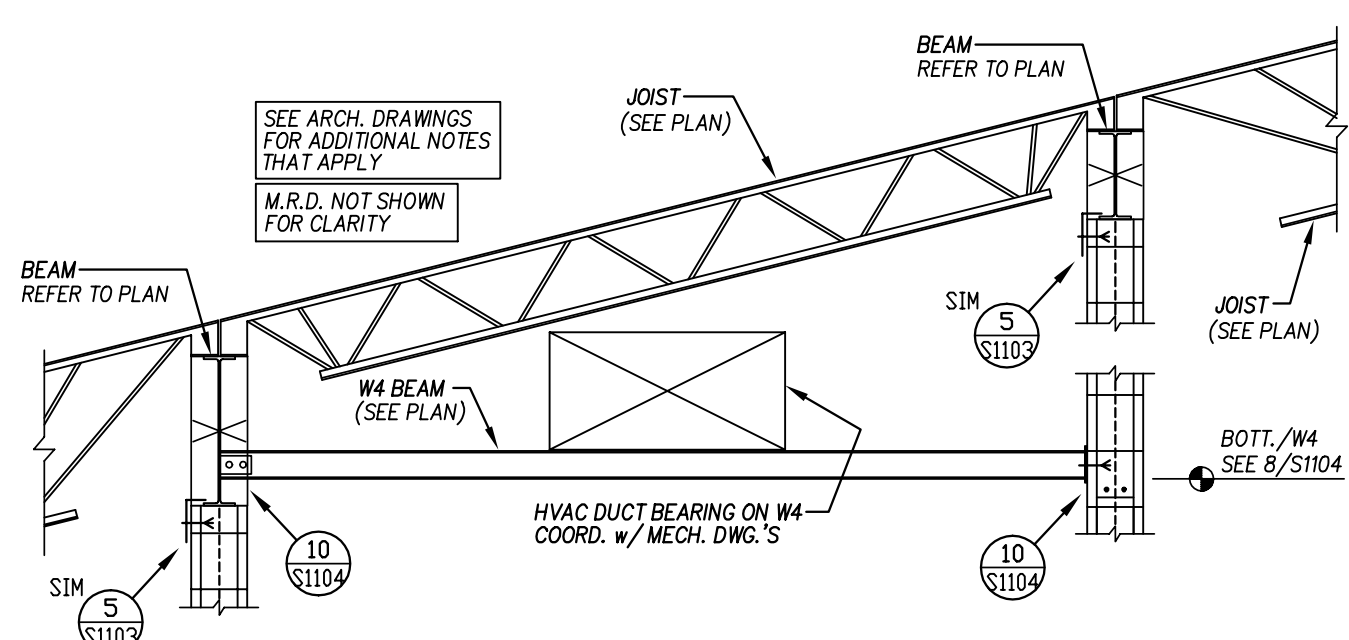

SECTION OVER PLATFORM AREA 100 COORDINATOR

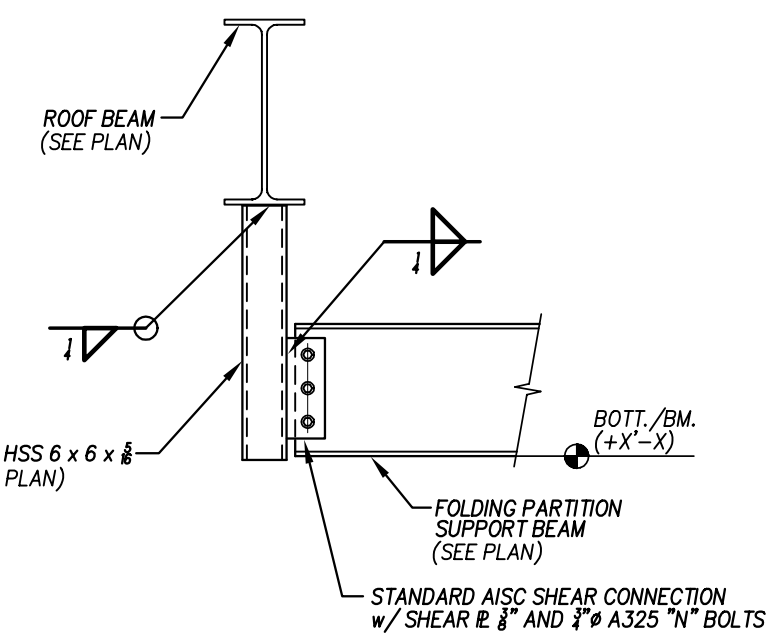

HANGER SECTION

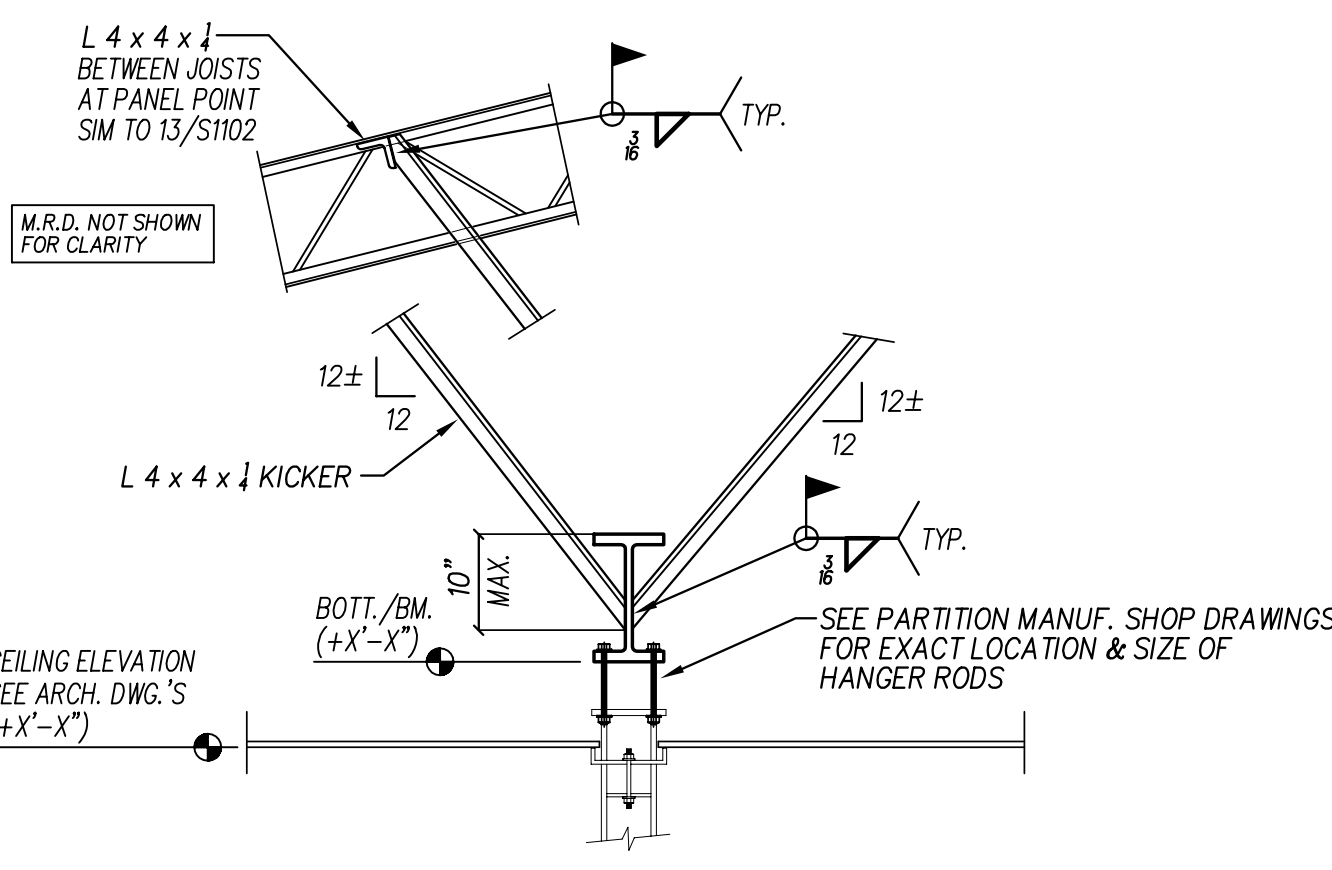

SECTION AT FOLDING PARTITION

Revision

No. Date












Hite associates
ARCHITECTURE / ENGINEERING / TECHNOLOGY
2600 Meridian Drive / Greenville, NC 27838 / tel (252) 757-0333

NC LIC. C-10329
QED
QUEEN ENGINEERING & DESIGN
2211 MARKET STREET, SUITE 4115
Raleigh, NC 27603
PH: 919 873 8888
FAX: 919 873 8889

North Carolina
Professional Engineer
Priscilla Queen
18981
ENGINEER
PRISCILLA QUEEN
09 OCT 2024

Beaufort PK-3 School
BEAUFORT COUNTY SCHOOLS
Washington / North Carolina / 27889

Project No. 22344
Date: 09 OCT 2024
Drawing no. S 1104

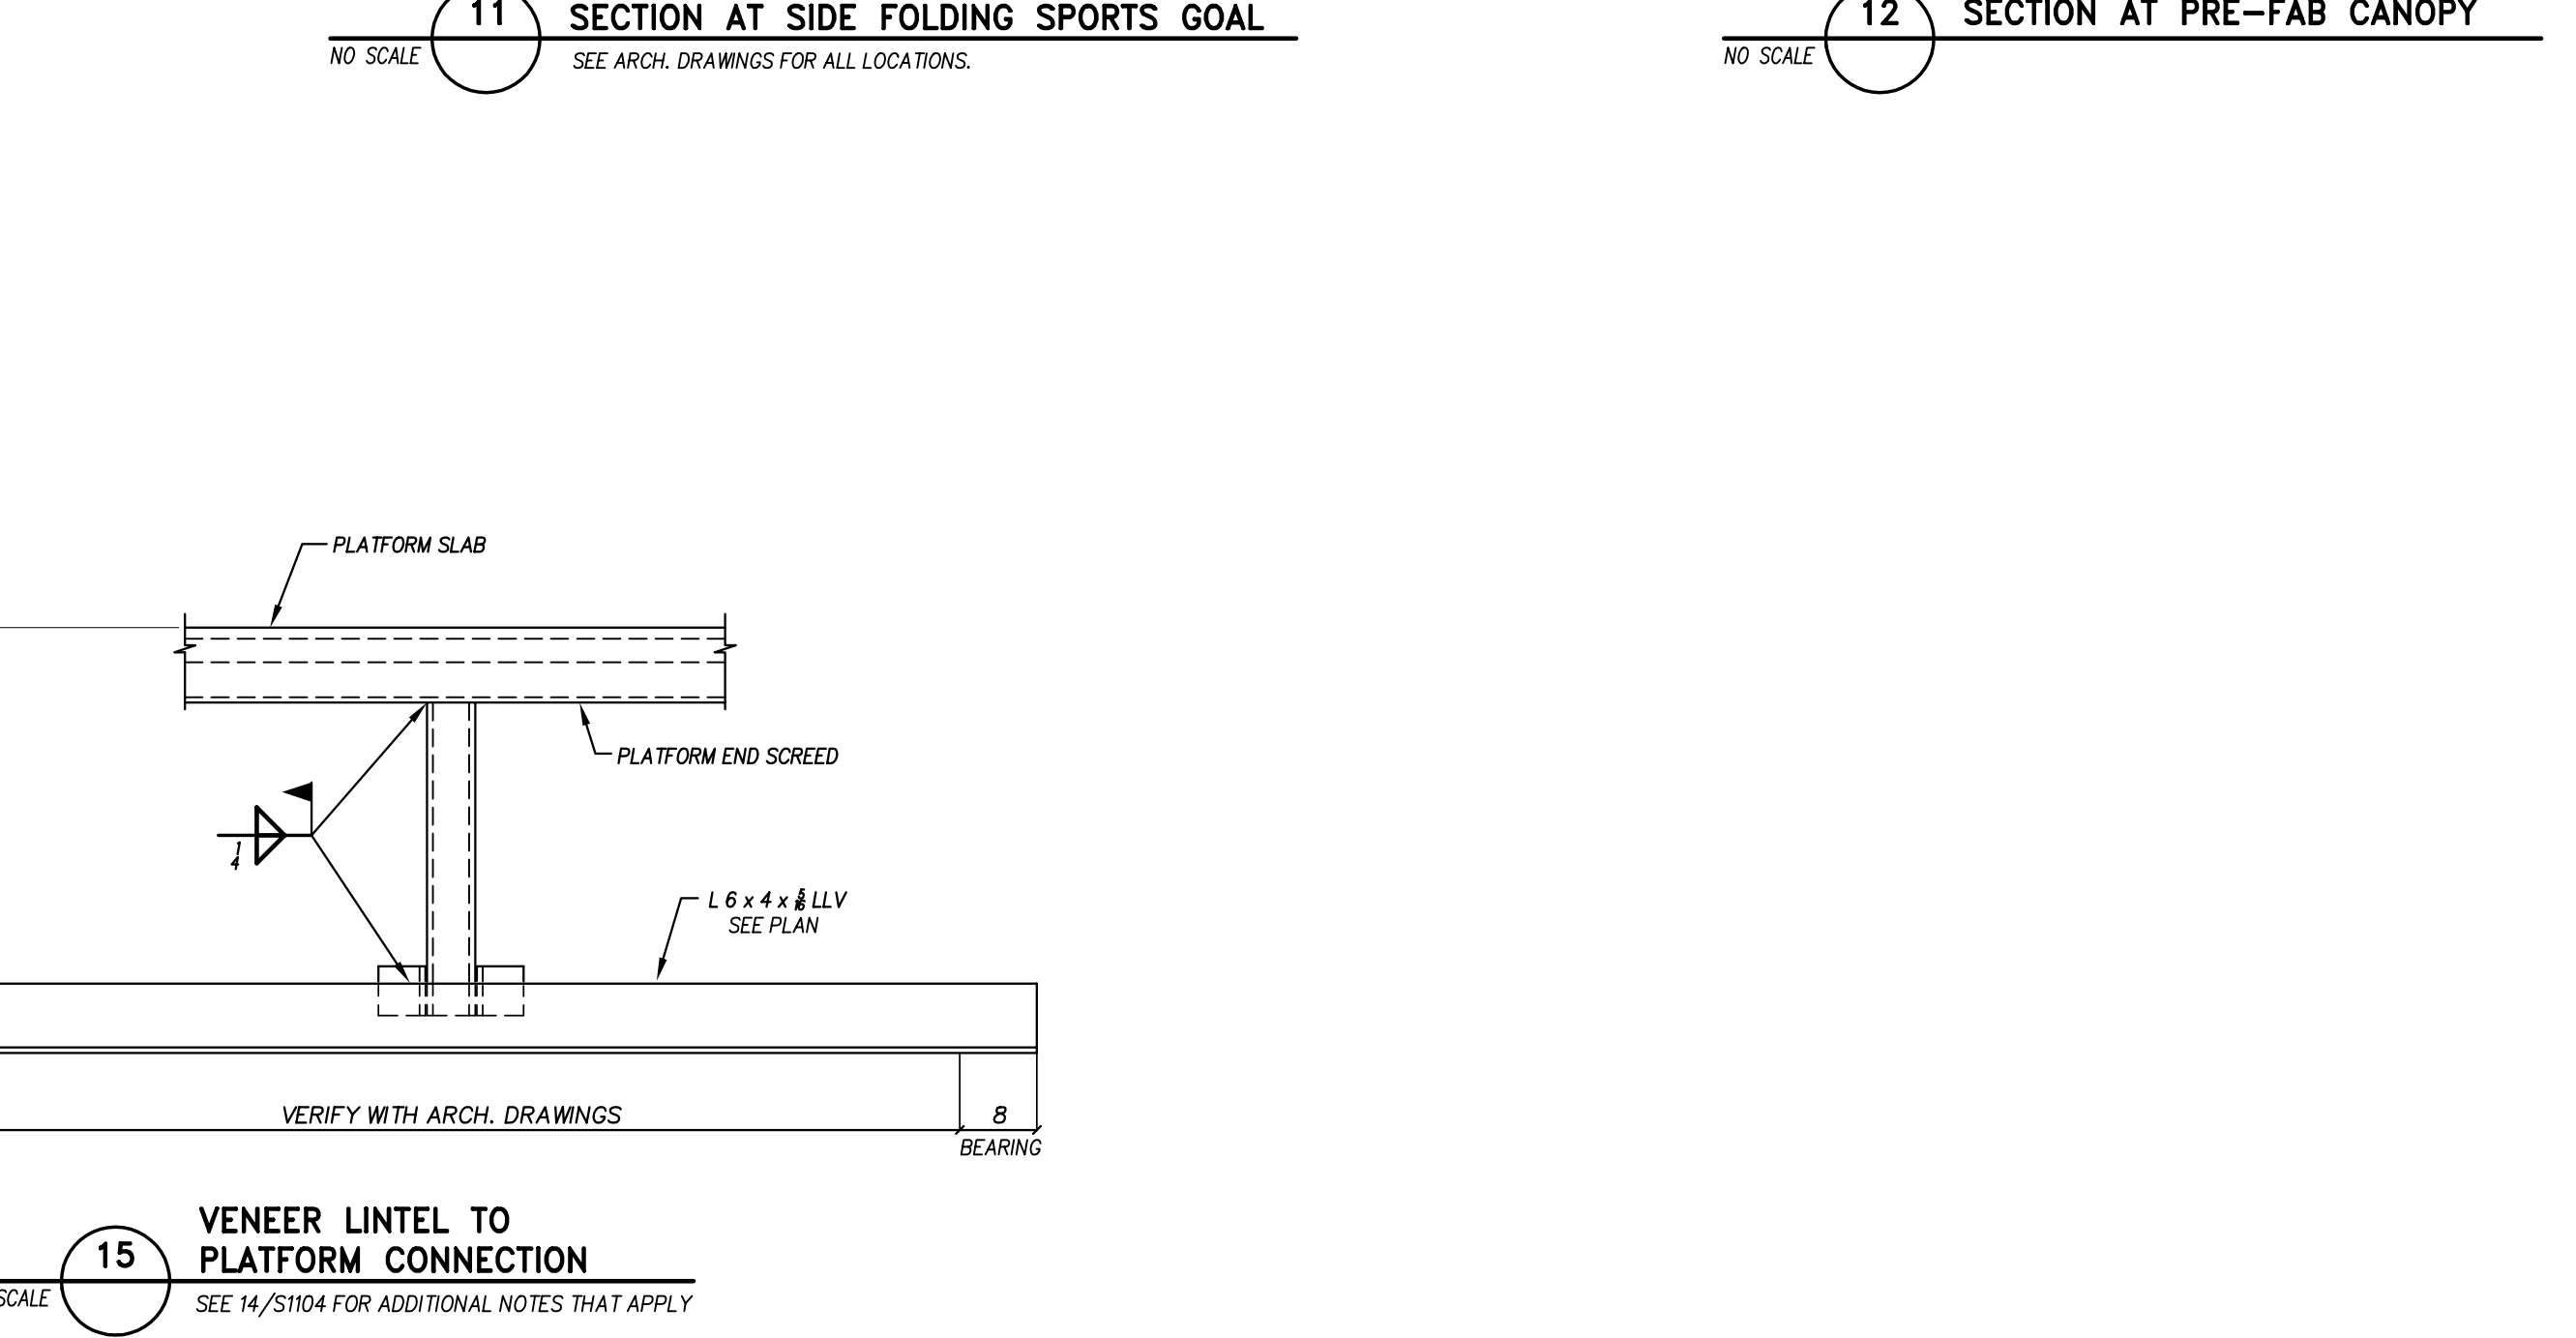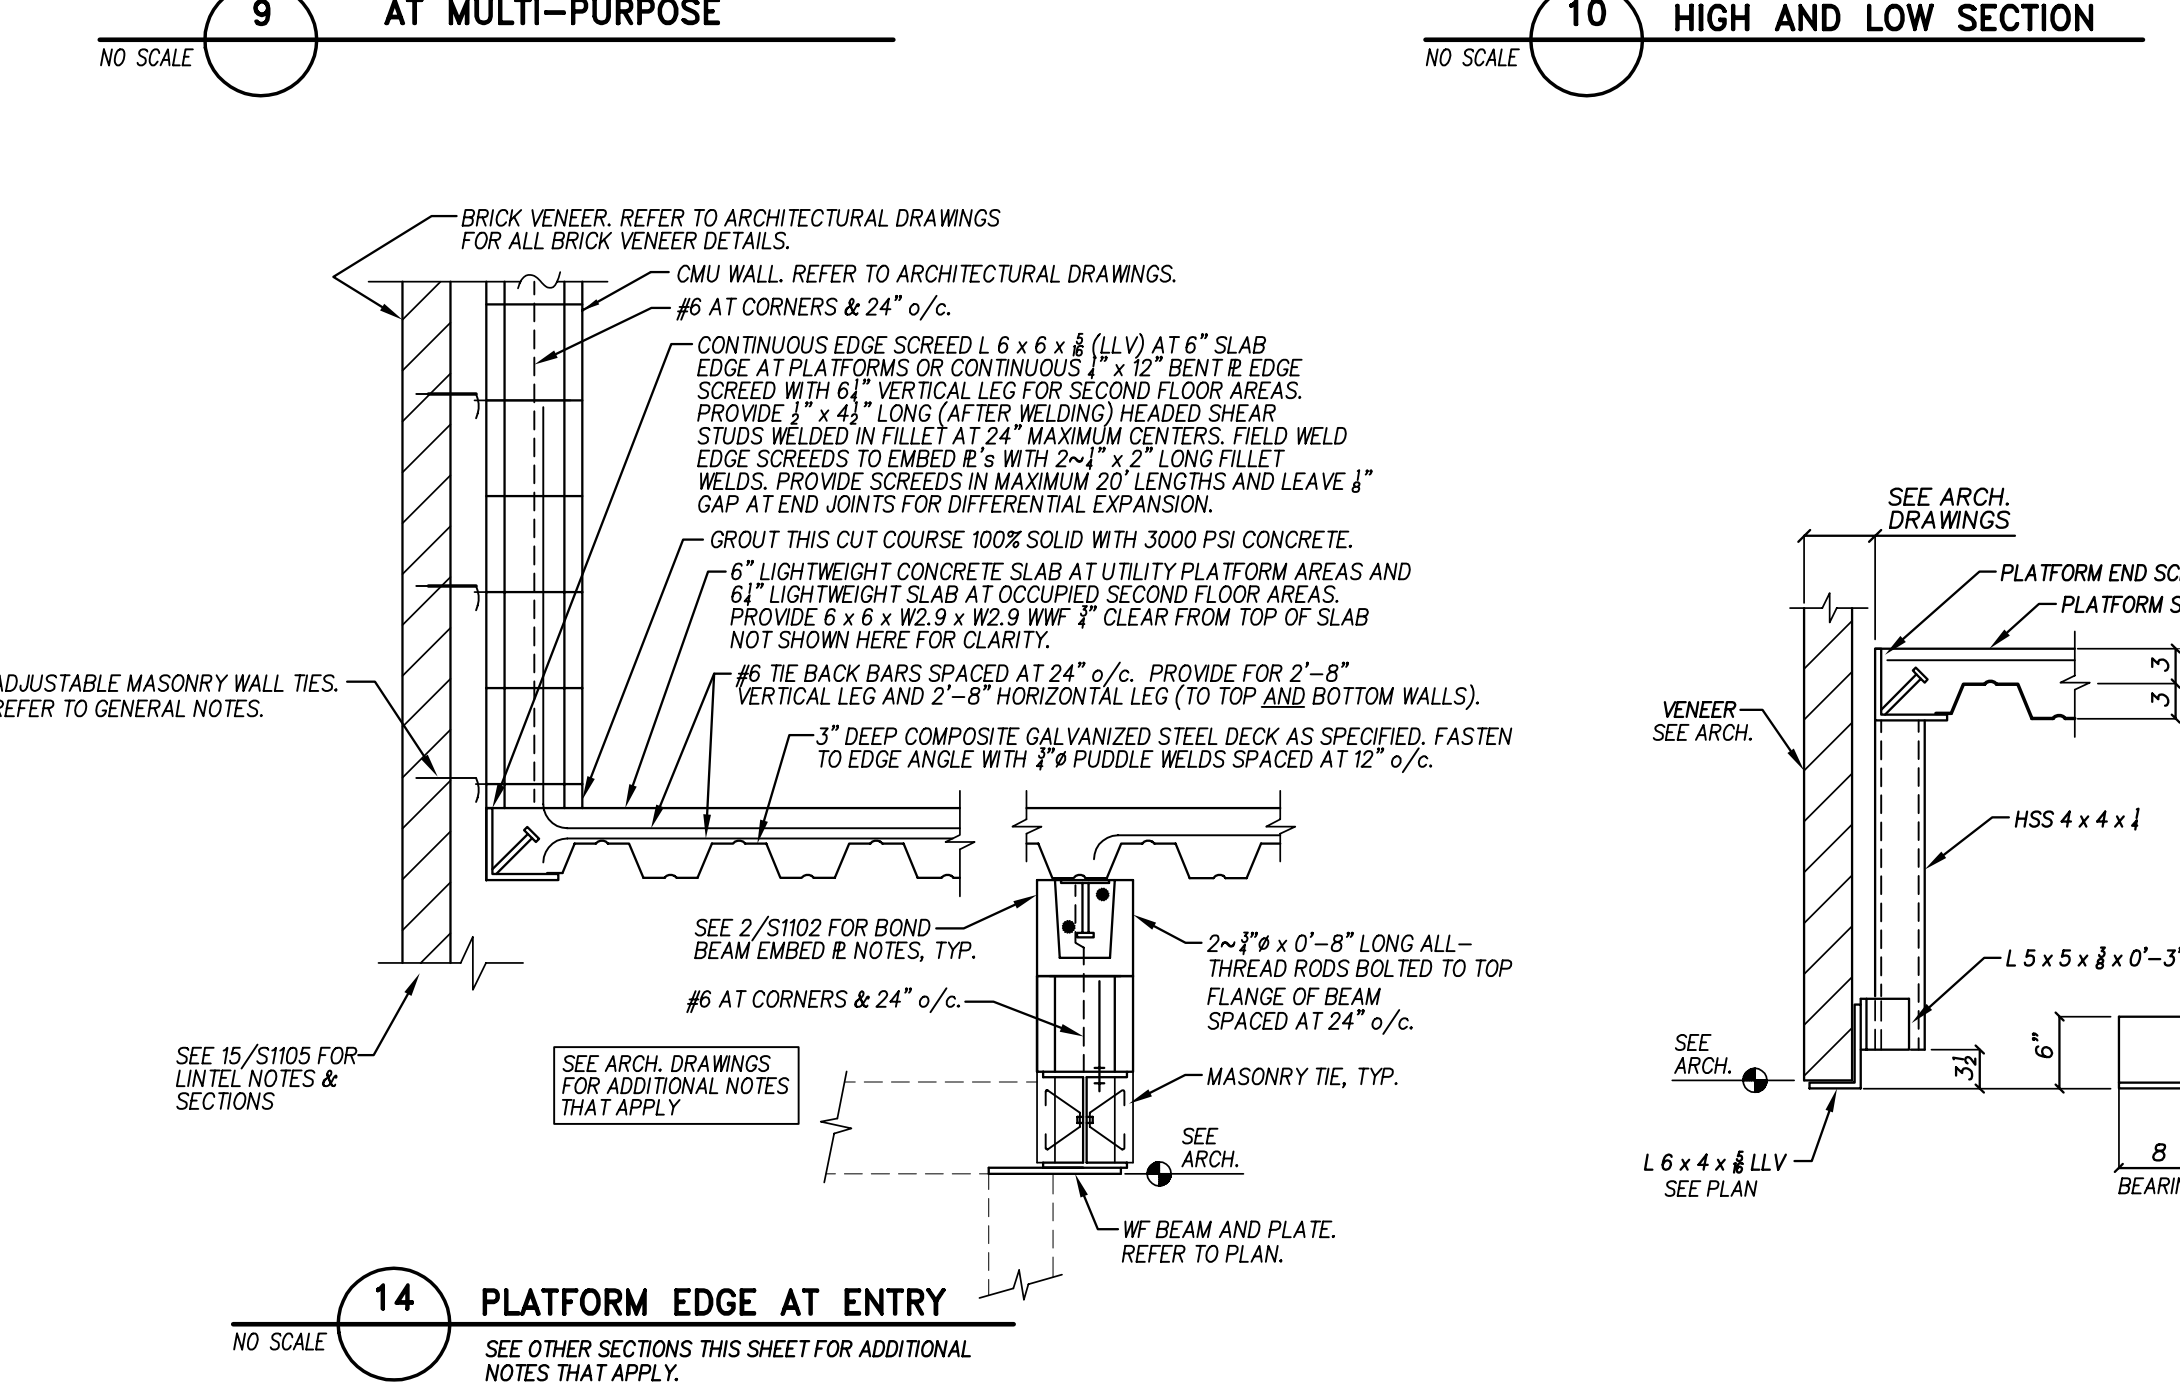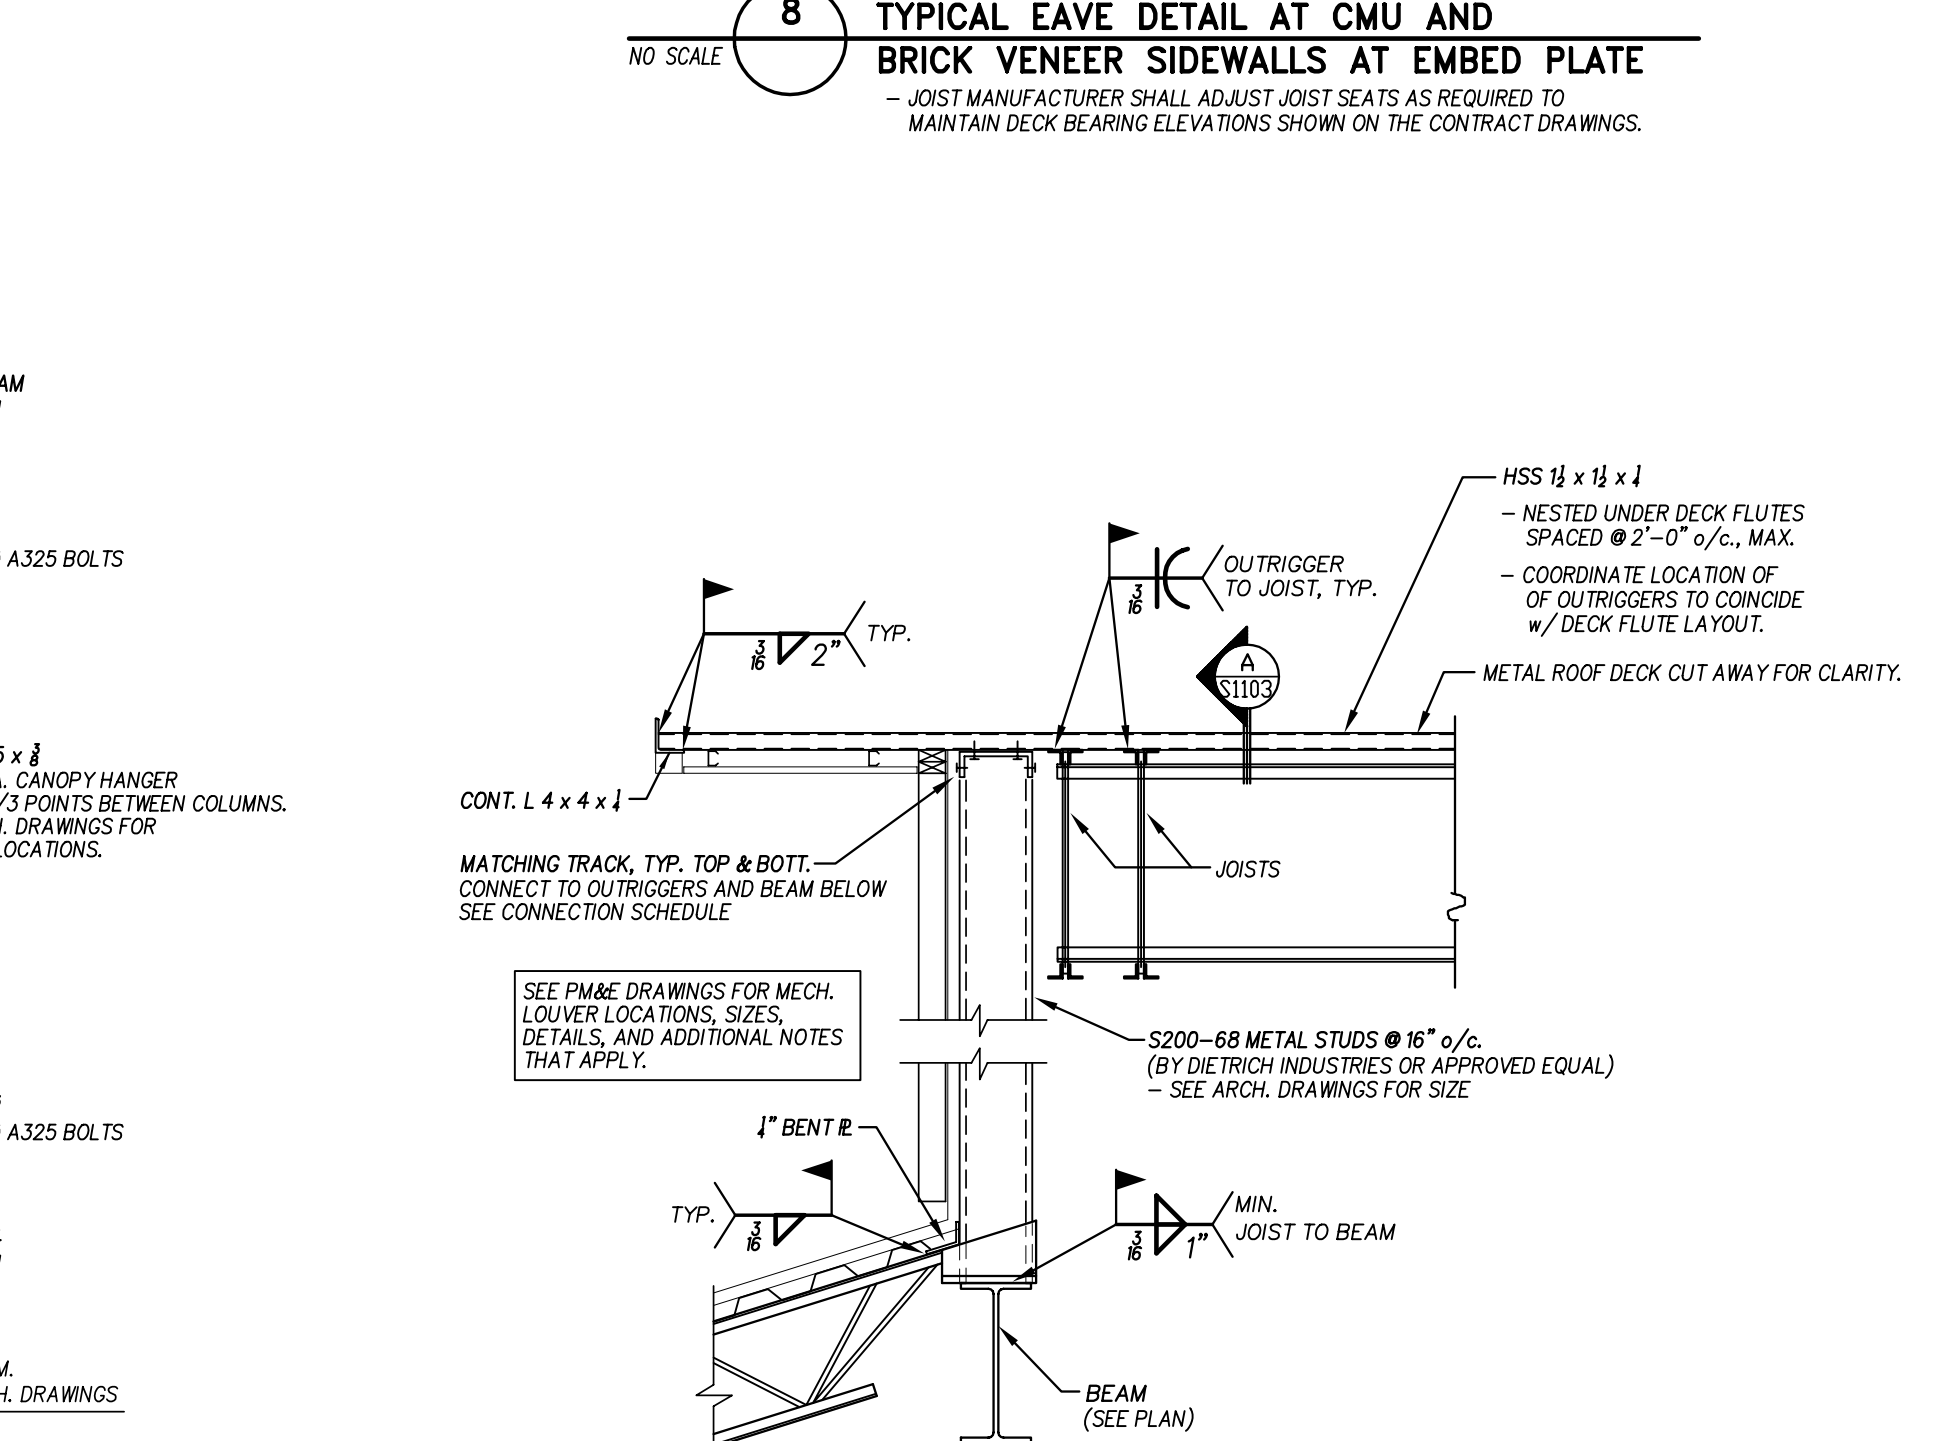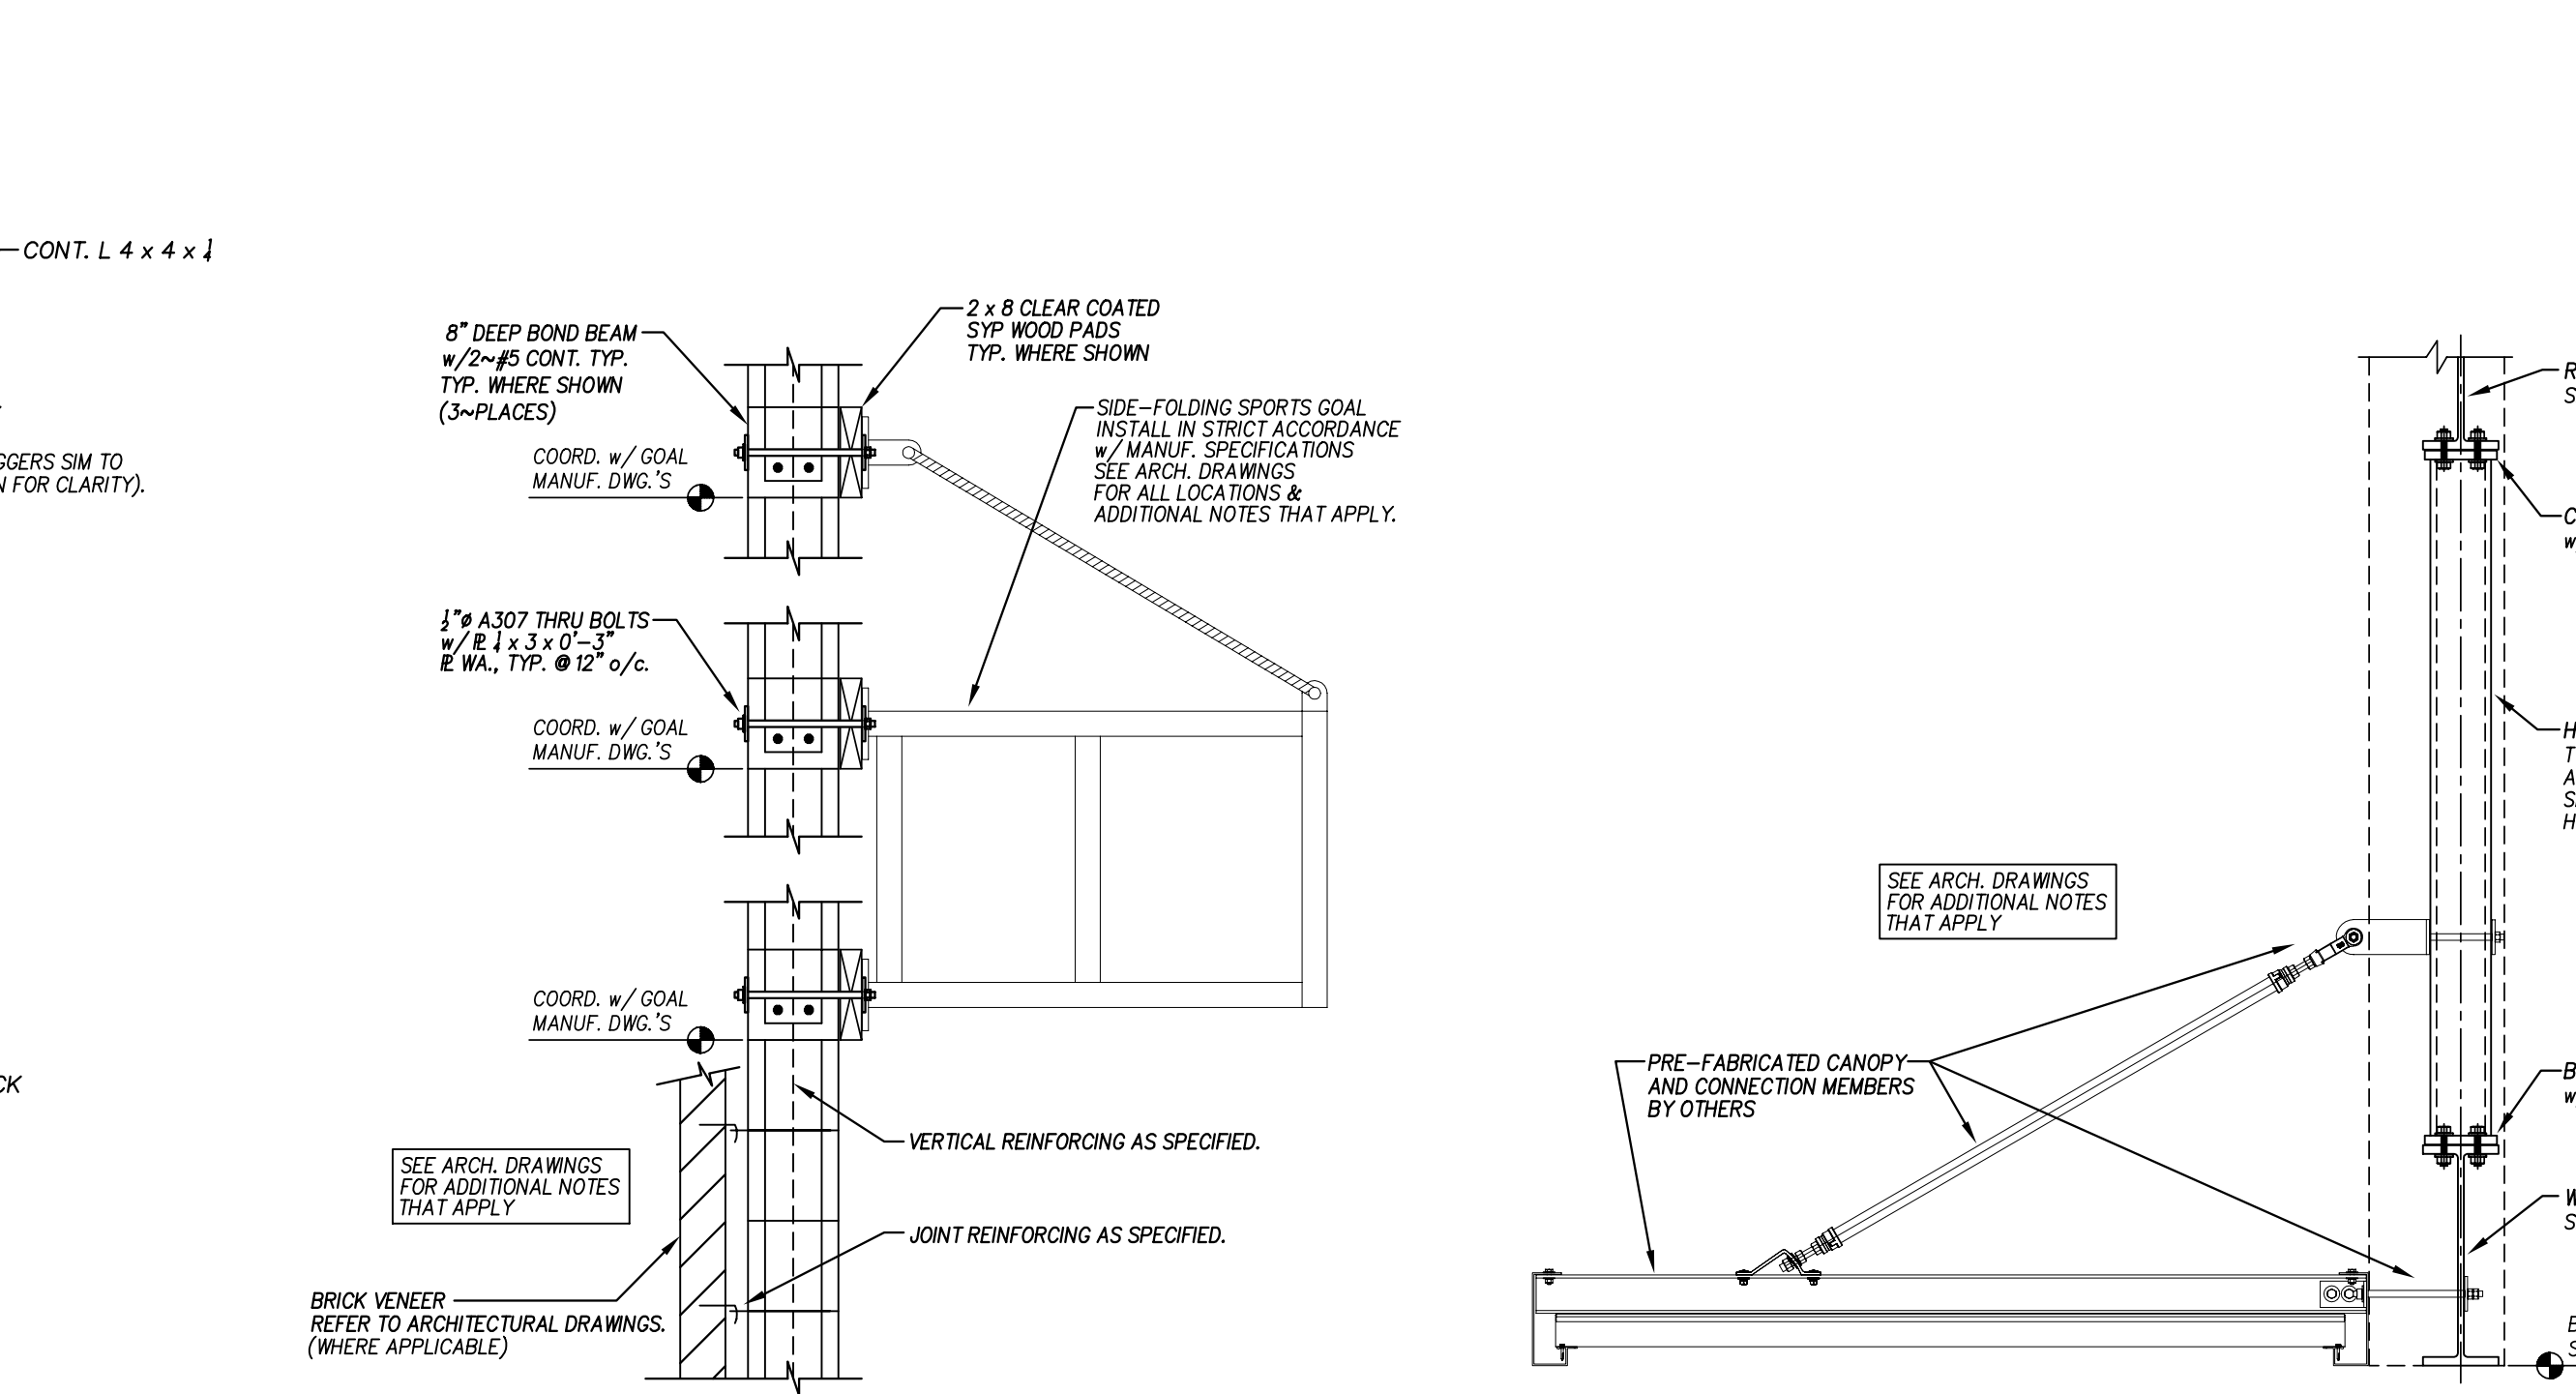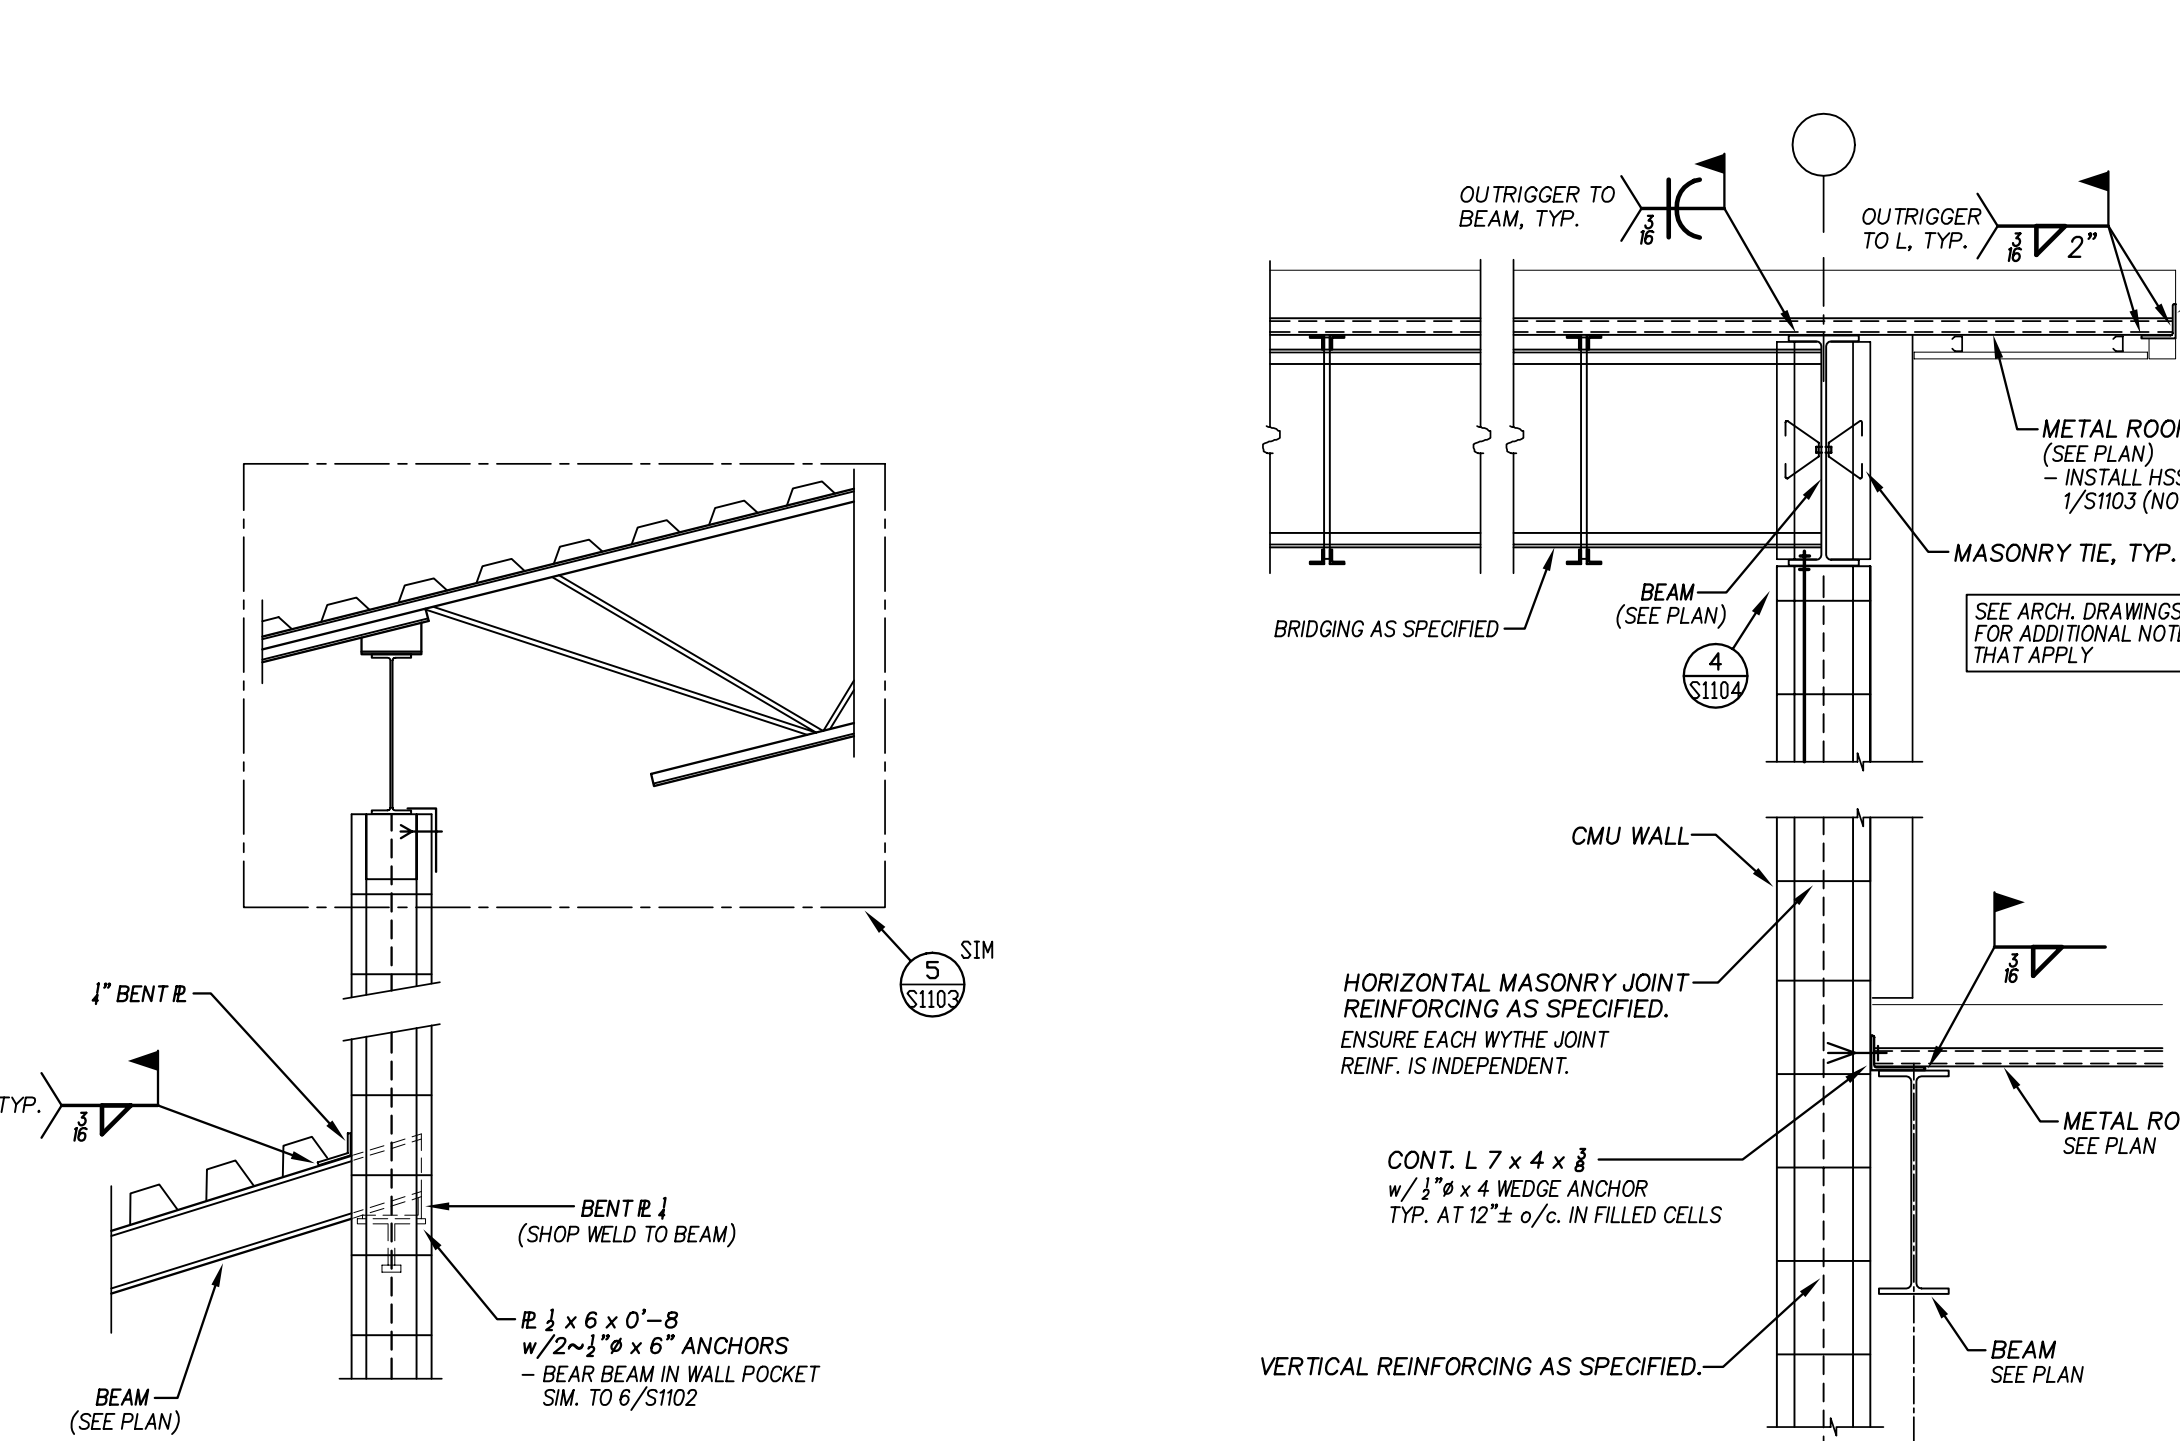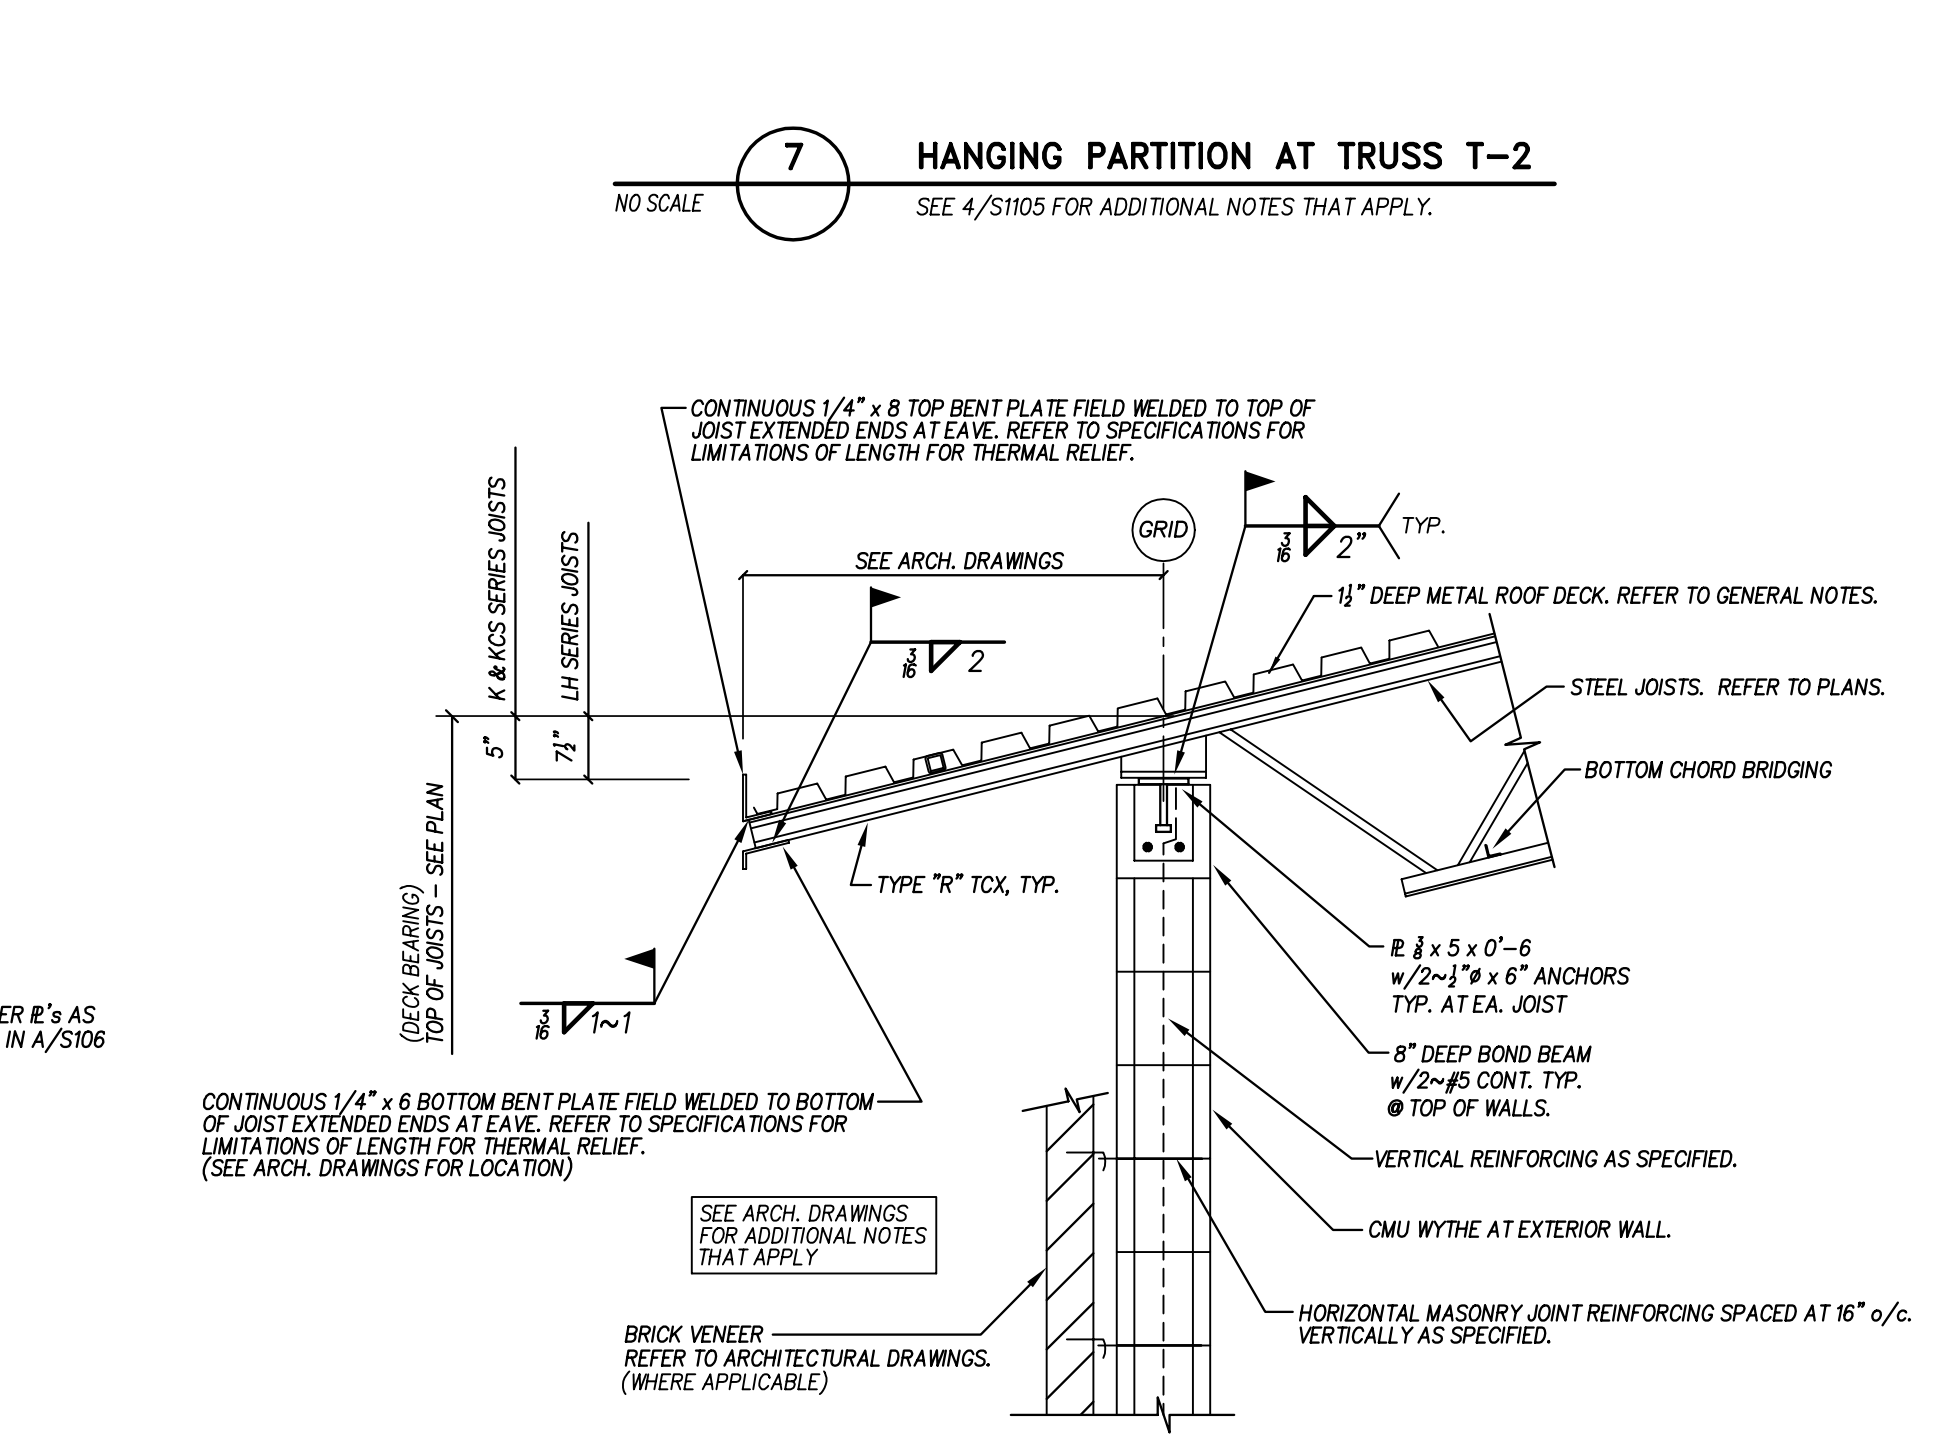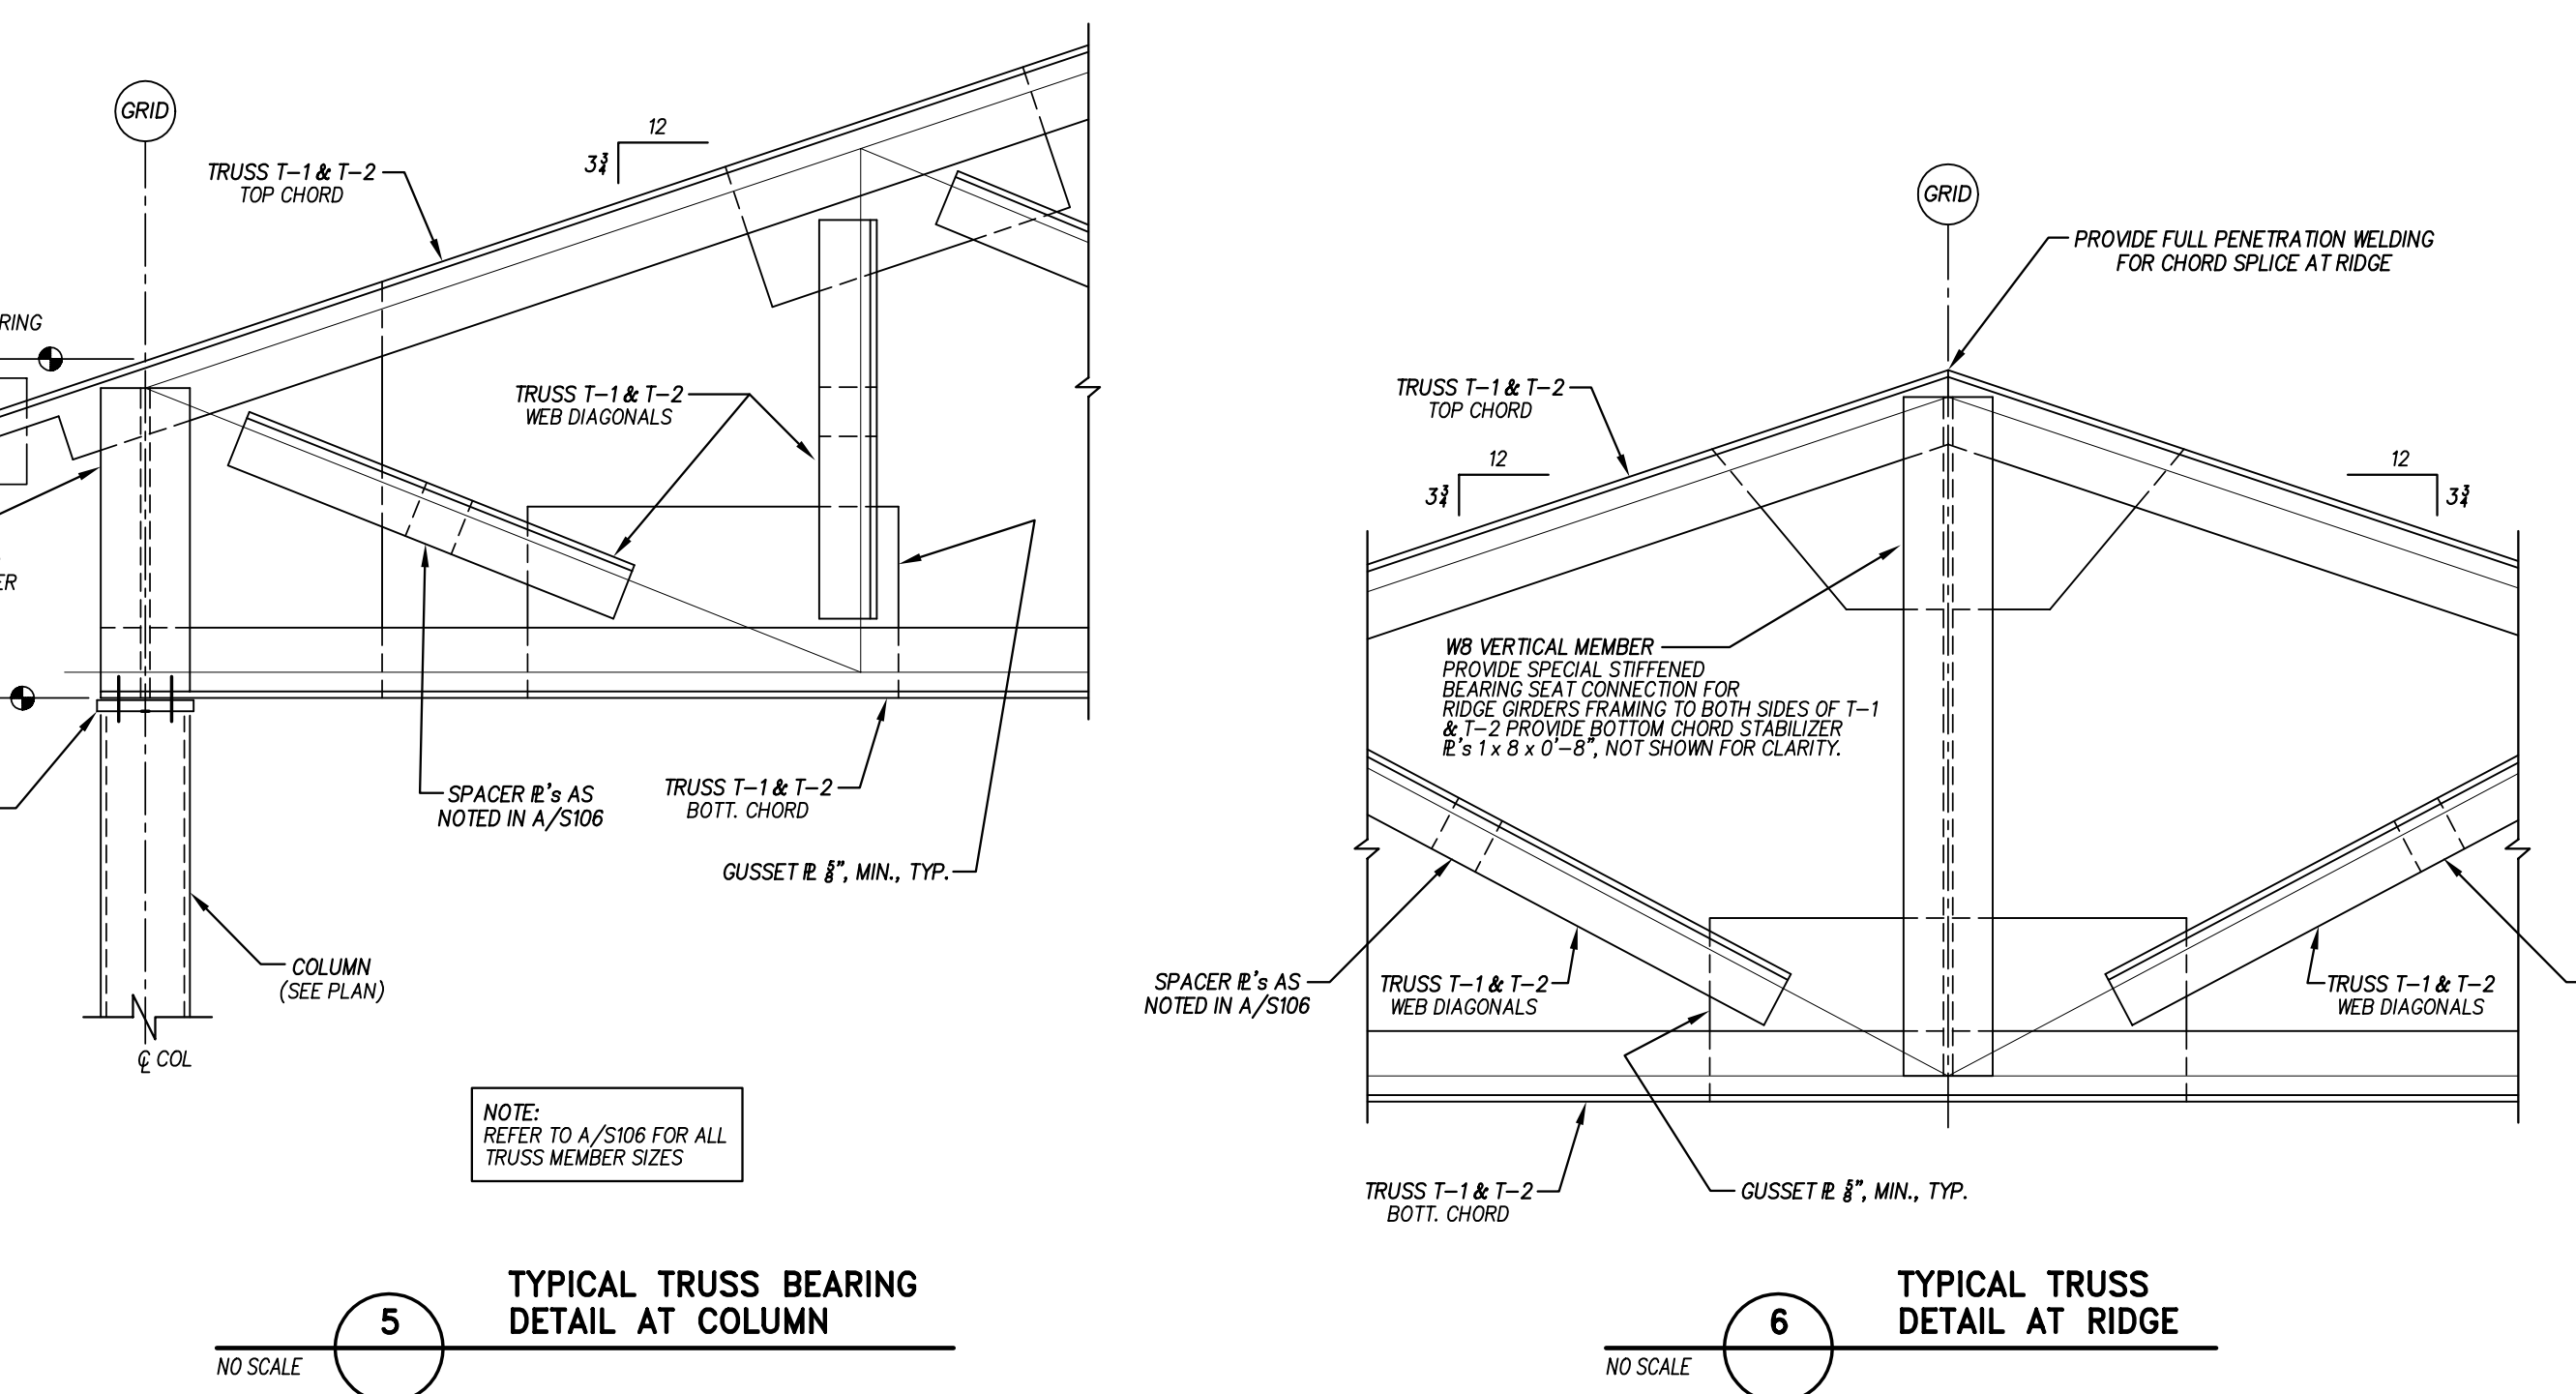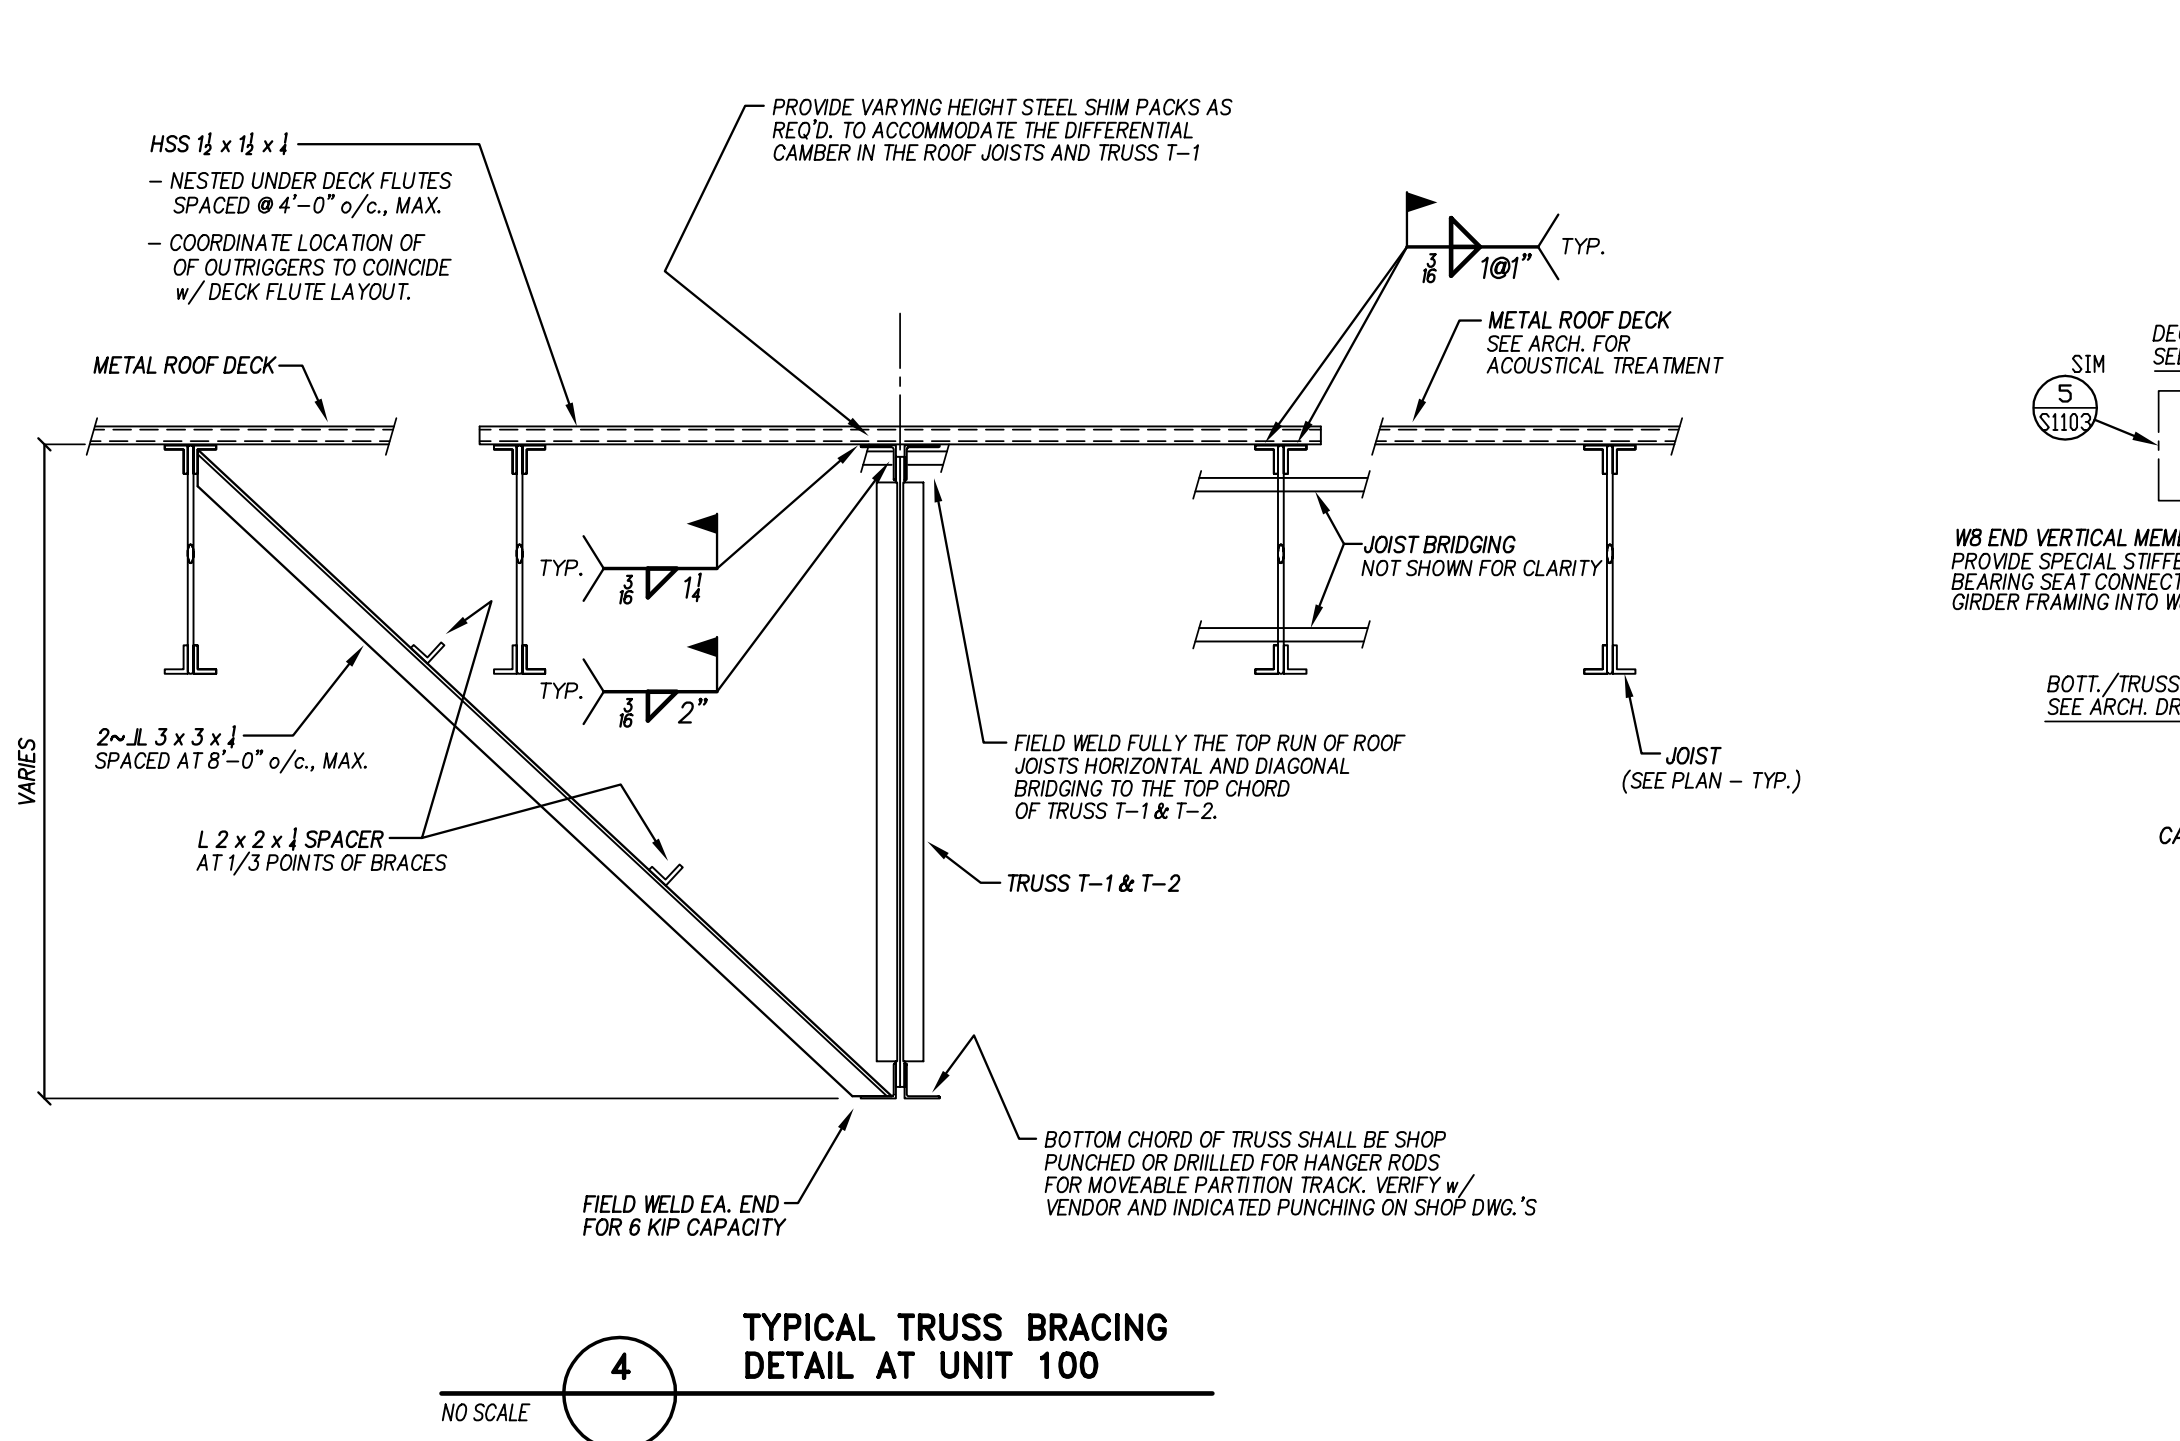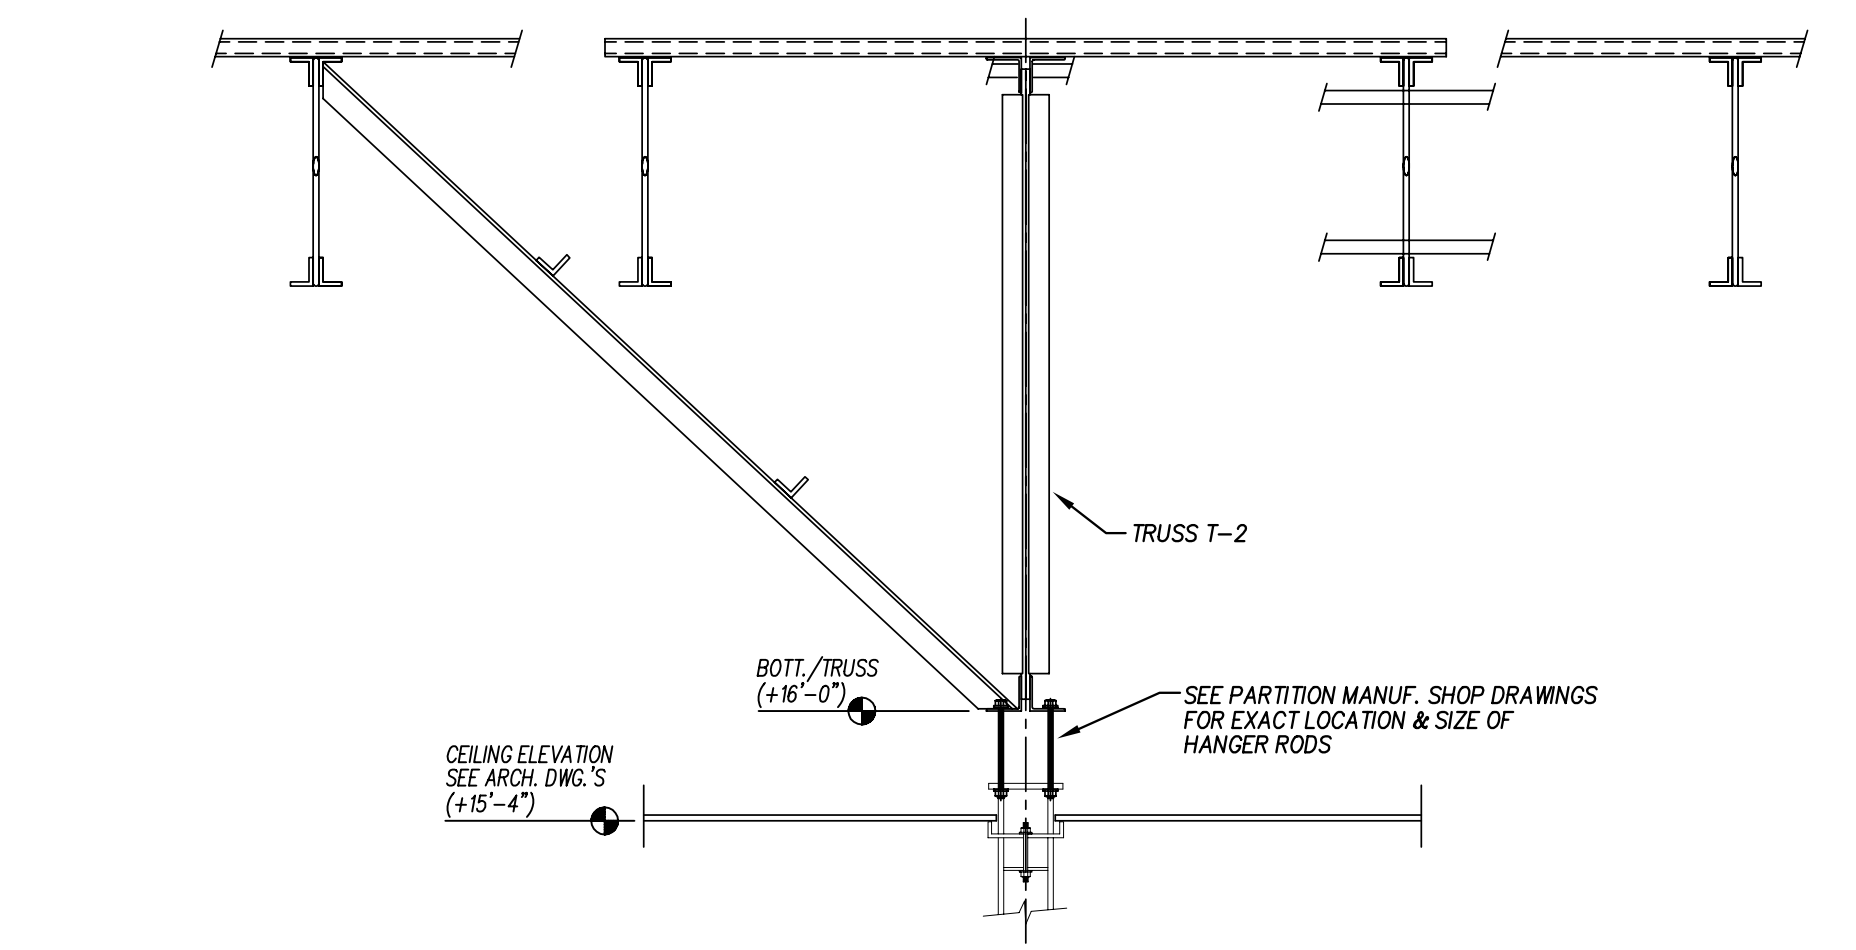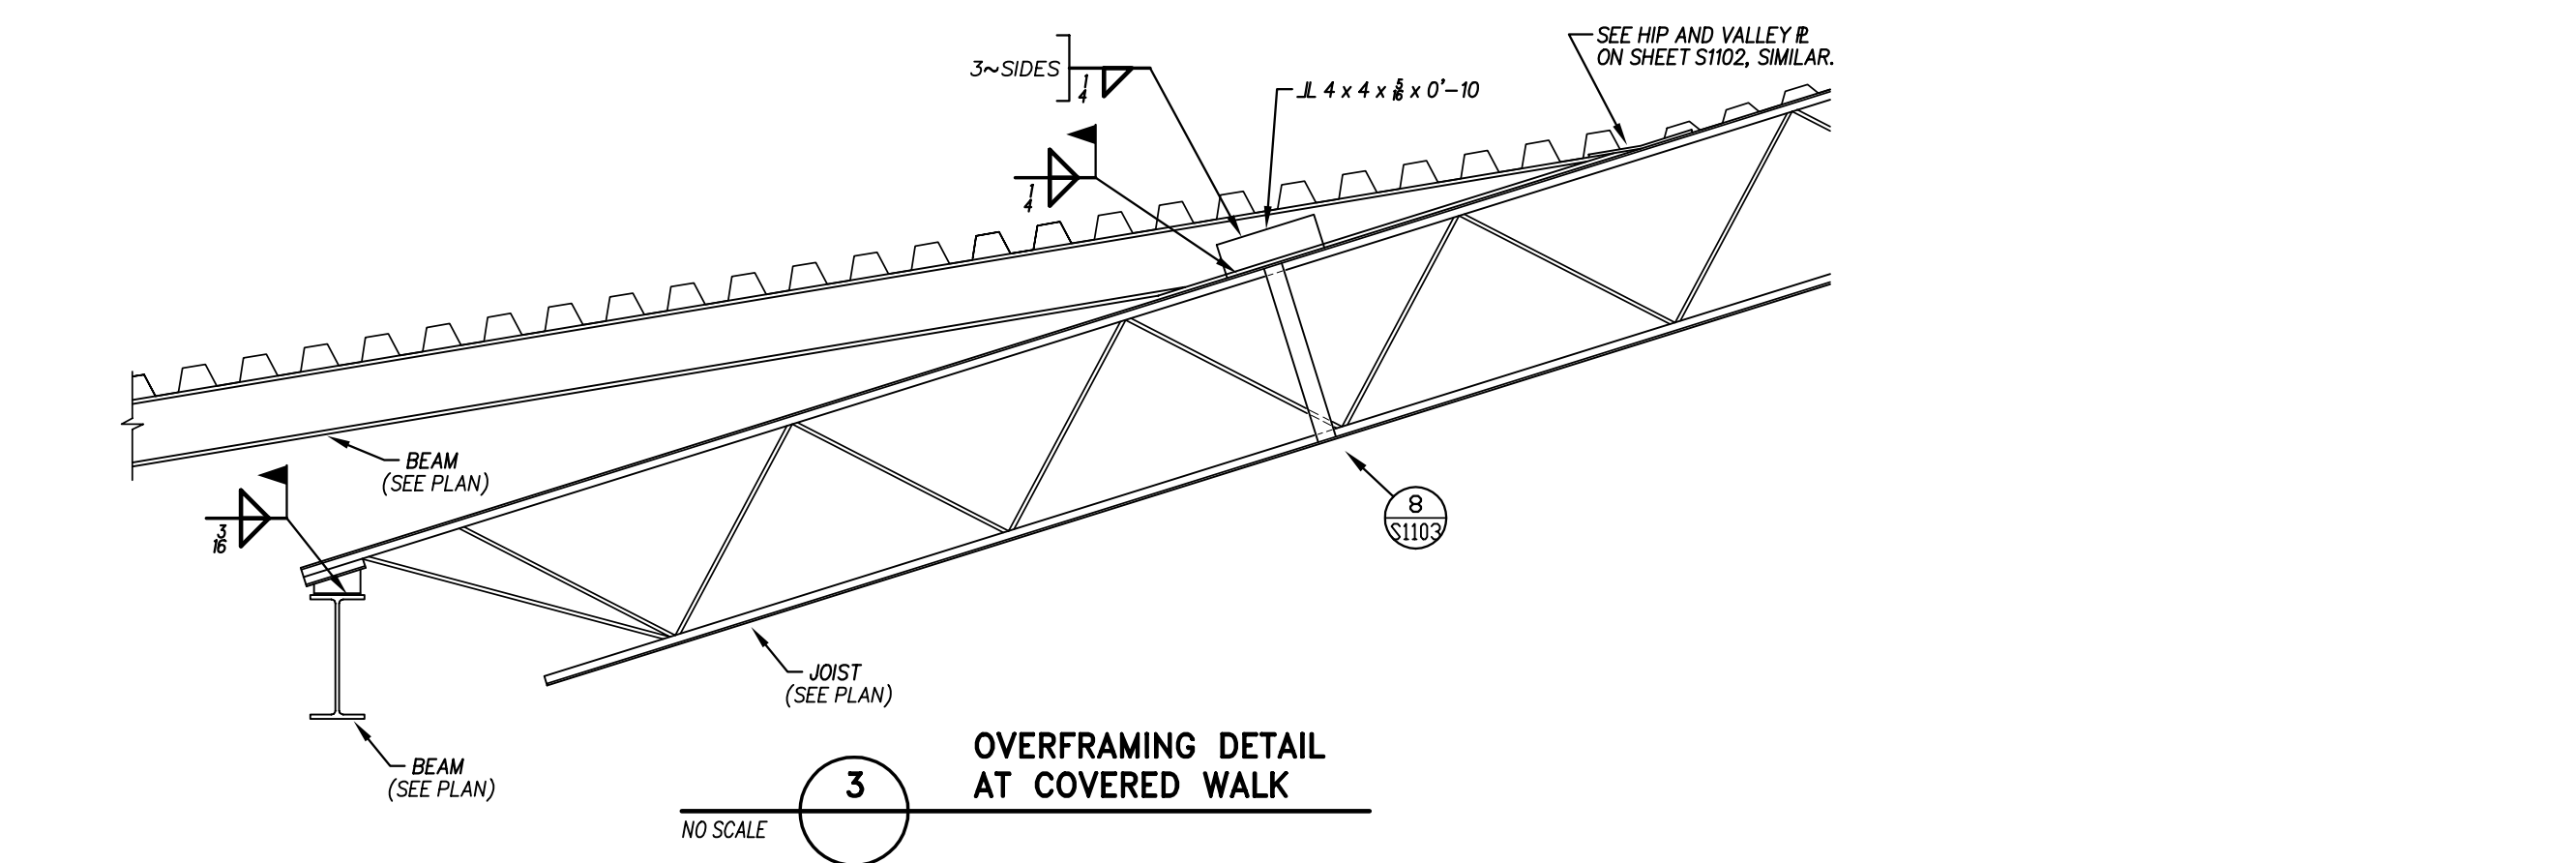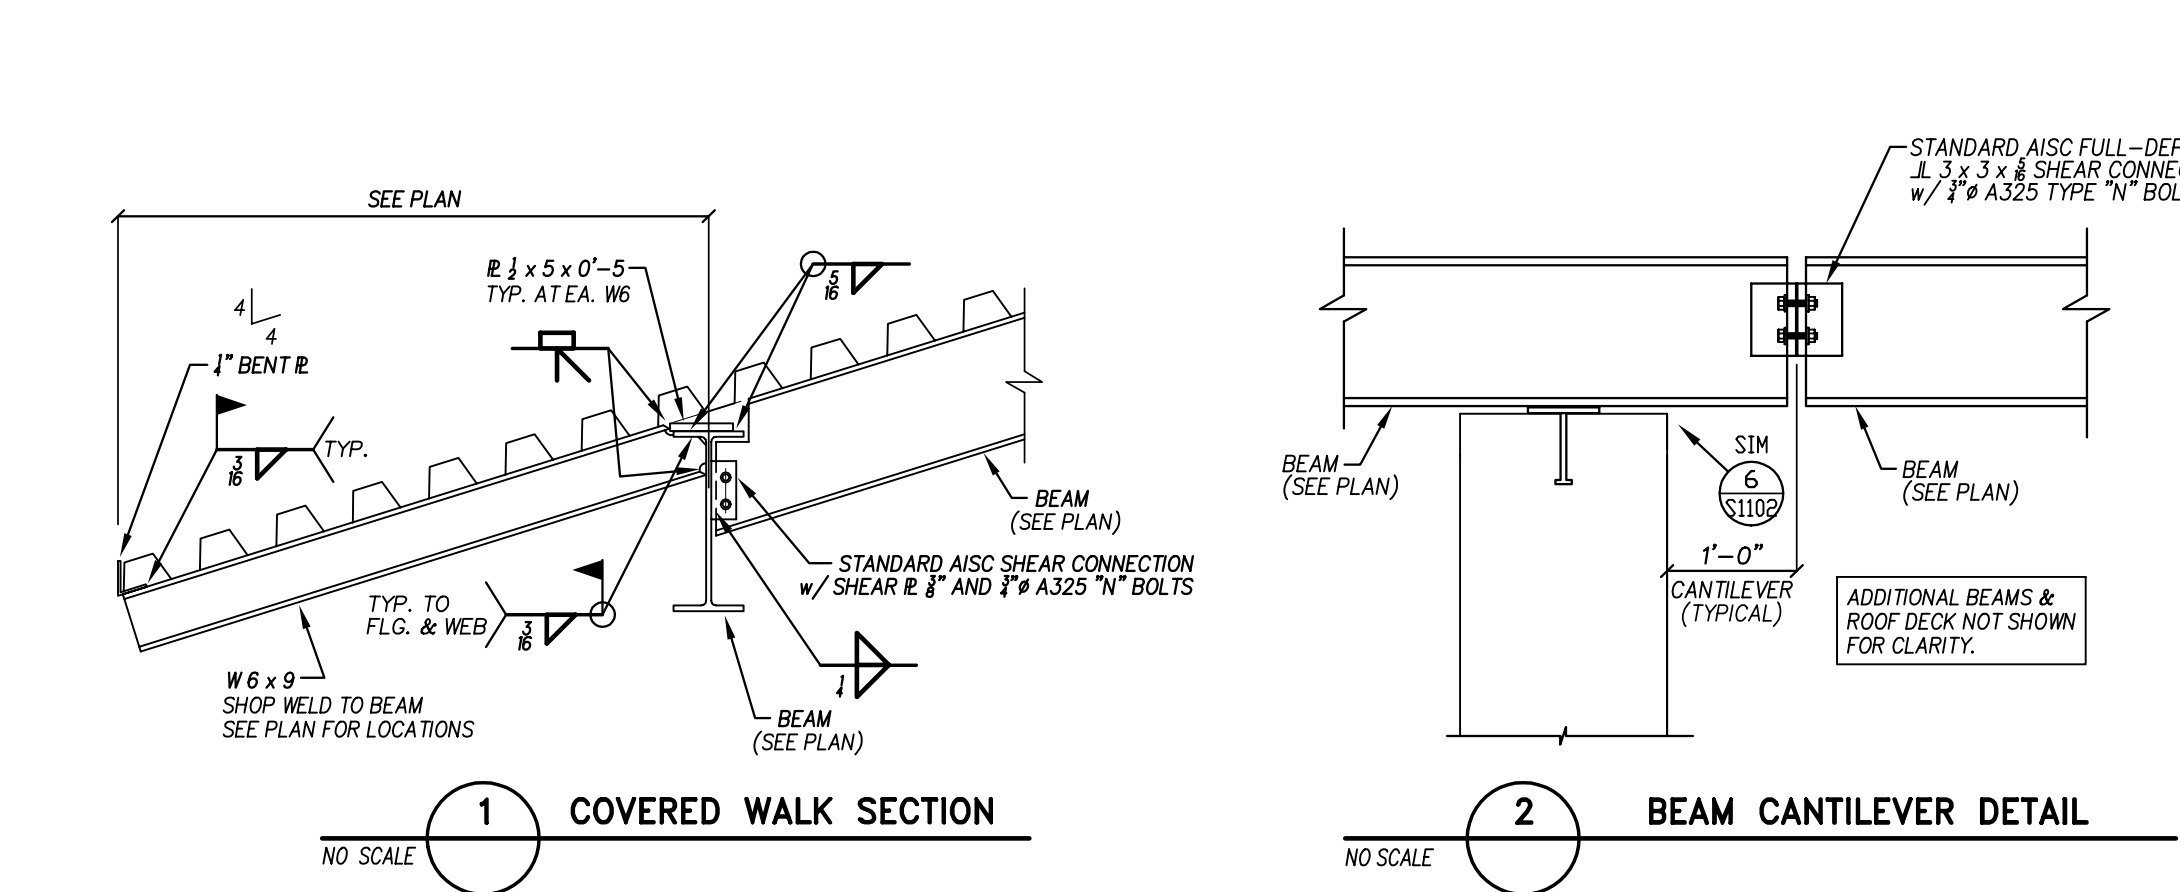





Revision	
No.	Date

Hite associates
 ARCHITECTURE/ENGINEERING/TECHNOLOGY
 2600 Meridian Drive / Greenville, NC 27858 / tel (252) 757-0333

QUEEN ENGINEERING & DESIGN
 ARCHITECTURE/ENGINEERING/TECHNOLOGY
 1000 W. HARRIS STREET
 WASHINGTON, NC 27883
 919-286-1111
 NORTH CAROLINA
 PROFESSIONAL ENGINEER
 BRUCE L. QUEEN
 1991
 09 OCT 2024

Beaufort PK-3 School
 BEAUFORT COUNTY SCHOOLS
 Washington / North Carolina / 27889

Project No. 22344
 Date: 09 OCT 2024
 Drawing no. S 1105

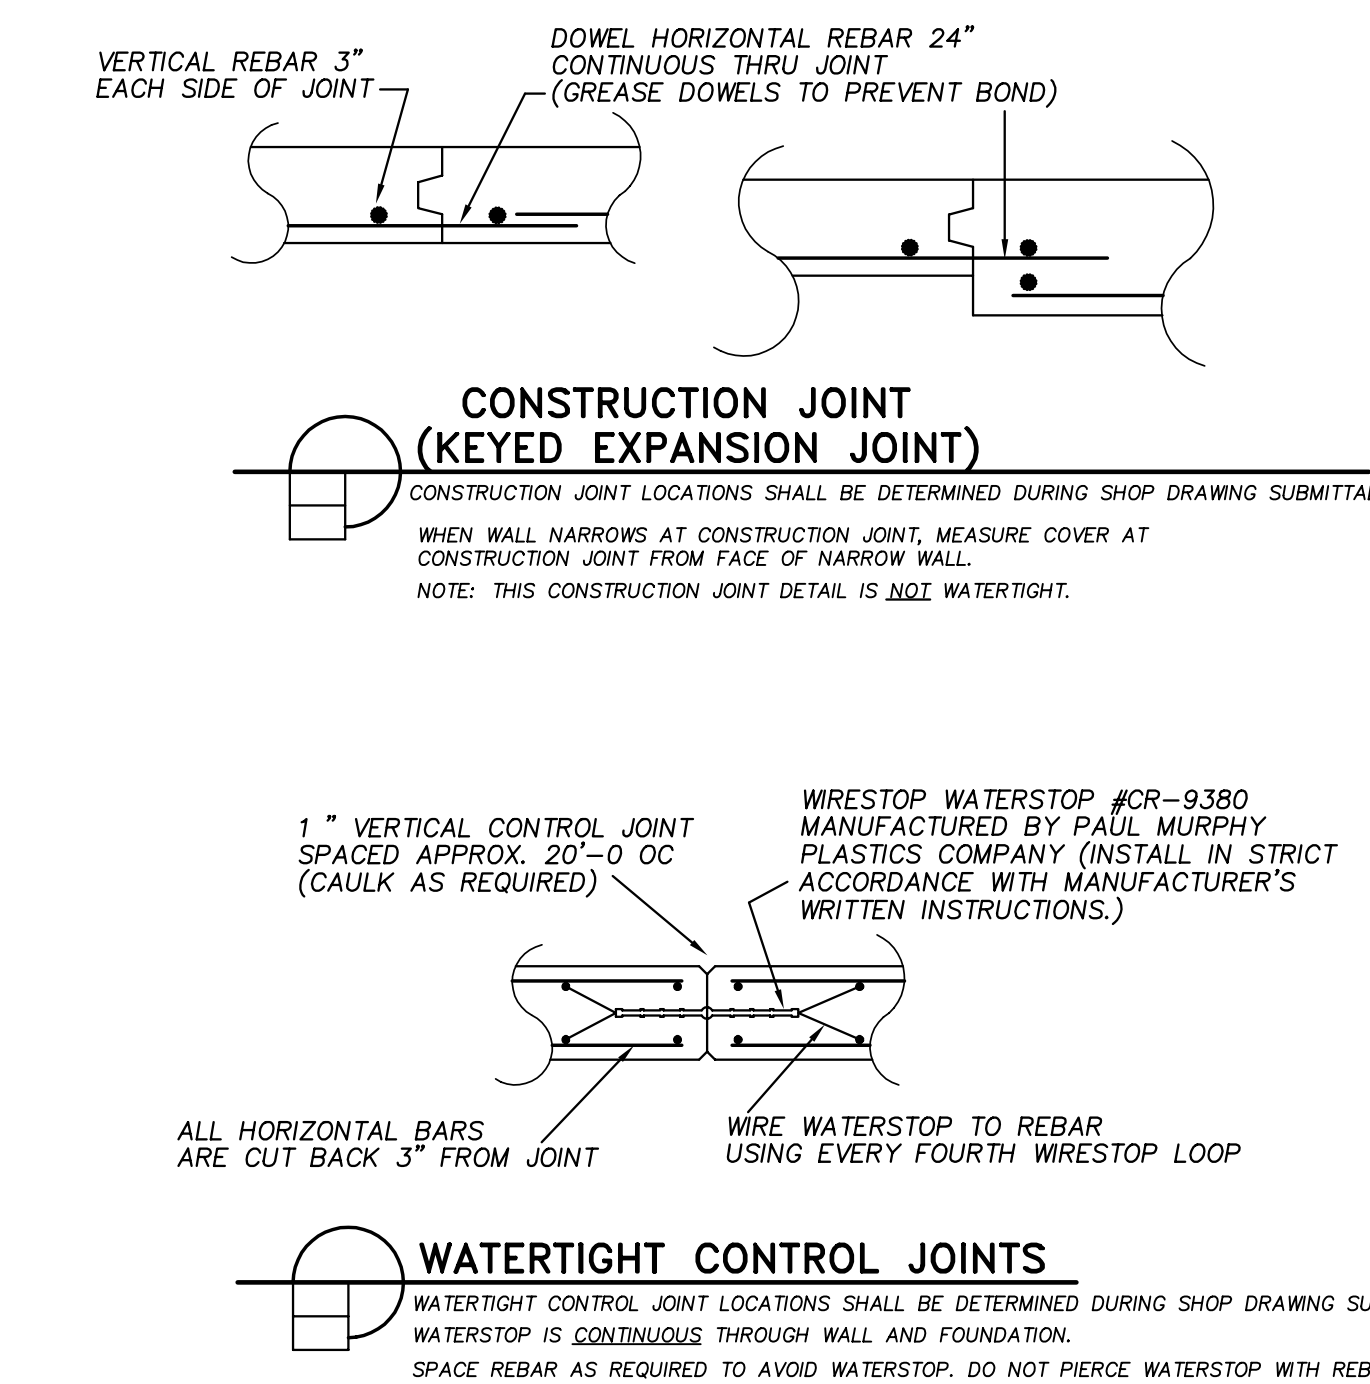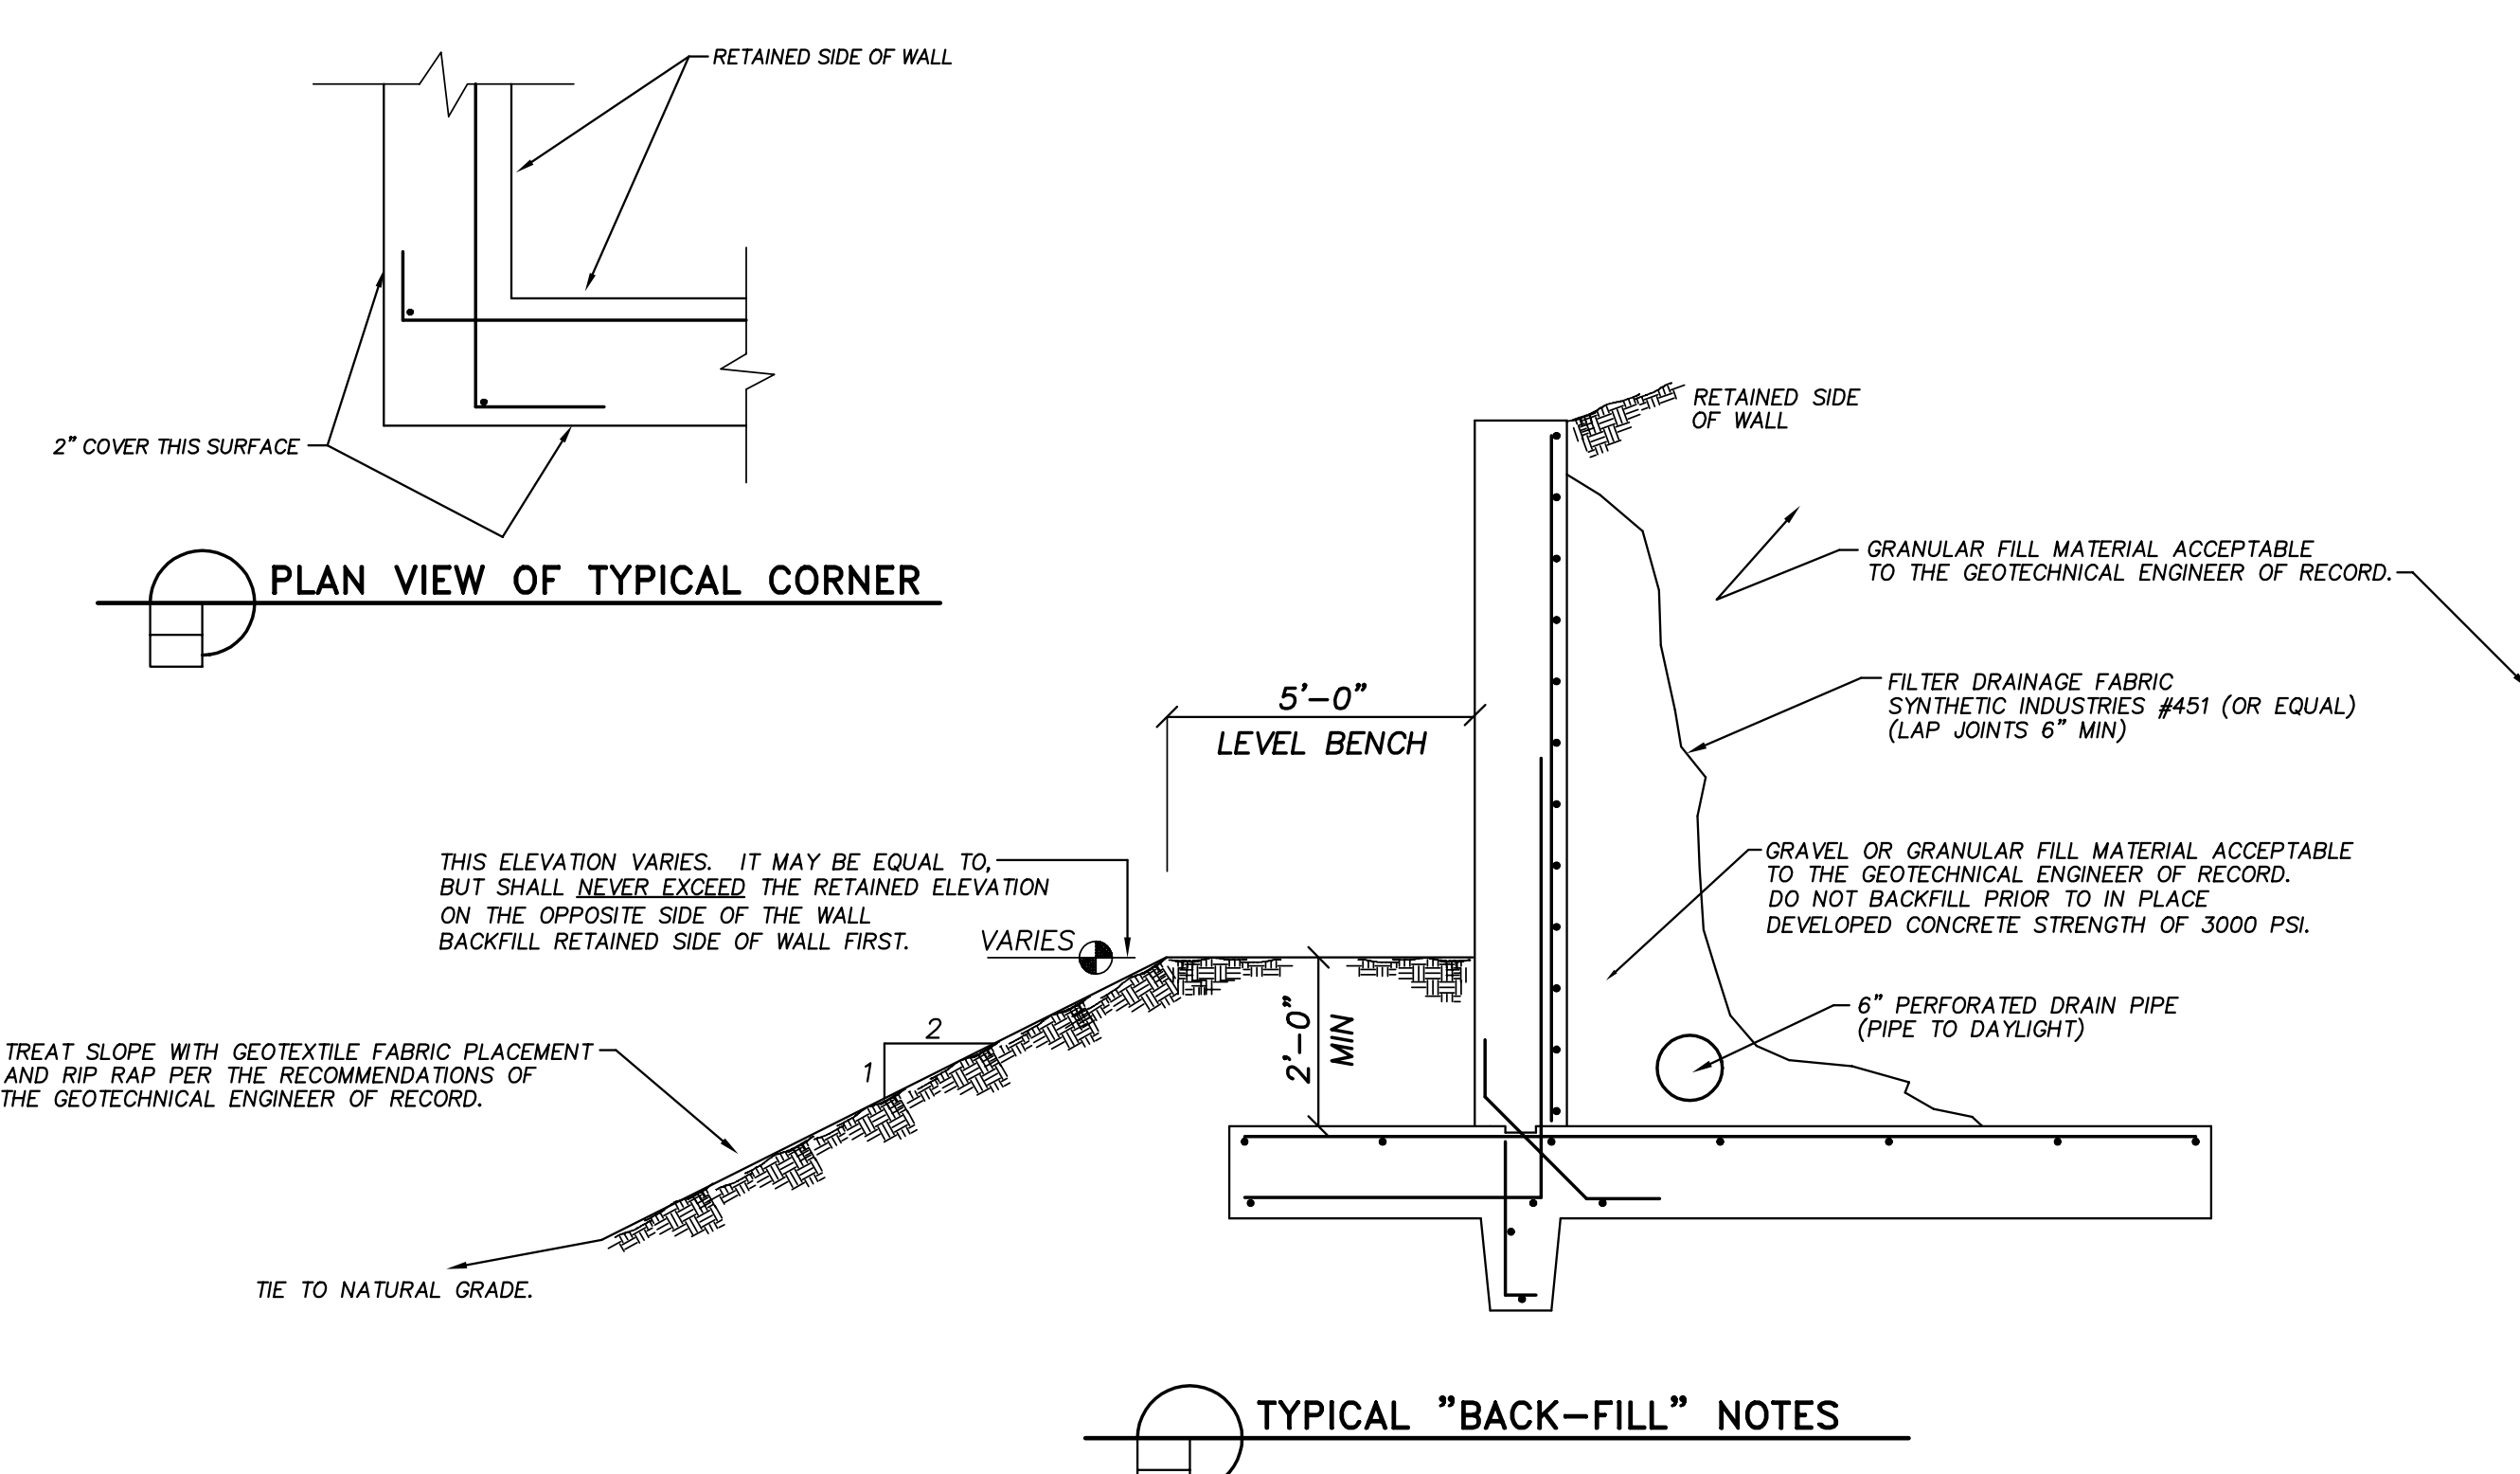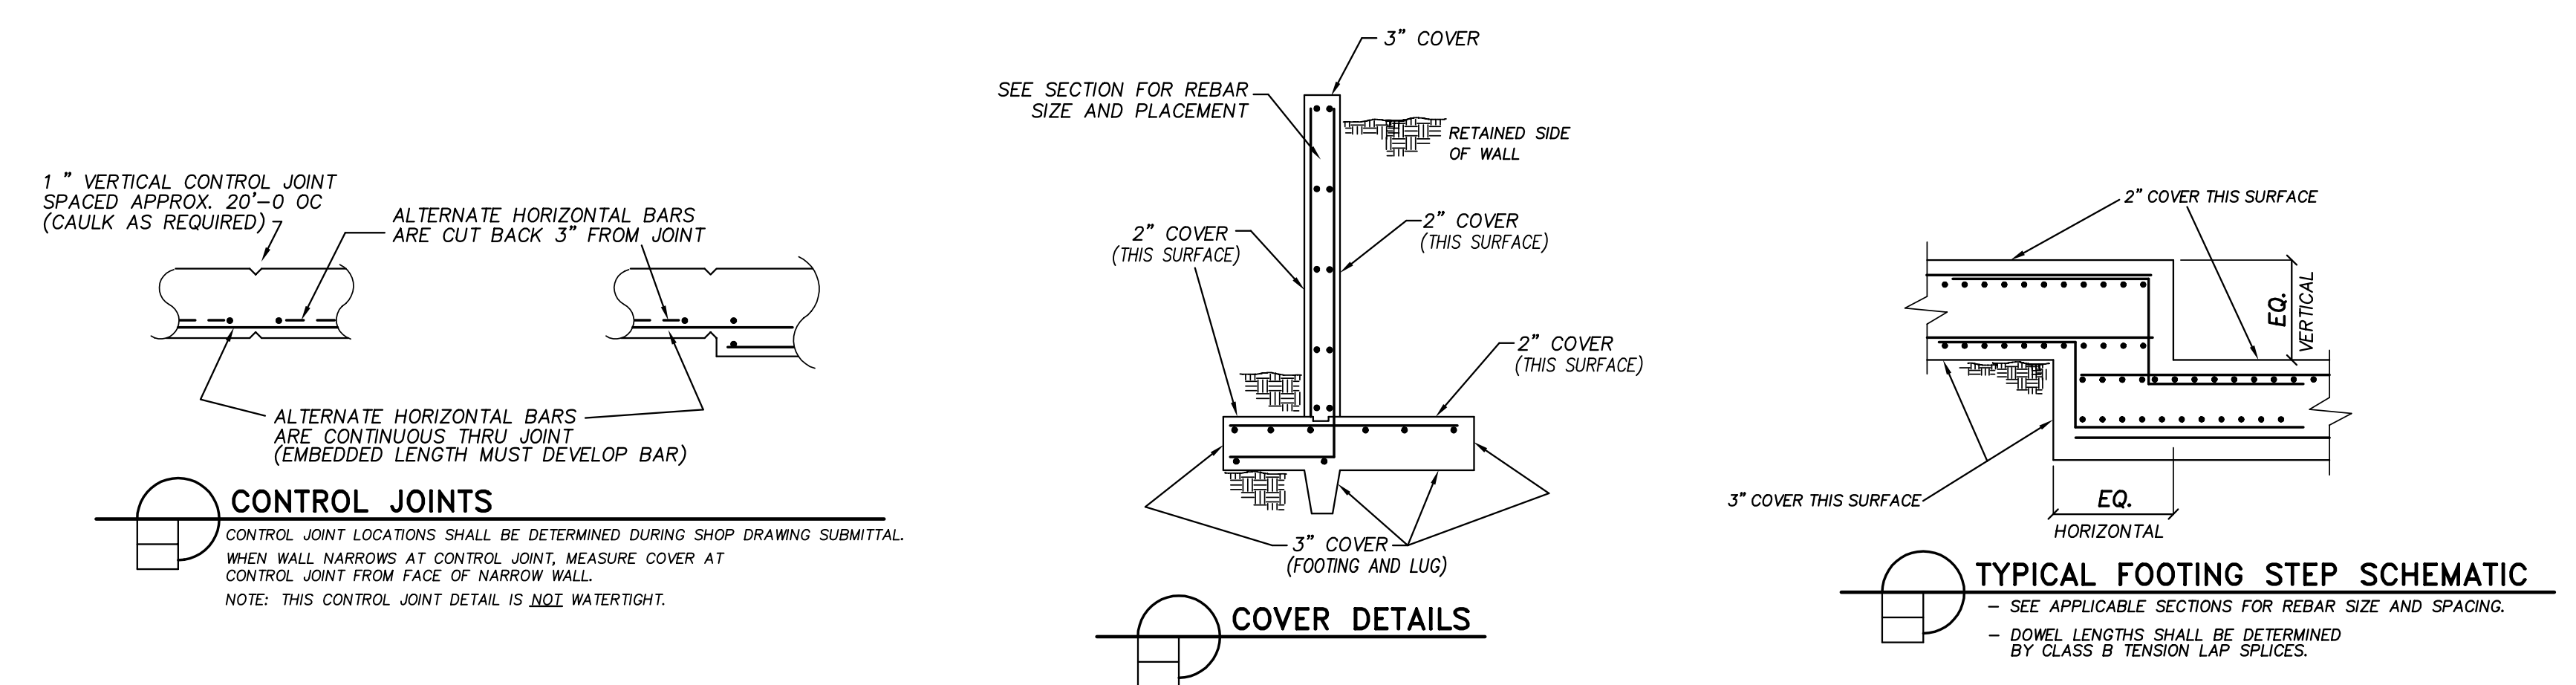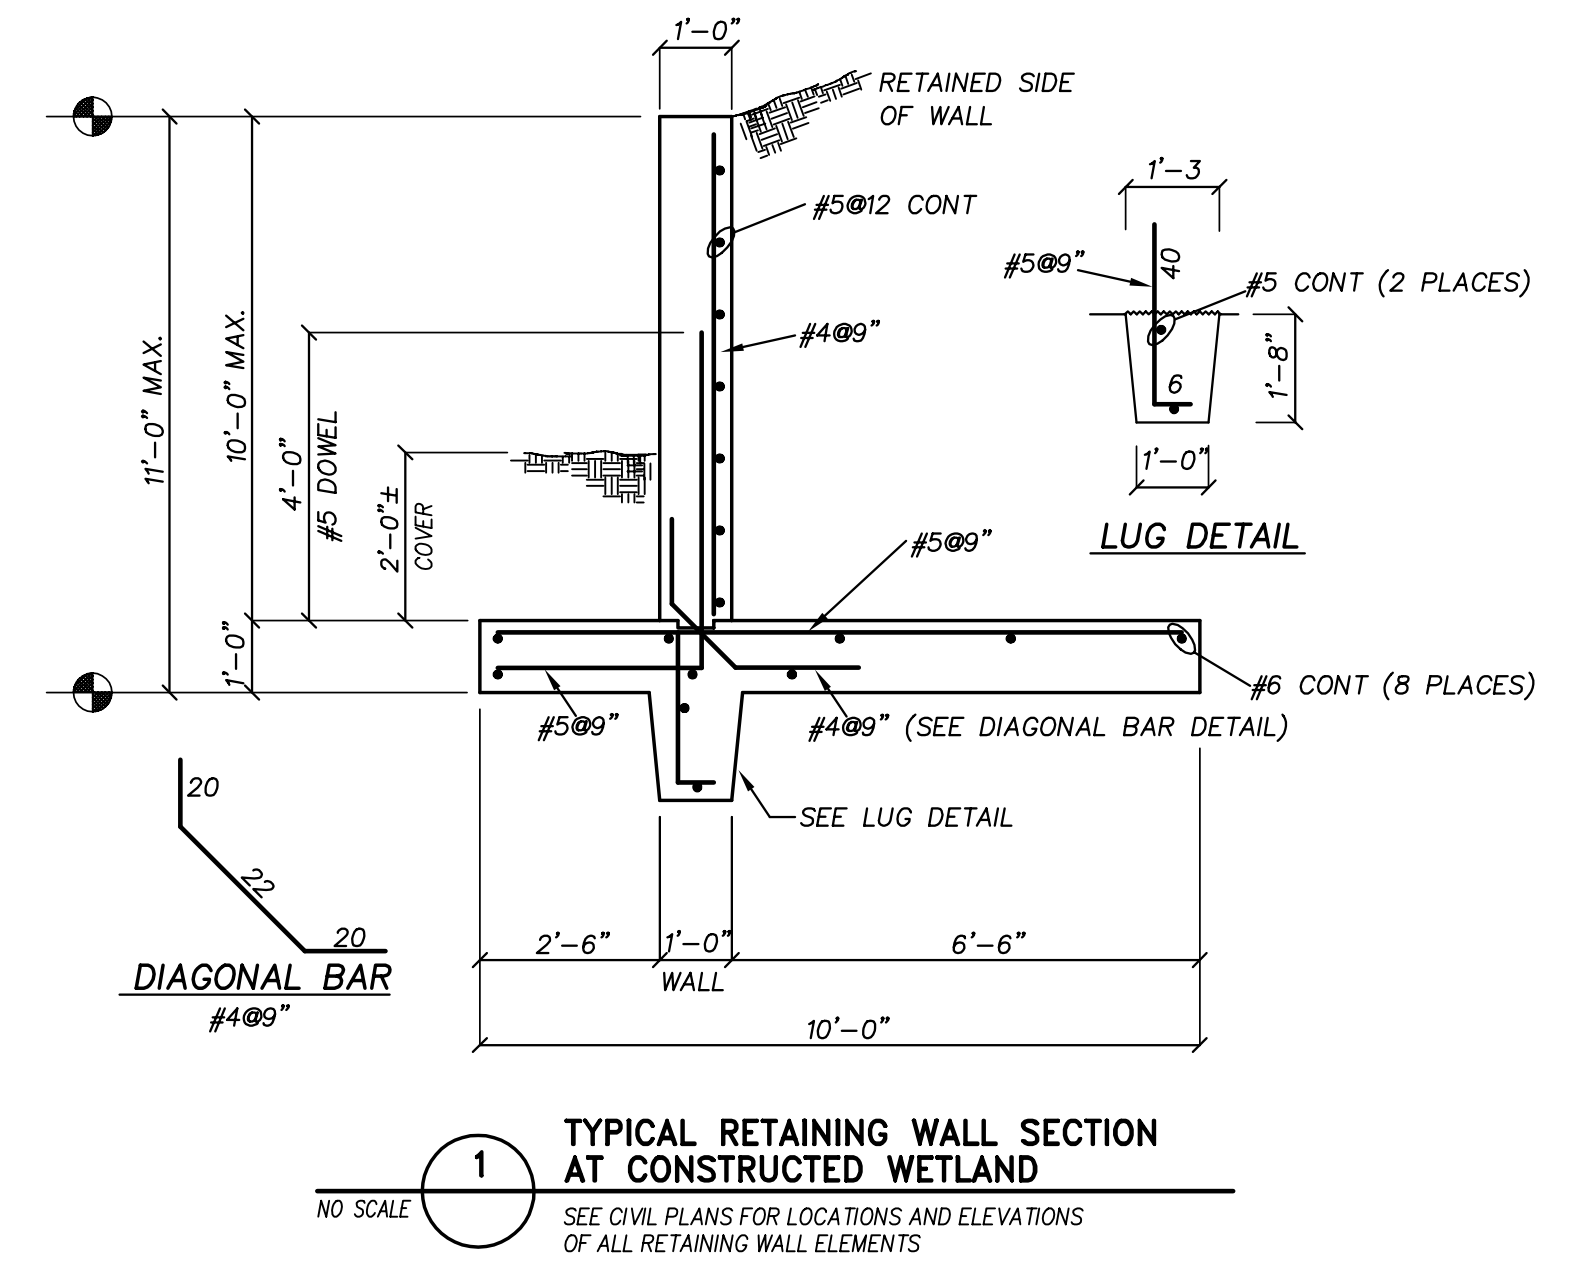

- GENERAL NOTES**
- WORK THESE DRAWINGS WITH ARCHITECTURAL DRAWINGS AND GRADING PLANS FOR EXACT WALL LOCATIONS AND ADDITIONAL INFORMATION.
 - THE CONTRACTOR SHALL COORDINATE AND VERIFY ALL DIMENSIONS PRIOR TO STARTING CONSTRUCTION AND ANY DISCREPANCY SHALL BE BROUGHT TO THE ATTENTION OF THE ENGINEER OF RECORD.
 - BACKFILL SHALL OCCUR ONLY AFTER THE IN PLACE CONCRETE HAS REACHED A VERIFIED STRENGTH OF 3000 PSI. IN ALL CASES, THE RETAINED SIDE OF THE WALL MUST BE BACKFILLED PRIOR TO ANY EARTH PLACEMENT AGAINST THE UNRETAINED SIDE.
 - ALL CONCRETE SHALL BE A MINIMUM STRENGTH OF 4000 PSI MEETING ACI 301 AND ACI 318. ALL CONCRETE SHALL BE MIXED, HANDLED, SAMPLED, TESTED, VIBRATED, AND PLACED IN ACCORDANCE WITH ACI STANDARDS. ALL SAMPLES SUBJECT TO PUMPING SHALL BE TAKEN AT THE EXIT END OF THE PUMP AT THE ELEVATION OF PLACEMENT.
 - ALL REINFORCING BARS SHALL BE GRADE 60 CONFORMING TO ASTM 615. LAP BARS WHERE REQUIRED USING CLASS B TENSION LAP SPLICES. MECHANICAL AND/OR WELDED SPLICES ARE NOT ACCEPTABLE. DOWEL AND LAP LENGTHS SHALL BE DETERMINED FOR $f_c = 3000$ PSI (NOT 4000 PSI) CONCRETE. SPLICES ARE UNACCEPTABLE IN THE VERTICAL REBAR OF THE WATERTIGHT PORTION OF THE WALL.
 - COVER DESIGNATIONS ARE CLEAR COVER TO OUTSIDE RADIUS OF BAR. (NOT TO BAR CENTERLINES.)
 - NO WATER SHALL BE ADDED TO THE CONCRETE AT THE JOB SITE. IT IS ACCEPTABLE TO INCLUDE HOT WATER IN THE CONCRETE MIX DESIGN IF REQUIRED BY CLIMATE CONDITIONS.
 - NO ADMIXTURES SHALL BE ADDED TO THE APPROVED CONCRETE MIX DESIGN WITHOUT THE PRIOR CONSENT OF THE ENGINEER OF RECORD.
 - THE PORTION OF WALL WHICH IS NOT WATER TIGHT MUST HAVE ADEQUATE DRAINAGE. ANY DRAINAGE SYSTEM ACCEPTABLE TO THE GEOTECHNICAL ENGINEER OF RECORD MAY BE USED IN LIEU OF THE SYSTEM SHOWN ON THESE DRAWINGS. HOWEVER, ADEQUATE DRAINAGE IS IMPORTANT TO THE PROPER OPERATION OF THE WALL.
 - FOOTING DESIGNS ARE BASED ON A REPORTED SOIL BEARING CAPACITY OF 3000 PSF. IT IS THE RESPONSIBILITY OF THE CONTRACTOR TO NOTIFY ENGINEER OF RECORD IF UNSTABLE, ORGANIC, WEAK, OR OTHERWISE UNACCEPTABLE SOIL CONDITIONS ARE ENCOUNTERED DURING EXCAVATIONS OR SUBSEQUENT GEOTECHNICAL INVESTIGATIONS.
 - ALL FOOTINGS SHALL BEAR ON UNDISTURBED SOIL OR COMPACTED FILL WHICH HAS BEEN APPROVED BY THE GEOTECHNICAL ENGINEER OF RECORD.
 - NO WORK SHALL COMMENCE PRIOR TO REBAR SHOP DRAWING APPROVAL BY THE ENGINEER OF RECORD.

No.	Date	Revision

Hite associates
ARCHITECTURE / ENGINEERING / TECHNOLOGY
2600 Meridian Drive / Greenville, NC 27838 / tel (252) 757-0333

QED
QUEEN ENGINEERING & DESIGN
REGISTERED PROFESSIONAL ENGINEER
STATE OF NORTH CAROLINA
EXPIRES 09 OCT 2024

Beaufort PK-3 School
BEAUFORT COUNTY SCHOOLS
Washington / North Carolina / 27889

Project No. 22344
Date: 09 OCT 2024
Drawing no. S 1106

